

MECHANICAL KEYED NOTES

- PROVIDE 36"/12" RUSKIN ALUMINUM WIND-DRIVEN RAIN RESISTANT EXHAUST AIR LOUVER MODEL EME520DD OR APPROVED EQUAL AT SIZE INDICATED WITH A MINIMUM FREE AREA OF 0.88 SQ FT. REFER TO X/M401 FOR LOUVER
- PROVIDE 60/12" RUSKIN ALUMINUM WIND-DRIVEN RAIN
 RESISTANT EXHAUST AIR LOUVER MODEL EME520DD OR
 APPROVED EQUAL AT SIZE INDICATED WITH A MINIMUM FREE AREA OF 1.51 SQ FT. REFER TO 9/M401 FOR LOUVER
- PROVIDE 18"/12" RUSKIN ALUMINUM WIND-DRIVEN RAIN RESISTANT EXHAUST AIR LOUVER MODEL EME520DD OR APPROVED EQUAL AT SIZE INDICATED WITH A MINIMUM FREE AREA OF 0.41 SQ FT. REFER TO 9/M401 FOR LOUVER
- 4 PROVIDE 36"/12" RUSKIN ALUMINUM WIND-DRIVEN RAIN RESISTANT OUTSIDE AIR LOUVER MODEL EME520DD OR APPROVED EQUAL AT SIZE INDICATED WITH A MINIMUM FREE AREA OF 0.88 SQ FT. REFER TO X/M401 FOR LOUVER
- 5 ROUTE 3/4" CONDENSATE DRAIN PIPING TO FLOOR SINK IN MECH ROOM. RE: 2/M201 FOR CONTINUATION.
- 6 ROUTE DUCT FROM CONNECTION AT DRYER UP THROUGH ROOF, TERMINATE TO GOOSENECK WITH GRAVITY BACK DRAFT DAMPER WITH NO BIRD OR BUG SCREEN. SIZE AND ROUTE DUCT IN STRICT ACCORDANCE TO MANUFACTURER'S RECOMMENDATIONS. RE: DETAILS XX & X/MXX.
- OSCILLATING AIR CIRCULATOR FAN. REFER TO FAN SPECIFICATION SECTION FOR MORE INFORMATION.
- 8 COORDINATE WITH ARCHITECT 48"X24" SERVICE ACCESS PANEL ON CEILING FOR INLINE FAN.

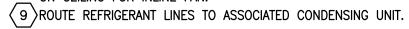

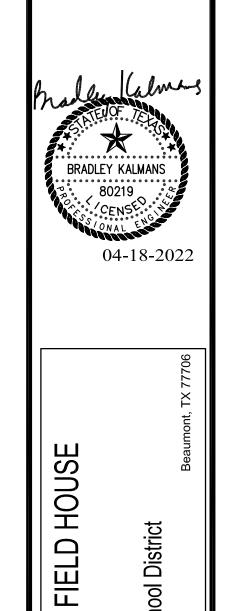

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WEST BROOK AL

100% REVIEW DATE: 01/12/2022

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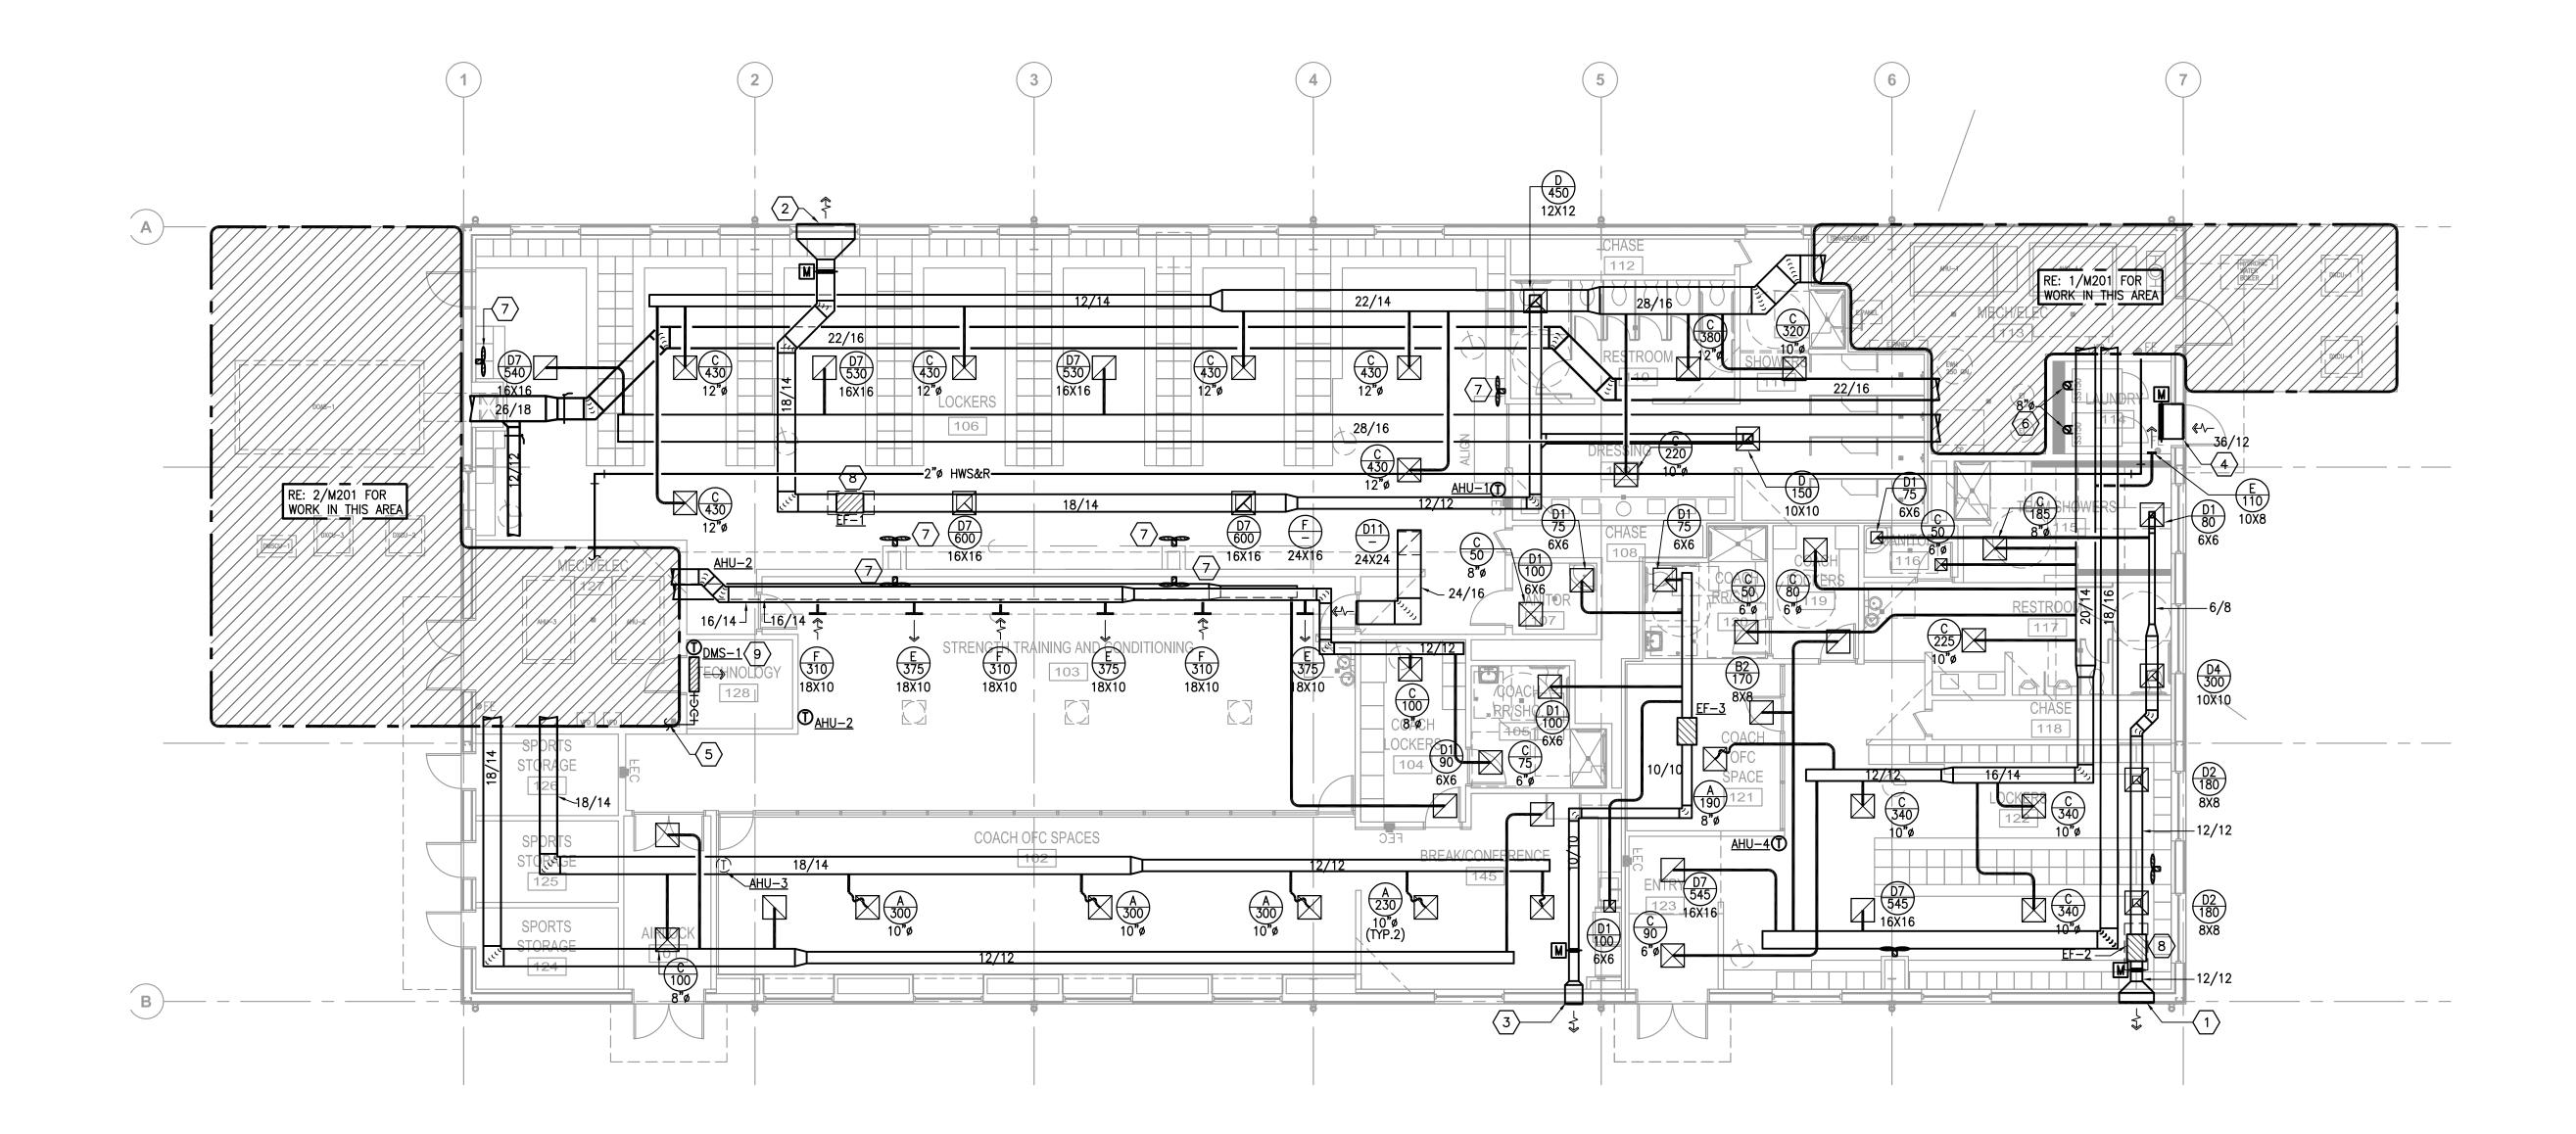
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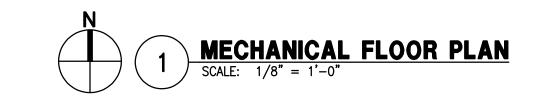
BIDS & CONSTRUCTION DATE: 04/18/2022

DRAWINGS SHEET TITLE

MECHANICAL


FLOOR PLAN






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MECHANICAL ENLARGED FLOOR PLAN
SCALE: 1/4" = 1'-0"

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MECHANICAL KEYED NOTES

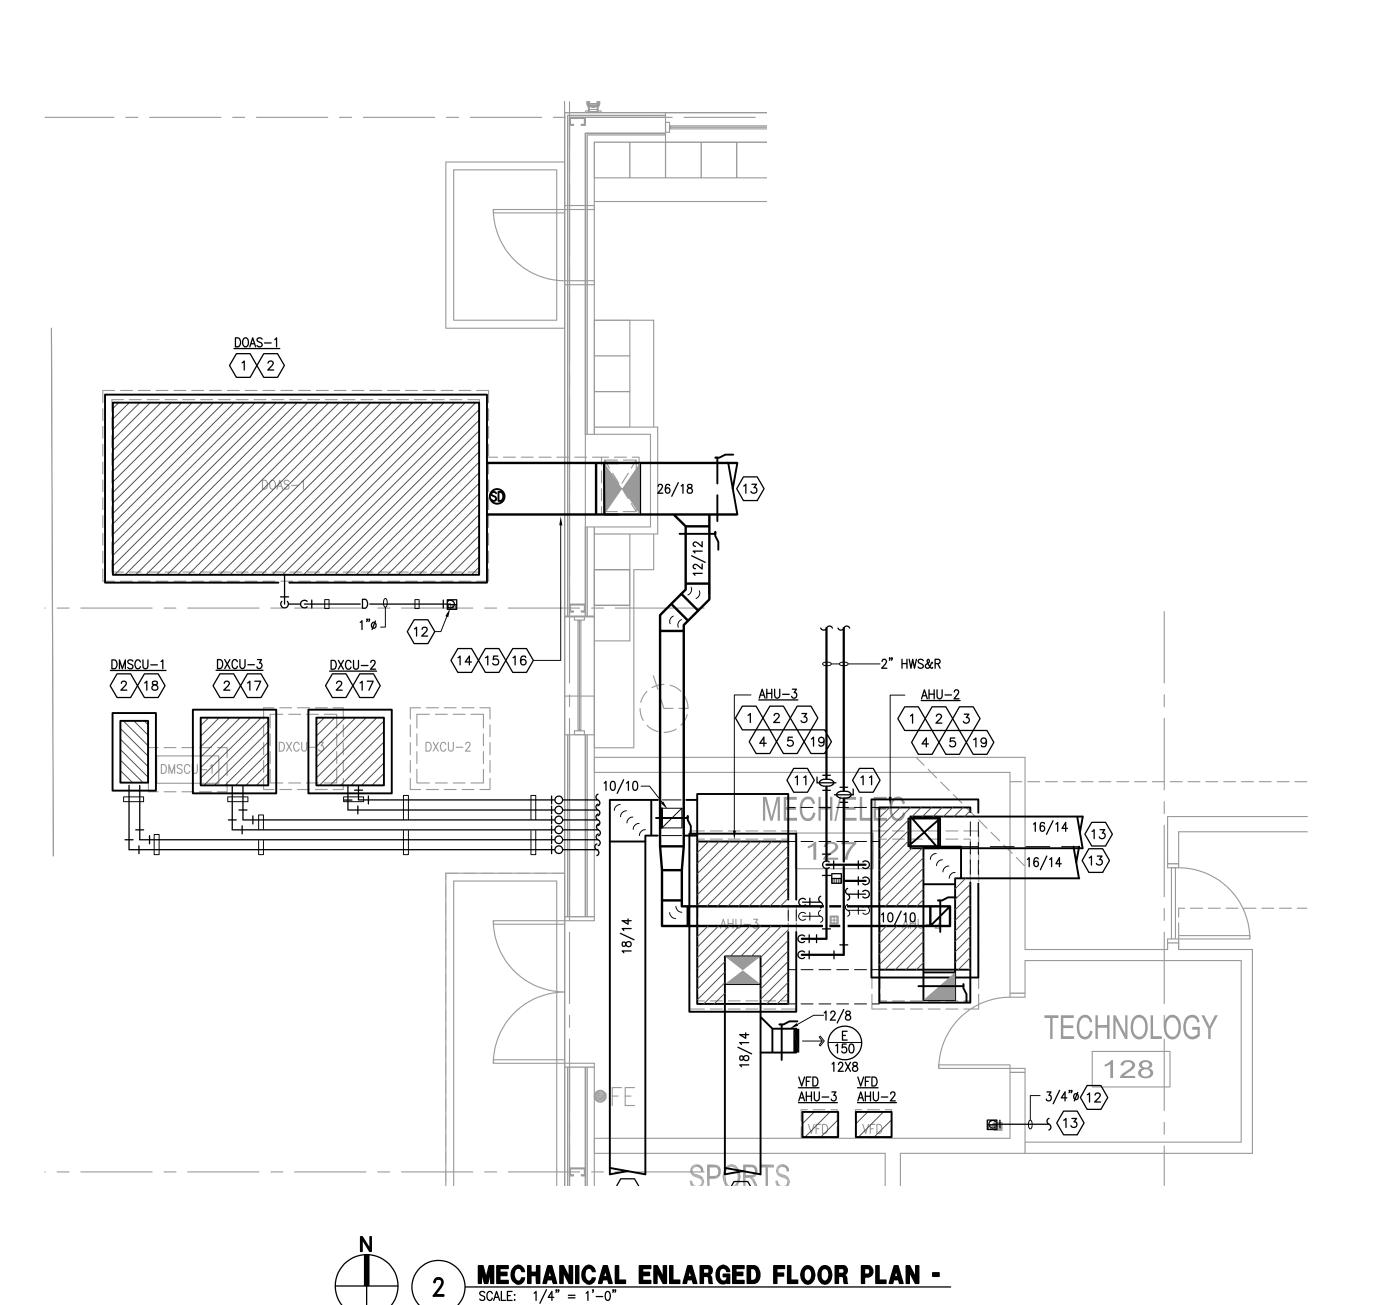VERIFY SERVICE CLEARANCES FOR AIR FILTER, FAN SHAFT AND COIL REMOVAL WITH EQUIPMENT MANUFACTURER. COORDINATE WITH ALL TRADES NOT TO OBSTRUCT.

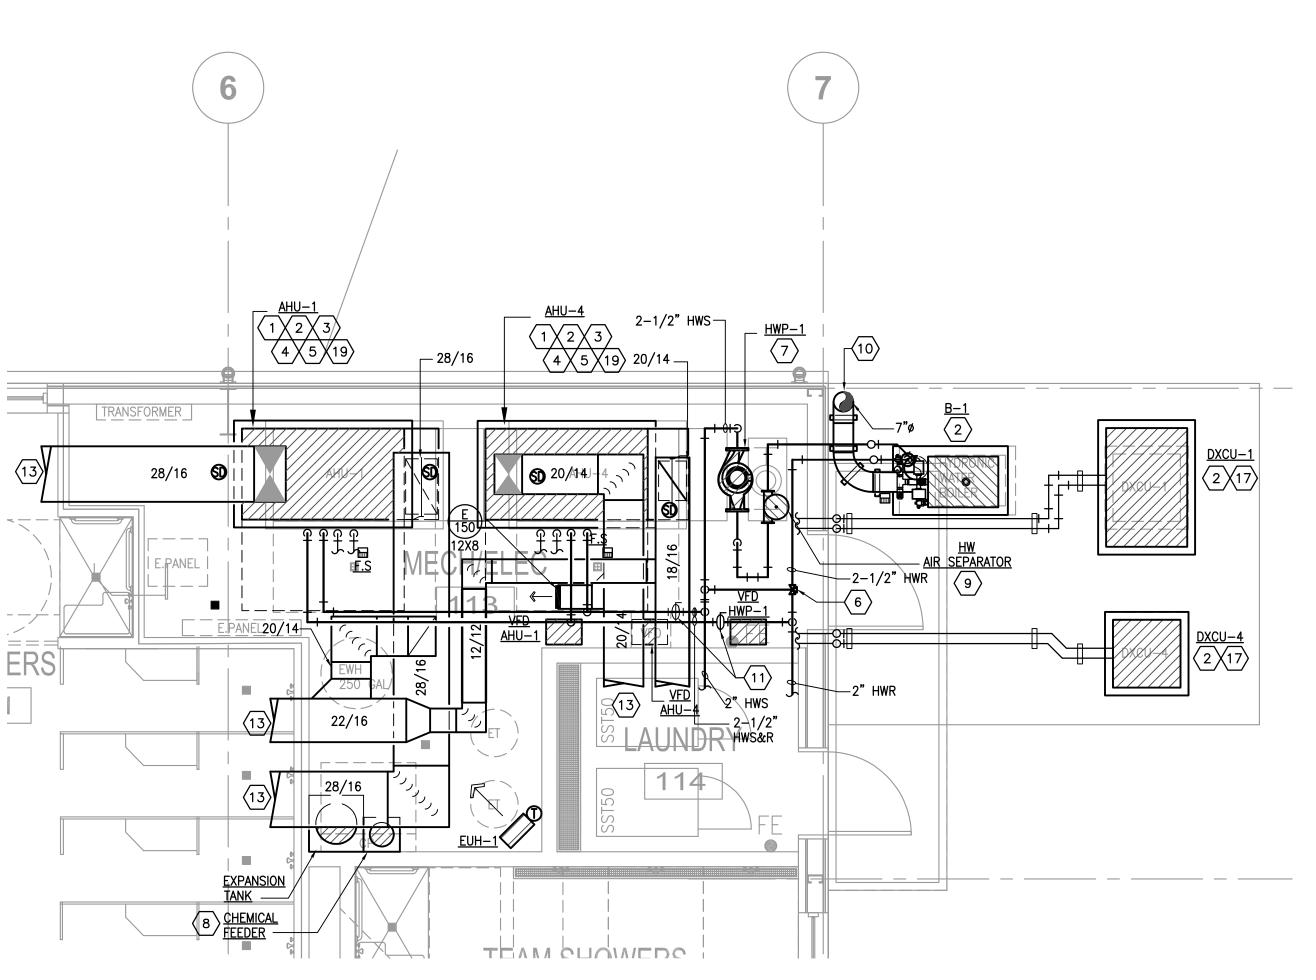2 PROVIDE 4" THICK CONCRETE HOUSEKEEPING PAD.

ROUTE FULL SIZE CONDENSATE DRAIN PIPING TO FLOOR DRAIN (SEE PLUMBING DRAWING FOR EXACT LOCATION).

4 REFER TO DETAILS FOR CONDENSATE PIPING AT AHU.

5 REFER TO DETAILS FOR COIL PIPING AT AHU.

9 RE: 4/M401 FOR AIR SEPARATOR SUPPORT.

 $\langle 11 \rangle$ PROVIDE ISOLATION VALVE.

SINK.

13 RE: 1/M101 FOR CONTINUATION.

6 COLD WATER PROTECTION 3 WAY CONTROL VALVE.

7 RE: 10/M401 FOR DETAIL ON VERTICAL INLINE PUMP SUPPORT.

8 RE: 7/M401 FOR CHEMICAL FEEDER TANK SUPPORT.

14 PROVIDE ENCLOSED DUCT SUPPORT MODEL PHP-D.

(15) PROVIDE VERTICAL DUCT SUPPORT AS SPECIFIED.

PROVIDE OUTDOOR DUCTWORK INSULATION AS PER SPECIFICATIONS.

PROVIDE PIPE SUPPORTS AS SPECIFIED.

ROUTE REFRIGERANT PIPING TO ASSOCIATED AIR CONDENSING UNIT.

ROUTE REFRIGERANT PIPING TO ASSOCIATED AIR HANDLING UNIT. PROVIDE PIPE SUPPORTS AS SPECIFIED.

(18) ROUTE REFRIGERANT PIPING TO ASSOCIATED INDOOR UNIT.

ROUTE STAINLESS STEEL EXHAUST AIR DUCTWORK AT SIZE INDICATED UP 4'-0" ABOVE FINISHED ROOF.

ROUTE CONDENSATE DRAIN PIPING AT SIZE INDICATED TO FLOOR

350 Pine Street, Suite 720 Edison Plaza Beaumont, Texas 77701 TEL (409) 866-7196 FAX (409) 866-7145 J. ROB CLARK, A.I.A. RONALD M. JONES, A.I.A.

BRADLEY KALMANS

80219

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04-18-2022

Beaumont, TX 777

sendent School District

FIELD HOUSE

WEST BROOK AUXILIARY

Reallmont Independent School D

Phelan Blvd

ISSUED FOR 100% REVIEW X DATE: 01/12/2022

BIDS & CONSTRUCTION X
DATE: 04/18/2022

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DRAWINGS SHEET TITLE

MECHANICAL ENLARGED FLOOR PLAN


SHEET NUMBER M201

MECHANICAL KEYED NOTES

- 1 VERTICAL INLINE PUMP. REFER TO 10/M-401 FOR ADDITIONAL INFORMATION.
- PROVIDE AN ERNEST GAUGE #E-57-3 BRONZE BODY SIGHT GLASS WITH S.S. SHAFT, PLASTIC SPINNER AND DOUBLE WINDOW. OPERATING TEMPERATURE AND PRESSURE SHALL BE 200°F, 125 PSI MINIMUM.
- PROVIDE BALL VALVE WITH HOSE THREAD ADAPTER AT FULL SIZE UNLESS OTHERWISE NOTED.
- 4 BALANCING VALVE TO BE PROVIDED WITH INFINITE POSITION CRANK OR MEMORY STOP FOR BALANCING
- (5) ROUTE TYPE "L" COPPER DRAIN AT FULL SIZE INDICATED TO NEAREST FLOOR DRAIN.
- 6 PROVIDE INLINE STRAINER.
- 7 HEADER TEMPERATURE SENSOR. PROVIDED BY BOILER
- MANUFACTURER.

 (8) REFER TO DETAIL 11/M-401 FOR MORE INFORMATION ON POWER EXHAUSTED FLUE.
- 9 ROUTE FULL SIZE CPVC PIPING FROM BOILER TO ACID NEUTRALIZATION BASIN AND FROM BASIN TO FLOOR SINK.



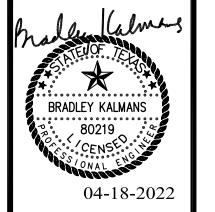

WEST BROOK AUXILIARY FIELD HOUSE

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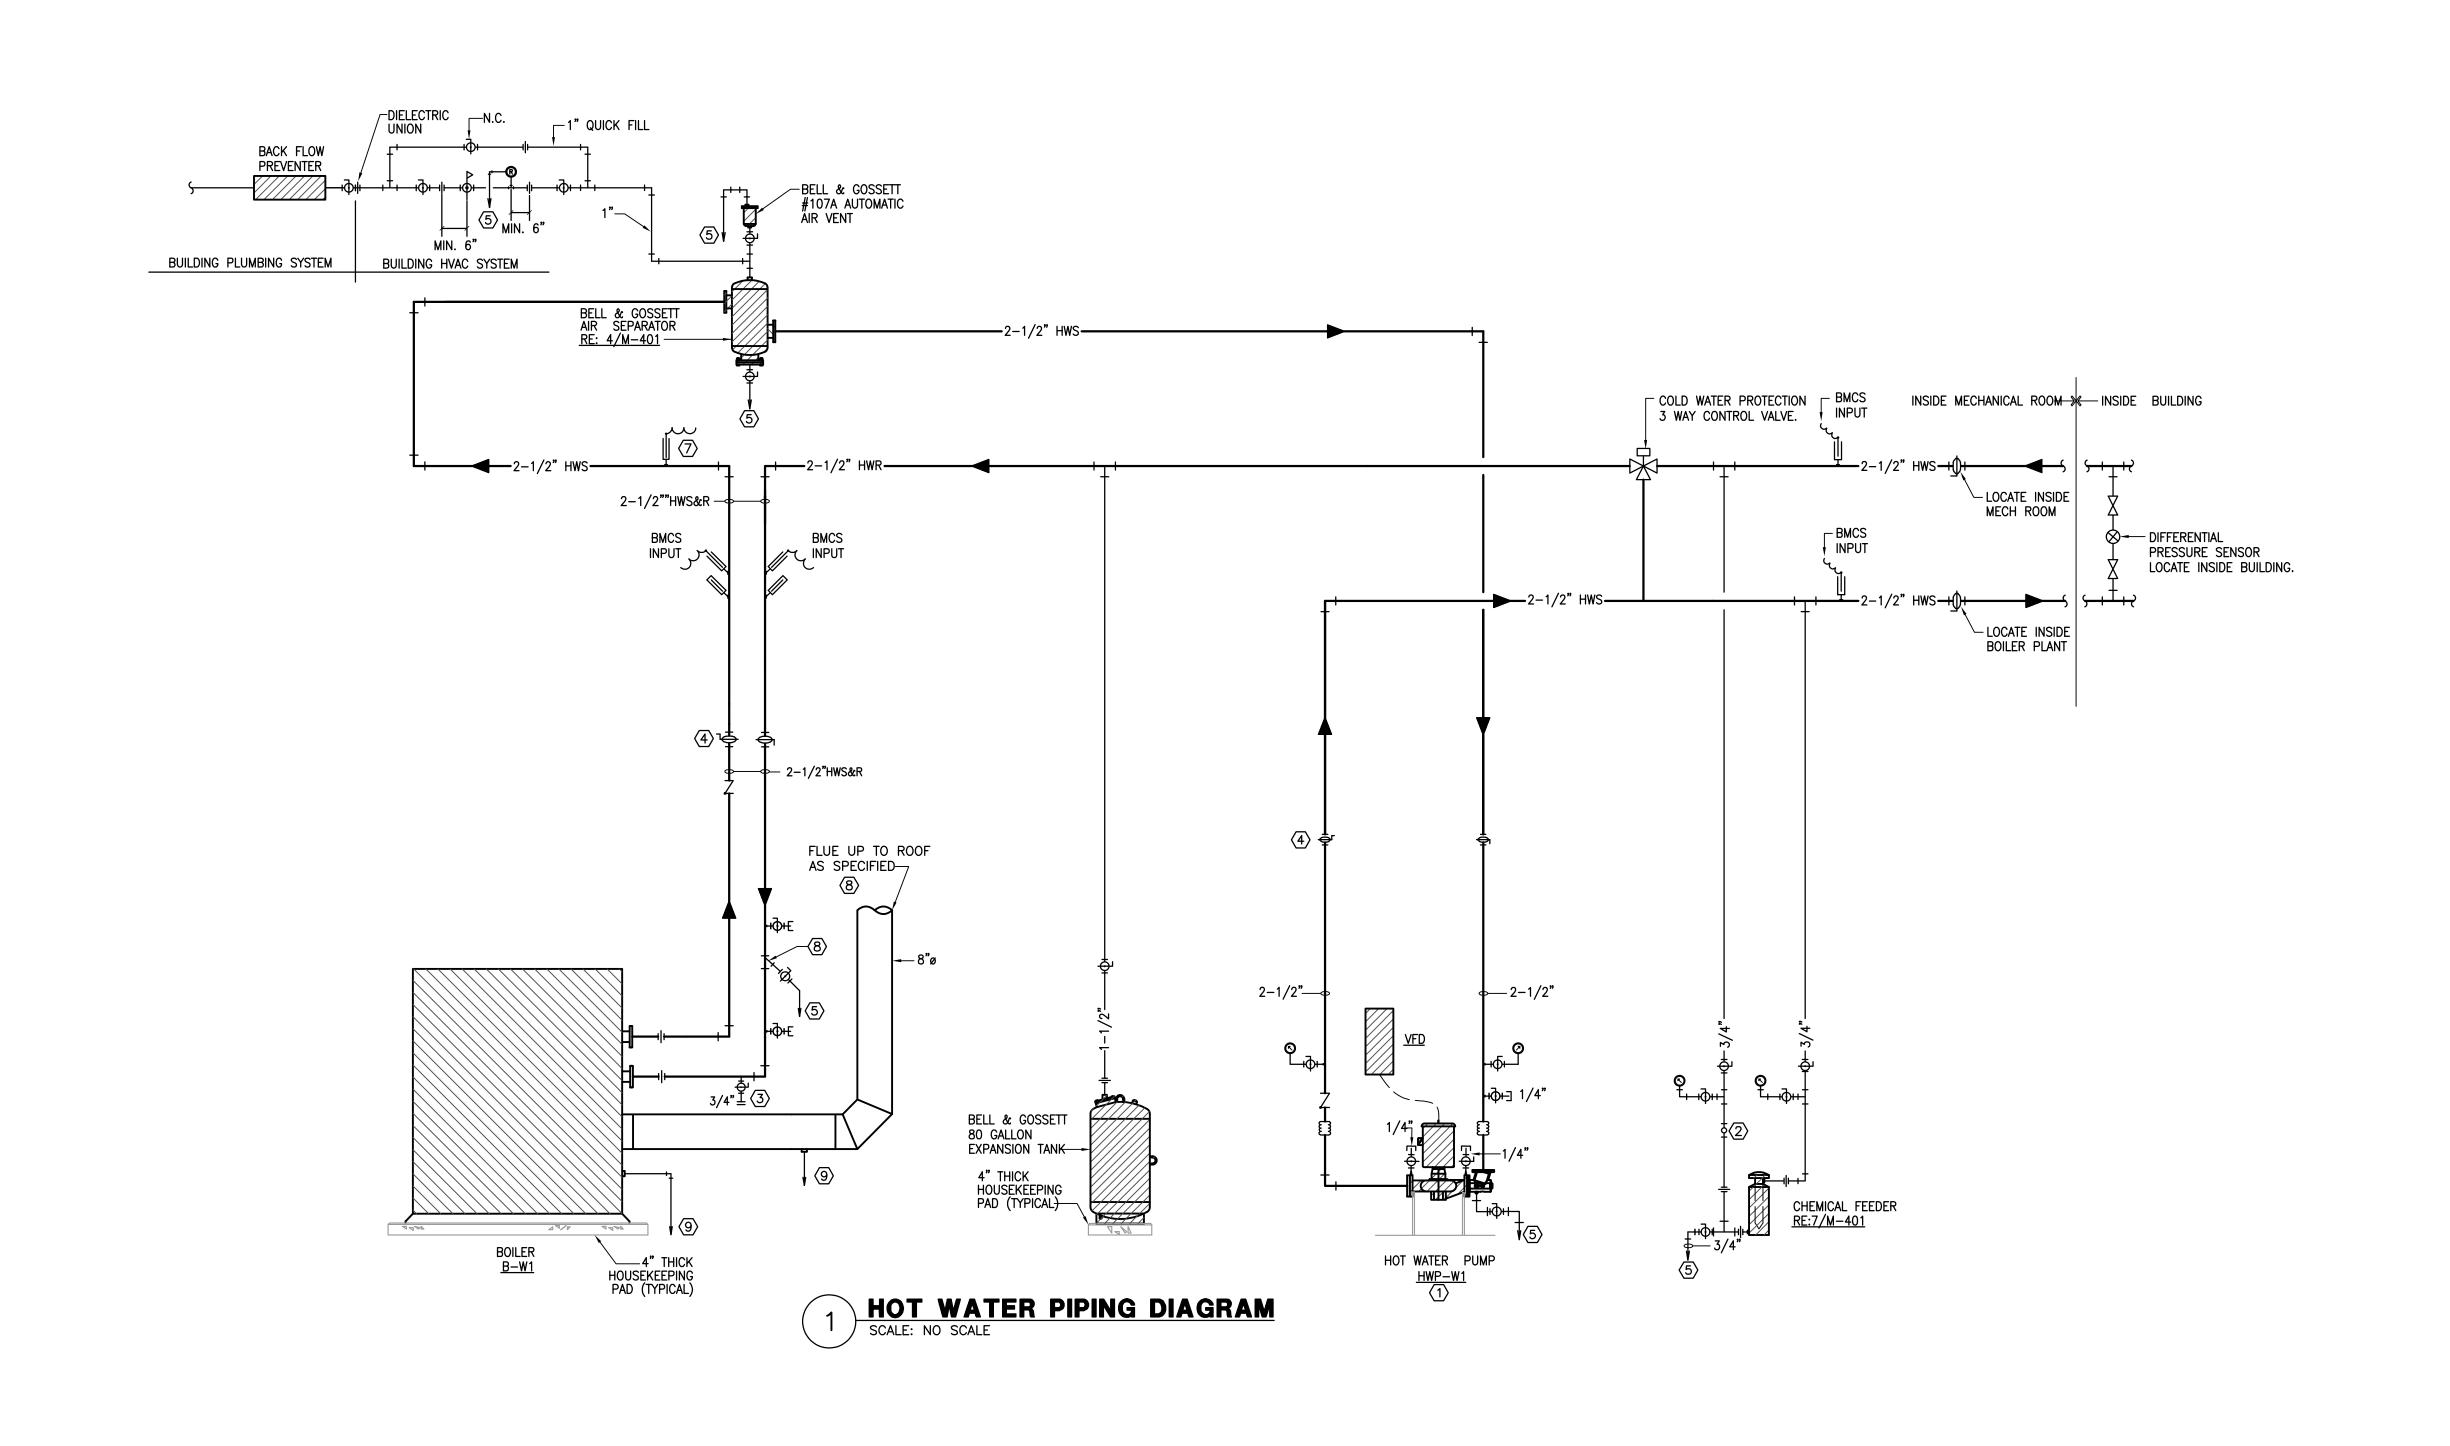
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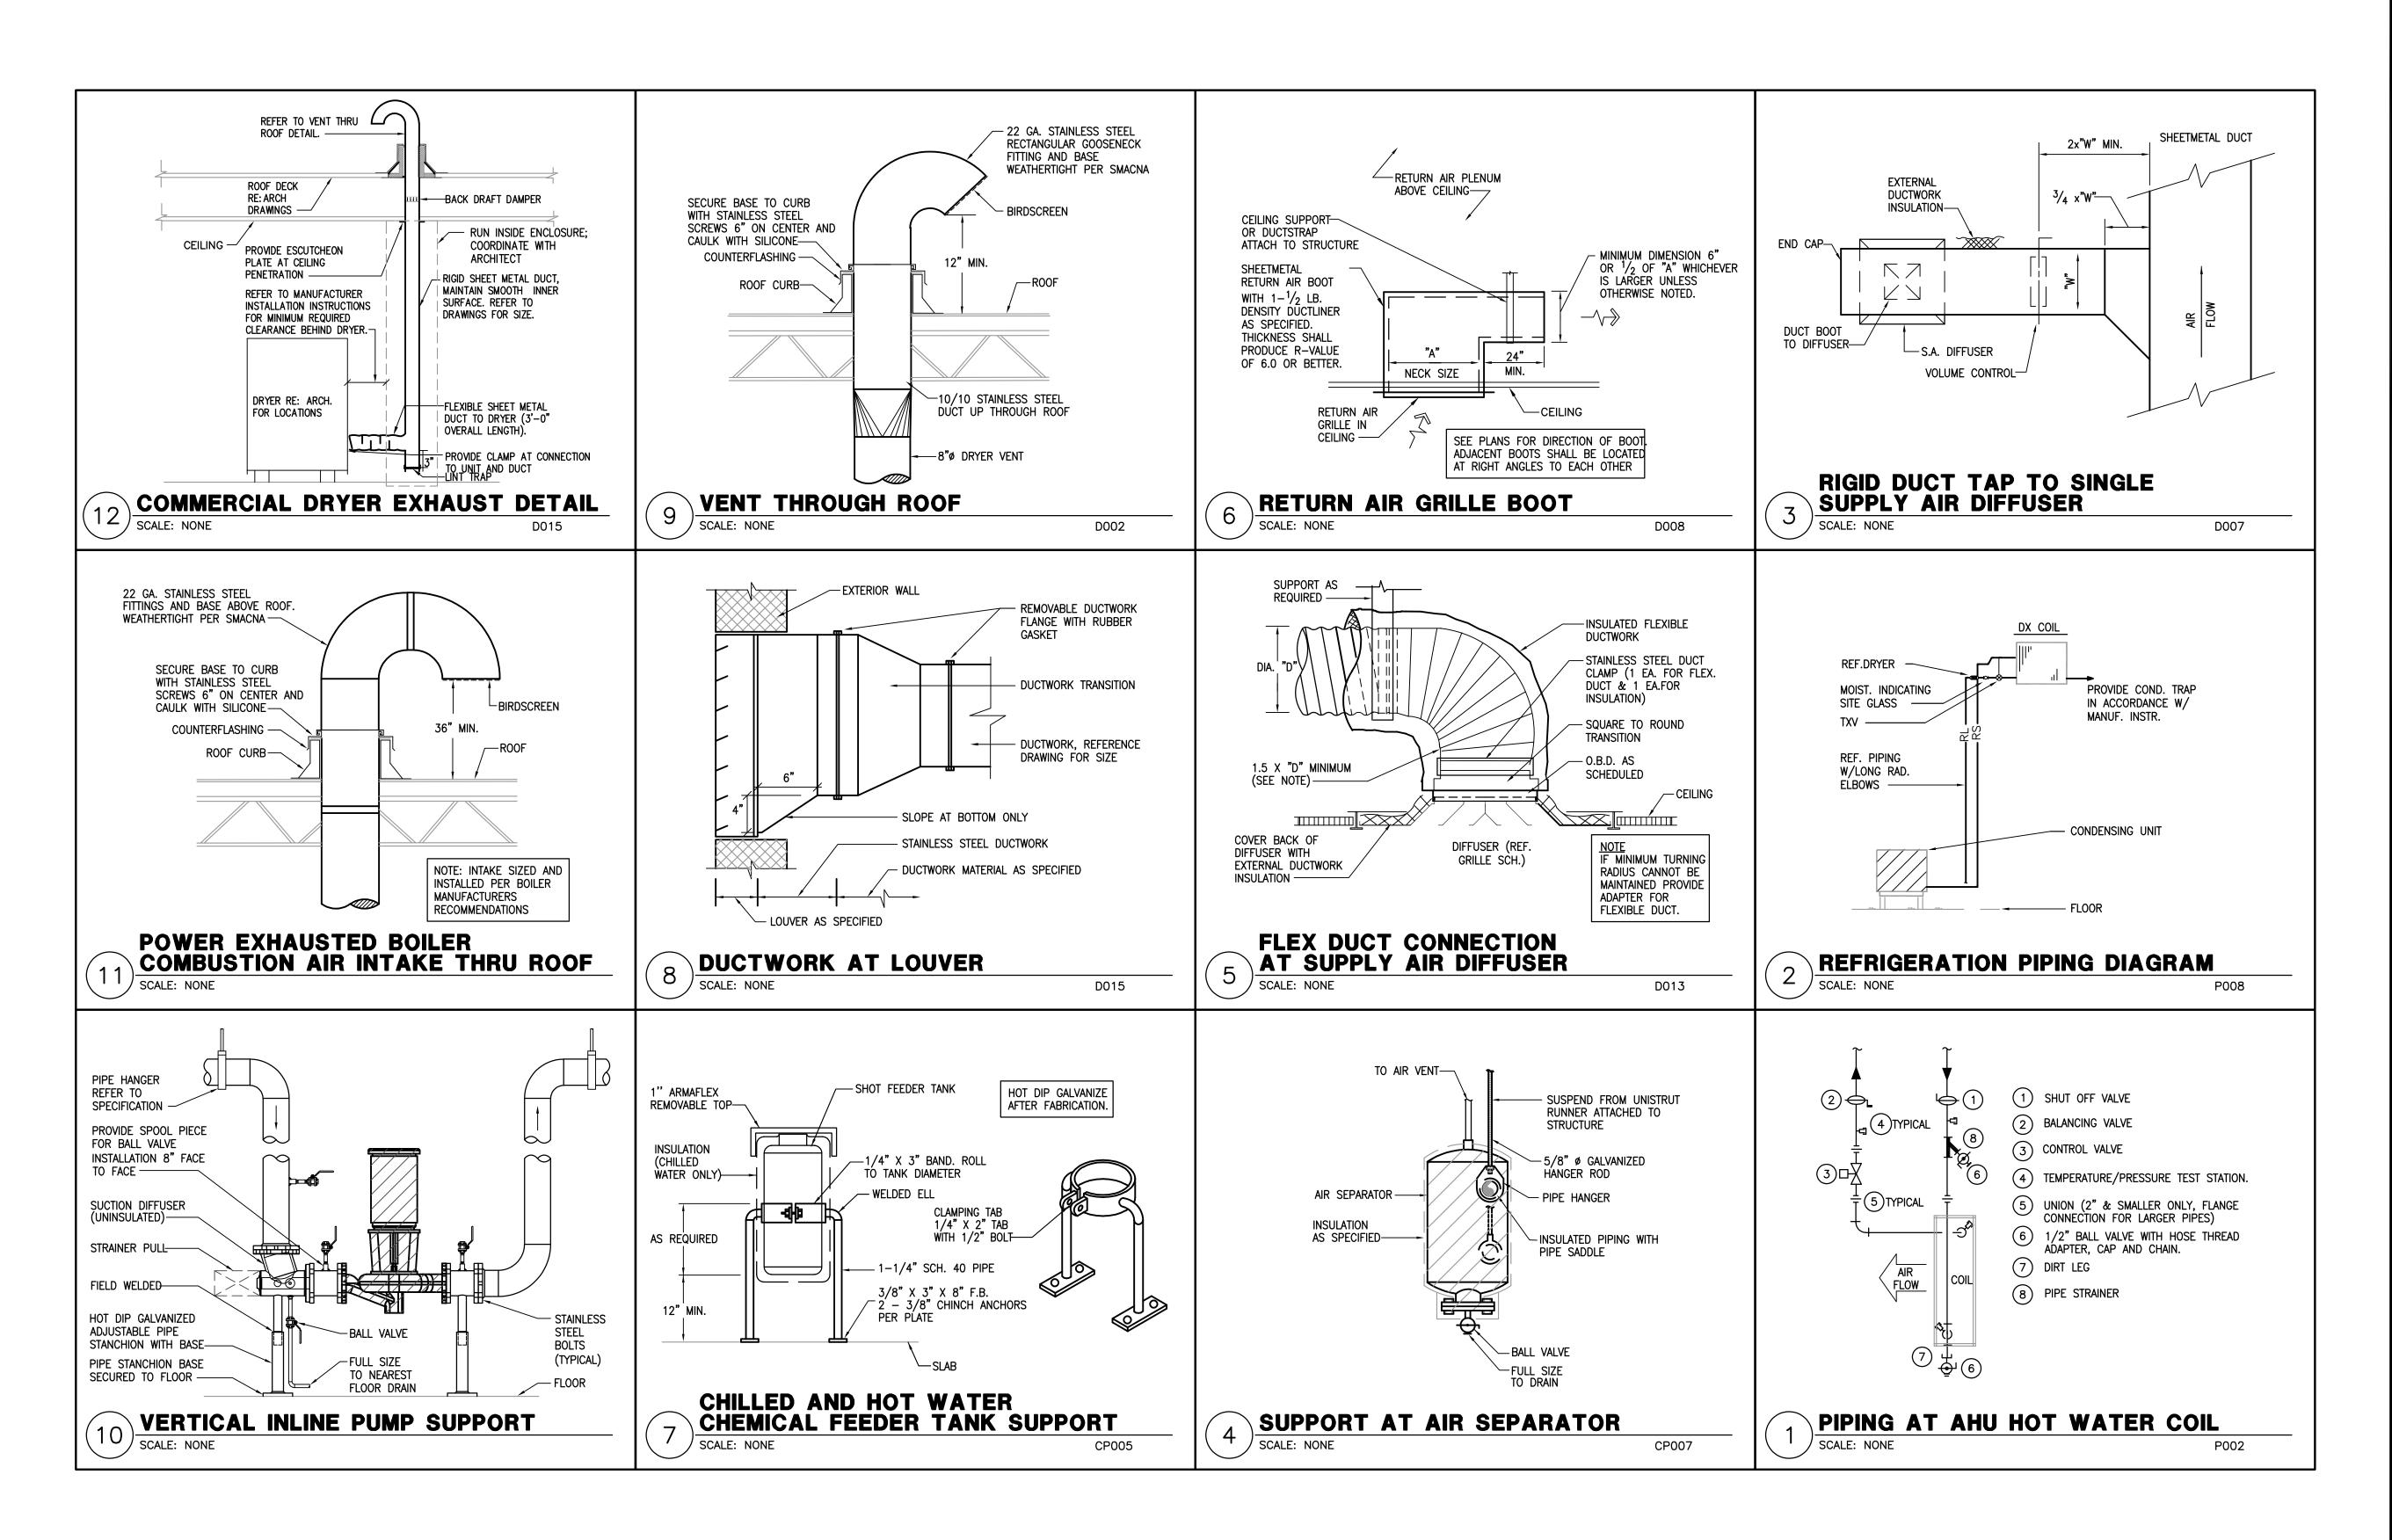
DRAWINGS SHEET TITLE MECHANICAL PIPING DIAGRAM

ALASO'BRIEN


[expect a difference] 10930 W. Sam Houston Parkway N., Suite 900 Houston, Texas 77064 281.664.1900 | Registration No. F-4111 21021 Project No. 2021-04159-00 PROJECT NUMBER




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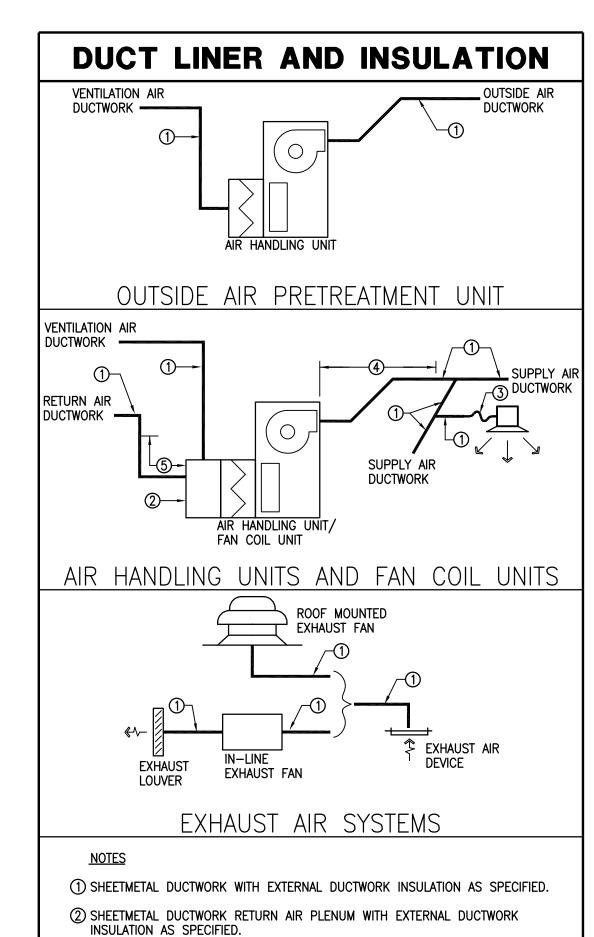
DRAWINGS SHEET TITLE **MECHANICAL** LEGEND AND

SHEET NUMBER

50'BRIEN

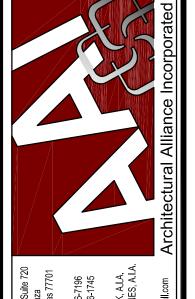10930 W. Sam Houston Parkway N., Suite 900 Houston, Texas 77064 281.664.1900 | Registration No. F-4111

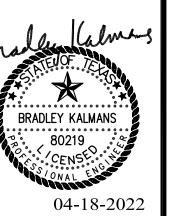Project No. 2021-04159-00



(3) FLEXIBLE DUCTWORK WITH EXTERNAL DUCTWORK INSULATION AS SPECIFIED.

10'-0" DOWNSTREAM.


4 SHEETMETAL DUCTWORK WITH EXTERNAL DUCTWORK INSULATION AS SPECIFIED AND

(5) SHEETMETAL DUCTWORK WITH EXTERNAL DUCTWORK INSULATION AS SPECIFIED AND


1" THICK 1-1/2 LB LINER AS SPECIFIED FROM AIR HANDLING UNIT INLET TO 10'-0" UPSTREAM.


(6) EXHAUST DUCTWORK AS SPECIFIED WITH FIREBOARD INSULATION AS SPECIFIED.

1" THICK 1-1/2 LB LINER AS SPECIFIED FROM AIR HANDLING UNIT DISCHARGE TO

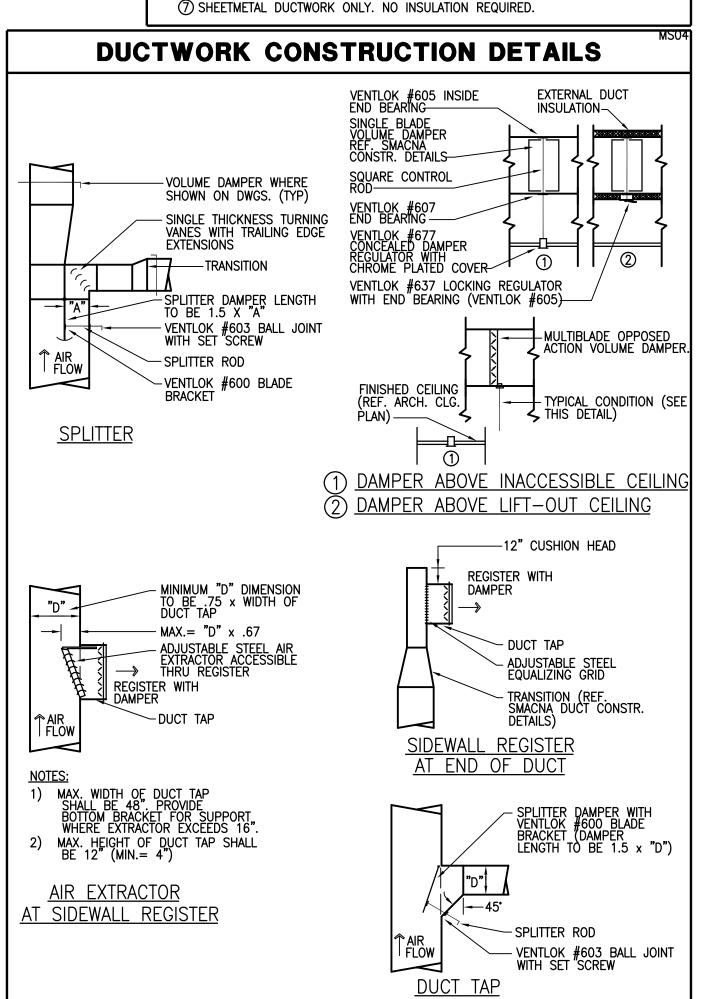


SYMBOL LEGEND DESCRIPTION (DISREGARD ITEMS NOT SHOWN ON PLANS) SUBSCRIPTS AND ABREVIATIONS AFF ABOVE FINISHED FLOOR BELOW BOTTOM OF STRUCTURE BOTTOM OF DUCT BOTTOM OF PIPE COMBUSTION AIR CFM | CUBIC FEET PER MINUTE EXHAUST AIR FEET PER MINUTE NORMALLY CLOSED NO NORMALLY OPEN OUTSIDE AIR RETURN AIR SUPPLY AIR

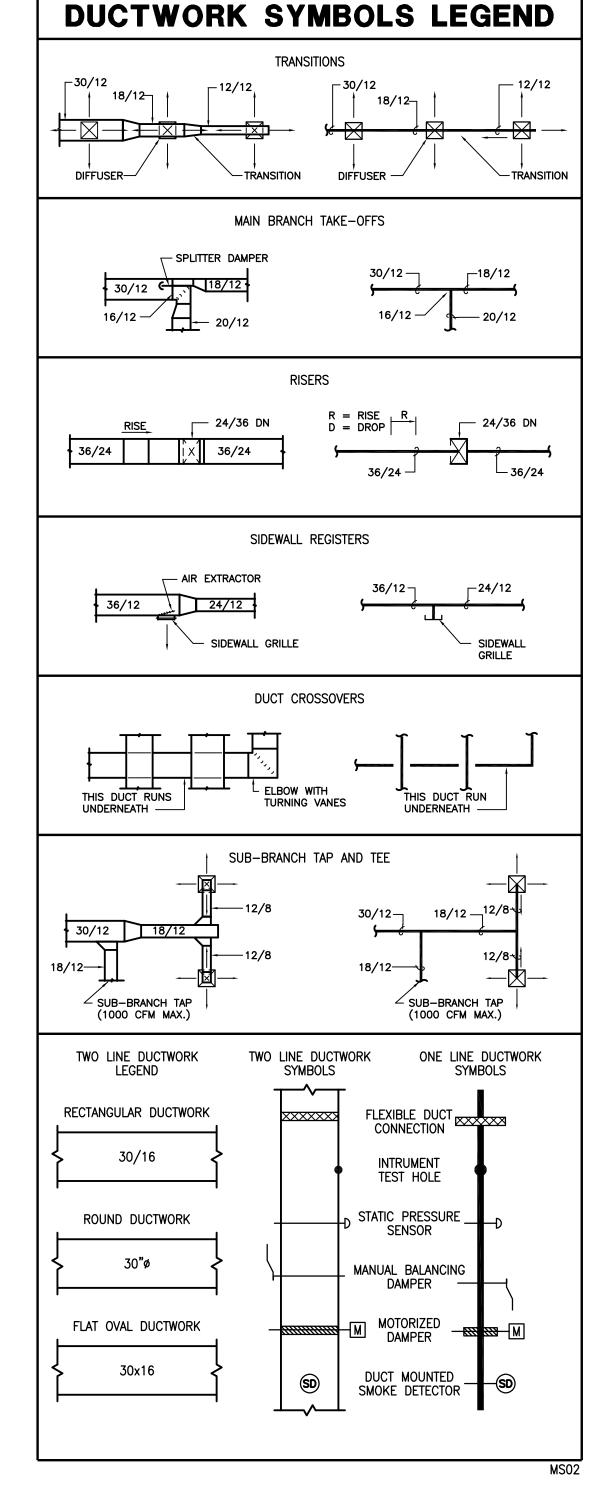


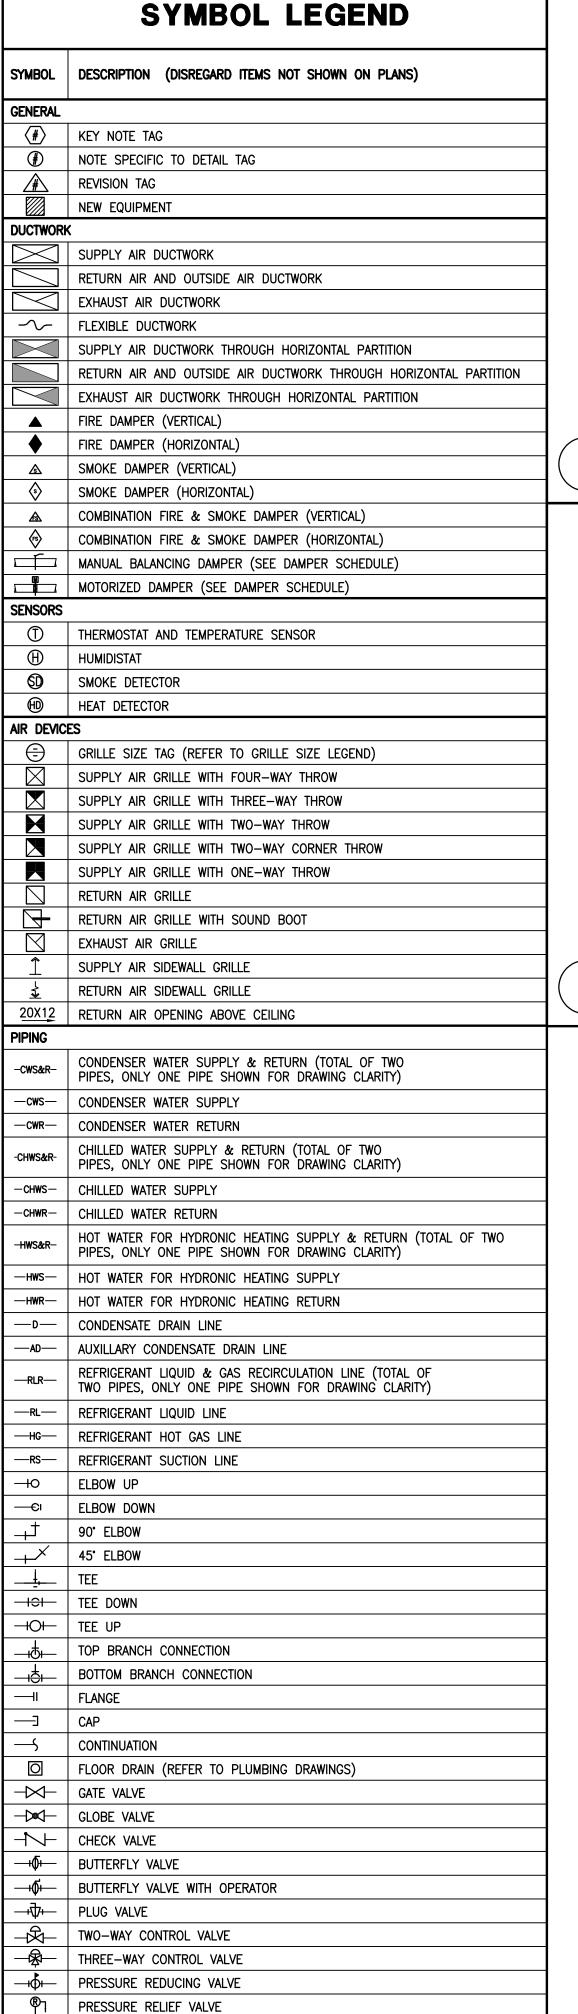



—ф— ∣ BALL VALVE

STRAINER

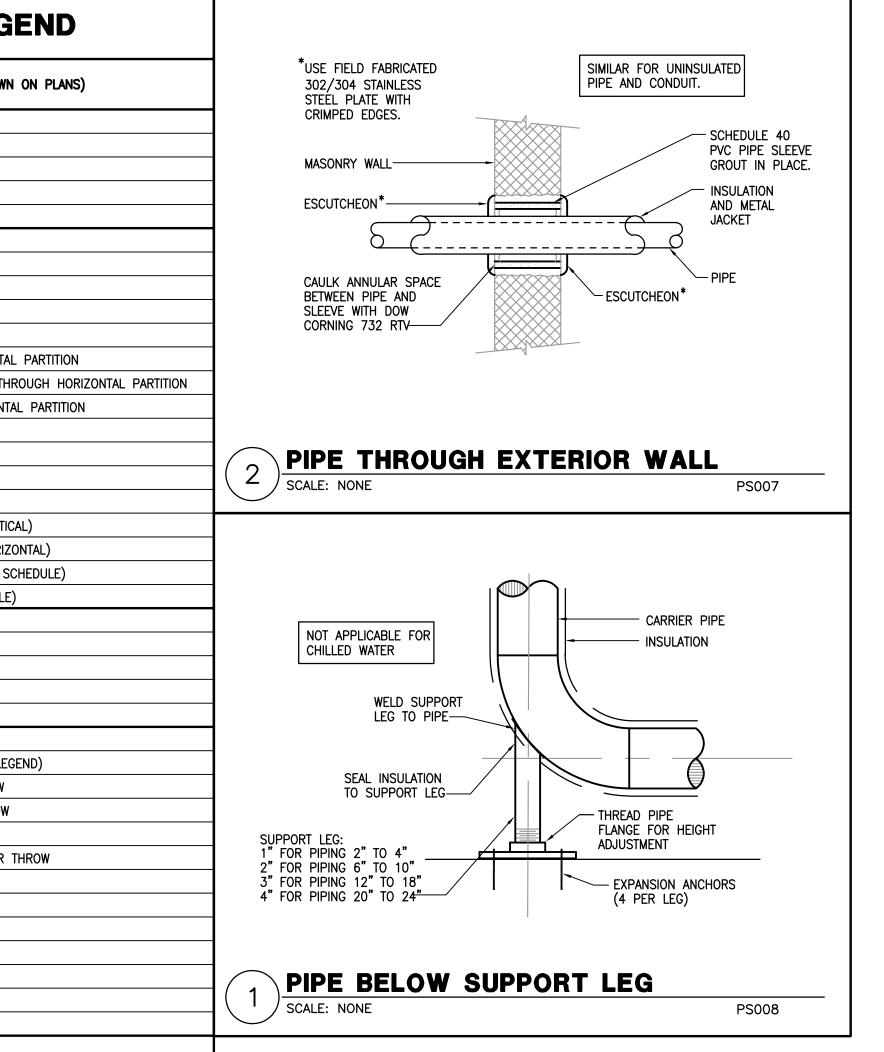

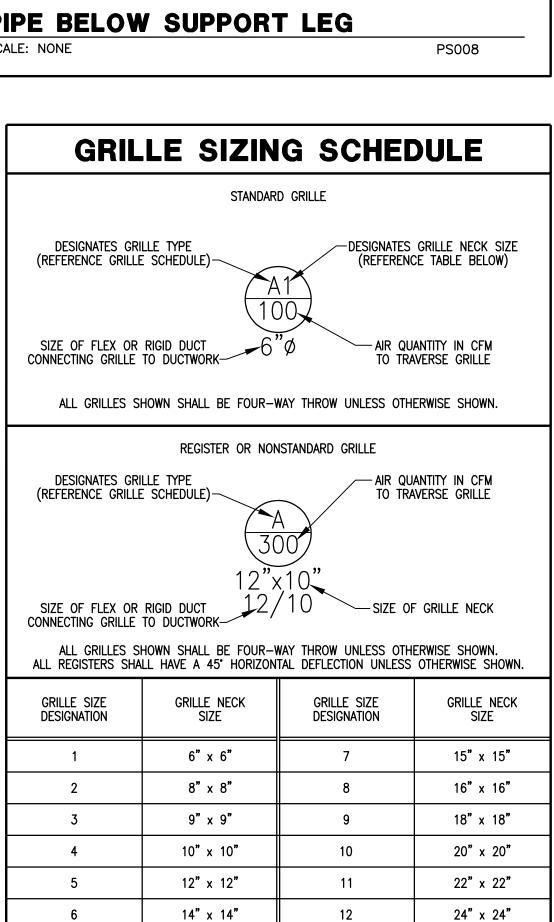

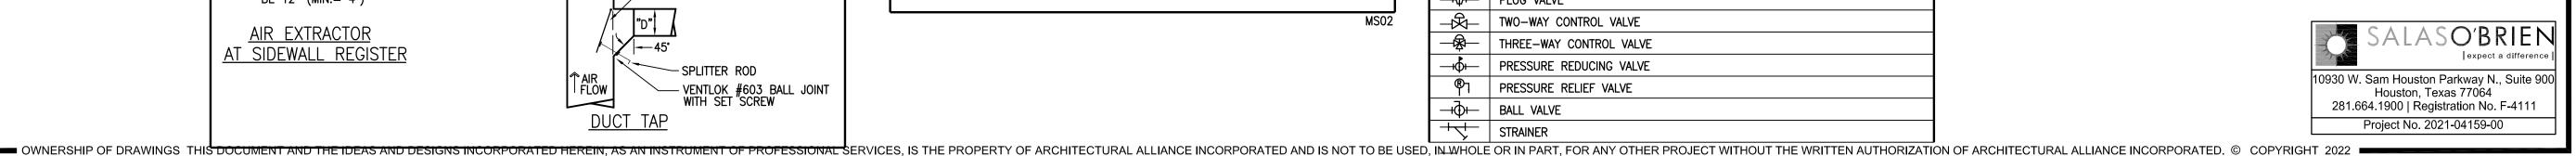

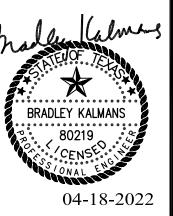

HOUSE FIELD JXILIARY A S Ŏ

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DATE: 01/12/2022 DESIGN DEVELOPMENT -DATE:_---

BIDS & CONSTRUCTION 🗵 DATE <u>04/18/2022</u> REVISION: DATE:____

REVISION: DATE:_ REVISION: DATE:

DRAWINGS SHEET TITLE

MECHANICAL LEGEND AND

SHEET NUMBER 21021

	100% OUTSIDE AIR UNIT - GAS HEAT																	
		INDOOR	AIR FAN					COOLING	;				GAS HEATING		ELECTRICAL	REQUIR	EMENTS	
MARK	SUPPLY AIR CFM	AIR CFM	EXT. STATIC PRESSURE (IN. W.C.)	POWER	FNTFRING	EMPERATUR ENTERING WET BULB	OÙTDOOR	MIN. TOTAL CAPACITY (BTUH)	MIN. SENSIBLE CAPACITY (BTUH)	MINIMUM SEER/EER	NUMBER OF STAGES	ENTERING AIR TEMP. (*F)	MIN. OUTPUT CAPACITY (BTUH)	AGA EFFICIENCY (%)	CURRENT CHARAC.	MCA	моср	REMARKS
DOAS-1	3,500	3,500	1.2	2.67	98.0	80.0	98.0	323,500	169,200	-/10.4	MOD.	27.0	112,883	80%	480/3/60	56.6	70.0	1,2,3,4,5,6,7,8,9,10

GENERAL NOTES:

- 1. EXTERNAL STATIC PRESSURE INCLUDES LOSSES DUE TO DUCTWORK, AIR DEVICES, DAMPERS, AND DUCT MOUNTED HOT WATER COILS WHERE APPLICABLE. DIRTY FILTER AND UNIT CASING MUST BE ADDED TO EXTERNAL STATIC PRESSURE TO OBTAIN TOTAL PRESSURE LOSS. INCREASE HORSEPOWER AS REQUIRED TO MEET YOUR TOTAL PRESSURE LOSS. COORDINATE WITH ELECTRICIAN.
- MINIMUM RECOMMENDED CLEARANCE AROUND ROOFTOP UNIT IS 12 INCHES ON NON-SERVICE SIDES AND 30 INCHES ON SERVICE SIDES. MAINTAIN MINIMUM CLEARANCE FOR CONDENSER AIR FLOW AS RECOMMENDED BY ROOFTOP UNIT MANUFACTURER. MAINTAIN MINIMUM CLEARANCE AS REQUIRED TO OPEN ACCESS AND CONTROL DOORS ON ROOFTOP UNIT FOR SERVICE, MAINTENANCE, AND INSPECTION. MAINTAIN MINIMUM ELECTRICAL CLEARANCE AS REQUIRED BY NEC.

- 1. PROVIDE UNIT WITH DISCONNECT SWITCH.
- PROVIDE PAD MOUNTED UNIT PROVIDE UNIT WITH MODULATING HOT GAS REHEAT TO DELIVER 70°F LEAVING AIR.
- PROVIDE UNIT WITH DOUBLE WALL CONSTRUCTION AS SPECIFICED.
- 5. PROVIDE UNIT WITH VARIABLE SPEED / DIGITAL SCROLL COMPRESSOR. 6. PROVIDE UNIT WITH DDC SPACE AND HUMIDITY SENSOR.
- 7. PROVIDE UNIT WITH FRONT DISCHARGE.
- 8. PROVIDE UNIT WITH REMOTE TOUCH SCREEN USER INTERFACE.
- 9. PROVIDE UNIT WITH MODULATING HOT GAS HEAT.
- 10. MECHANICAL CONTRACTOR IS RESPONSIBLE FOR ALL ELECTRICAL COSTS IF ALTERNATE UNIT IS PROVIDED WITH GREATER ELECTRICAL CHARACTERISTICS THEN SHOWN.

							FA	N					
MARK	LOCATION	СҒМ	MAXIMUM RPM	EXT. STATIC PRESSURE (IN. W.C.)	HORSE POWER	CURRENT CHARAC.	LOCALLY SWITCHED BY	INTERLOCKED WITH	FAN TYPE	BELT/DIRECT DRIVE	MANUFACTURER	MODEL NUMBER	REMARKS
EF-1	LOCKERS 106	1,800	1,593	0.5	1/2	120/1/60	_	AHU-1	INLINE	BELT	соок	SQNB	1,2,3,4
EF-2	LOCKERS 126	815	1,030	0.4	1/4	120/1/60	_	AHU-4	INLINE	BELT	COOK	SQNB	1,2,3,4
EF-3	121 126	350	1,314	0.3	1/4	120/1/60	_	AHU-3	INLINE	BELT	соок	SQNB	1,2,3,4

GENERAL NOTES:

- 1. EXTERNAL STATIC PRESSURE INCLUDES LOSSES DUE TO DUCTWORK, AIR DEVICES, DAMPERS, AND DUCT MOUNTED HOT WATER COILS WHERE APPLICABLE. DIRTY FILTER AND UNIT CASING MUST BE ADDED TO EXTERNAL STATIC PRESSURE TO OBTAIN TOTAL PRESSURE LOSS. INCREASE HORSEPOWER AS REQUIRED TO MEET YOUR TOTAL PRESSURE LOSS. COORDINATE WITH ELECTRICIAN.
- 2. MINIMUM RECOMMENDED CLEARANCE AROUND UNIT IS 12 INCHES ON NON-SERVICE SIDES AND 30 INCHES ON SERVICE SIDES. MAINTAIN MINIMUM CLEARANCE AS REQUIRED TO OPEN ACCESS AND CONTROL DOORS ON UNIT FOR SERVICE, MAINTENANCE, AND
- INSPECTION. MAINTAIN MINIMUM ELECTRICAL CLEARANCE AS REQUIRED BY NEC. 3. FAN SHALL BE CENTRIFUGAL, BELT DRIVEN TYPE UNLESS OTHERWISE SCHEDULED.

- 1. REFER MANUFACTURER FOR INSTALLATION INSTRUCTIONS.
- PROVIDE WITH DISCONNECT SWITCH.
- SUSPEND UNIT WITH FOUR HANGER RODS ATTACHED TO TWO UNISTRUT RUNNERS SECURED TO STRUCTURE. PROVIDE SPRING ISOLATION. REFER TO MANUFACTURER FOR MORE INFORMATION.
- 4. PROVIDE WITH MOTORIZED DAMPER.

			D	AMPER		
MARK	ACTUATOR	DUTY	BLADE ACTION	MANUFACTURER	MODEL NUMBER	REMARKS
D-1	MANUAL BALANCING	UNDER 9" WIDE	N/A	N/A	N/A	SEE SMACNA CONSTRUCTION DETAILS REFERENCED "TYPICAL CONSTRUCTION DETAILS FOR LOW VELOCITY DUCTS."
D-2	MANUAL BALANCING	OVER 9" WIDE	OPPOSED	RUSKIN	MD-35	MANUAL DAMPER WITH STANDARD CONSTRUCTION FEATURES AND VENTLOCK #639 LOCKING REGULATOR.
D-3	MOTORIZED	OVER 9" WIDE	OPPOSED	RUSKIN	CD-60	LOW LEAKAGE DAMPER WITH BLADE SEALS

N/A - NOT APPLICABLE

						GRILLE		
MARK	SERVICE	TYPE	DAMPER	CONSTRUCTION MATERIAL	FINISH COLOR	MANUFACTURER	MODEL NUMBER	REMARKS
A	SUPPLY AIR	DIFFUSER	_	ALUMINUM	_	TITUS	OMNI	EXPOSED T-BAR CEILING FRAME STYLE WITH A 24" X 24" FACE. (1) OR 12" X 12" FACE. (1)
В	RETURN AIR	DIFFUSER	_	ALUMINUM	_	TITUS	PAR	EXPOSED T-BAR CEILING FRAME STYLE WITH A 24" X 24" FACE. (1) OR 12" X 12" FACE. (1)
С	SUPPLY AIR	DIFFUSER	_	ALUMINUM	_	TITUS	OMNI	SURFACE MOUNTED FRAME STYLE WITH A 24" X 24" FACE. (1) OR 12" X 12" FACE. (1)
D	RETURN AIR	DIFFUSER	_	ALUMINUM	-	TITUS	PAR	SURFACE MOUNTED FRAME STYLE WITH A 24" X 24" FACE. (1) OR 12" X 12" FACE. (1)
E	SUPPLY AIR	GRILLE	_	ALUMINUM	_	TITUS	300RL	DOUBLE DEFLECTION SIDEWALL GRILLE WITH HORIZONTAL FRONT BARS. SURFACE MOUNTED. (1)
F	RETURN AIR	GRILLE	_	ALUMINUM	-	TITUS	350RL	DOUBLE DEFLECTION SIDEWALL GRILLE WITH HORIZONTAL FRONT BARS, SURFACE MOUNTED. (1)

- 1. DAMPERS NOTED AS U. L. SHALL BE A "U. L." CLASSIFIED CEILING
- RADIATION DAMPER WITH THERMAL BLANKET. 2. AIR DEVICE COLOR SHALL BE SELECTED BY ARCHITECT.

1. COORDINATE FINAL AIR DEVICE LOCATIONS WITH ARCHITECT.

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					DL	JCTL	ESS	MINI	SPLI	T D	(UI	TIV					
MARK	SUPPLY AIR CFM		FAN EXT. STATIC PRESSURE (IN. W.C.)		V/PH/HZ	AIR TEMPER ENTERING DRY BULB	RATURE (*F) ENTERING WET BULB		LING MIN. SENSIBLE CAPACITY (BTUH)	MINIMUM EER/ SEER	NUMBER OF STAGES	ENTERING AIR TEMP. (°F)	MINIMUM CAPACITY (BTUH)	HEATIN KW	NUMBER OF STAGES	CURRENT CHARAC.	REMARKS
DMS-1	370	0	0.1	40W	208/1/60	75.0	62.0	18,000	14,400	-/15.0	1		NC	HEATI	NG		1,2,3

- 1. EXTERNAL STATIC PRESSURE INCLUDES LOSSES DUE TO DUCTWORK, AIR DEVICES, DAMPERS, AND DUCT MOUNTED HOT WATER COILS WHERE APPLICABLE. DIRTY FILTER AND UNIT CASING MUST BE ADDED TO EXTERNAL STATIC PRESSURE TO OBTAIN TOTAL PRESSURE LOSS. INCREASE HORSEPOWER AS REQUIRED TO MEET YOUR TOTAL PRESSURE LOSS. COORDINATE WITH ELECTRICIAN.
- MINIMUM RECOMMENDED CLEARANCE AROUND UNIT IS 12 INCHES ON NON-SERVICE SIDES AND 30 INCHES ON SERVICE SIDES. MAINTAIN MINIMUM CLEARANCE AS REQUIRED TO OPEN ACCESS AND CONTROL DOORS ON UNIT FOR SERVICE, MAINTENANCE, AND

INSPECTION. MAINTAIN MINIMUM ELECTRICAL CLEARANCE AS REQUIRED BY NEC.

HIGH WALL UNIT.

- 1. CONTROLLED BY WIRED PROGRAMMABLE THERMOSTAT.
- 2. REFRIGERANT LINES TO BE SIZED PER MANUFACTURER'S REQUIREMENTS.

DX AIR HANDLING UNIT - WITH HOT WATER HEATING MARK SUPPLY OUTSIDE EXT. STATIC HORSE AIR TEMPERATURE (*F) MIN. TOTAL MIN. SENSIBLE MINIMUM NUMBER ENTERING AIR MINIMUM REMARKS CAPACITY ENTERING GPM MAX. PRESSURE HOT (BTUH) TEMP. (*F) GPM DROP (FT.) WATER AIR CFM | AIR CFM | PRESSURE | POWER | ENTERING | ENTERING | CAPACITY CAPACITY OF TEMPERATURE CAPACITY EER/ SEÉR STAGES (°F) DRY BULB | WET BULB | (BTUH) (BTUH) 1-10 1,900 1.0 75.0 62.5 89,775 77,112 11.2/-62.8 122,388 10.0 1-1/4 AHU-1 3,500 160 | 12.2 | 12.2/14.0 67.7 1-10 AHU-2 1,375 350 8.0 75.0 62.5 35,269 30,294 40,769 160 10.0 1-10 AHU-3 1,610 400 0.8 75.0 62.5 37,449 32,167 12.2/14.0 67.3 43,812 160 10.0

11.7/14.0

GENERAL NOTES:

AHU-4

2,150

850

8.0

EXTERNAL STATIC PRESSURE INCLUDES LOSSES DUE TO DUCTWORK, AIR DEVICES, DAMPERS, AND DUCT MOUNTED HOT WATER COILS WHERE APPLICABLE. DIRTY FILTER AND UNIT CASING MUST BE ADDED TO EXTERNAL STATIC PRESSURE TO OBTAIN TOTAL PRESSURE LOSS. INCREASE HORSEPOWER AS REQUIRED TO MEET YOUR TOTAL PRESSURE

75.0

62.5

51,600

44,064

LOSS. COORDINATE WITH ELECTRICIAN. MINIMUM RECOMMENDED CLEARANCE AROUND UNIT IS 12 INCHES ON NON-SERVICE SIDES AND 30 INCHES ON SERVICE SIDES. MAINTAIN MINIMUM CLEARANCE AS REQUIRED TO OPEN ACCESS AND CONTROL DOORS ON UNIT FOR SERVICE, MAINTENANCE, AND INSPECTION. MAINTAIN MINIMUM ELECTRICAL CLEARANCE AS REQUIRED BY NEC.

64.8

1. PROVIDE VERTICAL FLOOR MOUNTED UNIT.

65,588

LOW VELOCITY FLAT FILTER SECTION. PROVIDE WITH AUTOMATIC SHUT OFF FLOAT SWITCH TO DEACTIVATE UNIT IN EVENT PRIMARY DRAIN LINE BECOMES

160

10.0

1-1/4

- 4. VERTICAL DRAW THRU UNIT.
- 5. CONSTANT VOLUME UNIT.
- . HOT WATER COIL IN REHEAT POSITION. LOW VELOCITY ANGLED FILTER SECTION.
- 8. PROVIDE UNIT WITH HUMIDITY CONTROL.
- 9. THREE-WAY HOT WATER CONTROL VALVE.
- 10. PROVIDE WITH DIRECT DRIVE PLENUM FAN WITH VARIABLE FREQUENCY DRIVE.

				BOIL	ER - I	FORCE) AIR	1			
MARK	TYPE	MINIMUM GAS INPUT (MBH)	MINIMUM HEATING OUTPUT (MBH)	MAXIMUM WATER PRESSURE DROP (FT.)	GPM	FLUE SIZE (IN. Ø)	ELECTI BLOWER FLA (AMP)	RICAL ELECTRICAL CHARAC. (V/ø/Hz)	MANUFACTURER	MODEL	REMARKS
B-1	NON-CONDENSING	500	425	10.0	75.0	7	8.8	120/1/60	LOCHINVAR	POWER FIN	1-2

- 1. PROVIDE NON-CONDENSING BOILER. 2. PROVIDE OUTDOOR BOILER.
- MAINTAIN MINIMUM CLEARANCE AROUND A BOILER OF 24 INCHES PER TEXAS BOILER LAW. MAINTAIN MINIMUM CLEARANCES FOR TUBE PULL AND CLEANING OF TUBES AS RECOMMENDED BY THE BOILER'S MANUFACTURER. MAINTAIN MINIMUM CLEARANCE AS REQUIRED TO OPEN ACCESS AND CONTROL DOORS FOR SERVICE, MAINTENANCE AND INSPECTION. MAINTAIN MINIMUM ELECTRICAL CLEARANCES AS

REQUIRED BY NEC.

PROVIDE 8 OUNCE GAS PRESSURE TO BOILER.

GENERAL NOTES:

GENERAL NOTES:

					PU	MP				
MARK	SERVICE	TYPE	GРM	HEAD (FT.)	MAXIMUM RPM	MOTOR HORSEPOWER	CURRENT	MANUFACTURER	MODEL	REMARKS
HWP-1	HEATING HOT WATER	VERTICAL INLINE	75.0	70.0	1,750	5	480/3/60	BELL & GOSSETT	E-80SC	1,2,3

- PUMP IS TO HAVE A NON-OVERLOADING MOTOR.
- MINIMUM RECOMMENDED CLEARANCE AROUND A PUMP IS 24 INCHES. MAINTAIN MINIMUM CLEARANCES AS REQUIRED FOR SERVICE, MAINTENANCE, AND

- 1. PROVIDE SUCTION DIFFUSER WITH GAUGE TAPS AT PUMP INLET. PROVIDE WITH VARIABLE FREQUENCY DRIVE.
- PROVIDE PUMP WITH GAUGE TAPS.

	AIR (COOLI	ED C	ONDE	ENSIN	IG UN	IT		
MARK	MIN. TOTAL CAPACITY (BTUH)	OUTDOOR AIR TEMP (*F)	MINIMUM EER/ SEER	NUMBER OF STAGES	RELATED UNIT MARK	CURRENT CHARAC.	MCA	MOCP	REMARKS
DXCU-1	89,775	95.0	11.2/-	2	AHU-1	480/3/60	16	30	1,2
DXCU-2	35,269	95.0	12.2/14.0	2	AHU-2	480/3/60	7.6	15	1,2
DXCU-3	37,449	95.0	12.2/14.0	2	AHU-3	480/3/60	7.6	15	1,2
DXCU-4	51,600	95.0	11.7/14.0	2	AHU-4	480/3/60	9.7	15	1,2
DMSCU-1	17,100	95.0	-/15.0	1	DMS-1	208/1/60	12	20	1,2

MINIMUM RECOMMENDED CLEARANCE AROUND ROOFTOP UNIT IS 12 INCHES ON NON-SERVICE SIDES AND 30 INCHES ON SERVICE SIDES. MAINTAIN MINIMUM CLEARANCE FOR CONDENSER AIR FLOW AS RECOMMENDED BY UNIT MANUFACTURER. MAINTAIN MINIMUM CLEARANCE AS REQUIRED TO OPEN ACCESS AND CONTROL DOORS ON UNIT FOR SERVICE, MAINTENANCE, AND INSPECTION. MAINTAIN MINIMUM ELECTRICAL CLEARANCE AS REQUIRED BY NEC.

1. PROVIDE WITH PENDENT MOUNTED THERMOSTAT

2. PROVIDE WITH DISCONNECT SWITCH.

PROVIDE WITH LOW AMBIENT. PROVIDE WITH DISCONNECT SWITCH.

		UNI	ТН	EATI	ER -	ELECT	'RIC	
MARK	MINIMUM CAPACITY (BTUH)	KW	STAGES	CURRENT CHARAC.	CFM	MANUFACTURER	MODEL	REMARKS
EUH-1	10,240	3.0	2	277/1/60	310	REZNOR	EGEB	1,2

50'BRIEN

Project No. 2021-04159-00

21021 PROJECT NUMBER

|10930 W. Sam Houston Parkway N., Suite 900| Houston, Texas 77064 281.664.1900 | Registration No. F-4111

1-10

BRADLEY KALMANS , 80219 04-18-2022

HOUSE \Box 田田 **JXILIAR** \forall BRO(

100% REVIEW DATE: 01/12/2022 DESIGN DEVELOPMENT -

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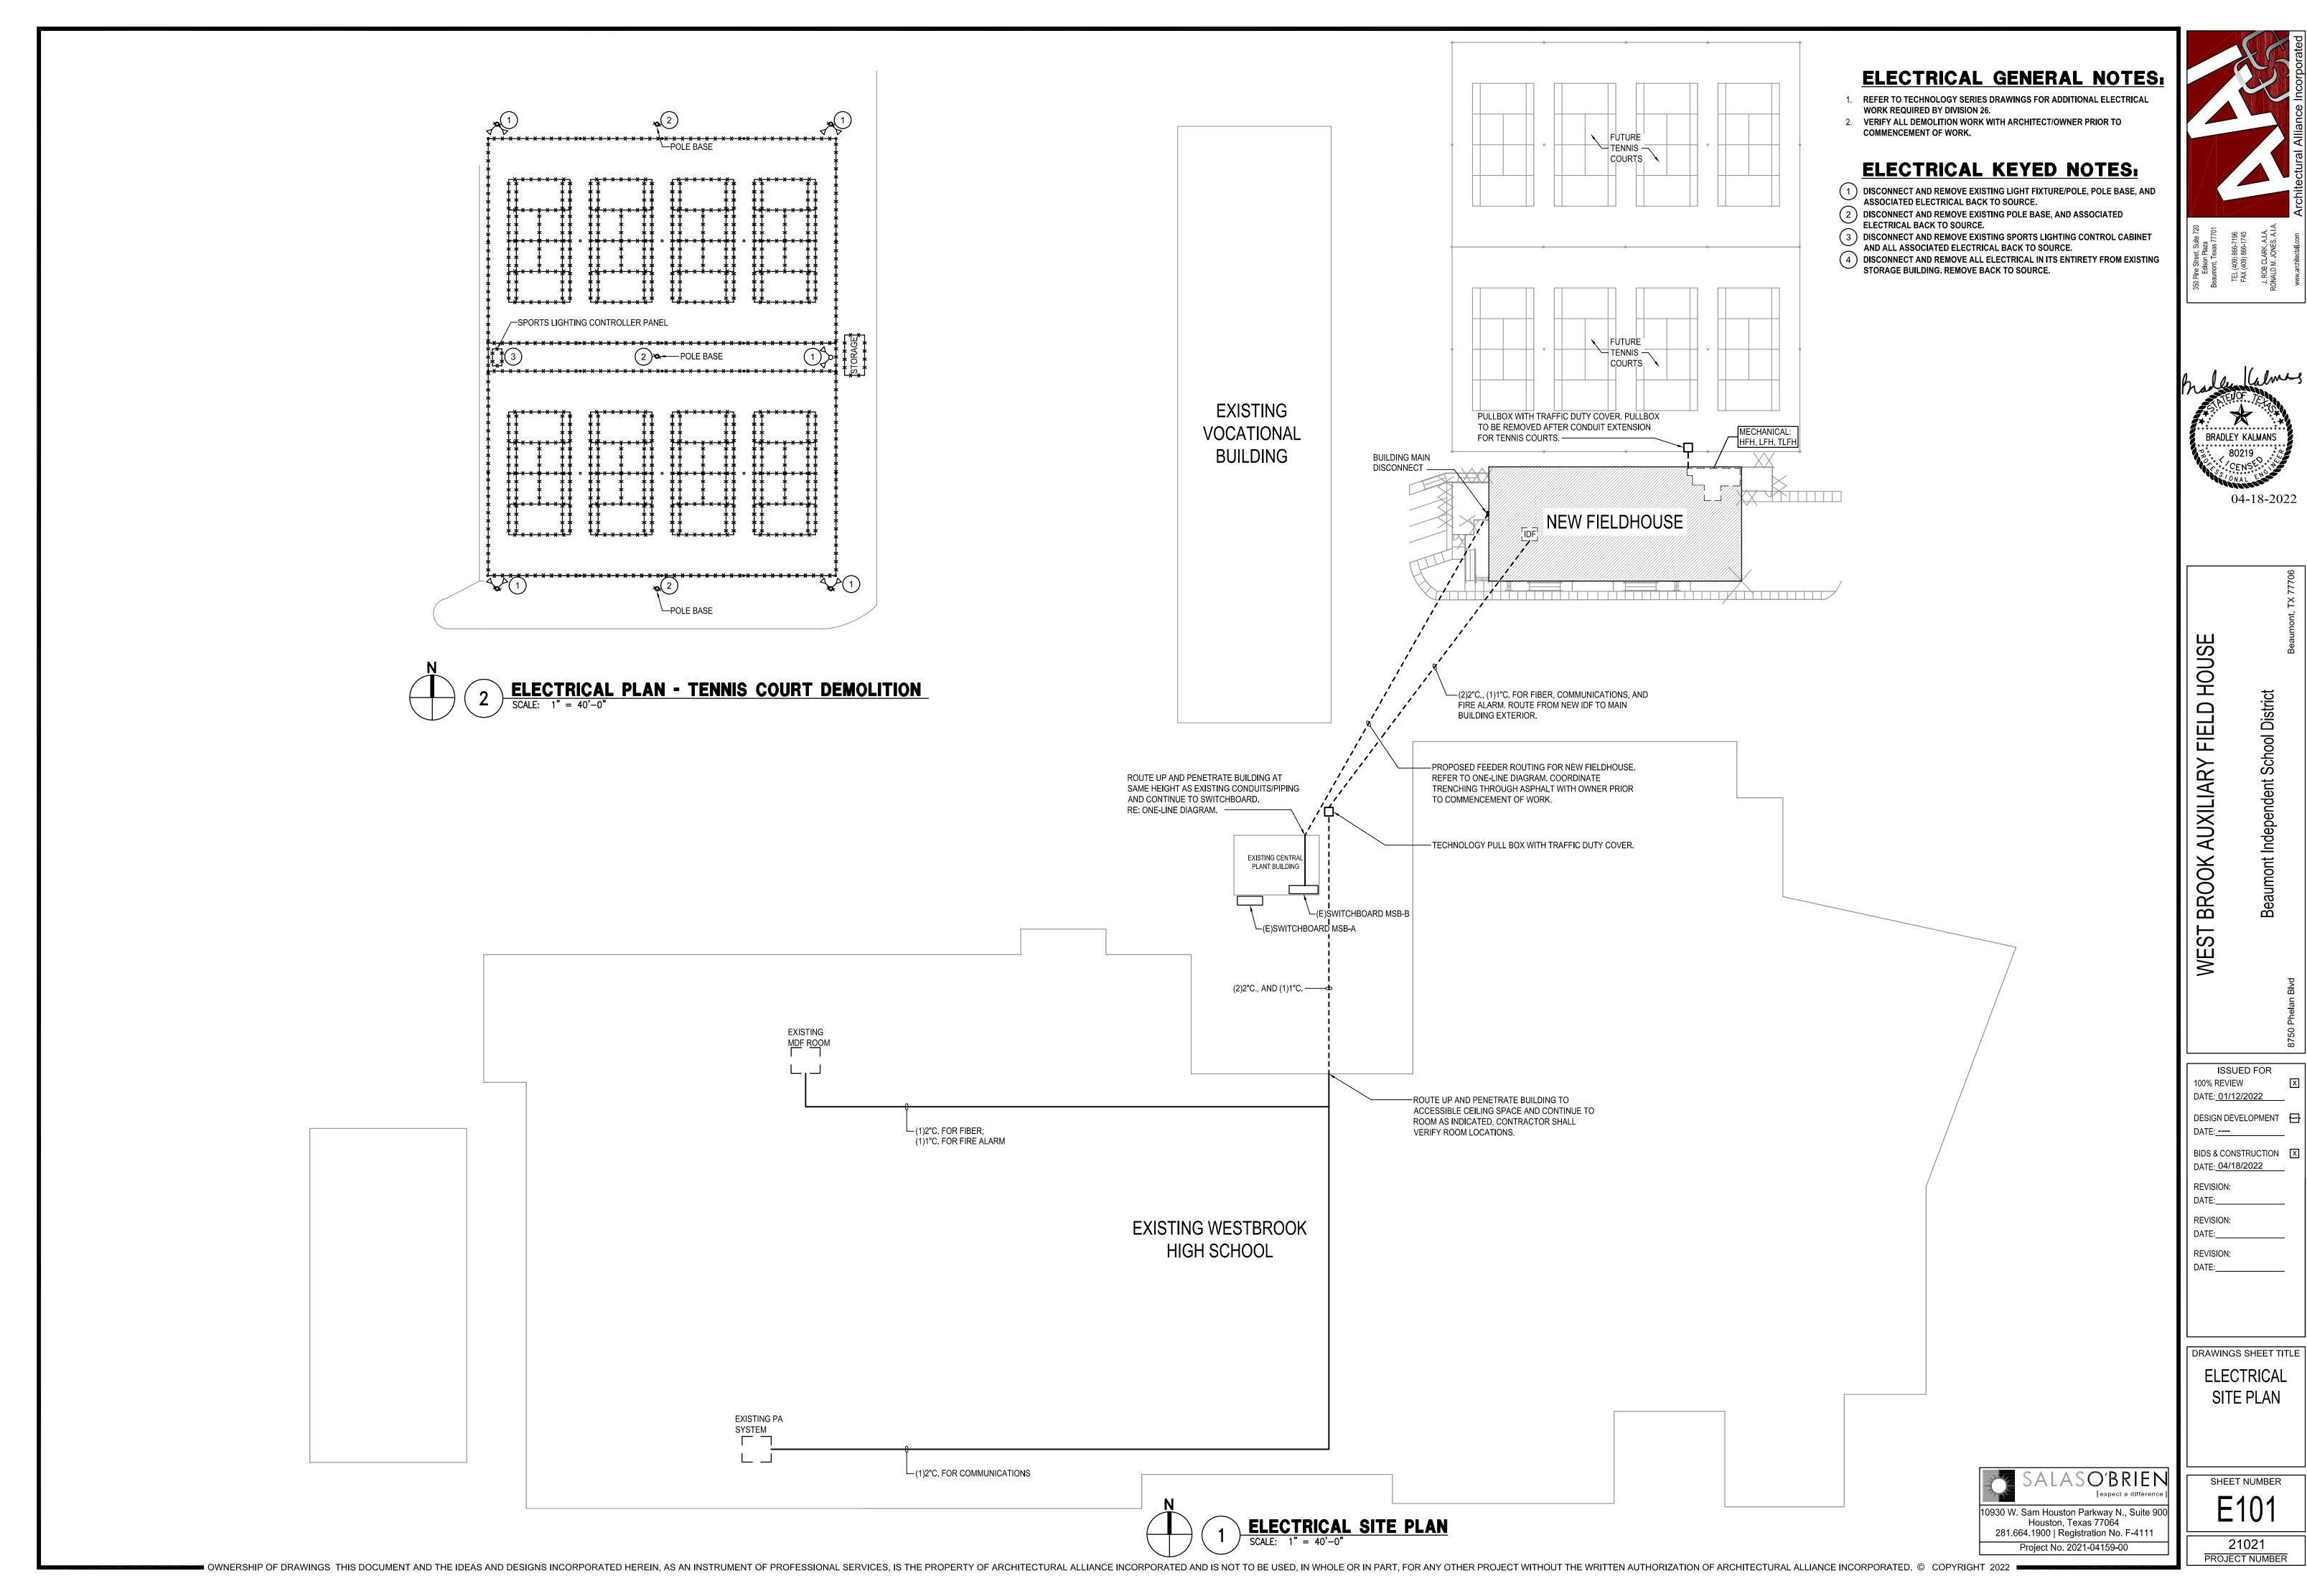
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DRAWINGS SHEET TITLE **MECHANICAL**




ELECTRICAL GENERAL NOTES:

- PROVIDE A CONSTANT HOT FROM THE LINE SIDE OF SWITCH SERVING SPACE FOR EXIT LIGHTS (I.E. EXIT SIGNS, BATTERY PACKS, INVERTER, ETC.) 2. ALL LIGHT FIXTURES IN MECHANICAL AREAS SHALL BE COORDINATED WITH
- MECHANICAL, PLUMBING, AND TECHNOLOGY EQUIPMENT TO AVOID CONFLICTS. LOCATE LIGHT FIXTURES ON CHAIN FROM STRUCTURE OR MOUNTED ON PERIMETER WALLS WHERE PRACTICAL. NOTIFY ENGINEER OF ANY CONFLICTS.

ELECTRICAL KEYED NOTES:

MOUNT IN UPPER CAVITY OF CORRUGATED CANOPY WITH WATER -TIGHT SEALS AND STAINLESS STEEL MOUNTING HARDWARE. CONCEAL CONDUITS AS MUCH AS POSSIBLE.

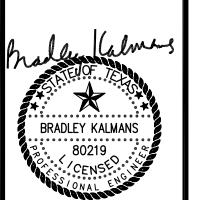

04-18-2022

WEST BROOK AUXILIARY FIELD HOUSE

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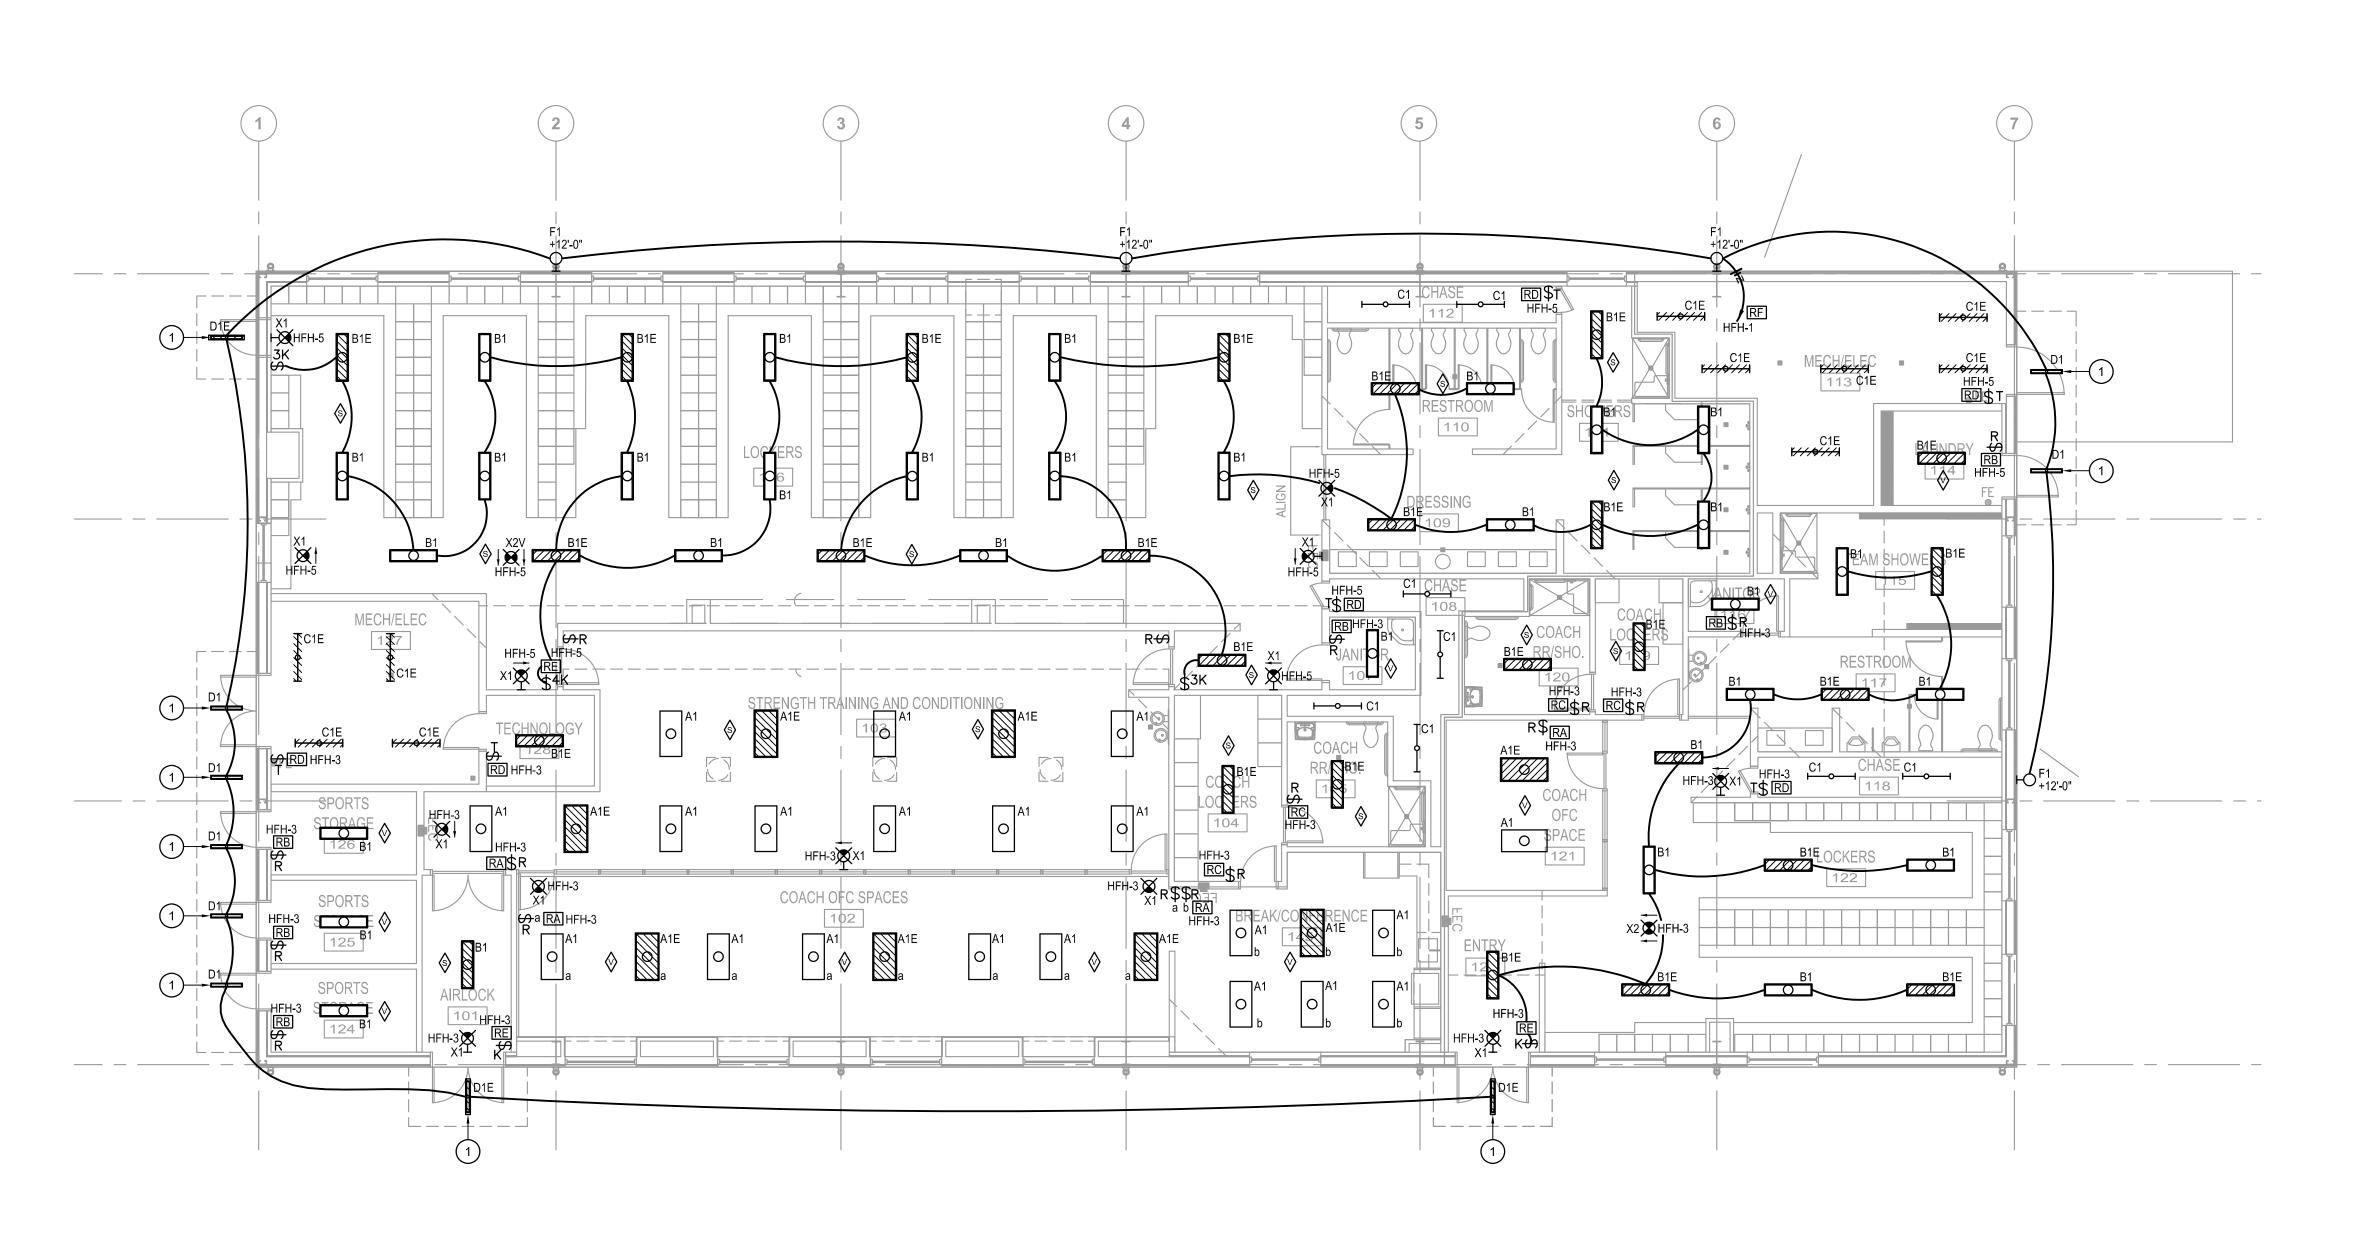
DRAWINGS SHEET TITLE LIGHTING FLOOR

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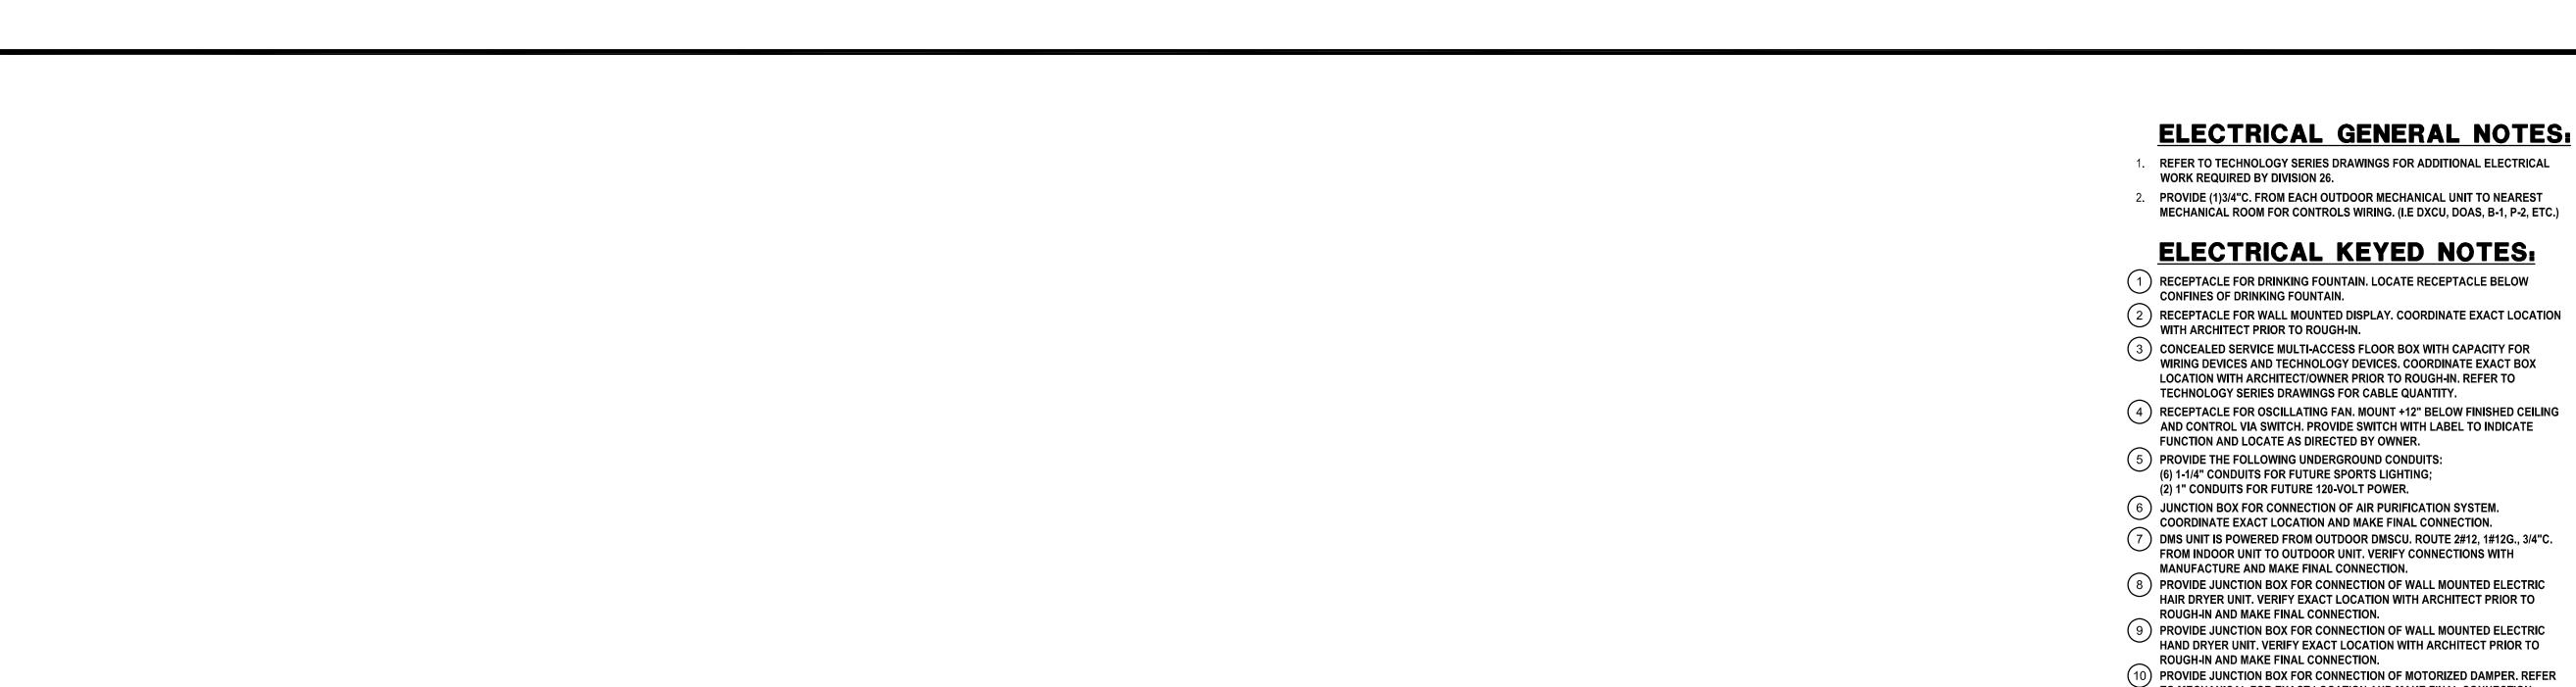
10930 W. Sam Houston Parkway N., Suite 900 Houston, Texas 77064 281.664.1900 | Registration No. F-4111


Project No. 2021-04159-00


21021 PROJECT NUMBER




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BRADLEY KALMANS

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TO MECHANICAL FOR EXACT LOCATION AND MAKE FINAL CONNECTION.

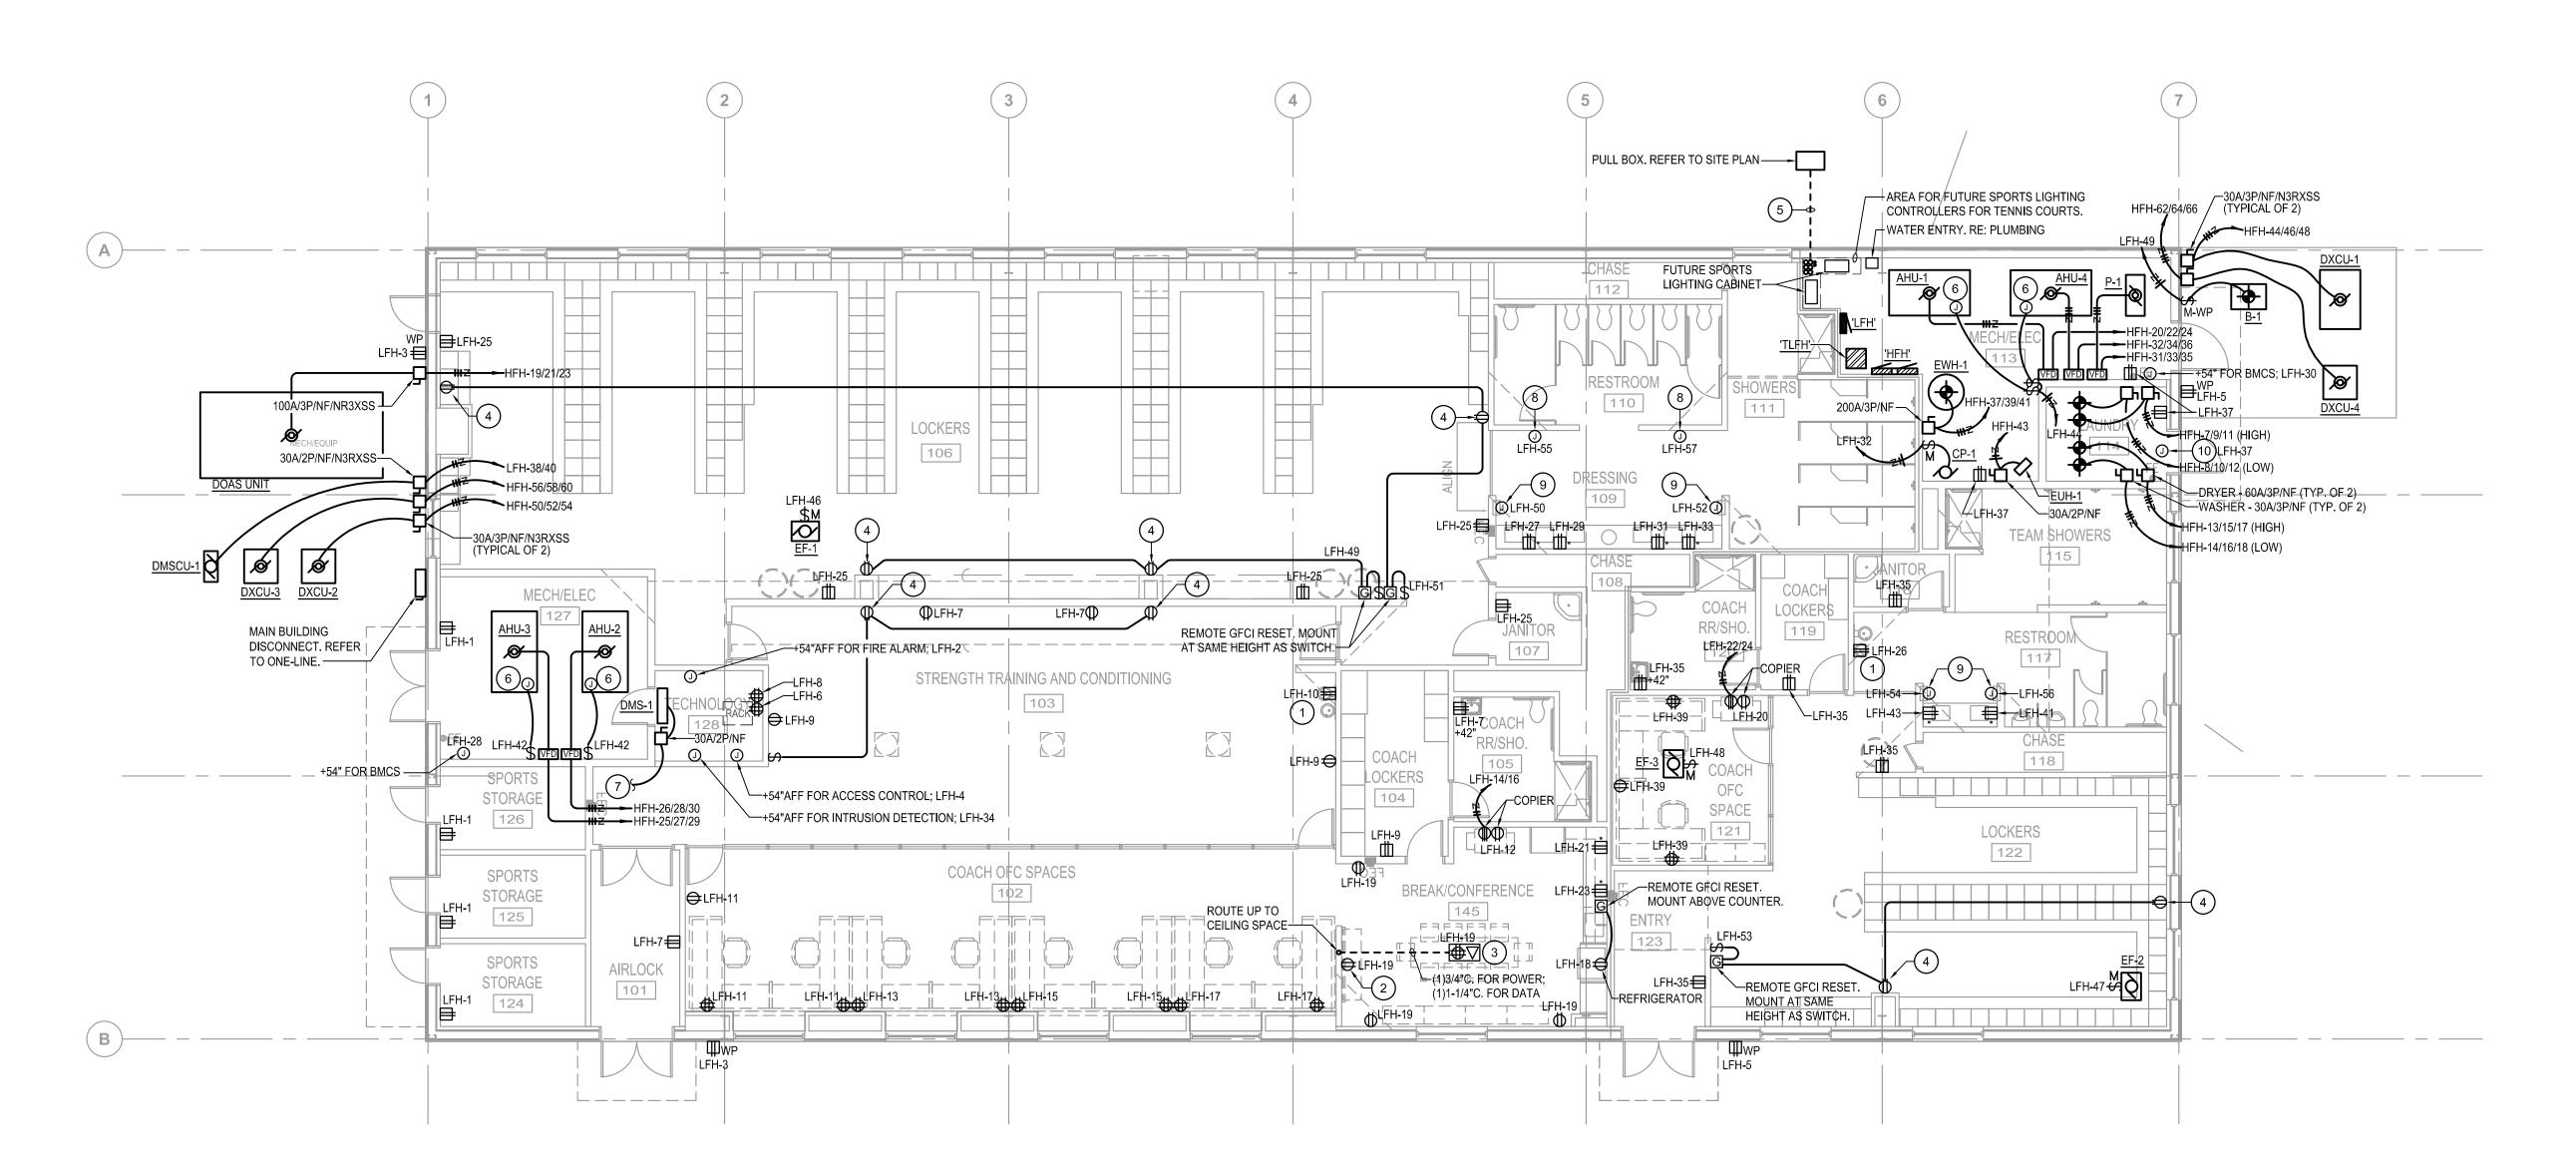Beaumont Independent School District

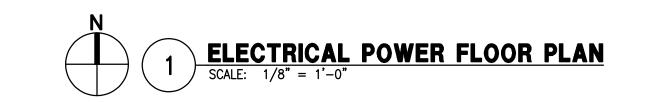FIELD HOUSE

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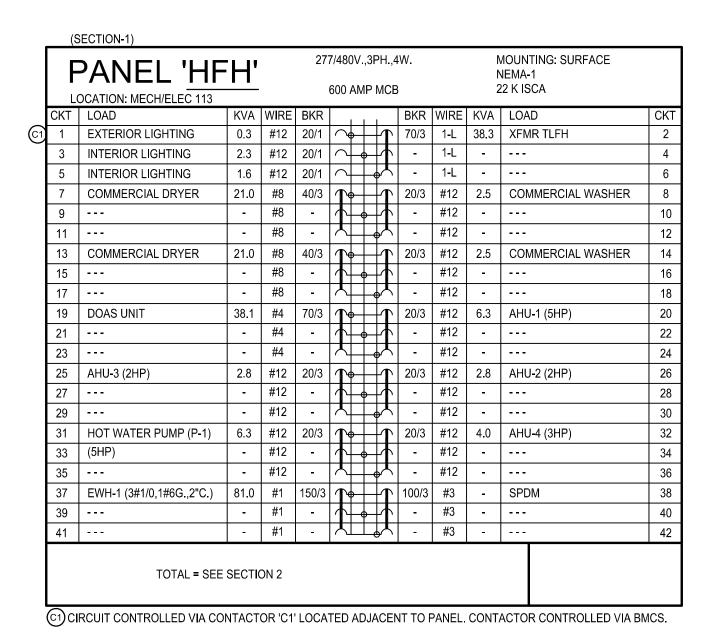
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DRAWINGS SHEET TITLI

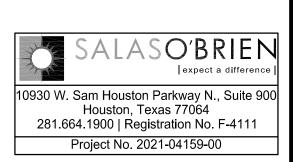ELECTRICAL POWER FLOOR PLAN

SHEET NUMBER




	PANEL DOCATION: MECH/EL		<u>H'</u>			7/480 600 .						N	MOUNTING: SURFACE IEMA-1 12 K ISCA	
KT	LOAD		KVA	WIRE	BKR					BKR	WIRE	KVA	LOAD	CKT
43	EUH-1		3.0	#12	20/1	\sim		7	$\overline{\mathbf{T}}$	30/3	#10	10.6	DXCU-1	44
45	SPARE				20/1	\	4	7	$\overline{\Lambda}$	-	#10	-		46
1 7	SPARE				20/1	7		—	Т	-	#10	-		48
19	SPARE				20/1	~		4	$\overline{1}$	20/3	#12	5.0	DXCU-2	50
51	SPARE				20/1		4	7	$\overline{\Lambda}$	-	#12	-		52
53	SPARE				20/1			—	\overline{A}	-	#12	-		54
55	SPACE					\sim	\Box	7	$\overline{\mathbf{T}}$	20/3	#12	5.0	DXCU-3	56
57	SPACE	Ī					4	7	不	-	#12	-		58
59	SPACE							4	X	-	#12	-		60
31	SPACE					~	\Box	7	$\overline{f T}$	20/3	#12	6.4	DXCU-4	62
33	SPACE					7	4	7	$\overline{\mathbf{\Lambda}}$	-	#12	-		64
35	SPACE					7		—	Т	-	#12	-		66
67	SPACE					~		4	\rangle				SPACE	68
69	SPACE						4	7	\rangle				SPACE	70
'1	SPACE							—	\supset				SPACE	72
'3	SPACE					~	\Box	7	$\overline{)}$				SPACE	74
'5	SPACE					7	4	7	$\overline{)}$				SPACE	76
7	SPACE							4	\supset				SPACE	78
' 9	SPACE					\sim		7	$\overline{}$				SPACE	80
31	SPACE					$\overline{}$	4	7	$\overline{\ }$				SPACE	82
33	SPACE					$\overline{}$		-	$\overline{}$				SPACE	84

	PANEL 'LF LOCATION: MECH/ELEC 113	<u>H'</u>					BPH.,			١	MOUNTING: SURFACE NEMA-1 IO K ISCA	
СКТ	1	KVA	WIRE	BKR				BKR	WIRE	KVA	LOAD	СК
1	RECEPTACLES	0.7	#12	20/1		$\downarrow \downarrow$	$\downarrow \sim$	20/1	#12	0.5	FIRE ALARM	2
3	RECEPTACLES	0.4	#12	20/1	$\overline{}$		$\downarrow \sim$	20/1	#12	0.5	ACCESS CONTROL	1
5	RECEPTACLES	0.4	#12	20/1	$\overline{}$	\exists	\downarrow	20/1	#12	0.7	IDF RECEPTACLES	1
7	RECEPTACLES	0.7	#12	20/1	$\overline{}$		\perp	20/1	#12	0.7	IDF RECEPTACLES	1 8
9	RECEPTACLES	0.7	#12	20/1			\downarrow	20/1	#12	0.4	DRINKING FOUNTAIN	1
11	RECEPTACLES	0.9	#12	20/1	$\overline{}$	Ⅎ	\downarrow	20/1	#12	1.5	COPIER	1
13	RECEPTACLES	0.7	#12	20/1	$\overline{}$	$\downarrow \downarrow$	<u></u>	20/2	#12	2.0	COPIER	1
15	RECEPTACLES	0.7	#12	20/1	$\overline{}$		╁┸	-	#12	-		1
17	RECEPTACLES	0.7	#12	20/1	$\overline{}$	Ⅎ	\downarrow	20/1	#12	0.6	REFRIGERATOR	1
19	RECEPTACLES	1.1	#12	20/1		\pm	\bot	20/1	#12	1.5	COPIER	2
21	DED. RECEPTACLE	1.0	#12	20/1			<u></u>	20/2	#12	2.0	COPIER	2
23	DED. RECEPTACLE	1.0	#12	20/1	$\overline{}$	Ĭ	$\downarrow \downarrow$	-	#12			1 2
25	RECEPTACLES	0.9	#12	20/1		\downarrow	\perp	20/1	#12	0.4	DRINKING FOUNTAIN	1 2
27	DED. RECEPTACLE	1.0	#12	20/1			\perp	20/1	#12	0.5	BMCS	1 2
29	DED. RECEPTACLE	1.0	#12	20/1	$\overline{}$	Ĭ	\downarrow	20/1	#12	0.5	BMCS	3
31	DED. RECEPTACLE	1.0	#12	20/1		\pm	\perp	20/1	#12	0.2	CP-1	3
33	DED. RECEPTACLE	1.0	#12	20/1			\pm	20/1	#12	0.5	INTRUSION DETECTION	3
35	RECEPTACLES	0.9	#12	20/1	$\overline{}$	1	\downarrow	20/1	" '2	0.0	SPARE	3
37	RECEPTACLES	0.5	#12	20/1		\forall		20/2	#12	2.5	DMSCU-1 / DMS-1	3
39	RECEPTACLES	0.9	#12	20/1			╁	-	#12			4
41	DED. RECEPTACLE	1.0	#12	20/1				20/1	#12	0.4	AIR PURIFICATION	4
43	DED. RECEPTACLE	1.0	#12	20/1		\forall		20/1	#12	0.4	AIR PURIFICATION	4
45	BOILER (B-1)	0.6	#12	20/1				20/1	#12	1.1	EF-1	4
47	EF-2	0.7	#12	20/1				20/1	#12	0.7	EF-3	4
49	OSC. FAN RECEPT.	0.4	#12	20/1		\pm	\perp	20/1	#12	1.5	ELEC. HAND DRYER	5
51	OSC. FAN RECEPT.	0.4	#12	20/1			\pm	20/1	#12	1.5	ELEC. HAND DRYER	5
53	OSC. FAN RECEPT.	0.4	#12	20/1	$\overline{}$	1	\downarrow	20/1	#12	1.5	ELEC. HAND DRYER	5
(G) 55	ELEC. HAIR DRYER	1.5	#10	20/1		\top		20/1	#12	1.5	ELEC. HAND DRYER	5
G 57	ELEC. HAIR DRYER	1.5	#10	20/1		$\uparrow\uparrow$		20/1	#12	1.5	SPACE SPACE	5
59	SPARE SPARE	1.5	#10	20/1		Ť	T .	20/1			SPARE	6
61	SPARE			20/1		+		20/1			SPARE	6
63	SPARE			20/1				20/1			SPARE	1 6
65	SPARE			20/1				20/1			SPARE	1 6
67	SPARE	+		20/1		\mp		20/1			SPARE	6
69	SPARE	+		20/1		7	T.	20/1			SPARE	7
71	SPARE			20/1		\dashv	Ţ.	20/1			SPARE	7
73	SPARE			20/1	\ \ \	\exists		20/1			SPARE	7
75	SPARE			20/1		7	_ _	20/1			SPARE	7
77	SPARE	+		20/1		\dashv	Ţ.,	20/1			SPARE	 ' 7
79	SPARE	+		20/1		Ħ	<u> </u>	30/3	#10	_	SPDL	8
		+			_ *		 	30/3	#10	-	5PDL	8
81	SPARE	+		20/1	 	H][#10	<u>-</u>		+
83	SPARE			20/1	<u>'</u> '		-ლ \		π10		· · ·	8

(G) PROVIDE GFCI TYPE CIRCUIT BREAKER. TYPE AS REQUIRED. (L) PROVIDE WITH LOCK-OFF DEVICE.
(L) PROVIDE WITH LOCK-ON DEVICE.

ELECTRICAL LOAD ANALY 480V,3PH.,4W	SIS
PEAK KVA @ 125%	1875.0
LIGHTING - CALC. 9,935 SF x 3W	29.8
LIGHTING (CONNECTED)	(5.3)
RECEPTACLES (CONNECTED)	(10.2)
1ST 10KVA @ 100% (NEC 220-44)	10.0
REMAINDER @ 50% (NEC 220-44)	0.1
MISCELLANEOUS	63.9
HVAC: AHU, VAV, PUMPS, ETC	96.2
ELEC. WATER HEATING @ 125%	101.3
FUTURE LOAD	80.0
TOTAL	2256.3


TOTAL / 480 $\sqrt{3}$ = 2715.2 AMPS (EXISTING 4000-AMP SERVICE)

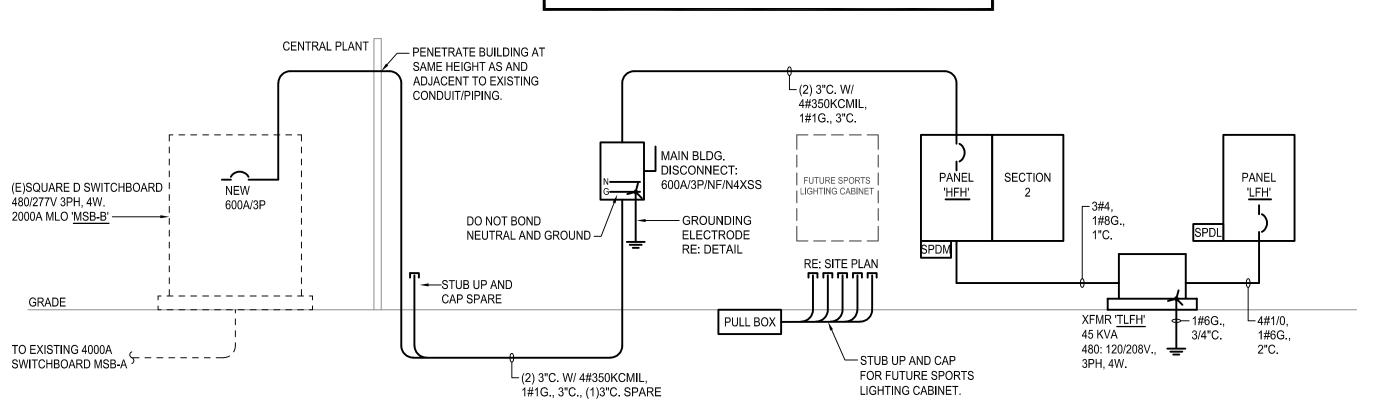


-ALL CONDUCTORS AND GROUNDS ARE COPPER UNLESS NOTED OTHERWISE-





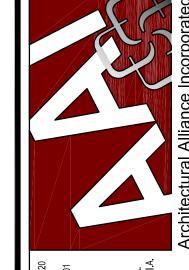

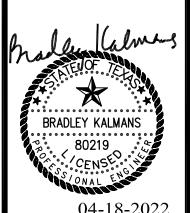

04-18-2022

FIELD HOUSE A BROOK WEST

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> DRAWINGS SHEET TITLE ELECTRICAL ONE-LINE AND PANEL SCHEDULES

SHEET NUMBER

		LIGHTI	NG FIXT	ΓURE	SC	HEC	ULE	
MARK	MANUFACTURER AND CATALOG NUMBER	MOUNTING	TYPE/LUMENS	KELVIN COLOR	CRI	VOLTS	INPUT WATTAGE	REMARKS
A1	METALUX# 24FP4740C	RECESSED	LED / 4700 LU	4000K	80+	UNV	42W	2X4 FLAT PANEL, OPAQUE LENS, 0-10V DIMMING, DLC LISTED.
A1E	METALUX# 24FP4740C + EL14W	RECESSED	LED / 4700 LU	4000K	80+	UNV	42W	2X4 FLAT PANEL, OPAQUE LENS, 0-10V DIMMING, DLC LISTED. PROVIDE WITH 90-MIN EM BATTERY.
B1	METALUX# 14FP4240C + DF14WU	RECESSED	LED / 4200 LU	4000K	80+	UNV	39W	1X4 FLAT PANEL, OPAQUE LENS, 0-10V DIMMING, DLC LISTED. PROVIDE WITH DRYWALL KIT.
B1E	METALUX# 14FP4240C + DF14WU + EL14W	RECESSED	LED / 4200 LU	4000K	80+	UNV	39W	1X4 FLAT PANEL, OPAQUE LENS, 0-10V DIMMING, DLC LISTED. PROVIDE WITH DRYWALL KIT AND 90-MIN EM BATTERY.
C1	METALUX# 4SNLED-LD5-37SL-LW-UNV-CD1-U + AYC-CHAIN/SET	SURFACE/ CHAIN	LED / 3800 LU	4000K	80+	UNV	31W	4-FOOT STRIP LIGHT, FROSTED LENS, WIRE GUARD, CHAIN HANG KIT, DLC LISTED.
C1E	METALUX# 4SNLED-LD5-37SL-LW-UNV-CD1-U + EL14W + AYC-CHAIN/SET	SURFACE/ CHAIN	LED / 3800 LU	4000K	80+	UNV	31W	4-FOOT STRIP LIGHT, FROSTED LENS, WIRE GUARD, CHAIN HANG KIT, DLC LISTED. PROVIDE WITH 90-MIN EM BATTERY.
D1	ALW# LP3.5SMBWL-S3-LOW-0/10V/S- EXT/F-AL-UNV	SURFACE/ CANOPY	LED / 600 LU/FT	4000K	80+	UNV	15W	3-FOOT EXTRUDED ALUMINUM, END FEED, WET LOCATION, LOW PROFILE, DIFFUSE LENS.
D1E	ALW# LP3.5SMBWL-S3-LOW-0/10V/S- EXT/F-AL-UNV + EMB/1	SURFACE/ CANOPY	LED / 600 LU/FT	4000K	80+	UNV	15W	3-FOOT EXTRUDED ALUMINUM, END FEED, WET LOCATION, LOW PROFILE, DIFFUSE LENS. PROVIDE WITH 90-MIN EM BATTERY.
F1	MCGRAW EDISON# IST-AF-1000-LED-E1-T4FT-BZ-LCF	WALL	LED / 6274 LU	4000K	70+	UNV	55W	ARCHITECTURAL WALLPACK, FORWARD THROW DISTRIBUTION, BRONZE FINISH, DLC LISTED. TRIM PLATE SHALL MATCH HOUSING COLOR.
X1	SURE-LITES# UX7-1-WH-SD	UNIVERSAL	LED	-	-	UNV	< 5W	SINGLE-FACED VANDAL RESISTANT EXIT SIGN, WHITE HOUSING, RED LETTERING, 90-MIN EM BATTERY. PROVIDE WITH CHEVRON DIRECTIONAL ARROWS PER PLANS OR BY AHJ.
X2	SURE-LITES# UX7-2-WH-SD	UNIVERSAL	LED	-	-	UNV	< 5W	DOUBLE-FACED VANDAL RESISTANT EXIT SIGN, WHITE HOUSING, RED LETTERING, 90-MIN EM BATTERY. PROVIDE WITH CHEVRON DIRECTIONAL ARROWS PER PLANS OR BY AHJ.

**REFER TO SPECIFICATIONS FOR APPROVED MANUFACTURER LIST.

NOTES:

EMERGENCY BATTERY BACK-UP, WHEN SPECIFIED, SHALL ENERGIZE FIXTURE FOR A MINIMUM OF 90-MINUTES, REFER TO SPECIFICATIONS FOR ADDITIONAL REQUIREMENTS NOT INDICATED IN THE LIGHT FIXTURE SCHEDULE. WHERE THERE IS AN INCONSISTENCY BETWEEN THE LIGHT SCHEDULE AND THE SPECIFICATIONS, THE BETTER QUALITY OF WORK SHALL BE INCLUDED IN THE PROPOSAL.

LIGHT FIXTURE APPROVAL WILL BE DETERMINED AFTER REVIEW OF SHOP DRAWING TO DETERMINE IF THE FIXTURE OR POLE SUBMITTED MEETS OR EXCEEDS THE DESIGN STANDARDS AND PERFORMANCE REQUIRED OF THE FIXTURE SPECIFIED IN THE LIGHT FIXTURE SCHEDULE OR SPECIFICATIONS. IT SHALL BE THE RESPONSIBILITY OF THE CONTRACTOR TO PROVIDE THE SPECIFIED LIGHT FIXTURE IF A SUBSTITUTION IS NOT APPROVED WITHOUT ANY ADDITIONAL COST TO THE OWNER. WHERE SPECIFIC OPTIONS/ACCESSORIES ARE SPECIFIED OR REQUIRED, THEY SHALL BE PROVIDED WITHOUT ANY ADDITIONAL COST TO THE OWNER.

DUE TO THE WIDE RANGE OF FIXTURE QUALITIES OFFERED BY EACH MANUFACTURER, THE APPROVED LIGHTING MANUFACTURERS SUBSTITUTION LIST IS NOT INTENDED TO INDICATE THAT ANY OR ALL MANUFACTURERS LISTED WILL HAVE SUITABLE SUBSTITUTIONS FOR THE LIGHT FIXTURES OR POLES SPECIFIED IN THE LIGHT FIXTURE SCHEDULE. SHOP DRAWING AND CONSTRUCTION DELAYS AS A RESULT OF INAPPROPRIATE SUBSTITUTIONS SHALL BE THE RESPONSIBILITY OF THE CONTRACTOR AND SHALL NOT RESULT IN ANY ADDITIONAL COST TO THE OWNER.

	LIGHTING CONTROLS SCHEDULE							
TYPE	SENSOR FUNCTION	# OF ZONES	DESCRIPTION					
RA	VACANCY - MANUAL ON / AUTO OFF	1	DIGITAL KEYPAD; ON/OFF SWITCH WITH RAISE LOWER; 0-10V DIMMING.					
RB	RB VACANCY - MANUAL ON / AUTO OFF 1 DIGITAL KEYPAD; ON/OFF SWITCH.							
RC	OCCUPANCY - AUTO ON / AUTO OFF	1	DIGITAL KEYPAD; ON/OFF SWITCH. (FULL AUTO IECC EXCEPTION FOR SAFETY/SECURITY)					
RD	NONE	1	WATTSTOPPER 12-HOUR TIMER SWITCH WITH VISUAL/AUDIO ALARM.					
RE	OCCUPANCY - AUTO ON / AUTO OFF	1	ON/OFF KEYED SWITCH. (FULL AUTO IECC EXCEPTION FOR SAFETY/SECURITY)					
RF	NONE	1	EXTERIOR LIGHTING. CONTACTOR CONTROLLED VIA BMCS.					


ELECTRICAL GENERAL NOTES:

- REFER TO ARCHITECTURAL DRAWINGS FOR EXACT LOCATION AND MOUNTING HEIGHTS OF ALL LIGHTING FIXTURES AND ELECTRICAL DEVICES.
- 2. ALL LIGHT FIXTURES IN MECHANICAL AREAS SHALL BE COORDINATED WITH MECHANICAL AND PLUMBING EQUIPMENT TO AVOID CONFLICTS. LOCATE LIGHT FIXTURES ON PERIMETER WALLS OF MECHANICAL AREAS WHERE PRACTICAL.
- 3. ALL EMPTY CONDUIT SHALL HAVE PULL STRING.
- 4. EACH CONDUIT SHALL BE LIMITED TO (3) CIRCUITS MAXIMUM.
- 5. VERIFY MOUNTING HEIGHTS OF RECEPTACLES WITH CASEWORK ELEVATIONS PRIOR TO ROUGH-IN. REFER TO ARCHITECTURAL DRAWINGS FOR ROOM ELEVATIONS FOR LOCATION AND COORDINATION OF ELECTRICAL OUTLETS. AT KNEESPACE LOCATIONS, LOCATE ELECTRICAL OUTLETS WITHIN KNEESPACE, UNLESS NOTED OTHERWISE. AT COUNTERS WITH OUT KNEESPACE, LOCATE OUTLETS HORIZONTALLY 6" ABOVE BACK SPLASH, UNLESS NOTED OTHERWISE.
- 6. ALL FIRE ALARM DEVICES, RECEPTACLES, SWITCHES, AND WIRING DEVICES IN MECHANICAL AND ELECTRICAL ROOMS ARE TO BE RECESSED IN WALLS.
- 7. ALL LIGHTING, RECEPTACLE, AND EQUIPMENT BRANCH CIRCUITS CONDUITS SHALL CONTAIN A GROUND WIRE. USING THE CONDUIT SYSTEM AS THE ONLY GROUND PATH IS NOT ACCEPTABLE.
- 10. CENTER ALL EXIT SIGNS OVER DOORS.

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11. PROVIDE 120V CIRCUIT FROM NEAREST RECEPTACLE OUTLET TO EACH DX FAN COIL UNIT FOR CONNECTION OF CONDENSATE PUMP.

	SYMBOL SCHEDULE
/MBOL	DESCRIPTION (DISREGARD ITEMS NOT SHOWN ON PLANS)
GHTING (I	ETTER DENOTES TYPE - SEE LIGHT FIXTURE SCHEDULE)
	LIGHT FIXTURE - RECESSED OR SURFACE MOUNTED
	LIGHT FIXTURE - RECESSED OR SURFACE MOUNTED ON EMERGENCY CIRCUIT DOWNLIGHT FIXTURE
0	DOWNLIGHT FIXTURE DOWNLIGHT FIXTURE ON EMERGENCY CIRCUIT
ў	LIGHT FIXTURE - WALL MOUNTED
⊬⊘	LIGHT FIXTURE - WALL MOUNTED ON EMERGENCY CIRCUIT
×	EXIT LIGHT - CEILING MOUNTED ON EMERGENCY CIRCUIT
⊬ X(EXIT LIGHT - WALL MOUNTED ON EMERGENCY CIRCUIT
SHTING C	ONTROLS & DEVICES LINE VOLTAGE SINGLE POLE SWITCH
Φ \$ ³	LINE VOLTAGE SINGLE POLE SWITCH
\$ ⁴	LINE VOLTAGE 4-WAY SWITCH
\$ ^K	LINE VOLTAGE MOMENTARY DPST KEYED SWITCH
\$ ^D	LINE VOLTAGE DIMMER SWITCH, SIZE AND TYPE AS REQUIRED
\$P	LINE VOLTAGE SWITCH WITH PILOT LIGHT
\$ ^T	6-HOUR ROTARY TIMER SWITCH WITH NO HOLD U.N.O.
<u>⊕</u> \$ ^{MC}	PUSH BUTTON EPO SWITCH WITH COVER LOW VOLTAGE MOMENTARY CONTACT SWITCH
\$R	LOW VOLTAGE MOMENTARY CONTACT SWITCH LOW VOLTAGE DIGITAL KEYPAD
\$B	LOW VOLTAGE BUILDING MANAGEMENT (BMCS) LOCAL OVERRIDE SWITCH
\$	OCCUPANCY SENSOR (AUTO ON / AUTO OFF WITHIN 20-MINUTES)
\Diamond	VACANCY SENSOR (MANUAL ON / AUTO OFF WITHIN 20-MINUTES)
<u> </u>	PHOTOCELL SENSOR
R#	LIGHTING CONTROL SYSTEM. ('#' DENOTES TYPE - SEE LIGHTING CONTROLS SCHEDULE)
CEPTAC	EMERGENCY LOAD CONTROL RELAY. MINIMUM 16A AND 0-10V COMPATIBLE. PROVIDE U.L. 924 U.N.O. LES AND OUTLETS
021 1710	SIMPLEX RECEPTACLE
0	DUPLEX RECEPTACLE
€	125/250 VOLT, 1 PHASE, 3-WIRE, 20 AMPS UNLESS NOTED OTHERWISE
#	DOUBLE DUPLEX IN 2-GANG BOX WITH SINGLE COVER PLATE
#	DOUBLE DUPLEX GROUND FAULT CIRCUIT INTERRUPTER RECEPTACLE IN 2-GANG BOX WITH SINGLE COVER PLATE
₽	DUPLEX GROUND FAULT CIRCUIT INTERRUPTER RECEPTACLE
ΦΔ	CONCEALED SERVICE MULTI-ACCESS FLOOR BOX WITH DUPLEX RECEPTACLE AND DATA OUTLET. REFER TO TECHNOLOGY SERIES DRAWINGS FOR DATA CABLE QUANTIES.
	CONCEALED SERVICE MULTI-ACCESS FLOOR BOX WITH DOUBLE DUPLEX RECEPTACLE AND DATA OUTLET.
⊕△	REFER TO TECHNOLOGY SERIES DRAWINGS FOR DATA CABLE QUANTIES.
0	JUNCTION BOX
G OTOR CO	FLUSH REMOTE GFCI DEVICE (LOCATE IN READILY ACCESSIBLE LOCATION) NTROLLERS AND EQUIPMENT
1	1-PHASE MOTOR, MAKE FINAL MOTOR CONNECTION
Ø	3-PHASE MOTOR, MAKE FINAL MOTOR CONNECTION
\$ ^M	MOTOR-RATED SWITCH. 20A/1P UNLESS INDICATED OTHERWISE.
	DISCONNECT SWITCH AS REQUIRED
	COMBINATION MOTOR STARTER/DISCONNECT SWITCH AS REQUIRED
$\frac{\boxtimes}{lack}$	MOTOR STARTER PREWIRED DEVICE, MAKE ELECTRICAL FINAL CONNECTIONS
VFD	VARIABLE FREQUENCY DRIVE MOTOR CONTROLLER FURNISHED BY MECHANICAL CONTRACTOR
	AND INSTALLED BY ELECTRICAL CONTRACTOR.
	LOW VOLTAGE TRANSFORMER, SIZE AND TYPE AS REQUIRED. CHIME/BUZZER
SPD'X'	SURGE PROTECTION DEVICE. 'X' = EXPOSURE TYPE: VH - VERY HIGH, H - HIGH, M - MEDIUM, L - LOW
.ECTRICA	L EQUIPMENT
	277/480 VOLT DISTRIBUTION OR PANELBOARD
	120/208 VOLT PANELBOARD
	DRY TYPE TRANSFORMER PLYMOOD TELEPHONE PACKBOARD
RCUITING	PLYWOOD TELEPHONE BACKBOARD
	CONDUIT
	CONDUIT BELOW FLOOR, SLAB, OR GRADE
	3/4"C. UNLESS OTHERWISE NOTED; LONG HATCH, NEUTRAL; SHORT
 Z -	HATCH, PHASE; LONG HATCH & HOOK, INSULATED GROUND. NO HATCHES INDICATES 2 CONDUCTORS.
	ARROW INDICATES HOMERUN.
IBSCRIPT	PARTIAL ELECTRICAL HOME RUN S AND ABBREVIATIONS
WP	INDICATES 'WEATHERPROOF'
Н	INDICATES 'HORIZONTAL'
NL	INDICATES 'NIGHT LIGHT'.
TP	INDICATES 'TAMPER PROOF'
(KS)	INDICATES 'KNEE SPACE'. LOCATE WIRING DEVICE CENTERED WITHIN KNEESPACE
J.N.O.	INDICATES 'UNLESS NOTED OTHERWISE'
(E) (R)	INDICATES EXISTING TO REMAIN INDICATES REPLACE DEVICE AND COVERPLATE
` '	INDICATES REPLACE DEVICE AND COVERPLATE. NEXT TO ANY SYMBOL INDICATES FINAL ROUGH-IN FIELD COORDINATION BY
•	CONTRACTOR WITH ARCHITECTURAL MILLWORK DRAWINGS AND OTHER TRADES

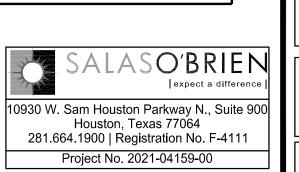

uite 720 a. 77701 -7196 -1745 A.I.A. S. A.I.A. S. A.I.A. Over a Prochitectural Alliance Incorporate

BRADLEY KALMANS

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FIELD HOUSE

WEST BROOK AU

ISSUED FOR 100% REVIEW

DATE: 01/12/2022

DESIGN DEVELOPMENT F----

BIDS & CONSTRUCTION X

DATE: 04/18/2022
REVISION:
DATE:


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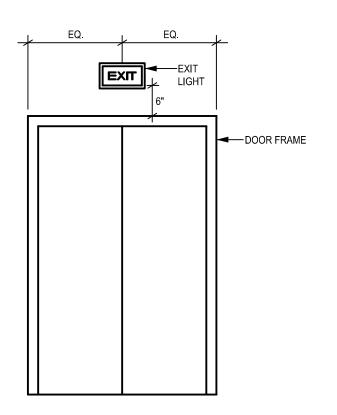
ELECTRICAL
DETAILS AND
SCHEDULES

SHEET NUMBER


E501




3 CONDUIT BELOW BUILDING SLAB
SCALE: NONE

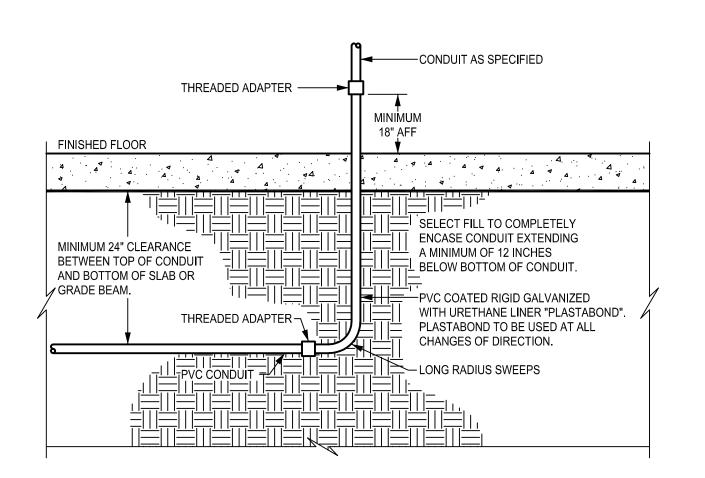


5 TYPICAL EXIT SIGN

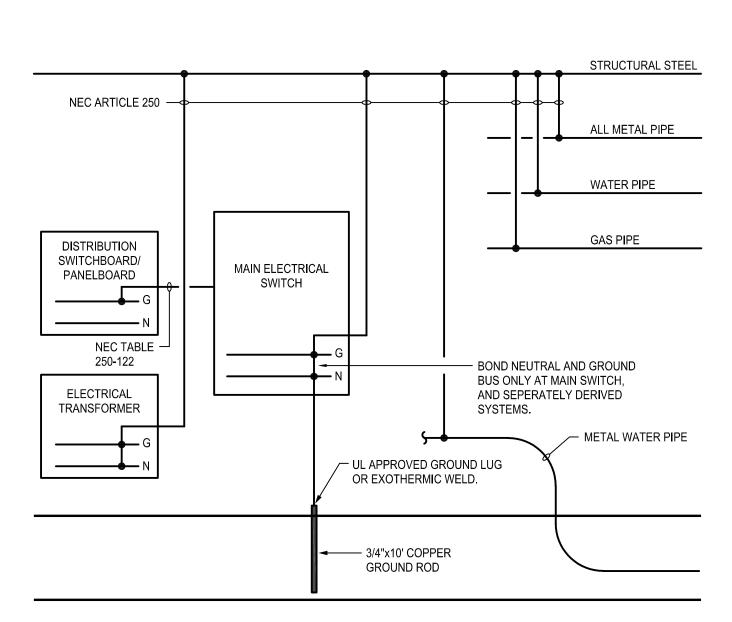


4 GROUNDING DETAIL
SCALE: NONE

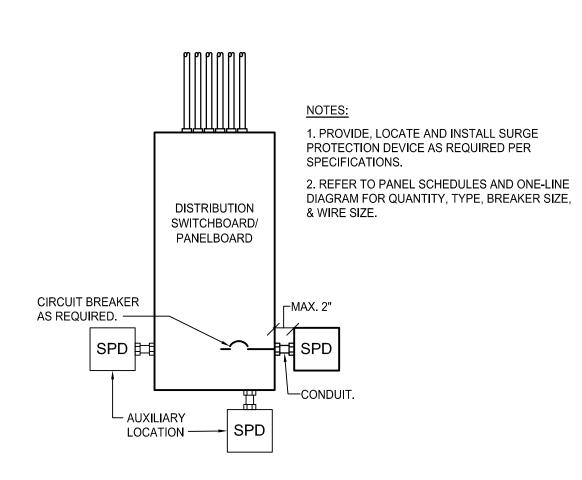


3 SURGE PROTECTION DETAIL
SCALE: NONE

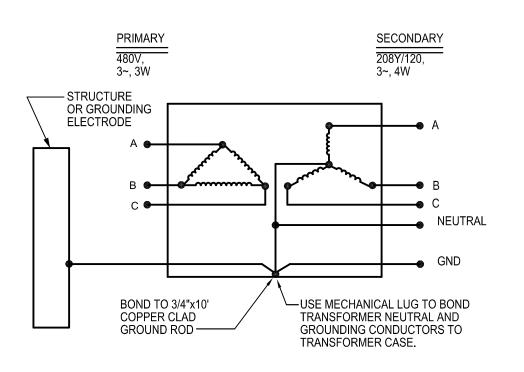

2 TRANSFORMER GROUNDING DETAIL
SCALE: NONE

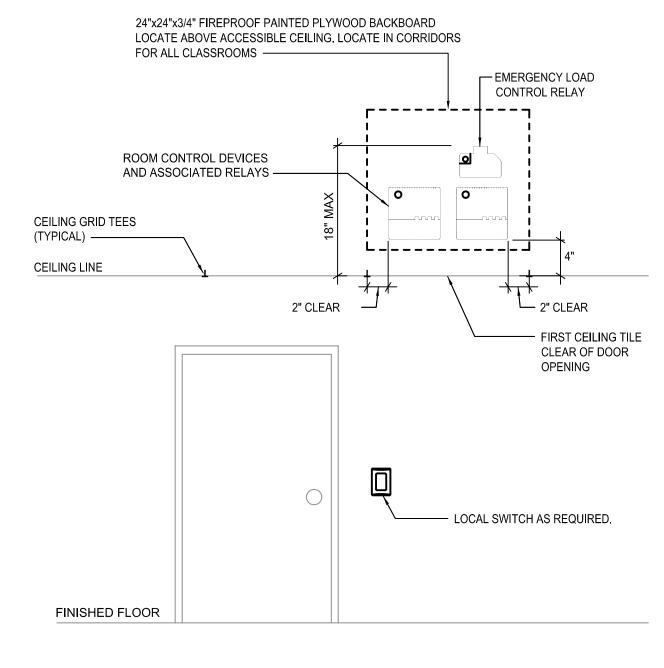

1 TYPICAL LIGHTING CONTROLS ELEVATION
SCALE: NONE

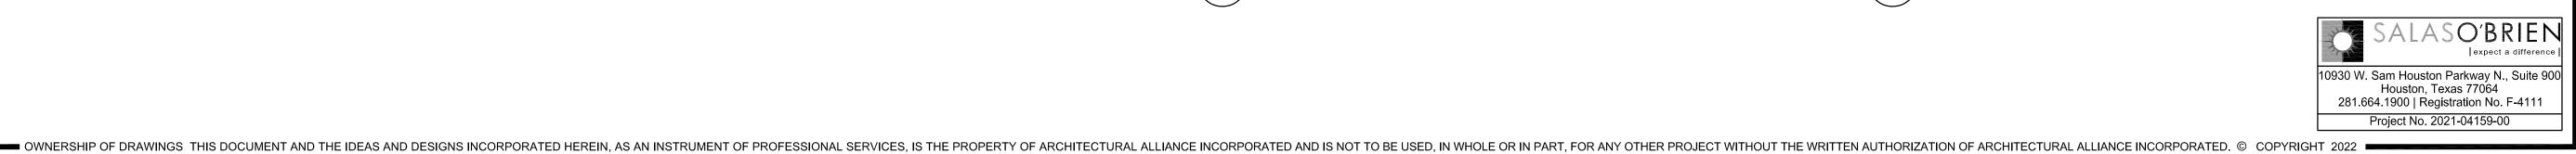

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Beaumont Independent School District

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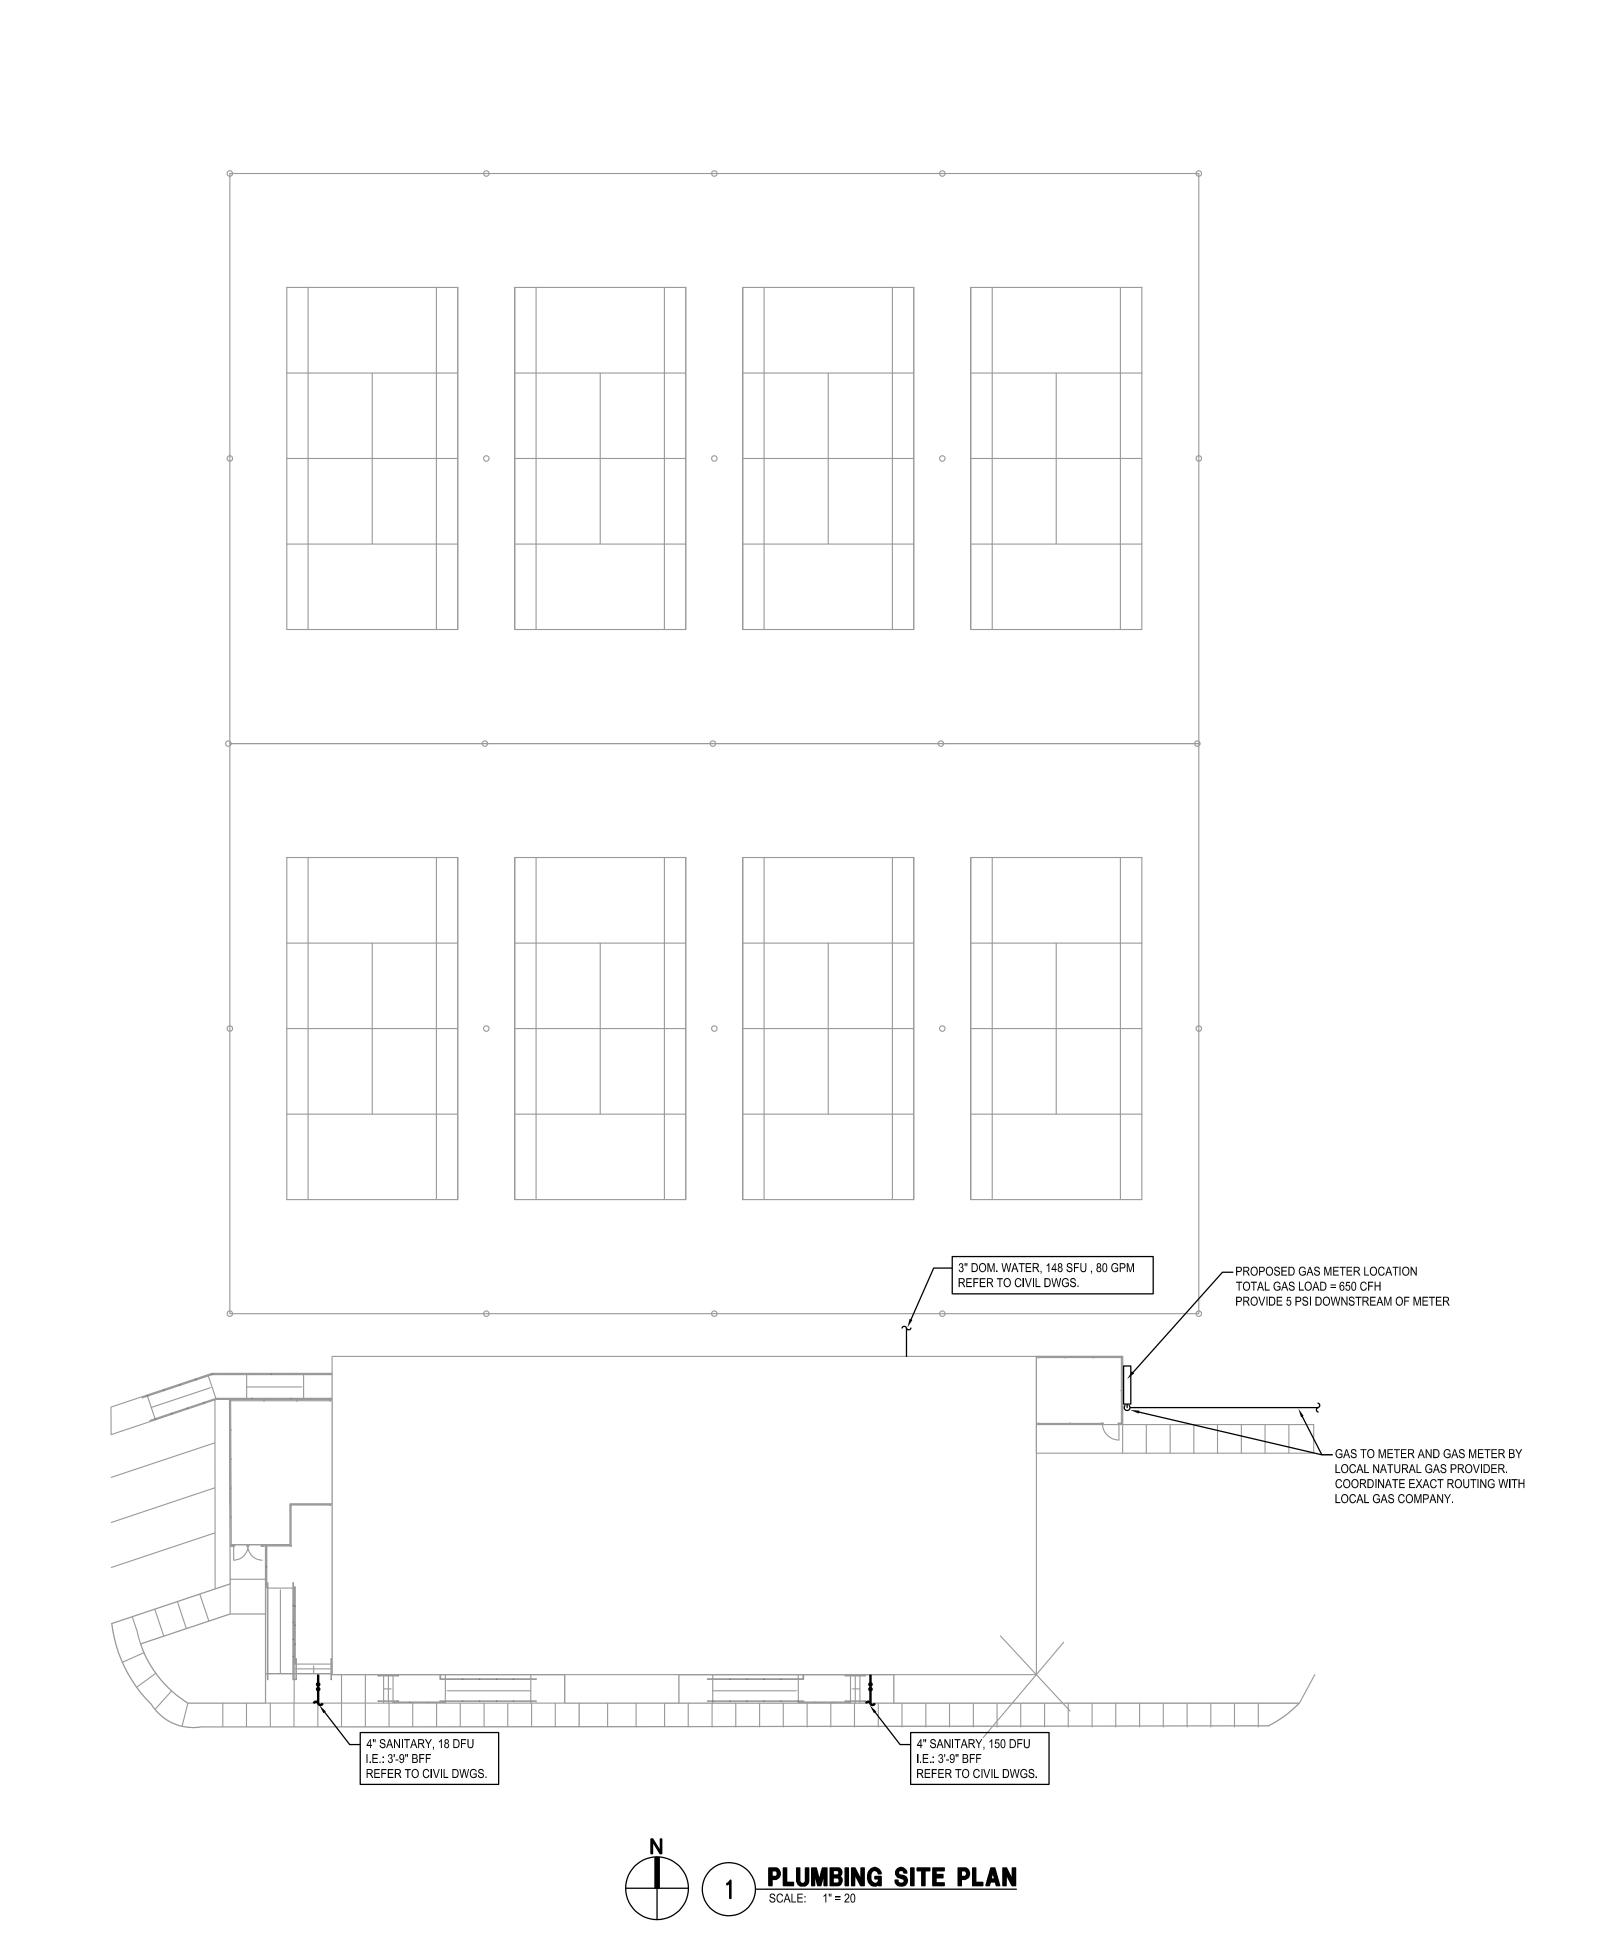
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DRAWINGS SHEET TITLE
ELECTRICAL
DETAILS


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PLUMBING SITE


SALASO'BRIEN

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Houston, Texas 77064
281.664.1900 | Registration No. F-4111

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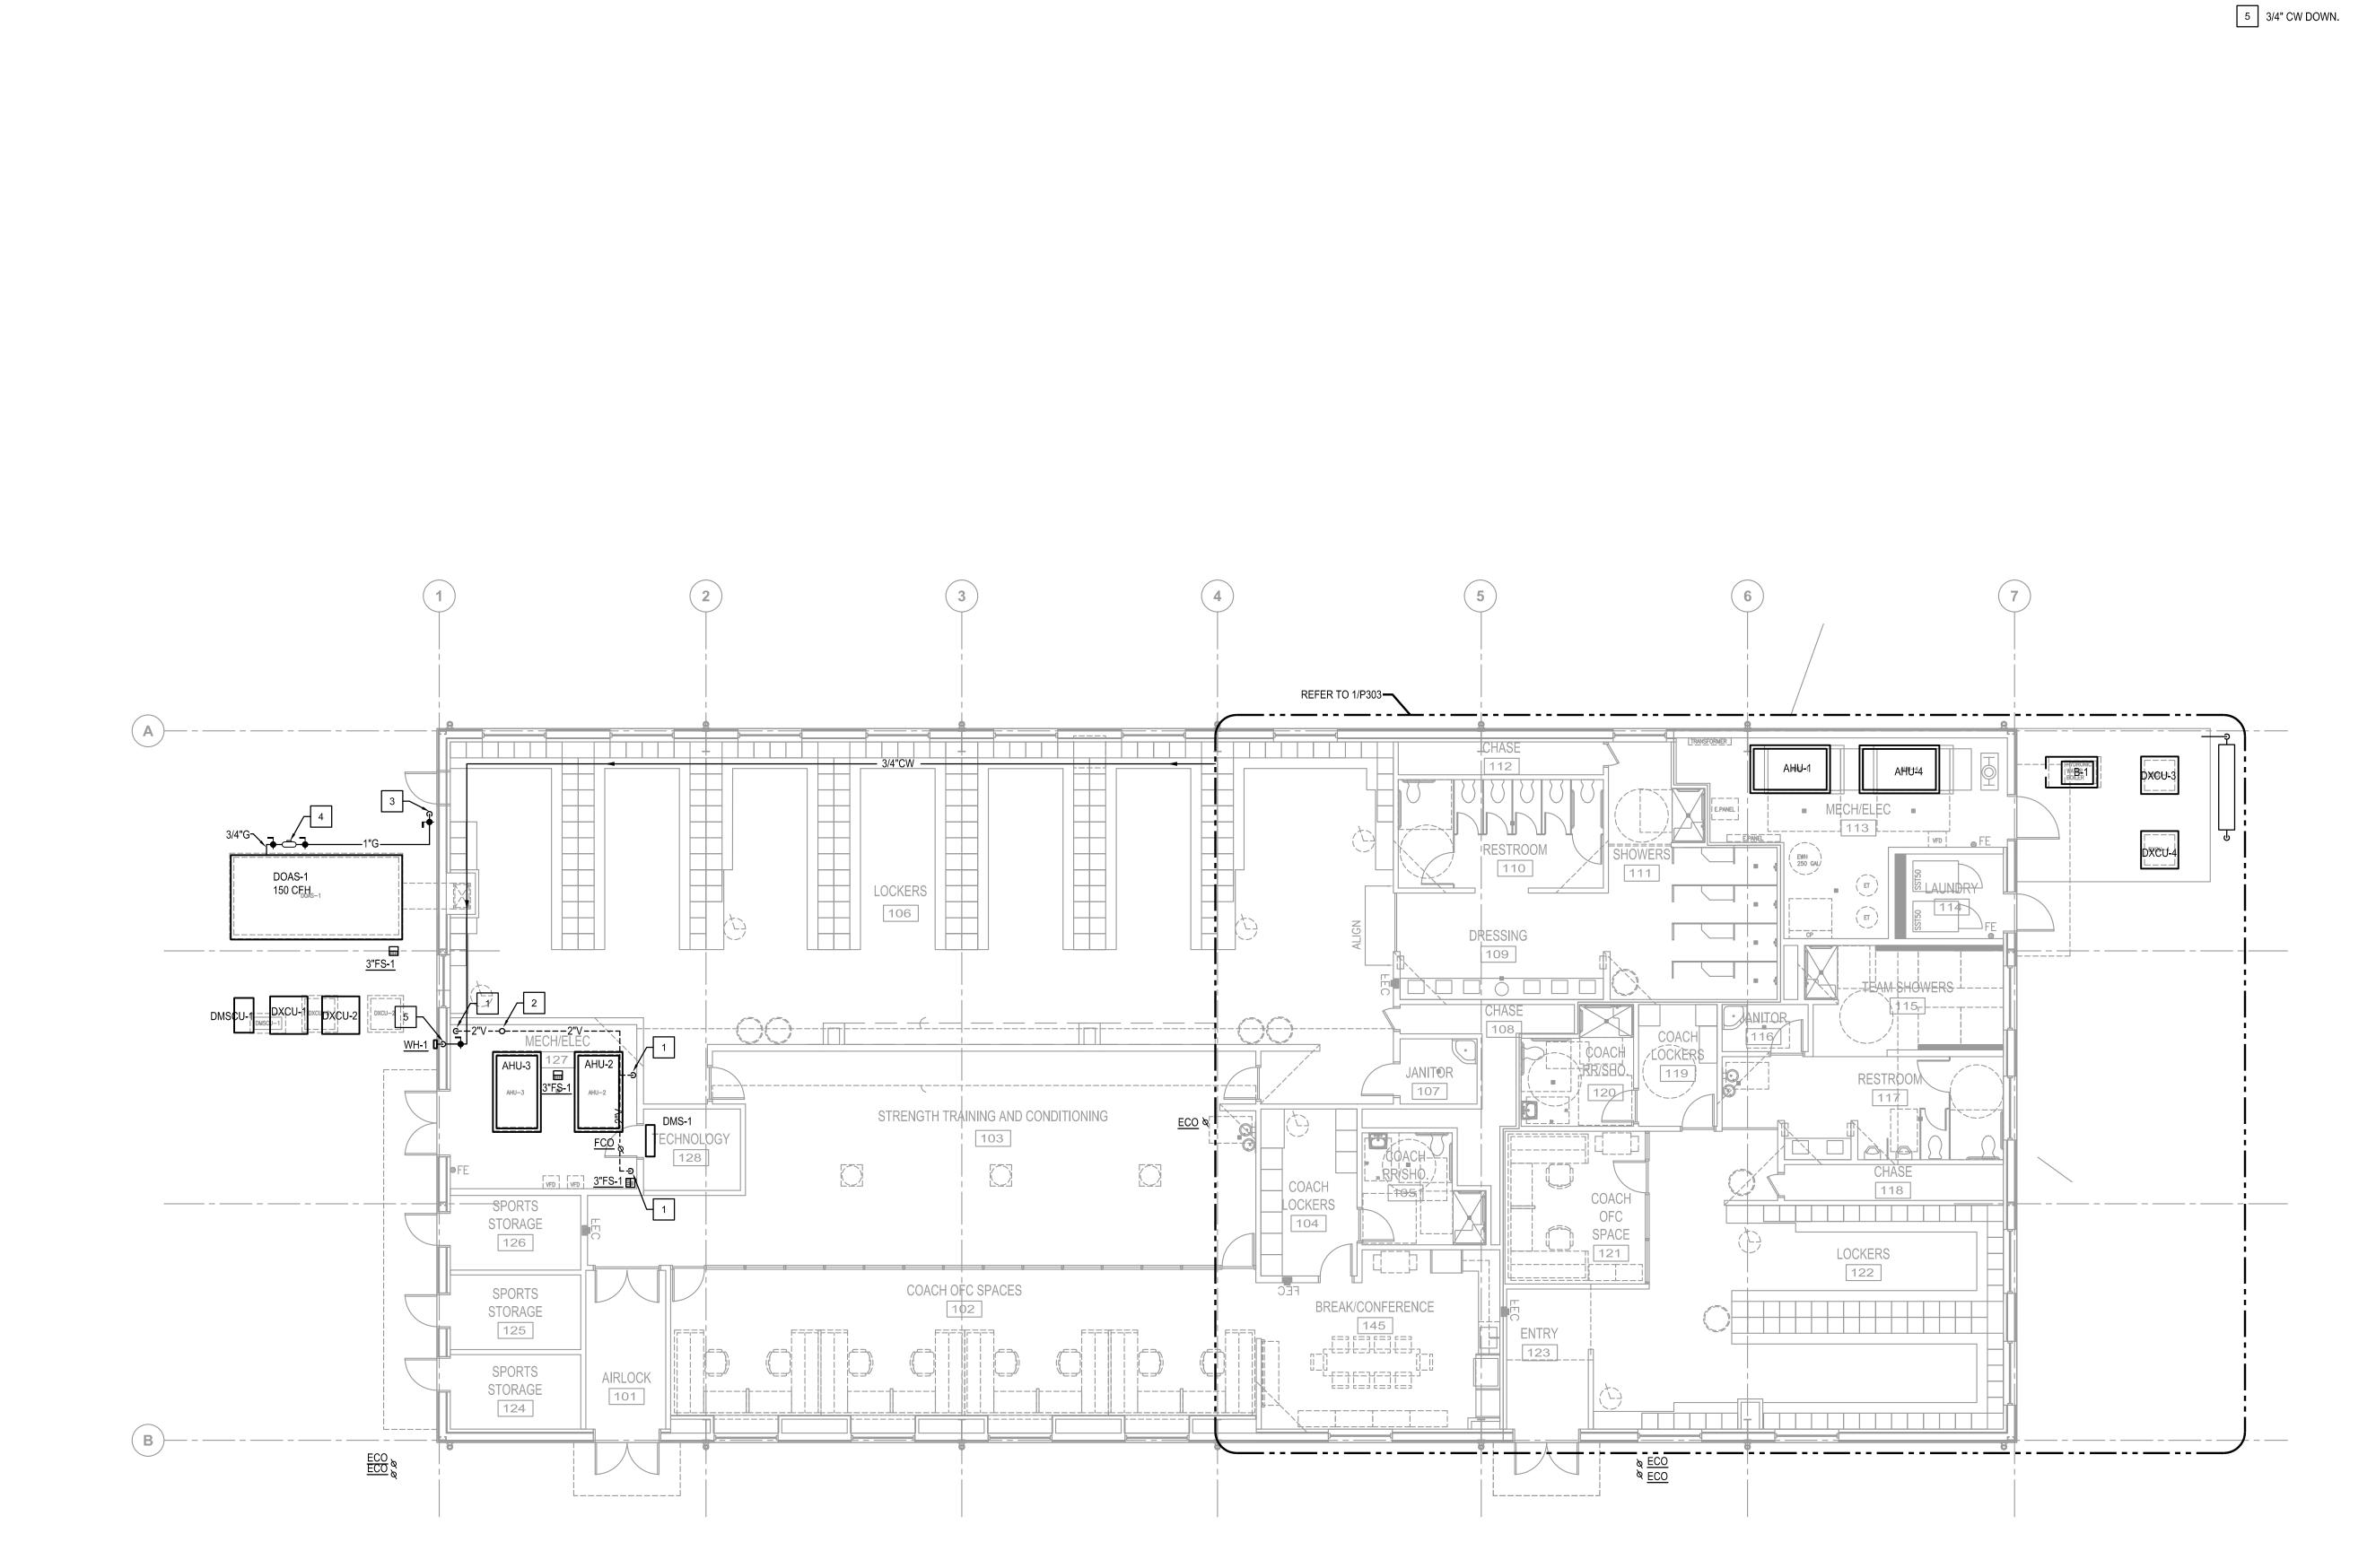
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DRAWINGS SHEET TITLI

PLUMBING UNDERFLOOR PLAN

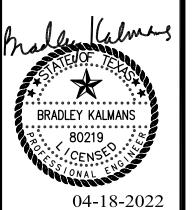P201

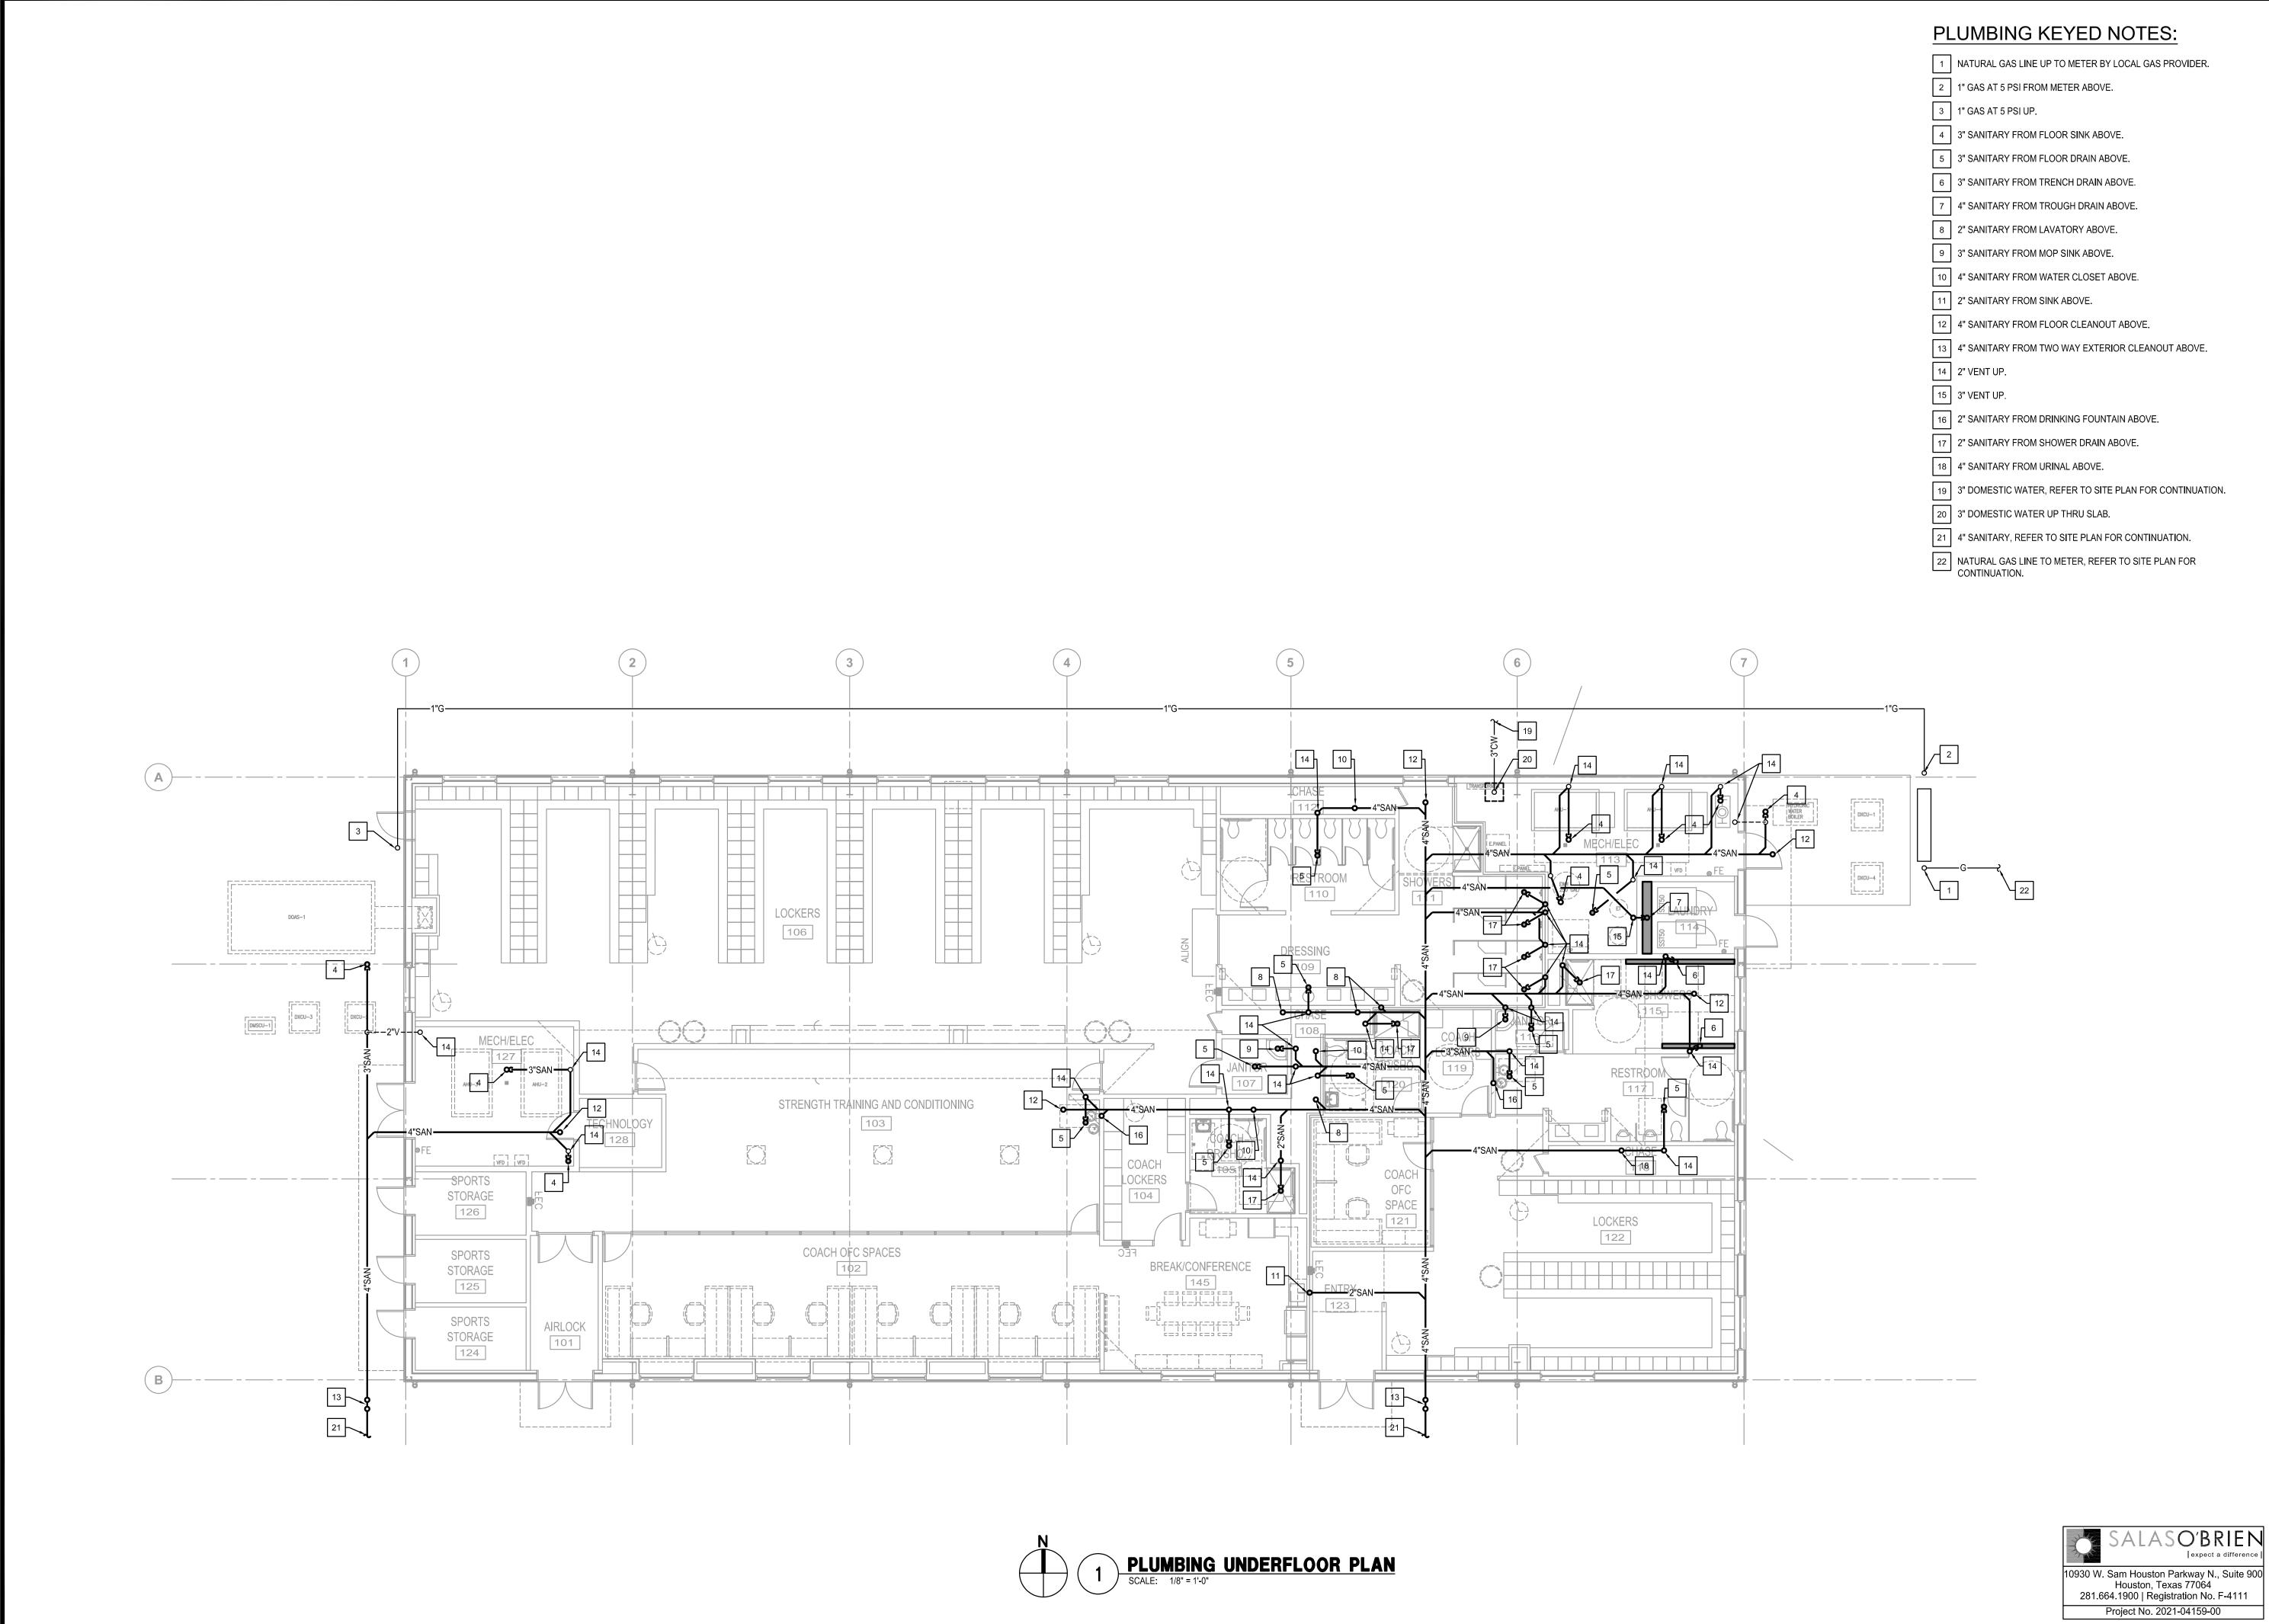

PLUMBING FLOOR PLAN
SCALE: 1/8" = 1'-0"

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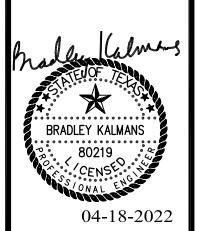


1 2" VENT FROM BELOW.

2 2" VENT UP TO 4" VTR.

3 1" GAS AT 5 PSI FROM BELOW GRADE.

4 NATURAL GAS PRESSURE REGULATOR, 5 PSI TO 8 POUNCE PRESSURE, 150 CFH.



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DRAWINGS SHEET TITLE PLUMBING


FLOOR PLAN

SHEET NUMBER

ALASO'BRIEN


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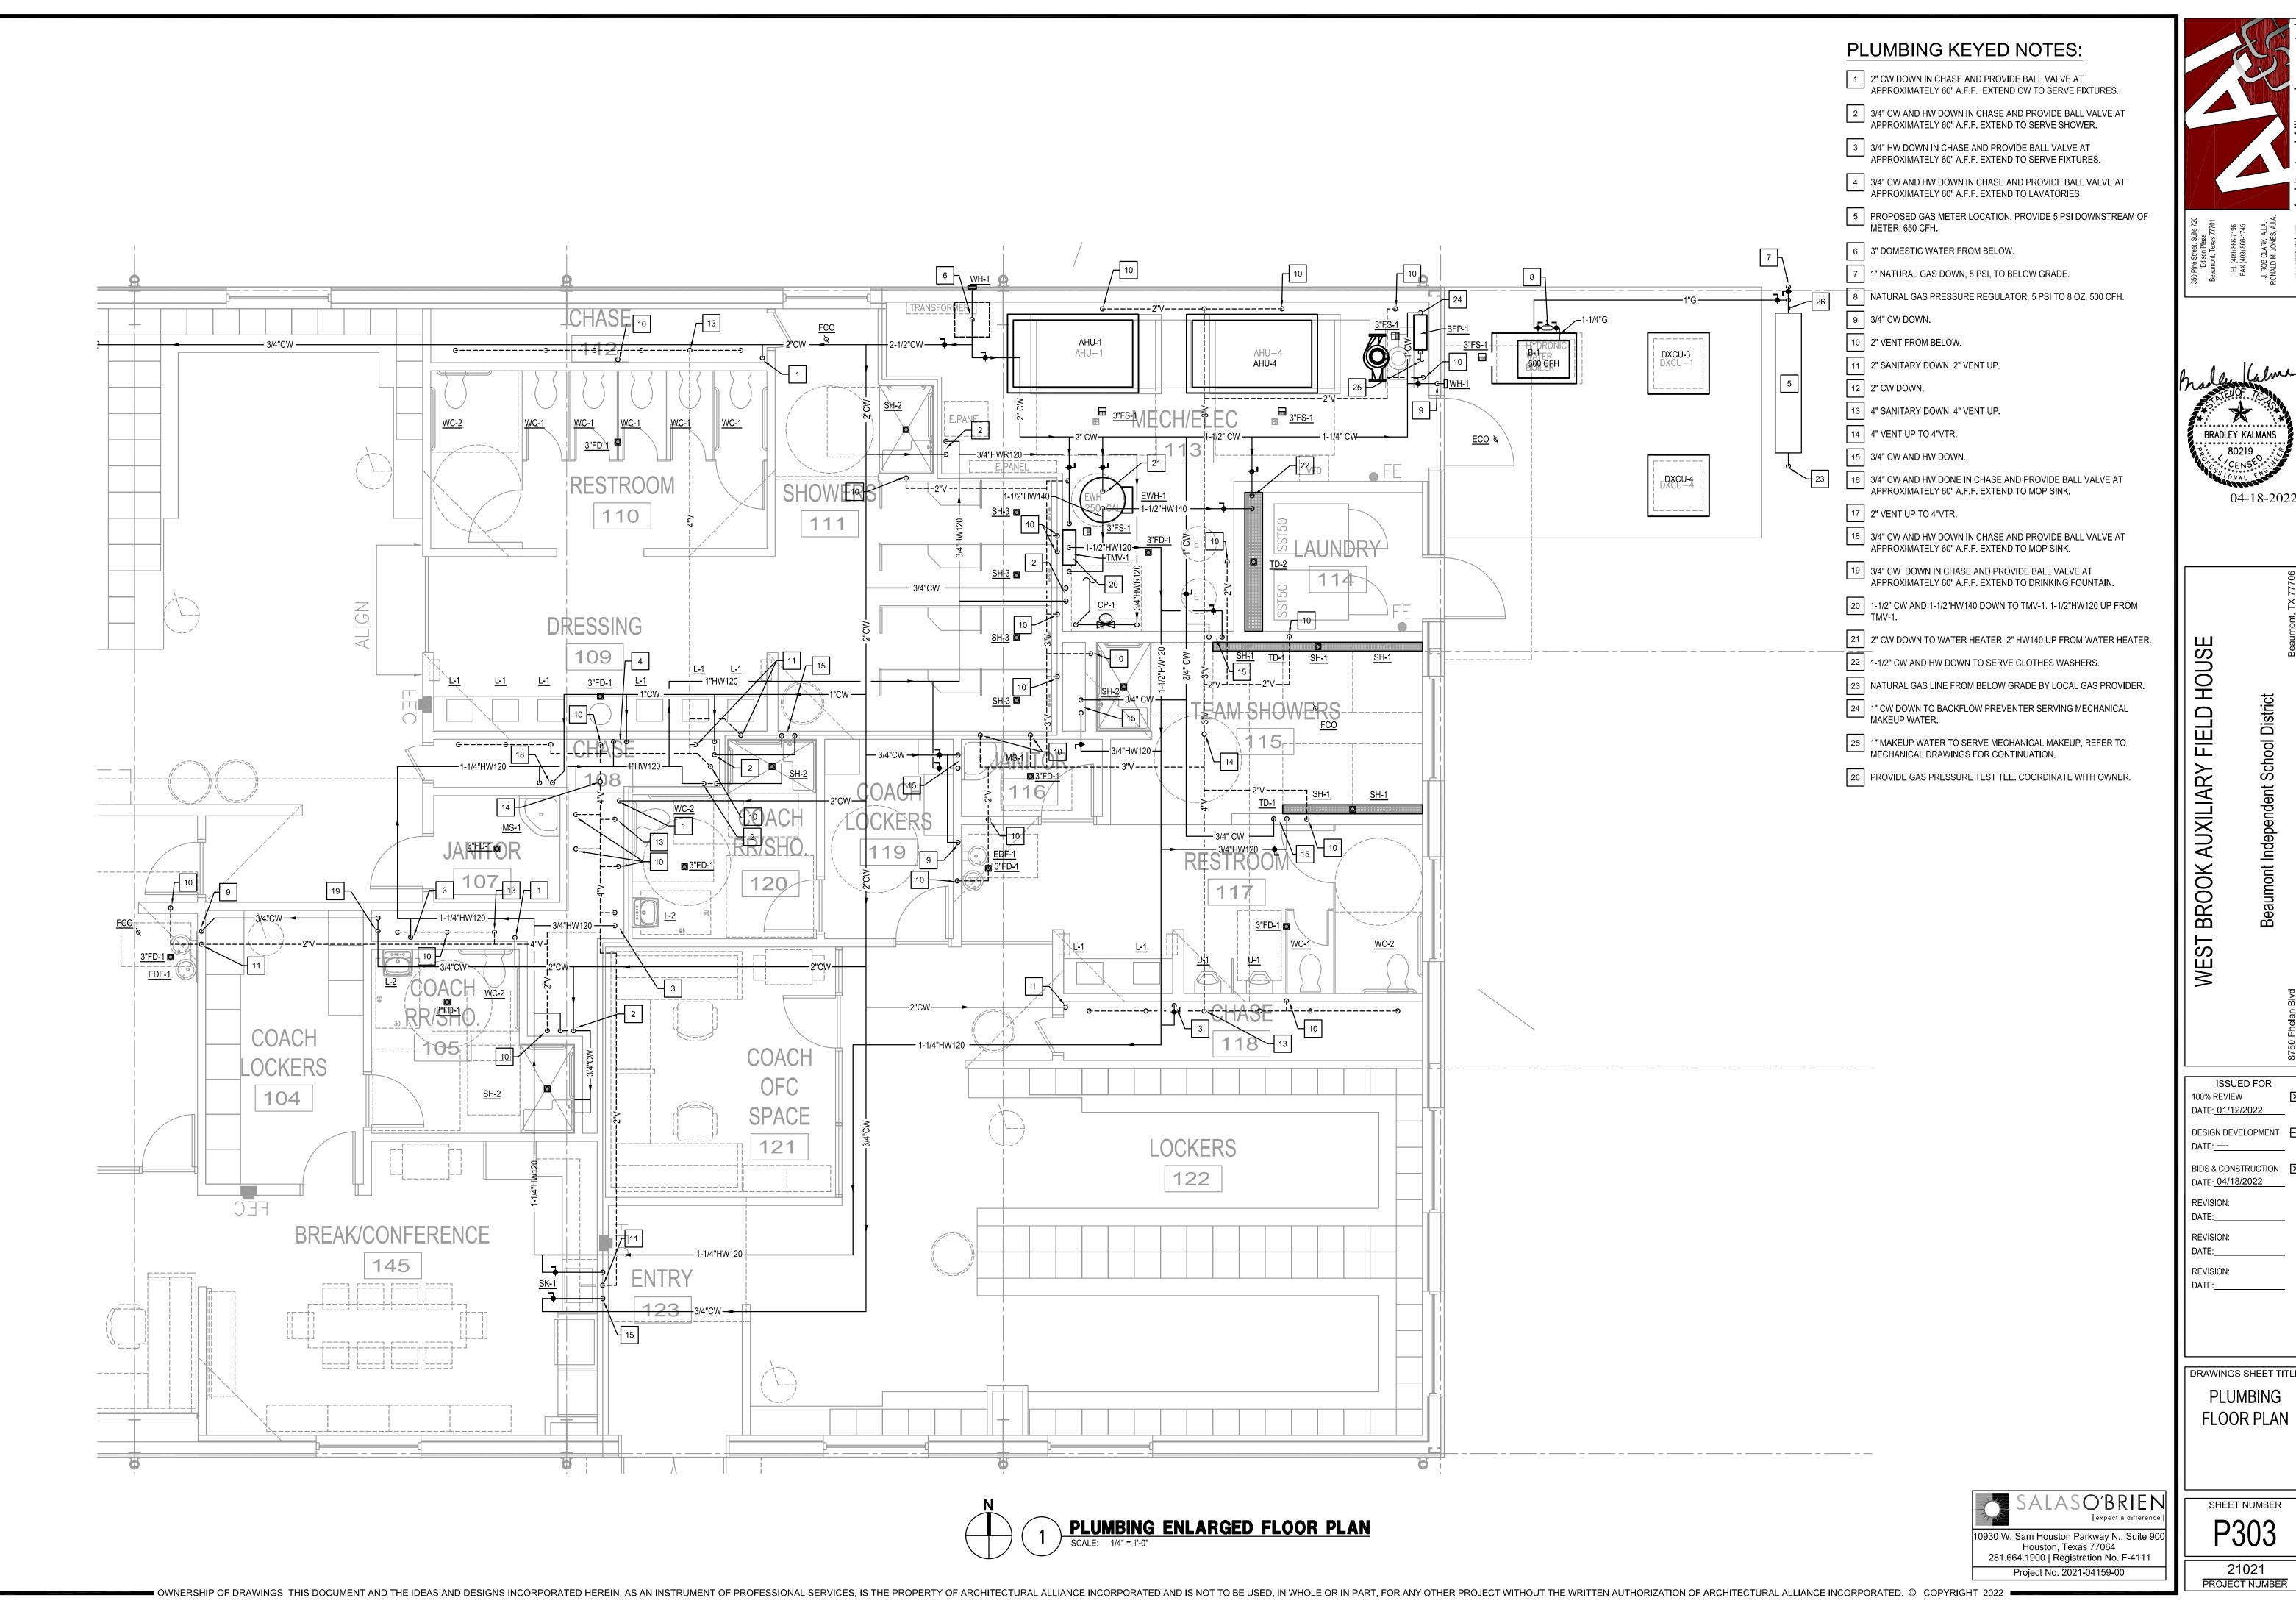
DRAWINGS SHEET TITLE

PLUMBING ROOF

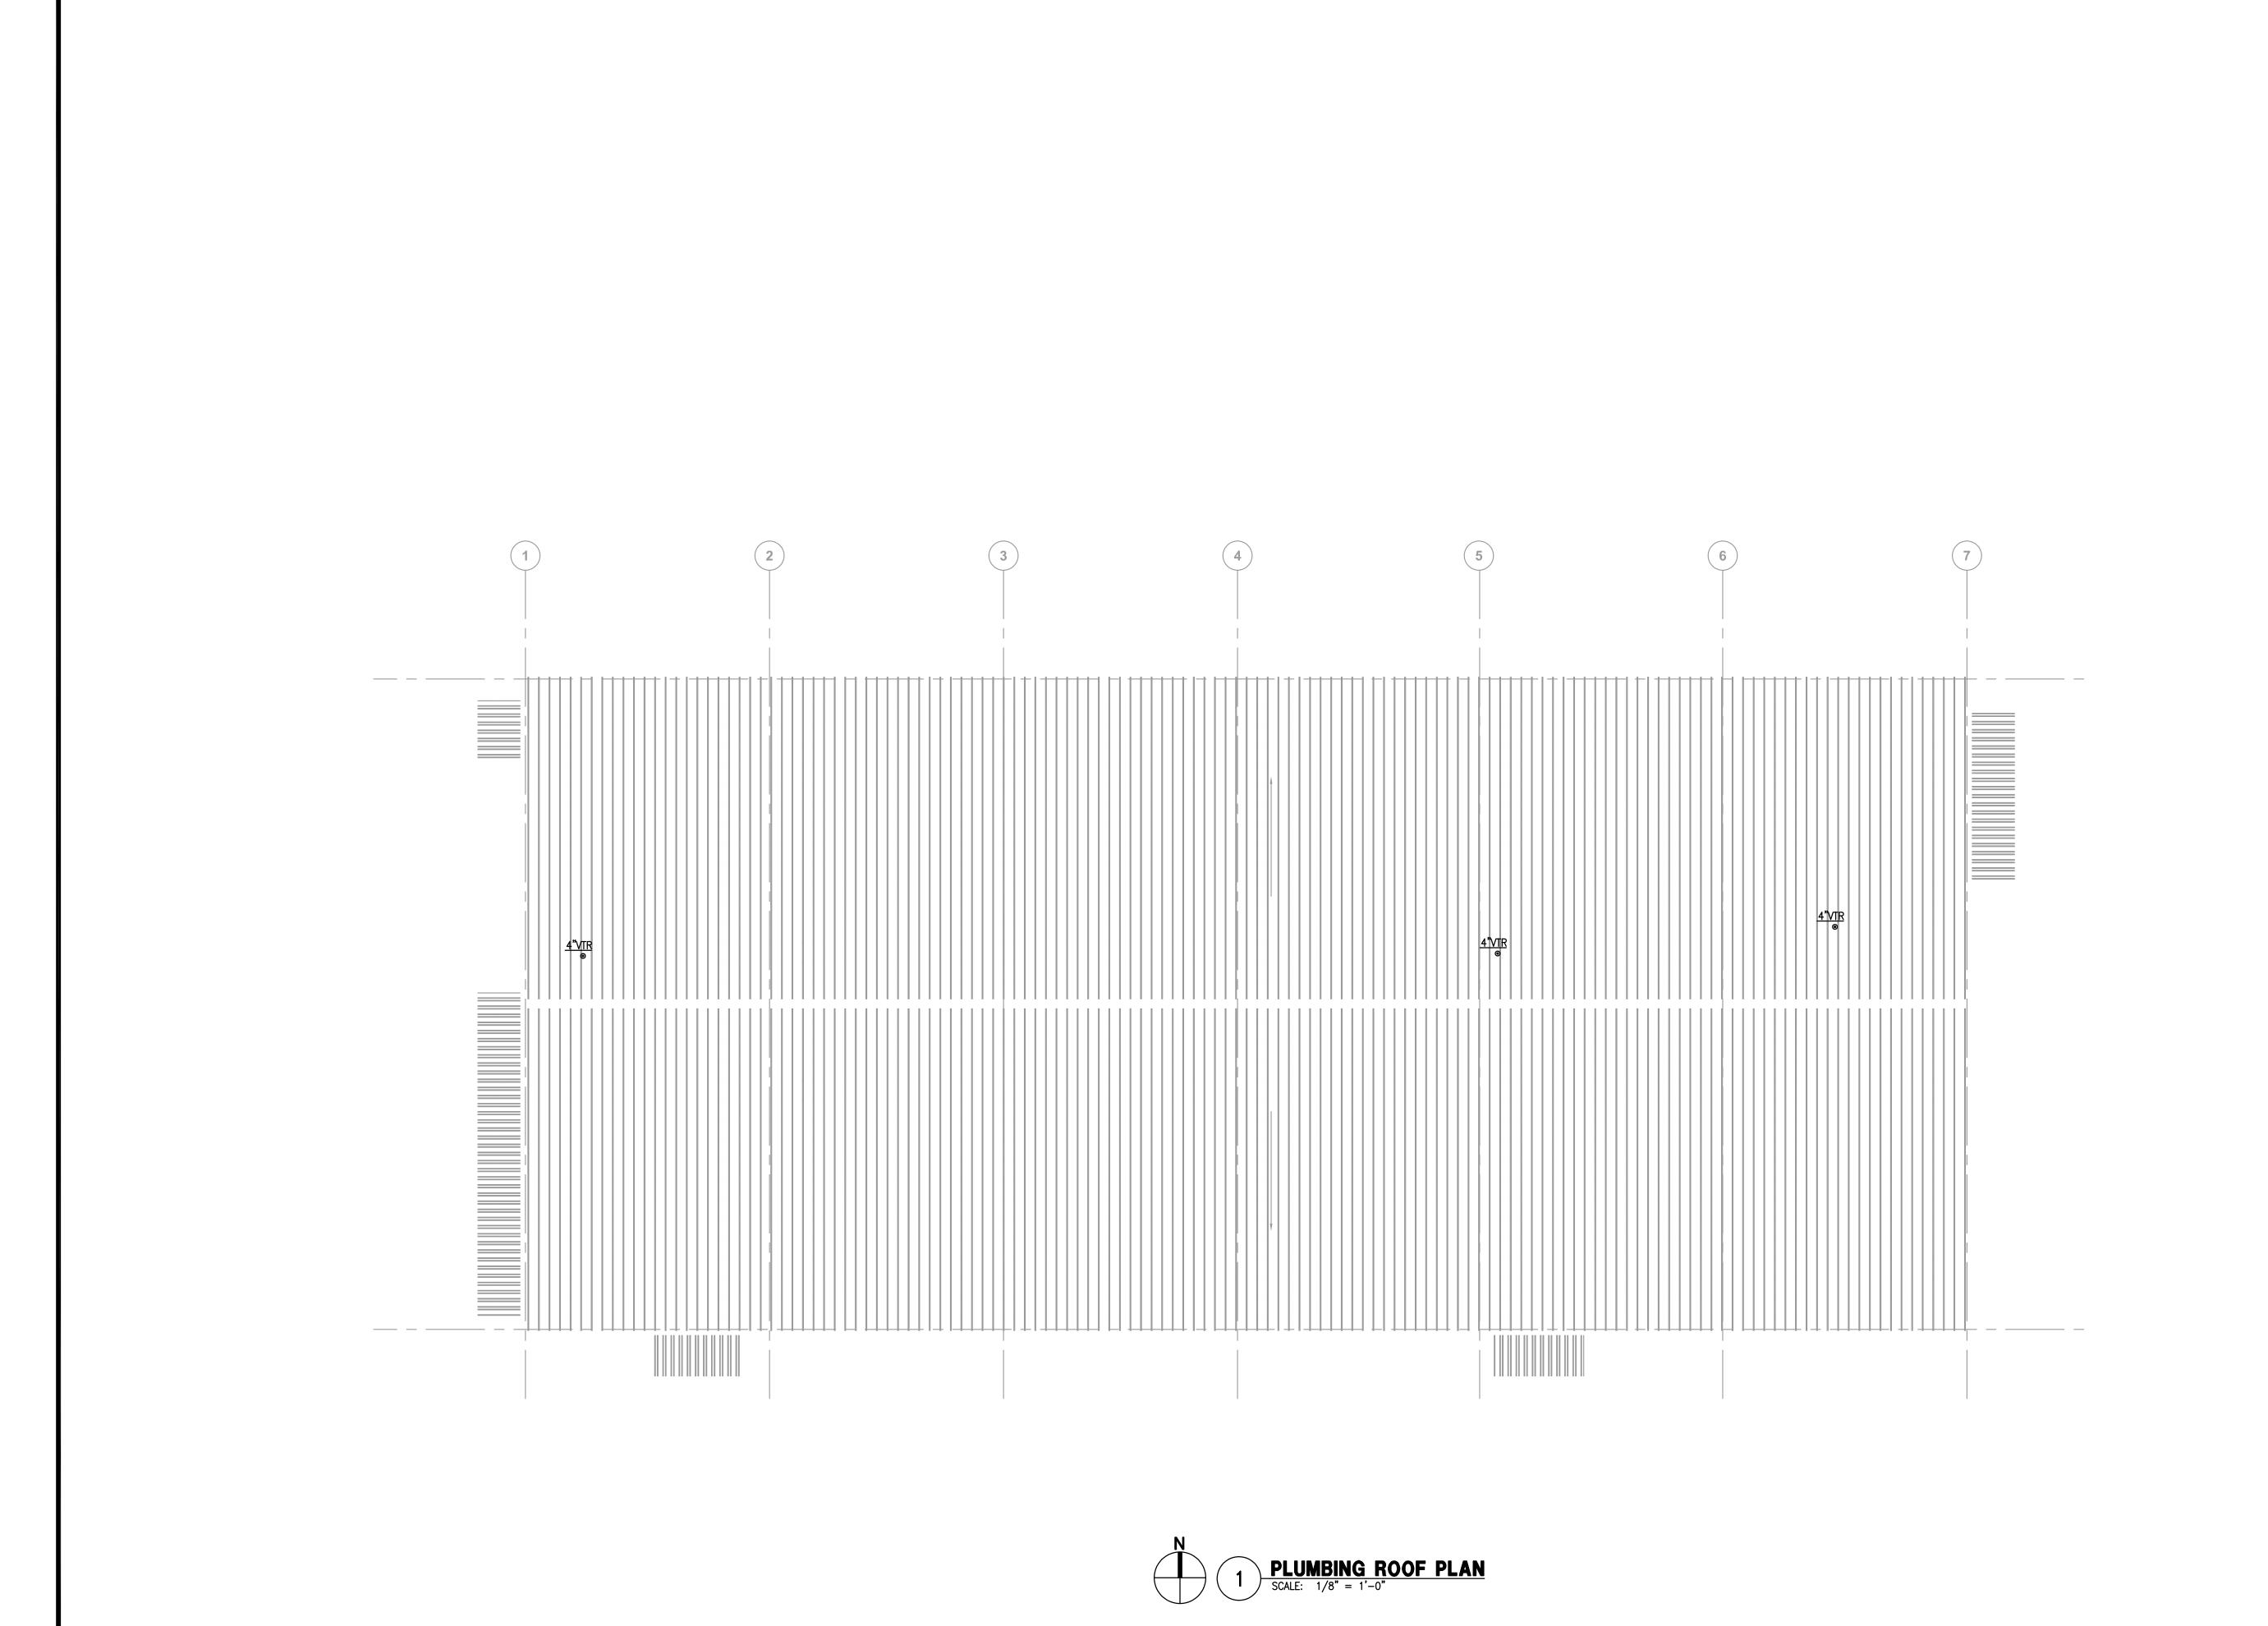ALASO'BRIEN


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PLUMBING FLOOR PLAN

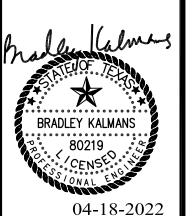

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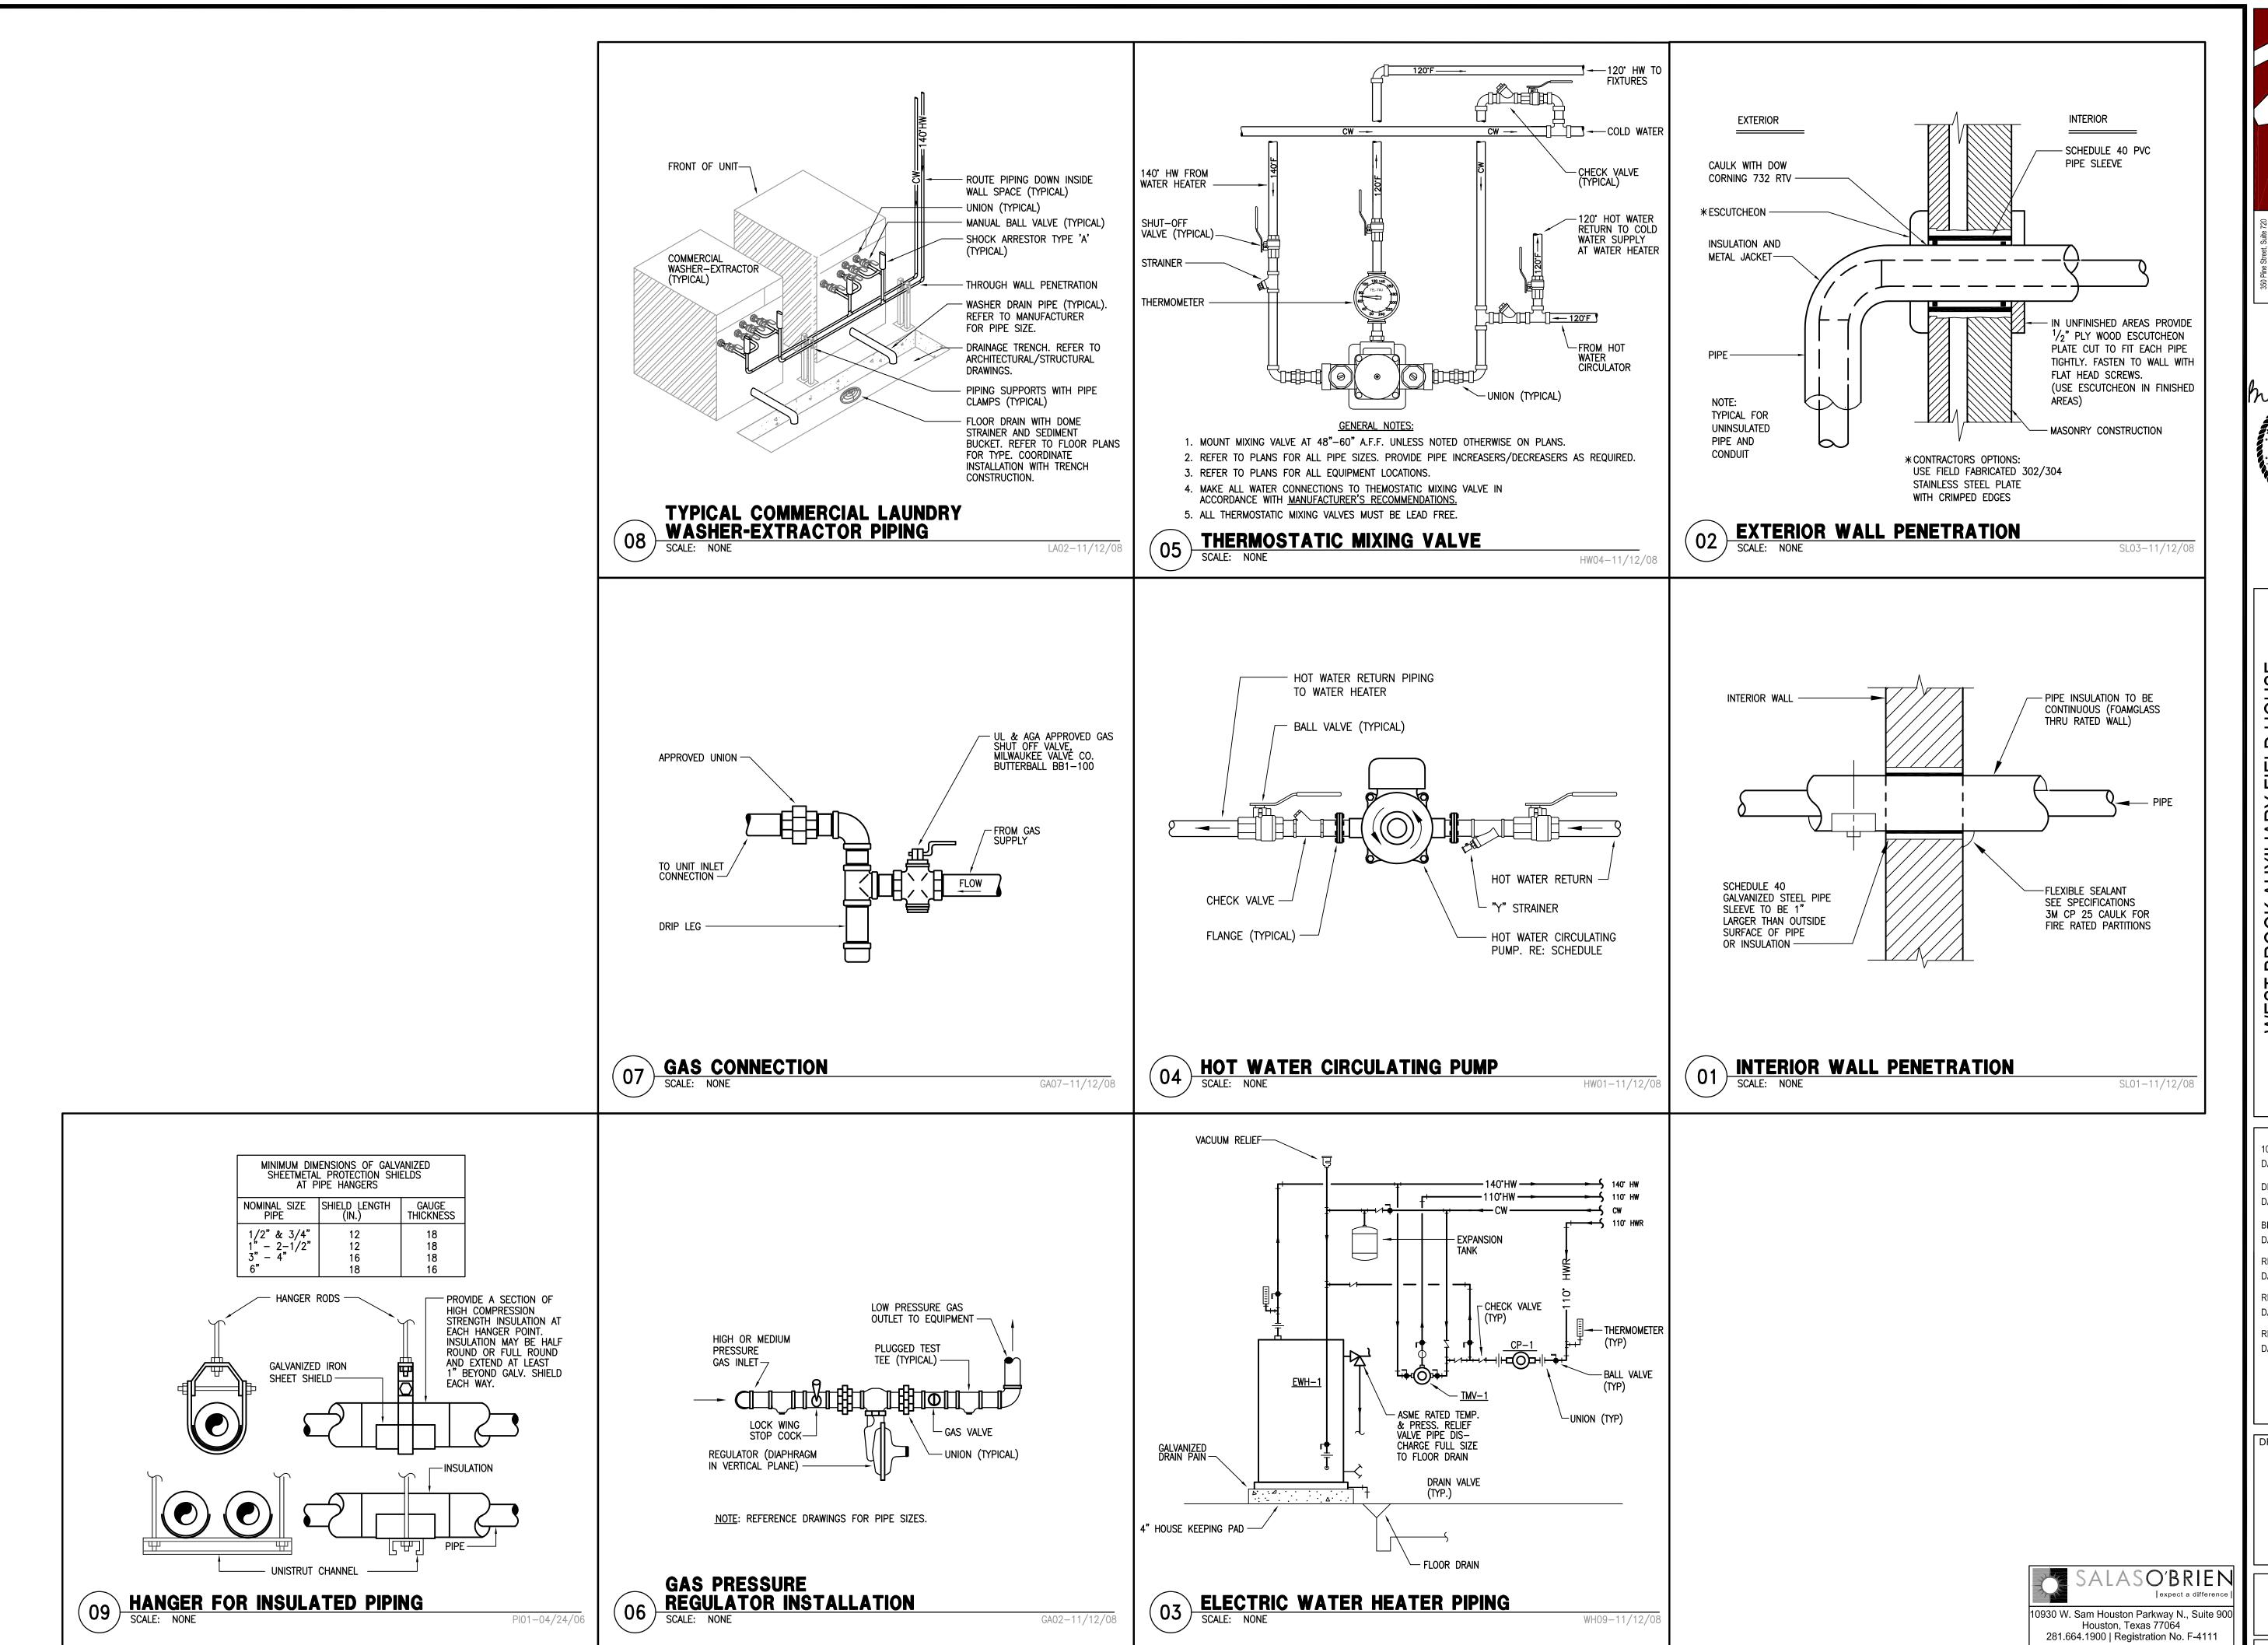
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HOUSE FIELD JXILIARY BROOK AU WEST

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	ELE	C. WAT	ER H	EATE	R S	CHEDULE
ITEM	KW INPUT	GALS. PER HR. RECOVERY RATE 100°F RISE	STORAGE CAPACITY	ELECTRICAL REQUIRED		MANUFACTURER COMMENT
EWH-1	81	335	120 GAL	480V/3ø 60HZ	140°F	RHEEM #ES-120A-81-GS


DO	MESTIC	HW E	KPANS	ION T	ANK	SCHED.
ITEM NO.	DESCRIPTION	MAX. WORK PRESSURE	TANK VOL. GALLONS	MAX. ACCEPT. GALLONS	DIAMETER INCHES	MANUFACTURER AND MODEL
ET-1	HOT WATER EXPANSION TANK	150 PSI	6.4	3.2	12	AMTROL THERM-X-TROL #ST-12C-DD
NOTES	S: 1. ALL EXPANSION 2. ET-1 SHALL B					

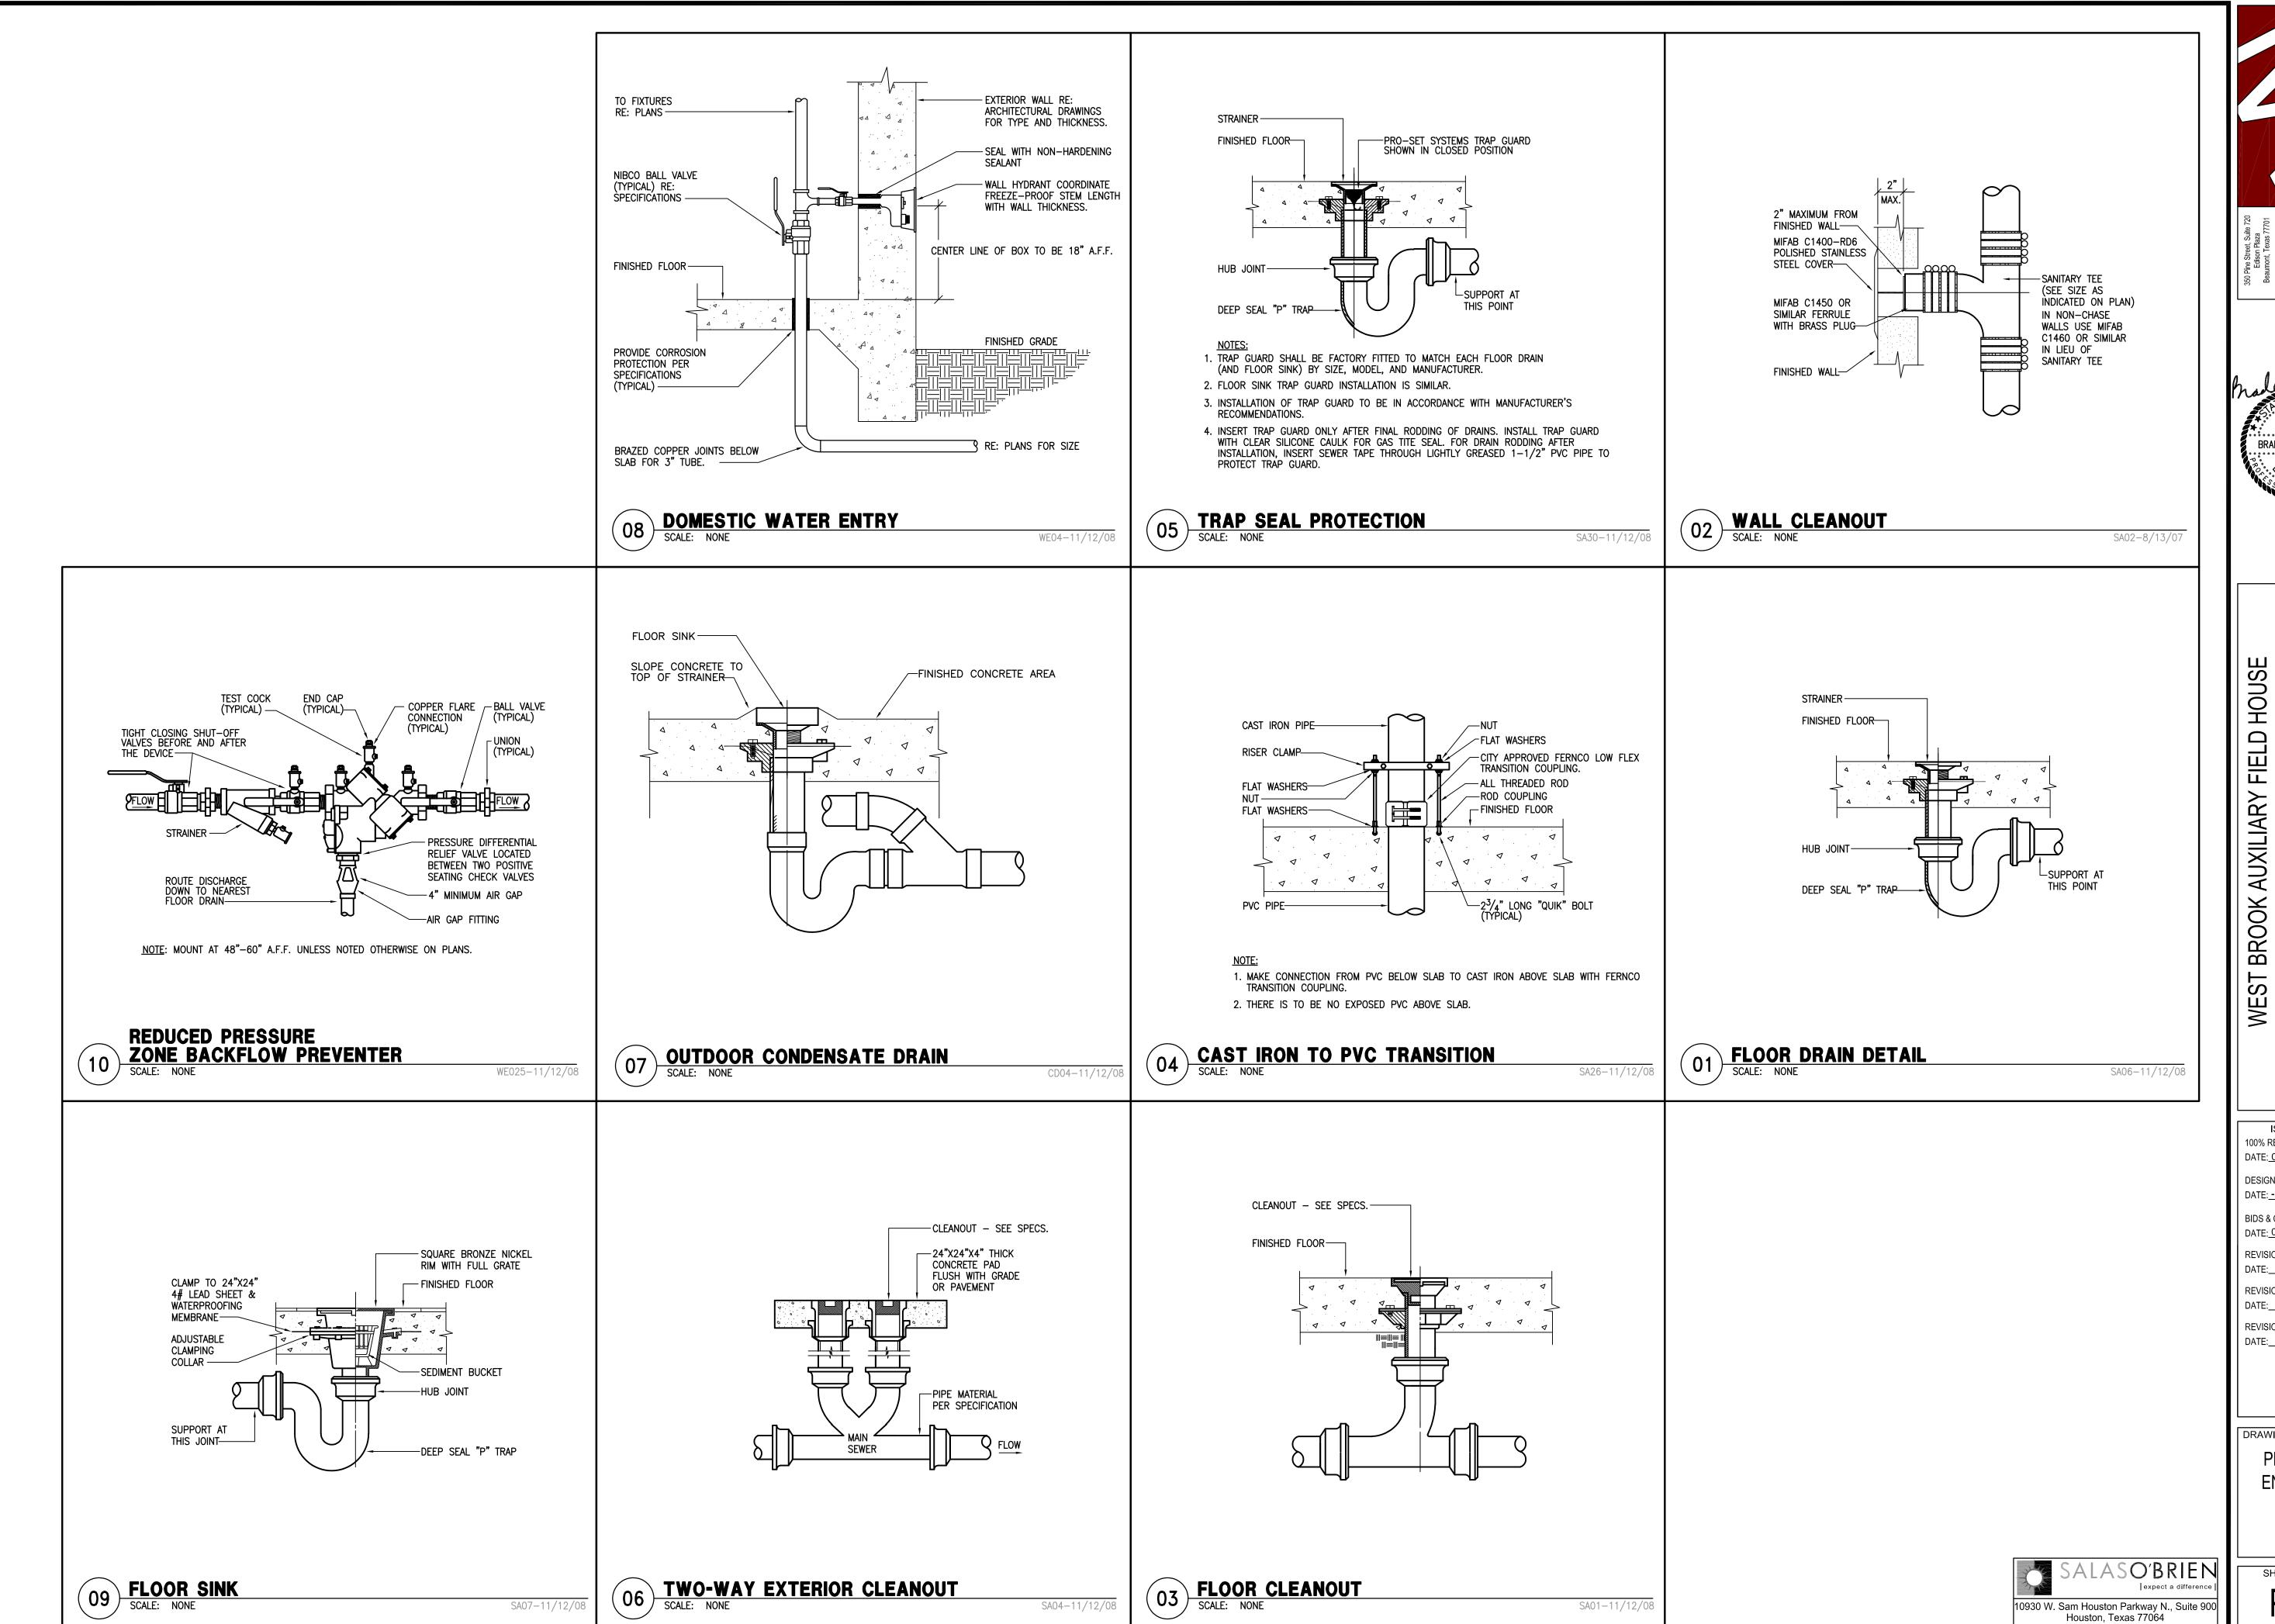	CIRCULATING PUMP SCHEDULE										
ITEM NO.	DESCRIPTION	TYPE	GPM	HEAD FEET	H.P MIN.	VOLT/ PHASE	MAX RPM	MANUFACTURER AND MODEL			
CP-1	CIRCULATION PUMP	IN-LINE STAINLESS	3	3	1/12	120/1	3600	GRUNDFOS ALPHA 2 15-55			
NOTES	NOTES: 1. CIRCULATING PUMPS TO BE STARTED IN AUTOADAPT MODE.										


THE	RM(OST	AT	IC I	MIX	ING	VAI	_VE	SCHEDULE
ITEM NO.	TEMP. IN DEG. F	TEMP. OUT DEG. F	MIN. FLOW GPM		ASSE	THERM- OMETER			MANUFACTURER/ MODEL
TMV-1	140	120	0.5	20	1017	YES	YES	5	POWERS INTELLISTATION JR #LFIS100VL

NOTES:	TMV-1	IS	Α	DIGITAL	FIELD	ADJUSTABLE	MIXING	VALVE	WITH	TOUCH	SCREEN	DISPLAY	

	PLUMBING FIXT	TURE SCH	IEDULE	
TYPE: DESCRIPTION: SEAT:	WC-1 (NON - T.A.S. COMPLIANT) WATER CLOSET, WALL MOUNTED, WHITE VITREOUS CHINA WITH ANTIMICROBIAL SURFACE, 1.28 GALLON PER FLUSH SIPHON JET ACTION, ELONGATED CLOSET BOWL WITH 1- 1/2" BACK SPUD AND BOLT COVERS. AMERICAN STANDARD "AFWALL MILLENIUM" #3353.101. ELONGATED OPEN FRONT WHITE PLASTIC SEAT WITH SELF SUSTAINING	TYPE: DESCRIPTION: CONTROLS:	SH-1 - INDIVIDUAL SHOWER STATION - NON TAS COMPLIANT SHOWER, JOB SITE BUILT AND INSTALLED PER THE ARCHITECTURAL DRAWINGS. CONFIRM CONFIGURATION AND ORIENTATION WITH ARCHITECTURAL DRAWINGS. PRESSURE BALANCE HOT AND COLD WATER SHOWER CONTROL VALVE WITH	TYPE: WCO DESCRIPTION: WALL CLEANOUT. CAST IRON CLEANOUT FERRULE WITH COUNTERSUNK ABS PLUG AND ROUND STAINLESS COVER PLATE WITH CENTER SECURING SCREW. WADE 8550 WITH 8304-85. PROVIDE WADE 8560 CAST IRON TEE IN LIEU OF FERRULE AS REQUIRED FOR FOR WALL CONSTRUCTION.
FLUSH VALVE:	CONCEALED CHECK HINGES, ANTI-MICROBIAL BUILT-IN AND STA-TITE FASTENING SYSTEM. BEMIS #2155SSCT. 1.28 GALLON FLUSH CYCLE. MANUAL FLUSH WITH ANTI-MICROBIAL HANDLE CUVERRO, DIAPHRAGM TYPE, CHROME PLATED BRASS, VACUUM BREAKER, SPUD COUPLING FOR 1-1/2" TOP SPUD. SLOAN ROYAL #111-1.28-CV.	DRAIN:	VANDAL RESISTANT LEVER HANDLE, INTEGRAL CHECK STOPS AND ADJUSTABLE TEMPERATURE LIMIT SCREW. CAST BRASS VALVE BODY. ALL EXPOSED MATERIALS SHALL BE STAINLESS STEEL OR CHROME PLATED BRASS.1.5 GPM VANDAL RESISTANT SHOWER HEAD. SYMMONS #1-100-150-1.5-VP-X-CHKS REFER TO "TD-1" IN FIXTURE SCHEDULE.	TYPE: WH-1 - COLD WATER DESCRIPTION: FREEZE PROOF WALL HYDRANT, CONCEALED, BRONZE BODY, ANIT-SIPHON, INTEGRAL BACKFLOW PREVENTION, 3/4" MALE HOSE THREAD, WALL CLAMP, STAINLESS STEEL BOX AND STAINLESS STEEL HINGED LOCKING COVER. WADE #8701-85-87.
ROUGH-IN:	4" WASTE, 2" VENT, 1" COLD WATER. REFER TO ARCHITECTURAL DRAWINGS FOR HEIGHT REQUIREMENTS.	ROUGH-IN:	1/2" HOT AND COLD WATER. REFER TO ARCHITECTURAL DRAWINGS FOR HEIGHT REQUIREMENTS.	ROUGH-IN: 3/4" COLD WATER. REFER TO ARCHITECTURAL DRAWINGS FOR HEIGHT REQUIREMENTS.
TYPE: DESCRIPTION: SEAT: FLUSH VALVE: ROUGH-IN:	WC-2 (T.A.S. COMPLIANT) WATER CLOSET, WALL MOUNTED, WHITE VITREOUS CHINA WITH ANTIMICROBIAL SURFACE, 1.28 GALLON PER FLUSH SIPHON JET ACTION, ELONGATED CLOSET BOWL WITH 1- 1/2" BACK SPUD AND BOLT COVERS. AMERICAN STANDARD "AFWALL MILLENIUM" #3353.101. ELONGATED OPEN FRONT WHITE PLASTIC SEAT WITH SELF SUSTAINING CONCEALED CHECK HINGES, ANTI-MICROBIAL BUILT-IN AND STA-TITE FASTENING SYSTEM. BEMIS #2155SSCT. 1.28 GALLON FLUSH CYCLE. MANUAL FLUSH WITH ANTI-MICROBIAL HANDLE CUVERRO, DIAPHRAGM TYPE, CHROME PLATED BRASS, VACUUM BREAKER, SPUD COUPLING FOR 1-1/2" TOP SPUD. SLOAN ROYAL #111-1.28-CV. 4" WASTE, 2" VENT, 1" COLD WATER. REFER TO ARCHITECTURAL DRAWINGS	TYPE: DESCRIPTION: CONTROLS:	SH-2 - INDIVIDUAL SHOWER STATION - NON TAS COMPLIANT SHOWER, JOB SITE BUILT AND INSTALLED PER THE ARCHITECTURAL DRAWINGS. CONFIRM CONFIGURATION AND ORIENTATION WITH ARCHITECTURAL DRAWINGS. PRESSURE BALANCE HOT AND COLD WATER SHOWER CONTROL VALVE WITH VANDAL RESISTANT LEVER HANDLE, INTEGRAL CHECK STOPS AND ADJUSTABLE TEMPERATURE LIMIT SCREW. CAST BRASS VALVE BODY. ALL EXPOSED MATERIALS SHALL BE STAINLESS STEEL OR CHROME PLATED BRASS. 1.5 GPM VANDAL RESISTANT HAND HELD SHOWER WITH 60" METAL CLAD FLEXIBLE HOSE, CHROME PLATED BRASS SUPPLY ARM, VACUUM BREAKER, MOUNTING BRACKET AND 24" METAL SLIDE BAR.	TYPE: TD-1 SERVICE: SHOWERS DESCRIPTION: TRENCH DRAIN, PRE-MANUFACTURED BODY (HDPE OR GLASS FIBER REINFORCED) WITH BOTTOM CENTER OUTLET, 2-1/2" WIDE STAINLESS STEEL HEEL PROOF GRATE AND STAINLESS STEEL FRAME. COORDINATE EXACT LENGTH WITH ARCHITECTURAL DRAWINGS (APPROXIMATELY 8'-0" LONG AND 12'-0" LONG) TRAP SEAL: PROVIDE PRO-SET SYSTEMS, INC. TRAP GUARD FACTORY TO FITTED TO MATCH FLOOR DRAIN BY SIZE, MODEL AND MANUFACTURER. ROUGH-IN: 2" WASTE AND VENT. REFER TO FLOOR PLAN FOR SIZES. COORDINATE FINAL LOCATION AND INSTALLATION WITH ARCHITECTURAL DRAWINGS AND FLOOR CONSTRUCTION. PROVIDE CONCRETE ENCASEMENT AS RECOMMENDED BY
Nogen IIV.	FOR HEIGHT REQUIREMENTS.	DRAIN: ROUGH-IN:	SYMMONS #1-25-FSB-ADAHS-1.5-VP-X-CHKS SAME AS FD-1. 1/2" HOT AND COLD WATER. REFER TO ARCHITECTURAL DRAWINGS FOR	TYPE: TD-2
TYPE: DESCRIPTION:	U-1(T.A.S. COMPLIANT) URINAL, WALL HUNG, WHITE VITREOUS CHINA WITH ANTIMICROBIAL SURFACE, 0.5 GALLON PER FLUSH, WASHOUT FLUSH ACTION, INTEGRAL TRAP, REMOVABLE DOMED STRAINER AND TOP SPUD. AMERICAN STANDARD "WASHBROOK FLOWISE" #6515.001EC	TYPE: DESCRIPTION:	MS-1 MOP SINK BASIN, 36" X 36" X 12" HIGH CORNER TYPE, PRECAST TERRAZZO	SERVICE: LAUNDRY DESCRIPTION: FIELD FABRICATED CONCRETE TROUGH, REFER TO STRUCTURAL AND ARCHITECTURAL DRAWINGS FOR DETAILS. PROVIDE THE FOLLOWING DRAIN IN CENTER BOTTOM OF TRENCH. CAST IRON BODY WITH ANCHOR FLANGE,
FLUSH VALVE: CARRIER: ROUGH-IN:	0.5 GALLON FLUSH CYCLE. MANUAL FLUSH WITH ANTI-MICROBIAL HANDLE CUVERRO, DIAPHRAGM TYPE, CHROME PLATED BRASS, VACUUM BREAKER, SPUD COUPLING FOR 3/4" TOP SPUD. SLOAN ROYAL #111-0.5-CV. RECTANGULAR STEEL TUBING UPRIGHTS WITH WELDED 4" SQUARE BASE ANCHORED TO CONCRETE WITH (4) 1/2" BOLTS, ADJUSTABLE SLEEVE, UPPER AND LOWER BEARING PLATES WITH THREADED STUDS. WADE #401-AM1-M36. 2" WASTE. 2" VENT. 3/4" COLD WATER. REFER TO ARCHITECTURAL DRAWINGS	FAUCET:	WITH 6" DROPPED FRONT, STAINLESS STEEL THRESHOLD CAP, AND DOUBLE STAINLESS STEEL WALL GUARDS.STERN-WILLIAMS "CORLOW" SBC-1750. CHROME PLATED BRASS WALL MOUNTED FITTING WITH CHECK IN STOPS, ADJUSTABLE SUPPLY ARMS, VACUUM BREAKER SPOUT WITH PAIL HOOK AND WALL BRACE, 2-1/2" INDEXED LEVER HANDLES ON 8" CENTERS. QUARTER TURN CARTRIDGES, 3/4" MALE HOSE THREAD OUTLET. CHICAGO #445-897-SRXKCCP.	CLAMPING COLLAR, NICKEL BRONZE DOME STRAINER AND SEDIMENT BUCKET. WADE #1000-KR-26-27 TRAP SEAL: PROVIDE PRO-SET SYSTEMS, INC. TRAP GUARD FACTORY TO FITTED TO MATCH FLOOR DRAIN BY SIZE, MODEL AND MANUFACTURER. ROUGH-IN: 4" WASTE AND 2"VENT. REFER TO FLOOR PLAN FOR SIZES. COORDINATE FINAL LOCATION AND INSTALLATION WITH ARCHITECTURAL DRAWINGS AND FLOOR CONSTRUCTION. PROVIDE CONCRETE ENCASEMENT AS
ROUGH-IN:	FOR HEIGHT REQUIREMENTS.	ROUGH-IN:	3" WASTE, 2" VENT, 1/2" HOT AND COLD WATER.	RECOMMENDED BY THE MANUFACTURER.
TYPE: DESCRIPTION:	L-1 (T.A.S. COMPLIANT) - TEMPERED WATER LAVATORY, SOLID ONE PIECE COUNTER TOP WITH SIX INTEGRAL BOWLS. BRADLEY OMNI-DECK 3000 SERIES. LD-3100-CST L229 D24-HS-TR1- 6-DR2-SW-1-WR-STD-EE-BS-FA-LSS-RSS-3-3-AS-K-4"SET-NSD-BRKT-LD-TRAP. COORDINATE COLOR SELECTION WITH ARCHITECT. COORDINATE	TYPE: DESCRIPTION:	EDF-1 (T.A.S. COMPLIANT) WALL HUNG, BARRIER FREE, SPLIT-LEVEL ELECTRIC DRINKING FOUNTAIN WITH BOTTLE FILLER, ALL STAINLESS STEEL, VANDAL RESISTANT BUBBLER GUARD AND PUSH BUTTON ACTIVATION. SHALL DELIVER 8 GPH OF 50 DEGREE WATER AT 90 DEGREE AMBIENT AND 80 DEGREE INLET WATER. ELKAY # VRCTL8WSK.	
FAUCET:	ANCHORING AND STUD REQUIREMENTS WITH MANUFACTURER. CHROME PLATED BRASS DECK MOUNTED LAVATORY METERING FAUCET, 3-1/2" SPOUT, PUSH-TILT TYPE PUSH BUTTON, VANDAL RESISTANT 0.5 GPM LAMINAR FLOW OUTLET AND 4" COVER PLATE. CHICAGO FAUCET #333-E2805-336CAB AND COVER PLATE #333-004KJKCP	P-TRAP: SUPPLIES:	1-1/4" CHROME PLATED CAST BRASS TRAP WITH CLEANOUT AND EXTENSION TO WALL WITH ESCUTCHEON. MCGUIRE #8872C. 1/2" I.P.S. X 3/8" O.D.CHROME PLATED LOOSE KEY STOP VALVE WITH ESCUTCHEON AND 3/8" COMPRESSION CHROME PLATED FLEXIBLE RISERS. MCGUIRE #2165LK.	
MIXING VALVE:	ASSE 1070 CERTIFIED ADJUSTABLE THERMOSTATIC MIXING VALVE WITH WAX FILLED THERMOSTAT, CHECK VALVES ON SUPPLY INLETS AND MOUNTING BRACKET. BRADLEY #S59-4007 AND #S59-2976 BRACKET. (105° F)	CARRIER:	RECTANGULAR STEEL TUBING UPRIGHTS WITH WELDED 3" X 4-1/2" BASE ANCHORED TO CONCRETE SLAB WITH (4) 1/2" BOLTS. ADJUSTABLE SLEEVE FOR CONNECTION TO HANGER PLATE PROVIDED BY FIXTURE	
STRAINER: P-TRAP"	1-1/4" 17 GAUGE CHROME PLATED BRASS GRID STRAINER WITH TAILPIECE. MCGUIRE #155A. 1-1/4" 17 GAUGE CHROME PLATED HEAVY CAST BRASS TRAP WITH CLEANOUT AND EXTENSION TO WALL WITH ESCUTCHEON PLATE. MCGUIRE #8872.	ROUGH-IN:	MANUFACTURER. WADE 400. 2" WASTE, 2" VENT, 1/2" COLD WATER. REFER TO ARCHITECTURAL DRAWINGS FOR HEIGHT REQUIREMENTS.	
SUPPLIES:	1/2" I.P.S. X 3/8" O.D.CHROME PLATED LOOSE KEY STOP VALVE WITH ESCUTCHEON AND 3/8" COMPRESSION CHROME PLATED FLEXIBLE RISERS. MCGUIRE #2165LK.	TYPE: DESCRIPTION:	SK-1 (T.A.S. COMPLIANT) - HOT AND COLD WATER - CLASSROOM SINK, COUNTER MOUNTED, UNDER COUNTER MOUNTED, 18 GAUGE TYPE 304	
CARRIER: ROUGH-IN:	RECTANGULAR STEEL TUBING UPRIGHTS WITH WELDED 3" X 4-1/2" BASE ANCHORED TO CONCRETE WITH (4) 1/2" BOLTS, ADJUSTABLE SLEEVE, THREADED CONCEALED ARMS, ALIGNMENT BAR, LOCKING DEVICE, AND LEVELING SCREWS. WADE 520-M36. 2" WASTE, 2" VENT, 1/2" COLD WATER ONLY. REFER TO ARCHITECTURAL	FAUCET:	STAINLESS STEEL, 21" X 15" X 5-1/2" DEEP, SINGLE COMPARTMENT. ELKAY #ELUHAD2115 CHROME PLATED BRASS DECK MOUNTED FITTING WITH 8" GOOSENECK SPOUT AND 4" ANTI-MICROBIAL WRIST BLADE HANDLES ON 8" CENTERS. QUARTER TURN CERAMIC DISC OPERATING CARTRIDGES, VANDAL	
TYPE:	DRAWINGS FOR HEIGHT REQUIREMENTS. L-2 (FACULTY T.A.S. COMPLIANT) - TEMPERED WATER	STRAINER:	RESISTANT 1.5 GPM AERATOR. CHICAGO #201-G8AE35-XKAB-317PRJKSAM. CHROME PLATED WROUGHT BRASS 4-1/2" WIDE GRID SINK STRAINER, 1-1/4" 17 GAUGE CHROME PLATED BRASS TAILPIECE. MCGUIRE #152.	
DESCRIPTION: FAUCET:	LAVATORY, WALL HUNG, WHITE VITREOUS CHINA, 20-1/2" X 18-1/4" WITH FRONT OVERFLOW AND CONCEALED ARM SUPPORTS, 4" FAUCET SPREAD. AMERICAN STANDARD "LUCERNE" #0355.012. CHROME PLATED BRASS DECK MOUNTED LAVATORY FAUCET, 4-5/8" SPOUT,	P-TRAP: SUPPLIES:	1-1/2" 17 GAUGE CHROME PLATED CAST BRASS TRAP WITH CLEANOUT AND EXTENSION TO WALL WITH ESCUTCHEON PLATE. MCGUIRE #8912. 1/2" I.P.S. X 3/8" O.D.CHROME PLATED LOOSE KEY STOP VALVE WITH ESCUTCHEON AND 3/8" COMPRESSION CHROME PLATED FLEXIBLE RISERS.	
MIXING VALVE:	SINGLE LEVER, 4" CENTERSET, CERAMIC OPERATING CARTRIDGE, VANDAL RESISTANT 0.5 GPM LAMINAR FLOW OUTLET. CHICAGO #420-E20805ABCP ASSE 1070 CERTIFIED ADJUSTABLE THERMOSTATIC MIXING VALVE WITH WAX	ROUGH-IN:	MCGUIRE #2165LK. 2" WASTE, 2" VENT, 1/2" HOT AND COLD WATER. REFER TO ARCHITECTURAL DRAWINGS FOR HEIGHT REQUIREMENTS.	
STRAINER:	FILLED THERMOSTAT, CHECK VALVES ON SUPPLY INLETS AND MOUNTING BRACKET. BRADLEY #S59-4007BY AND #S59-2976 BRACKET. (105° F) 1-1/4" 17 GAUGE CHROME PLATED BRASS GRID STRAINER WITH TAILPIECE. MCGUIRE #155A.	TYPE: DESCRIPTION:	HB-1 - COLD WATER FREEZE PROOF HOSE BIBB, EXPOSED TYPE, ANIT-SIPHON, INTEGRAL	
P-TRAP" SUPPLIES:	1-1/4" 17 GAUGE CHROME PLATED HEAVY CAST BRASS TRAP WITH CLEANOUT AND EXTENSION TO WALL WITH ESCUTCHEON PLATE. MCGUIRE #8872. 1/2" I.P.S. X 3/8" O.D.CHROME PLATED LOOSE KEY STOP VALVE WITH	ROUGH-IN:	BACKFLOW PREVENTION, 3/4" MALE HOSE THREAD, STAINLESS STEEL SEAT, EPDM PACKING, WALL FLANGE AND OVAL POWDER COATED ALUMINUM HANDLE AND TEE KEY. WOODFORD #MODEL 19 SERIES. 3/4" COLD WATER. REFER TO ARCHITECTURAL DRAWINGS FOR HEIGHT	
CARRIER:	ESCUTCHEON AND 3/8" COMPRESSION CHROME PLATED FLEXIBLE RISERS. MCGUIRE #2165LK. RECTANGULAR STEEL TUBING UPRIGHTS WITH WELDED 3" X 4-1/2" BASE ANCHORED TO CONCRETE WITH (4) 1/2" BOLTS, ADJUSTABLE SLEEVE,	TYPE:	REQUIREMENTS. RVB-1	
ROUGH-IN:	THREADED CONCEALED ARMS, ALIGNMENT BAR, LOCKING DEVICE, AND LEVELING SCREWS. WADE 520-M36. 2" WASTE, 2" VENT, 1/2" COLD WATER ONLY. REFER TO ARCHITECTURAL DRAWINGS FOR HEIGHT REQUIREMENTS.	DESCRIPTION: ROUGH-IN:	RECESSED VALVE BOX, 7" X 7", 20 GAUGE STEEL WITH WHITE POWDER COAT FINISH. 1/2" BRASS QUARTER TURN VALVE WITH THE THREADED CONNECTION. PROVIDE FILTER WHEN MAKING FINAL CONNECTION. GUY GRAY #MIB1AB WITH AQUA PURE #AP717 FILTER. 1/2" COLD WATER. REFER TO ARCHITECTURAL DRAWINGS FOR HEIGHT	
TYPE: DESCRIPTION:	L-1 (T.A.S. COMPLIANT) - TEMPERED WATER LAVATORY, SOLID ONE PIECE COUNTER TOP WITH TWO INTEGRAL BOWLS. BRADLEY OMNI-DECK 3000 SERIES. LD-3100-CST L75 D24-HS-TR1- 2-DR2-EE-BS-FA-LSS-RSS-3-3-4"SET-NSD-BRKT-LD-TRAP.	TYPE:	REQUIREMENTS. FD-1	
FAUCET:	COORDINATE COLOR SELECTION WITH ARCHITECT. COORDINATE ANCHORING AND STUD REQUIREMENTS WITH MANUFACTURER. CHROME PLATED BRASS DECK MOUNTED LAVATORY METERING FAUCET, 3-1/2" SPOUT, PUSH-TILT TYPE PUSH BUTTON, VANDAL RESISTANT 0.5 GPM	SERVICE: DESCRIPTION: TRAP SEAL:	TOILET ROOMS AND GENERAL USE. FLOOR DRAIN, CAST IRON BODY, ADJUSTABLE 6" DIAMETER STAINLESS STEEL FRAME AND GRATE (HEEL PROOF), ANCHOR FLANGE, SEEPAGE OPENINGS, CLAMPING COLLAR AND TRAP SEAL DEVICE. WADE #1100-MR6-85 PROVIDE PRO-SET SYSTEMS, INC. TRAP GUARD FACTORY TO FITTED TO	
MIXING VALVE:	LAMINAR FLOW OUTLET AND 4" COVER PLATE. CHICAGO FAUCET #333-E2805-336CAB AND COVER PLATE #333-004KJKCP ASSE 1070 CERTIFIED ADJUSTABLE THERMOSTATIC MIXING VALVE WITH WAX FILLED THERMOSTAT, CHECK VALVES ON SUPPLY INLETS AND MOUNTING	ROUGH-IN:	MATCH FLOOR DRAIN BY SIZE, MODEL AND MANUFACTURER. REFER TO FLOOR PLAN FOR SIZES. COORDINATE FINAL LOCATION AND INSTALLATION WITH ARCHITECTURAL DRAWINGS AND FLOOR	
STRAINER:	BRACKET. BRADLEY #S59-4007 AND #S59-2976 BRACKET. (105° F) 1-1/4" 17 GAUGE CHROME PLATED BRASS GRID STRAINER WITH TAILPIECE. MCGUIRE #155A.	TYPE:	CONSTRUCTION. FS-1	GENERAL NOTES
P-TRAP" SUPPLIES:	1-1/4" 17 GAUGE CHROME PLATED HEAVY CAST BRASS TRAP WITH CLEANOUT AND EXTENSION TO WALL WITH ESCUTCHEON PLATE. MCGUIRE #8872. 1/2" I.P.S. X 3/8" O.D.CHROME PLATED LOOSE KEY STOP VALVE WITH ESCUTCHEON AND 3/8" COMPRESSION CHROME PLATED FLEXIBLE RISERS. MCGUIRE #2165LK.	SERVICE: DESCRIPTION:	MECHANICAL ROOMS, INDIRECT WASTE A.R.E. FLOOR SINK, CAST IRON BODY WITH 8" SQUARE FLOOR SINK WITH 6" DEEP SUMP, BOTTOM OUTLET, A.R.E. DOME STRAINER, STAINLESS STEEL FRAME AND GRATE, ANCHOR FLANGE, CLAMPING COLLAR, AND HALF TOP	ALL LAVATORIES AND SINKS SHALL BE SUPPLIED WITH HOT AND COLD WATER (UNLESS NOTED TO BE COLD WATER ONLY) TO FAUCETS AS INDICATED ON PLANS AND FIXTURE SCHEDULE. PROVIDE CHROME PLATED BRASS SUPPLY STOPS WITH LOOSE KEYS AND WALL ESCUTCHEONS. PROVIDE CHROME PLATED FLEXIBLE RISERS OF SIZE REQUIRED TO
CARRIER:	RECTANGULAR STEEL TUBING UPRIGHTS WITH WELDED 3" X 4-1/2" BASE ANCHORED TO CONCRETE WITH (4) 1/2" BOLTS, ADJUSTABLE SLEEVE, THREADED CONCEALED ARMS, ALIGNMENT BAR, LOCKING DEVICE, AND LEVELING SCREWS. WADE 520-M36.	TRAP SEAL: ROUGH-IN:	GRATE. WADE 9140-85-15-26. PROVIDE PRO-SET SYSTEMS, INC. TRAP GUARD FACTORY TO FITTED TO MATCH FLOOR DRAIN BY SIZE, MODEL AND MANUFACTURER. REFER TO FLOOR PLAN FOR SIZES. COORDINATE FINAL LOCATION AND INSTALLATION WITH EQUIPMENT PLACEMENT AND FLOOR CONSTRUCTION.	PROPERLY CONNECT FIXTURES. PROVIDE 17 GAUGE CHROME PLATED CAST BRASS P-TRAP WITH CLEANOUT AND EXTENSION TO WALL WITH ESCUTCHEON (UNLESS NOTED TO BE AN ACID WASTE FIXTURE). REFER TO FIXTURE SCHEDULE FOR MINIMUM SIZES OF PLUMBING FIXTURE ROUGH-INS.
ROUGH-IN:	2" WASTE, 2" VENT, 1/2" COLD WATER ONLY. REFER TO ARCHITECTURAL DRAWINGS FOR HEIGHT REQUIREMENTS.	TYPE: DESCRIPTION:	ECO EXTERIOR CLEANOUT TO GRADE, CAST IRON BODY WITH ADJUSTABLE THREADED HOUSING, FLANGED FERRULE, INTEGRAL CLAMPING COLLAR, ABS PLUG AND DUCTILE IRON SCORIATED ROUND COVER. IF LOCATED IN ASPHALT OR DIRT PROVIDE 18"X18"X12" CONCRETE PAD. WADE 6000-12-81.	INSULATION KITS AT ALL LAVATORIES AND SINKS REQUIRED TO BE T.A.S. ACCESSIBLE (MCGUIRE OR TRUEBRO). ALL SUCH FIXTURES AND FINAL INSTALLATIONS SHALL COMPLY WITH THE STATE ACCESSIBILITY STANDARDS REQUIREMENTS. INSERT TRAP GUARDS AFTER FINAL RODDING OF DRAINS. INSTALL TRAP GUARD WITH CLEAR SILICONE CAULK FOR GAS-TIGHT SEAL. FOR DRAIN RODDING AFTER INSTALLATION. INSERT SEWER TAPE THROUGH LIGHTLY GREASED 1-1/2" PVC PIPE TO PROTECT TRAP
		TYPE: DESCRIPTION:	FCO FLOOR CLEANOUT, CAST IRON BODY AND ADJUSTABLE THREADED HOUSING FLANGED FERRULE, INTEGRAL CLAMPING COLLAR, ABS PLUG AND SCORIATED STAINLESS STEEL COVER. WADE 6000-85-81. FOR CARPETED FLOORS PROVIDE WADE 6000-85-CF.	GUARD. IN ALL RESTROOMS, POWER SUPPLIES FOR FAUCETS AND FLUSH VALVES SHALL BE LOCATED IN ACCESSIBLE CHASES DIRECTLY BEHIND THE FIXTURES.

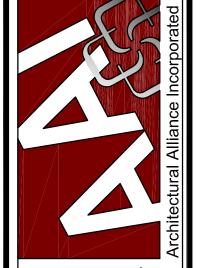

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04-18-2022

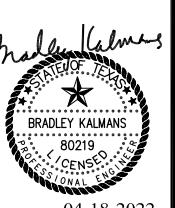WEST BROOK AUXILIARY FIELD HOUSE

ISSUED FOR 100% REVIEW DATE: 01/12/2022

DESIGN DEVELOPMENT ----

BIDS & CONSTRUCTION X

DATE: 04/18/2022

REVISION:

DATE:_____ REVISION: DATE:_____

REVISION: DATE:

PLUMBING
DETAILS AND
SCHEDULES

SHEET NUMBER

21021
PROJECT NUMBER

SALASO'BRIEN

[expect a difference]

10930 W. Sam Houston Parkway N., Suite 900 Houston, Texas 77064 281.664.1900 | Registration No. F-4111

Project No. 2021-04159-00

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DISREGARD FIXTURES LISTED THAT ARE NOT ON THIS JOB.

	TECH	INOLOGY LI	EGEND	
SYMBOL	DESCRIPTION	ELEVATION	BACK BOX/RACEWAY	NOTES
*#	WALL MOUNTED NETWORK OUTLET D#: NUMBER OF DATA DROPS IN OUTLET AP: WIRELESS ACCESS POINT	+18" AFF, UNLESS OTHERWISE NOTED	4"X4"X2 1/8" BACK BOX WITH 1-G MUD RING, 1"C	
AP ▼	WALL MOUNTED NETWORK OUTLET AP: WIRELESS ACCESS POINT	REFERENCE FLOOR PLAN	4"X4"X2 1/8" BACK BOX WITH 1-G MUD RING, 1"C	
V#	COMMUNICATIONS OUTLET	FIELD COORDINATE	FIELD COORDINATE	
W	WALL MOUNTED NETWORK OUTLET	+44" AFF	4"X4"X2 1/8" BACK BOX WITH 1-G MUD RING, 1"C	
$\overset{B}{\bigtriangledown}$	WALL MOUNTED BOX FOR FUTURE USE.	+18" AFF UNO	4"X4"X2 1/8" BACK BOX WITH 1-G MUD RING, 1"C	PROVIDE BLANK COVER REFER TO SPECIFICATIONS
D# ▼	FLOOR MOUNTED NETWORK OUTLET	N/A	COORDINATE WITH ELECTRICAL CONTRACTOR	FINISHED HARDWARE PROVIDED BY DIV 27
-	CEILING MOUNTED NETWORK OUTLET AP: WIRELSS ACCESS POINT D#": NETWORK OUTLET	ABOVE CEILING	CEILING BRACKET WITH BISCUIT BLOCK	
РВ	24" X 24" X 24" PULL BOX	REFERENCE FLOOR PLAN FOR QUANTITY AND LOCATION	N/A	MODEL #: OLDCASTLE 222 PB-KY

#-G INDICATES BACK BOX SIZE. #-C INDICATES CONDUIT SIZE.

UNO: UNLESS NOTED OTHERWISE

. CONDUIT STUB UP AND SLEEVES SHALL HAVE A SOLID UNCUT PLASTIC PROTECTIVE BUSHING. 5. NO CONDUITS SHALL EXCEED FOR 40% MAXIMUM FILL RATIO. CONTRACTOR TO PROVIDE ADDITIONAL CONDUITS REQUIRED.

	ACCESS CON	ITROL LEGI	END	
SYMBOL	DESCRIPTION	ELEVATION	BACK BOX/RACEWAY	NOTES
ACP	ACCESS CONTROL SYSTEM, CONTROL PANEL.	+60" AFF TO CENTER	AS REQUIRED	COORDINATE POWER. NOTE #4.
CR _{*#}	ACCESS CONTROL PROXIMITY CARD READER. *W - INDICATES WALL MOUNTED READER *M - INDICATES MULLION MOUNTED READER	+42" A.F.F.	1-G, 3/4" C	
(CR)	DOOR MOUNTED ACCESS CONTROL PROXIMITY CARD READER THAT IS INTEGRATED INTO THE DOOR HARDWARE.	+42" AFF	N/A	
DS *#	2-WAY AUDIO/VIDEO INTERCOM DOOR STATION. *W - INDICATES WALL MOUNTED READER *M - INDICATES MULLION MOUNTED READER	+42" AFF	*W: 1-G, 3/4" C *M: 3/4"C	COORDINATE POWER. NOTE #4.
(DS)	DOOR MOUNTED, 2-WAY AUDIO/VIDEO INTERCOM DOOR STATION.	+42" AFF, FIELD COORDINATE		COORDINATE POWER. NOTE #4
MS	2-WAY AUDIO/VIDEO INTERCOM MASTER STATION.	DESK MOUNTED UNO		COORDINATE POWER. NOTE #4
DR	DOOR RELEASE BUTTON	COORDINATE WITH GC	1-G, 3/4" C	
REX	PIR MOTION REQUEST TO EXIT DEVICE			
DP [®]	DOOR PROP ALARM	CEILING MOUNTED UNO	N/A	N/A
©C	DPDT MAGNETIC DOOR CONTACT/DOOR POSITION SENSOR.	FLUSH MOUNTED IN DOOR FRAME	N/A	PROVIDED BY ACS CONTRACTOR.
RFID	VEHICLE RFID TAG READER.		FIELD COORDINATE RACEWAYS AND BACK BOXES	PROVIDE NECESSARY EQUIPMENT FOR A FULLY FUNCTIONAL VEHICLE ENTRY POINT

NOTES:
1. #-G INDICATES BACK BOX SIZE.
2. #-C INDICATES CONDUIT SIZE.

3. UNO: UNLESS NOTED OTHERWISE

4. PROVIDE AND INSTALL ONE (1) CATEGORY CABLE TO CONNECT DEVICE TO NETWORK

	INTERCOM LEGEND								
SYMBOL	DESCRIPTION	ELEVATION	BACK BOX/RACEWAY	NOTES					
ICS	INTERCOM COMMUNICATIONS SYSTEM HEAD END UNIT.	FLOOR MOUNTED	COORDINATE WITH EC	COORDINATE POWER					
<u>(S)</u>	CEILING MOUNTED INTERCOM SPEAKER, LAY-IN CEILING	CEILING	CONTRACTOR PROVIDED						
§ 2	CEILING MOUNTED INTERCOM SPEAKER, HARD CEILING.	CEILING	CONTRACTOR PROVIDED						
§ 3	WALL MOUNTED INTERIOR INTERCOM SPEAKER	REFERENCE FLOOR PLANS	CONTRACTOR PROVIDED						
§ 4)	WALL MOUNTED EXTERIOR INTERCOM SPEAKER	+10' AFF UNO	CONTRACTOR PROVIDED						
#P	IP BASED SPEAKER. '#' TO BE REPLACED WITH S, S2, S3, S4 INDICATING THE SPECIFIC TYPE OF SPEAKER.	REFERENCE FLOOR PLANS	CONTRACTOR PROVIDED	NOTE #5					
VC	WALL MOUNTED VOLUME CONTROL	+48" AFF	4"X4"X2 1/8" BACK BOX WITH 1-G MUD RING, 1"C						
СВ	INTERCOM CALL BUTTON	+48" AFF	4"X4"X2 1/8" BACK BOX WITH 1-G MUD RING, 1"C						
©	SINGLE FACE CLOCK	REFERENCE FLOOR PLANS	4"X4"X2 1/8" BACK BOX WITH 1-G MUD RING, 1"C						
©2)	DOUBLE FACE CLOCK	REFERENCE FLOOR PLANS	4"X4"X2 1/8" BACK BOX WITH 1-G MUD RING, 1"C						
RPS	REMOTE PROGRAM SOURCE	DESK TOP	COORDINATE WITH EC	NOTE #5					
ACS	ADMINISTRATIVE CALL STATION.	DESK TOP	N/A	NOTE #5					
LD	LOCKDOWN BUTTON	+48" AFF	4"X4"X2 1/8" BACK BOX WITH 1-G MUD RING, 1"C						

1. #-G INDICATES BACK BOX SIZE. 2. #-C INDICATES CONDUIT SIZE.

UNO: UNLESS NOTED OTHERWISE

4. THE SYSTEM INTEGRATOR SHALL COORDINATE ALL BOX AND CONDUIT SIZE REQUIREMENTS PRIOR TO ROUGH-IN BY THE PROJECTS

ELECTRICAL CONTRACTOR.

5. PROVIDE AND INSTALL ONE (1) CATEGORY CABLE TO CONNECT DEVICE TO NETWORK

VIDEO SURVEILLANCE LEGEND						
SYMBOL	DESCRIPTION	ELEVATION	BACK BOX/RACEWAY	NOTES		
	WALL/CORNER MOUNT 4-SENSOR CAMERA	REFERENCE FLOOR PLANS	4"X4"X2 1/8" BACK BOX WITH 1-G MUD RING, 1"C	NOTE #5		
K K	CEILING MOUNTED 4-SENSOR CAMERA	CEILING		NOTE #5		
D D	2-SENSOR CAMERA	REFERENCE FLOOR PLANS	4"X4"X2 1/8" BACK BOX WITH 1-G MUD RING, 1"C	NOTE #5		
	1-SENSOR CAMERA	REFERENCE FLOOR PLANS	4"X4"X2 1/8" BACK BOX WITH 1-G MUD RING, 1"C			
VRS	VIDEO RECORDING SERVER					
#MU	VIDEO SURVEILLANCE MAIN UNIT	ABOVE CEILING		NOTE #5		

#-G INDICATES BACK BOX SIZE.

2. #-C INDICATES CONDUIT SIZE.

3. UNO: UNLESS NOTED OTHERWISE 4. THE SYSTEM INTEGRATOR SHALL COORDINATE ALL BOX AND CONDUIT SIZE REQUIREMENTS PRIOR TO ROUGH-IN BY THE PROJECTS

ELECTRICAL CONTRACTOR.

5. PROVIDE AND INSTALL ONE (1) CATEGORY CABLE TO CONNECT DEVICE TO NETWORK OWNERSHIP OF DRAWINGS THIS DOCUMENT AND THE IDEAS AND DESIGNS INCORPORATED HEREIN, AS AN INSTRUMENT OF PROFESSIONAL SERVICES, IS THE PROPERTY OF ARCHITECTURAL ALLIANCE INCORPORATED HEREIN, AS AN INSTRUMENT OF PROFESSIONAL SERVICES, IS THE PROPERTY OF ARCHITECTURAL ALLIANCE INCORPORATED. © COPYRIGHT 2022

	AUD	IO/VIDEO LE	GEND		
SYMBOL	DESCRIPTION	ELEVATION	BACK BOX/RACEWAY	NOTES , NOTE #5	
WMP V	WALL MOUNTED PROJECTOR	REFERENCE FLOOR PLANS	4 11/16"X4 11/16"X2-1/8" BACK BOX WITH DOUBLE GANG RING, TWO(2) 1.25"C		
CMP <	EILING MOUNTED PROJECTOR CEILING MOUNTED N/A		N/A	NOTE #5	
AV-1	WALL MOUNTED AUDIO/VIDEO INPUT OUTLET	+18" AFF UNO	4 11/16"X4 11/16"X2-1/8" BACK BOX WITH DOUBLE GANG RING, TWO(2) 1.25"C		
FSD-1	WALL MOUNTED FLAT SCREEN DISPLAY	+60" AFF TO CENTER OF DISPLAY UNO	4"X4"X2 1/8" BACK BOX WITH 1-G MUD RING, 1"C	NOTE #5	
FSD-2 ₩	WALL MOUNTED FLAT SCREEN DISPLAY ASSOCIATED WITH AV-1 INPUT OUTLET	+60" AFF TO CENTER OF DISPLAY UNO	4 11/16"X4 11/16"X2-1/8" BACK BOX WITH DOUBLE GANG RING, TWO(2) 1.25"C	NOTE #5	
VD	INTERACTIVE VIDEO DISPLAY	REFERENCE FLOOR PLAN	4 11/16"X4 11/16"X2-1/8" BACK BOX WITH DOUBLE GANG RING, TWO(2) 1.25"C	NOTE #5	
CP	AV CONTROL PANEL	+48" AFF TO TOP	4"X4"X2 1/8" BACK BOX WITH 1-G MUD RING, 1"C		
(PS)	LOCAL INSTRUCTIONAL SPACE PRESENTATION SPEAKER	(,F N (-)		COORDINATE POWER	
$\overline{\mathbb{Q}}$	STREAMING CAMERA	CEILING UNO	N/A	NOTE #5	

1. #-G INDICATES BACK BOX SIZE. 2. #-C INDICATES CONDUIT SIZE.

3. UNO: UNLESS NOTED OTHERWISE I. THE SYSTEM INTEGRATOR SHALL COORDINATE ALL BOX AND CONDUIT SIZE REQUIREMENTS PRIOR TO ROUGH-IN BY THE PROJECTS ELECTRICAL CONTRACTOR.

5. PROVIDE AND INSTALL ONE (1) CATEGORY CABLE TO CONNECT DEVICE TO NETWORK

INTRUSION LEGEND						
SYMBOL	DESCRIPTION	ELEVATION	BACK BOX/RACEWAY	NOTES		
יו וייטוו	INTRUSION DETECTION SYSTEM CONTROL PANEL	I DETECTION SYSTEM CONTROL +60" AFF TWO(2) - 1"C TO CONTRACTOR PROVIDED BACK BOX		COORDINATE POWER WITH EC. NOTE #5		
KP	INTRUSION DETECTION SYSTEM KEYPAD.	+48" AFF TO TOP	4"X4"X2 1/8" BACK BOX WITH 1-G MUD RING, 1"C			
M	CEILING MOUNTED MOTION DETECTOR	CEILING				
€	WALL MOUNTED MOTION DETECTOR LR: LONG RANGE	REFERENCE FLOOR PLAN	N/A			
*	CEILING MOUNTED GLASS BREAK DETECTOR	CEILING	N/A			
(00)	DPDT MAGNETIC DOOR CONTACT/DOOR POSITION SENSOR.	FLUSH MOUNTED IN DOOR FRAME	N/A	DEVICE PROVIDED BY ACS CONTRACTOR.		
SDC	SURFACE MOUNT MAGNETIC DOOR CONTACT.	SURFACE MOUNTED ON DOOR FRAME	N/A			
ODC	OVERHEAD DOOR MOUNT MAGNETIC DOOR CONTACT.	SURFACE MOUNTED ON DOOR FRAME	N/A			
DB	DURESS PANIC BUTTON	UNDER DESK UNO	N/A			

PTION	ELEVATION	BACK BOX/RACEWAY	NOTES
NG OUTLET		4"X4"X2 1/8" BACK BOX WITH 1-G MUD RING, 1"C	
	ING OUTLET		ING OUTLET 4"X4"X2 1/8" BACK BOX WITH

REFERENCE DIVISION 28 SPECIFICATION FOR ADDITIONAL INFORMATION AND REQUIRMENTS.

5. PROVIDE AND INSTALL ONE (1) CATEGORY CABLE TO CONNECT DEVICE TO NETWORK

#-G INDICATES BACK BOX SIZE. . #-C INDICATES CONDUIT SIZE.

UNO: UNLESS NOTED OTHERWISE

UNO: UNLESS NOTED OTHERWISE . THE SYSTEM INTEGRATOR SHALL COORDINATE ALL BOX AND CONDUIT SIZE REQUIREMENTS PRIOR TO ROUGH-IN BY THE

PROJECTS ELECTRICAL CONTRACTOR. 5. PROVIDE AND INSTALL ONE (1) CATEGORY CABLE TO CONNECT DEVICE TO NETWORK

SYMBOL	DESCRIPTION
FACP	FIRE ALARM CONTROL
FAA	FIRE ALARM ANNUNCIATOR PANEL
NOTES:	

SPECIFICATIONS FOR ADDITIONAL INFORMATION.

A LICENSED FIRE ALARM PLANNING SUPERINTENDENT CERTIFIED TO A MINIMUM LEVEL 3, IN THE SUBFIELD OF FIRE ALARM SYSTEMS THROUGH THE NATIONAL INSTITUTE FOR CERTIFICATION IN ENGINEERING TECHNOLOGIES (NICET), SHALL PROVIDE PLANS AND CALCULATIONS FOR A MANUAL AND AUTOMATIC FIRE DETECTION AND ALARM SYSTEM TO COMPLY WITH THE BUILDING SPACE LAYOUT, BUILDING OCCUPANCY, CURRENT NFPA 72, LOCAL AND STATE CODE REQUIREMENTS, AND THE FIRE ALARM AND DETECTION SYSTEM SPECIFICATIONS.

SUBSCRIPTS AND ABBREVIATIONS DESCRIPTION DEVICE SHALL BE WEATHER PROOF AND RATED FOR EXTERIOR CONDITIONS FIELD COORDINATE ELEVATION. AFF ABOVE FINSIHED FLOOR

DEVICE IS TO BE MOUNTED ON THE UNDERSIDE OF THE ELEVATED CANOPY.

INTERCOM GENERAL NOTES

. THE FOLLOWING AREAS SHALL BE ZONED SEPARATELY: 1)INTERIOR - ZONE 1 2)EXTERIOR - ZONE 2

2. CONTRACTOR TO TAP ALL SPEAKERS WITHIN THE GYMNASIUM AND CAFETERIA AT 4 WATTS.

3. CONTRACTOR TO TAP ALL EXTERIOR SPEAKERS AT 7 WATTS.

NOTES TO CONTRACTOR

. EVERY SYMBOL SHOWN ON LEGEND MAY NOT APPEAR ON DRAWINGS.

. SYSTEM INSTALLERS SHALL COORDINATE LOCATIONS AND CONNECTIONS WITH THE PROJECT'S ELECTRICAL CONTRACTOR.

. CONTRACTOR TO PROVIDE PROPERLY GROUNDED LIGHTING PROTECTION ON ALL CABLING ENTERING AND EXITING THE BUILDING.

RESPONSIBILITY MATRIX					
SCOPE ITEM	RES	RESPONSIBILITY		NOTES	
COMMUNICATIONS - DIVISION 27	OFOI	CFCI	OFCI		
CATEGORY 6/6A STRUCTURED CABLING SYSTEM		X			
FLAT PANEL DISPLAYS	X				
FLAT PANEL DISPLAY MOUNTS	Х				
NETWORK EQUIPMENT		.!	1	ı	
→ MDF/IDF NETWORK EQUIPMENT		X			
→ VOIP TELEPHONES		X			
→ WIRELESS ACCESS POINTS		Х			
→ UNITERRUPTABLE POWER SUPPLIES (UPS)		X			
RACEWAY: CONDUIT, BACK BOXES, SLEEVES, ETC.		Х		SEE NOTE 1.	
ELECTRICAL POWER		Х		SEE NOTE 1.	
LIFE SAFETY AND SECURITY - DIVISION 28	OFOI	CFCI	OFCI		
ACCESS CONTROL SYSTEM(ACS)		X			
INTRUSION DETECTION SYSTEM		Х			
VIDEO SURVEILLANCE SYSTEM (VSS)		1	!		
→ VSS SERVERS	X				
→ VSS CAMERAS	Х				
→ VSS PROGRAMMING	X				
→ VSS CABLING	X			SEE NOTE 2.	
FIRE ALARM SMOKE DETECTION WITH VOICE EVACUATION		X			
RACEWAY: CONDUIT, BACK BOXES, SLEEVES, ETC.		X		SEE NOTE 1.	
ELECTRICAL POWER		Х		SEE NOTE 1.	
OFOL OWNED FURNISHED AND OWNED INSTALLED	•				

OFOI - OWNER FURNISHED AND OWNER INSTALLED CFCI - CONTRACTOR FURNISHED AND CONTRACTOR INSTALLED OFCI - OWNER FURNISHED AND CONTRACTOR INSTALLED

REPONSIBILITY MATRIX NOTES:

1. BY DIVISION 26.

2. BY DIVISION 27. BY DIVISION 11.

FIELD HOUSE

JXILIARY

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BROOK,

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ISSUED FOR 100% REVIEW

DESIGN DEVELOPMENT 급 DATE:_---- BIDS & CONSTRUCTION X

DATE: 01/12/2022

DATE: 04/18/2022 REVISION: REVISION:


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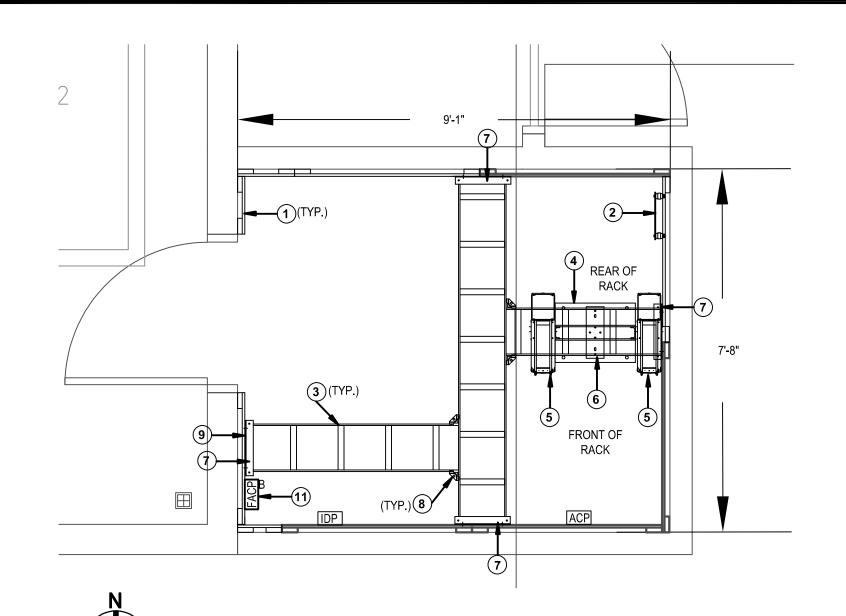
DRAWINGS SHEET TITLE **TECHNOLOGY** NOTES AND LEGENDS

SHEET NUMBER

281.664.1900 | Registration No. F-4111 21021 Project No. 2021-04159-00 PROJECT NUMBER

ALASO'BRIEN 10930 W. Sam Houston Parkway N., Suite 900 Houston, Texas 77064



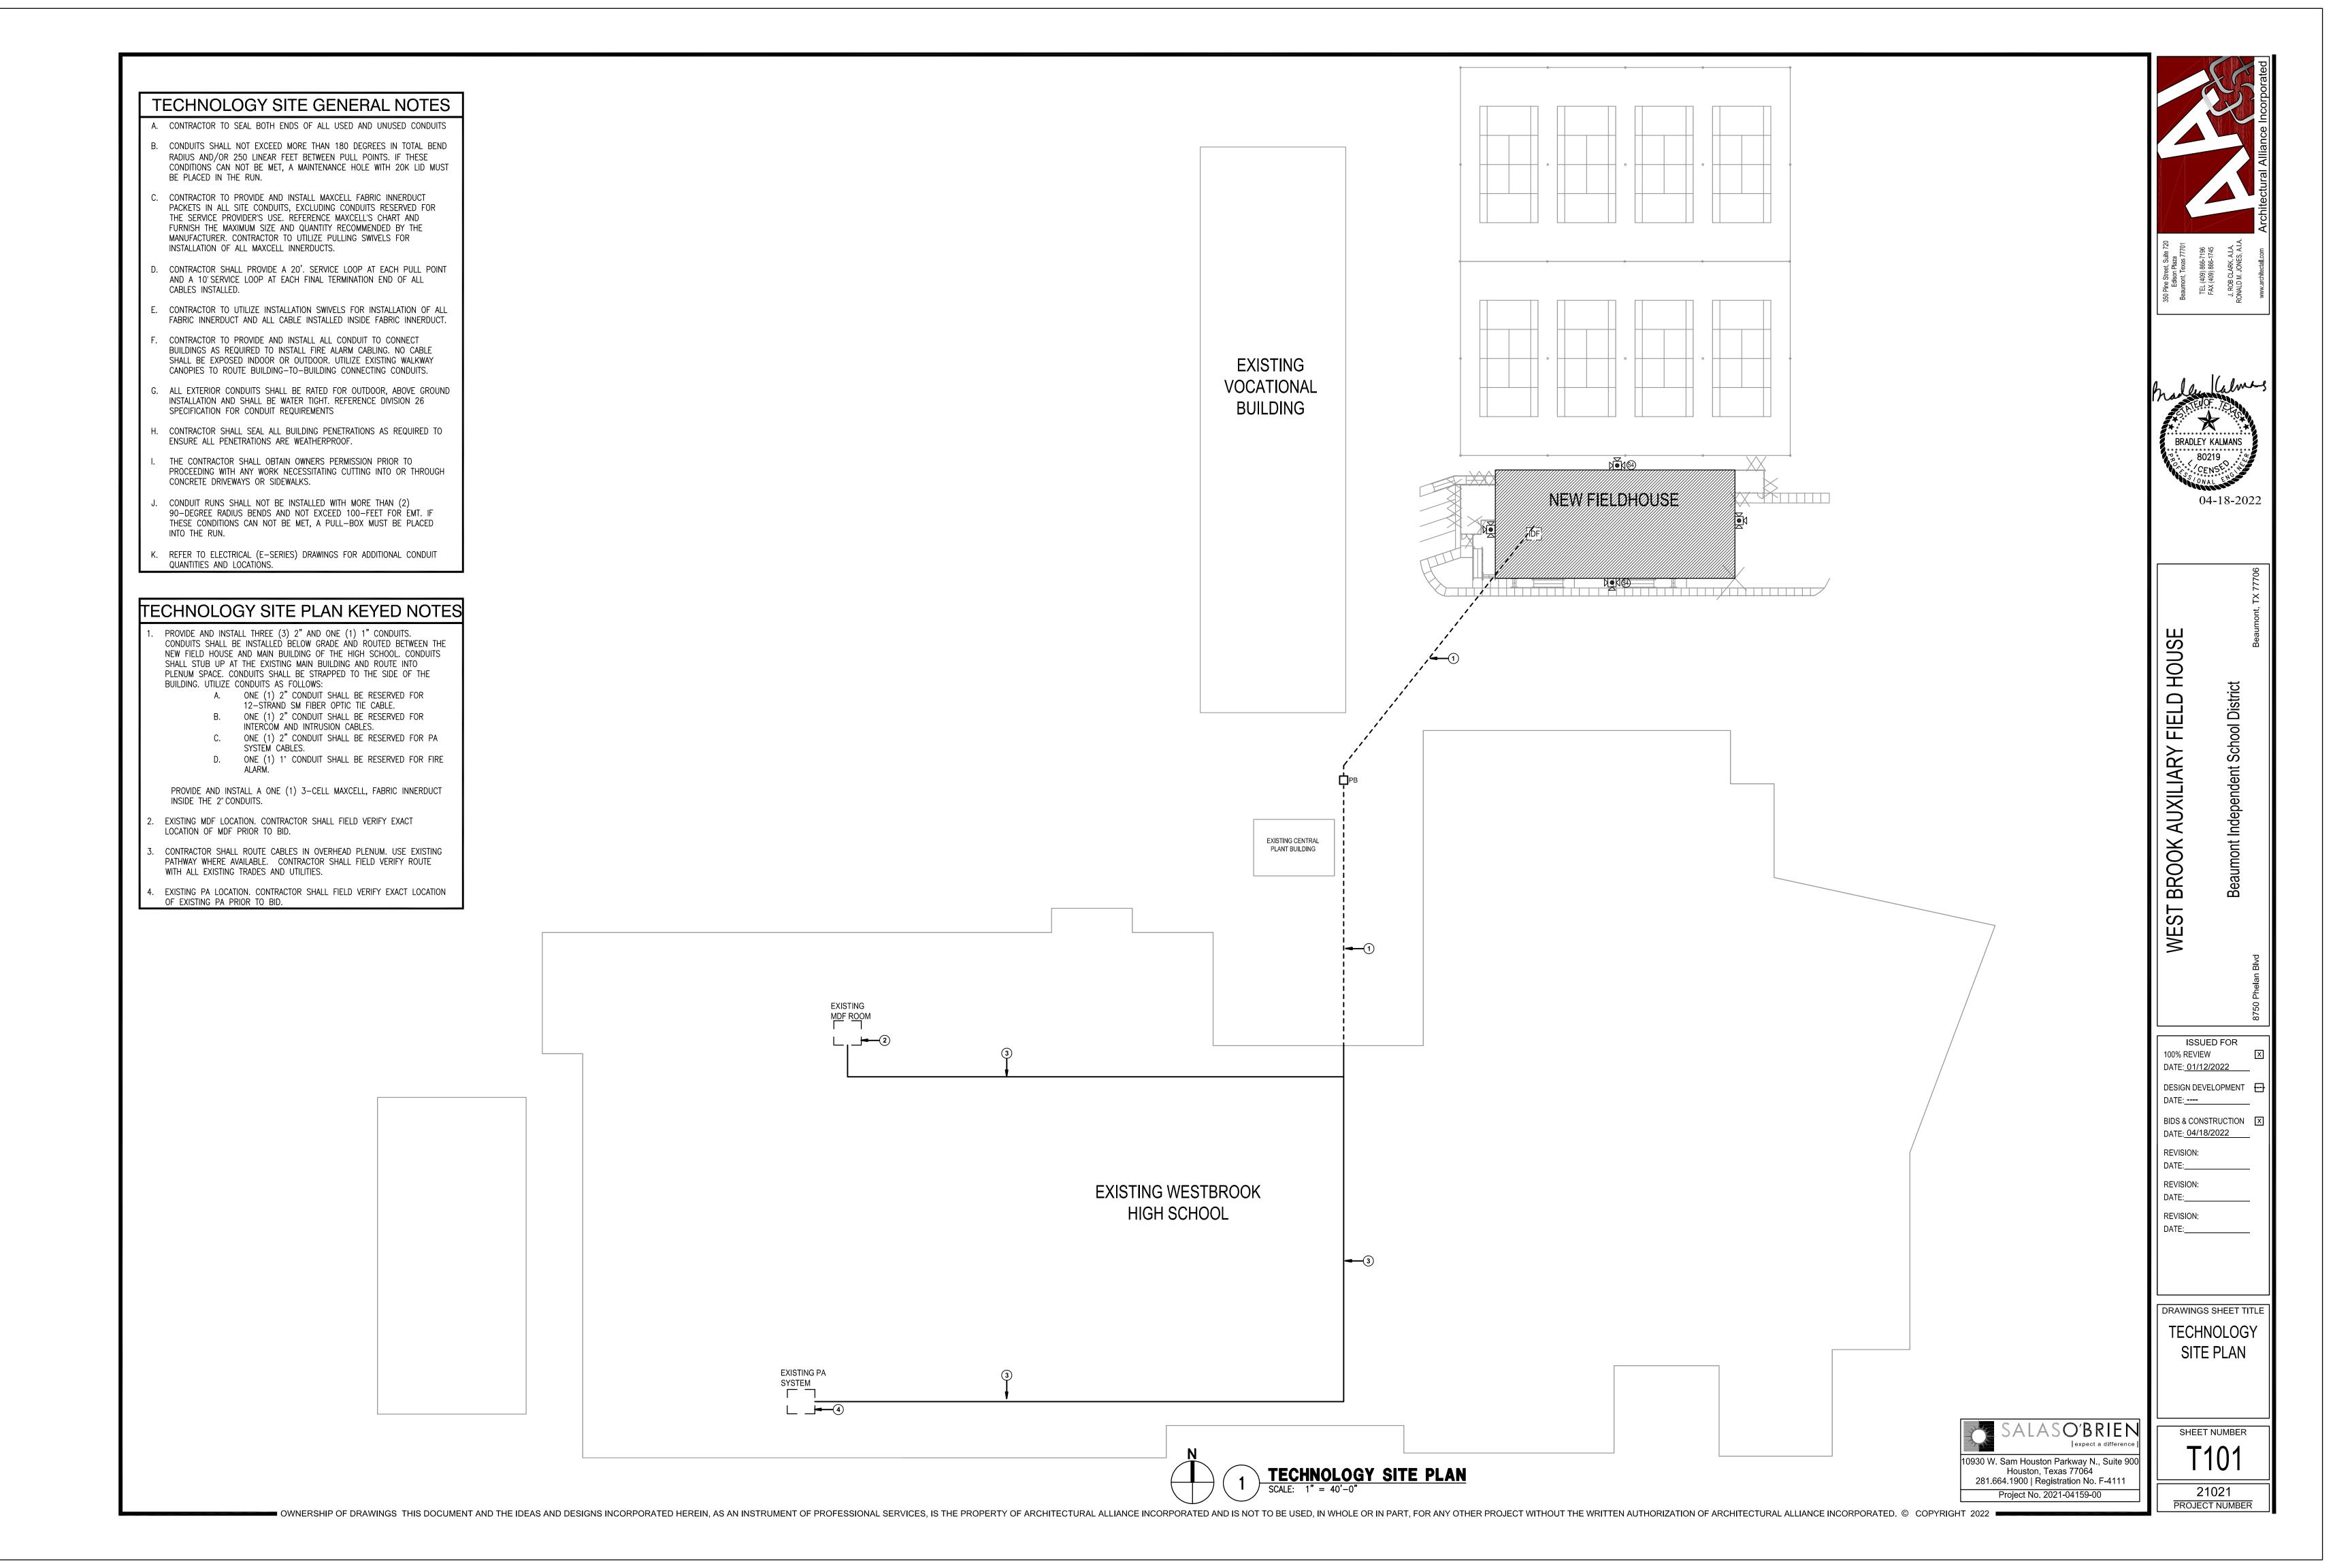

TECHNOLOGY ENLARGED PLAN - TECHNOLOGY 128

TECHNOLOGY PLAN KEYED NOTES


- INDICATES THE LOCATION OF A 8' TALL, 3/4" FIRE RATED PLYWOOD CONTRACTOR TO PROVIDE AND INSTALL PLYWOOD AND ALL REQUIRED MOUNTING HARDWARE. PLYWOOD SHALL BE PAINTED WHITE WITH FIRE RATED PAINT. TYPICAL FOR ALL SHOWN ON DRAWING.
- INDICATES THE LOCATION OF A NEW WALL MOUNTED TELECOMMUNICATION GROUND BUS BAR (TGBB). CABLING CONTRACTOR TO PROVIDE BUS BAR AND ALL REQUIRED MATERIAL TO MOUNT AT THE LOCATION SHOWN. TGBB TO BE MOUNTED AT +93" A.F.F.
- PROVIDE AND INSTALL A 12" WIDE, UNIVERSAL LADDER TRAY AND ALL REQUIRED MOUNTING HARDWARE. LADDER TRAY SHALL BE BLACK IN COLOR. TYPICAL FOR ALL SHOWN ON ENTIRE
- PROVIDE AND INSTALL ONE (1) 2-POST, FLOOR MOUNTED, 7' RELAY RACK (BLACK IN COLOR). PROVIDE BONDING WASHERS, BOLTS, AND NUTS AT ALL MECHANICALLY CONNECTED LOCATIONS OF THE RACK TO ENSURE THAT ALL PIECES OF THE RACK ARE COMPLETELY BONDED. SCRAPING PAINT FROM RACKS TO MAKE A BOND WILL NOT BE ACCEPTED. ALL RACK MOUNTED COMPONENTS SHALL BE MOUNTED WITH BONDING SCREWS AND THE CONTRACTOR SHALL PROVIDE THE OWNER WITH (50) ADDITIONAL BONDING SCREWS FOR THE INSTALLATION OF OWNER EQUIPMENT. NO DAISY CHAINING GROUNDS FROM RACK TO CABLE TRAY OR TO OTHER RACKS WILL BE ACCEPTED. ALL GROUNDS SHALL BE HOME RUN TO THE TELECOMMUNICATIONS GROUND BUS BAR (TGBB). TYPICAL FOR ALL SHOWN ON THE ENTIRE PROJECT.
- PROVIDE AND INSTALL ONE (1) 7'X6", FRONT AND REAR MANAGED, VERTICAL CABLE MANAGER (BLACK IN COLOR). CABLE MANAGERS SHALL BE INSTALLED ON EACH END OF THE RACK SYSTEMS AND BETWEEN EACH RACK. CABLE MANAGERS SHALL HAVE A SINGLE, SOLID, FULL HEIGHT HINGED DOOR IN THE FRONT AND WIDE SPACED CABLE RINGS WITH SPIN-OPEN LATCHES IN THE REAR. TYPICAL FOR ALL SHOWN IN THE ENTIRE PROJECT.
- PROVIDE AND INSTALL RACK-TO-RUNWAY MOUNTING PLATE FOR ALL LOCATIONS WHEN ASSOCIATED WITH A 2-POST OR 4-POST RACK. MOUNTING PLATE SHALL BE BLACK IN COLOR. PROVIDE (1) 6" LADDER TRAY ELEVATION KIT (BLACK IN COLOR) AT EACH RACK-TO-RUNWAY MOUNTING PLATE LOCATION. TYPICAL FOR ALL SHOWN ON THE ENTIRE PROJECT.
- INDICATES THE LOCATION OF A 12" LADDER TRAY WALL ANGLE SUPPORT BRACKET, BLACK IN COLOR. CONTRACTOR TO PROVIDE AND INSTALL WALL ANGLE SUPPORT BRACKET AND ALL REQUIRED MOUNTING HARDWARE AT EACH LOCATION WHERE LADDER TRAY TERMINATES INTO A VERTICAL WALL SECTION. TYPICAL FOR ALL SHOWN.
- PROVIDE AND INSTALL A LADDER JUNCTION SPLICE KIT, BLACK IN COLOR. PROVIDE ONE (1) KIT AT EACH LADDER TRAY JUNCTION SPLICE LOCATION ON THE ENTIRE PROJECT.
- 9. INDICATED DATA DROP TO BE RESERVED FOR VAPE DETECTOR CONNECTION.
- 10. COORDINATE BAS DATA OUTLET LOCATION WITH MECHANICAL / ELECTRICAL CONTRACTORS.
- 11. LOCATION FOR FIRE ACCESS CONTROL BOOSTER PANEL IF REQUIRED.


TECH ENLARGED PLAN GEN NOTES

- ALL RACK LOCATIONS SHALL BE COORDINATED WITH THE PROJECT'S TECHNOLOGY CONSULTANT AND OWNER PRIOR TO INSTALLATION. NO RACKS AND/OR ASSOCIATED CABLE TRAY SYSTEM SHALL BE PERMANENTLY INSTALLED PRIOR TO DOCUMENTED ACCEPTANCE.
- PATCH PANEL QUANTITY SHALL BE DETERMINED BY STATION CABLE DROP COUNTS SHOWN ON TECHNOLOGY PLANS AND THE ASSOCIATED PROJECT MATRIX. ENSURE PATCH PANEL QUANTITY IS SUFFICIENT TO SUPPORT THE NUMBER OF PORTS REQUIRED BY TECHNOLOGY PLANS PLUS AN ADDITIONAL 25% FOR FUTURE GROWTH.
- CONTRACTOR SHALL NOT EXCEED MORE THAN A 50% RACK FILL RATIO ON ANY RACK.
- REFERENCE SPECIFICATIONS FOR MATERIALS AND METHODS
- ALL RACKS, LADDER TRAYS, LIGHTNING PROTECTION ENCLOSURES AND ANY OTHER DEVICES, PART OF THE STRUCTURED CABLING SYSTEM, SHALL BE GROUNDED TO A GROUND BUS BAR LOCATED IN THE TELECOMMUNICATIONS ROOM WITH A #6AWG GROUND CABLE. DAISY CHAINING WILL NOT BE ACCEPTED. ALL ITEMS SHALL HAVE A DEDICATED GROUND CABLE TO BUS BAR.GROUND CABLE SHALL BE GREEN IN COLOR.
- REFER TO ELECTRICAL (E-SERIES) DRAWINGS FOR ADDITIONAL CONDUIT QUANTITIES, SIZES AND LOCATIONS.

A LICENSED FIRE ALARM PLANNING SUPERINDENDENT CERTIFIED TO A MINIMUM LEVEL 3, IN THE SUBFIELD OF FIRE ALARM SYSTEMS THROUGH THE NATIONAL INSTITUTE FOR CERTIFICATION IN ENGINEERING TECHNOLOGIES (NICET), SHALL PROVIDE PLANS AND CALCULATIONS FOR A MANUAL AND AUTOMATIC FIRE DETECTION AND ALARM SYSTEM TO COMPLY WITH THE BUILDING SPACE LAYOUT, BUILDING OCCUPANCY, NFPA 72, LOCAL AND STATE CODE REQUIREMENTS, AND THE FIRE ALARM AND DETECTION SYSTEM SPECIFICATIONS.

PROVIDE RADIO COVERAGE SURVEY AND ENGINEERED EMERGENCY RESPONDER RADIO COVERAGE (EERC) PLANS/SYSTEM AS REQUIRED BY AUTHORITY HAVING JURISDICTION TO MAINTAIN RADIO COVERAGE INSIDE THE BUILDING PER INTERNATIONAL FIRE CODE SECTION-5-10 AND OTHER APPLICABLE LOCAL CODES, THE SYSTEM SHALL BE MONITORED BY FIRE ALARM SYSTEM. CONTRACTOR TO PROVIDE ACEWAYS, CABLING, BRANCH CIRCUITS, DEVICES ... ETC. AND TO MAKE ALL FINAL CONNECTIONS AS REQUIRED.

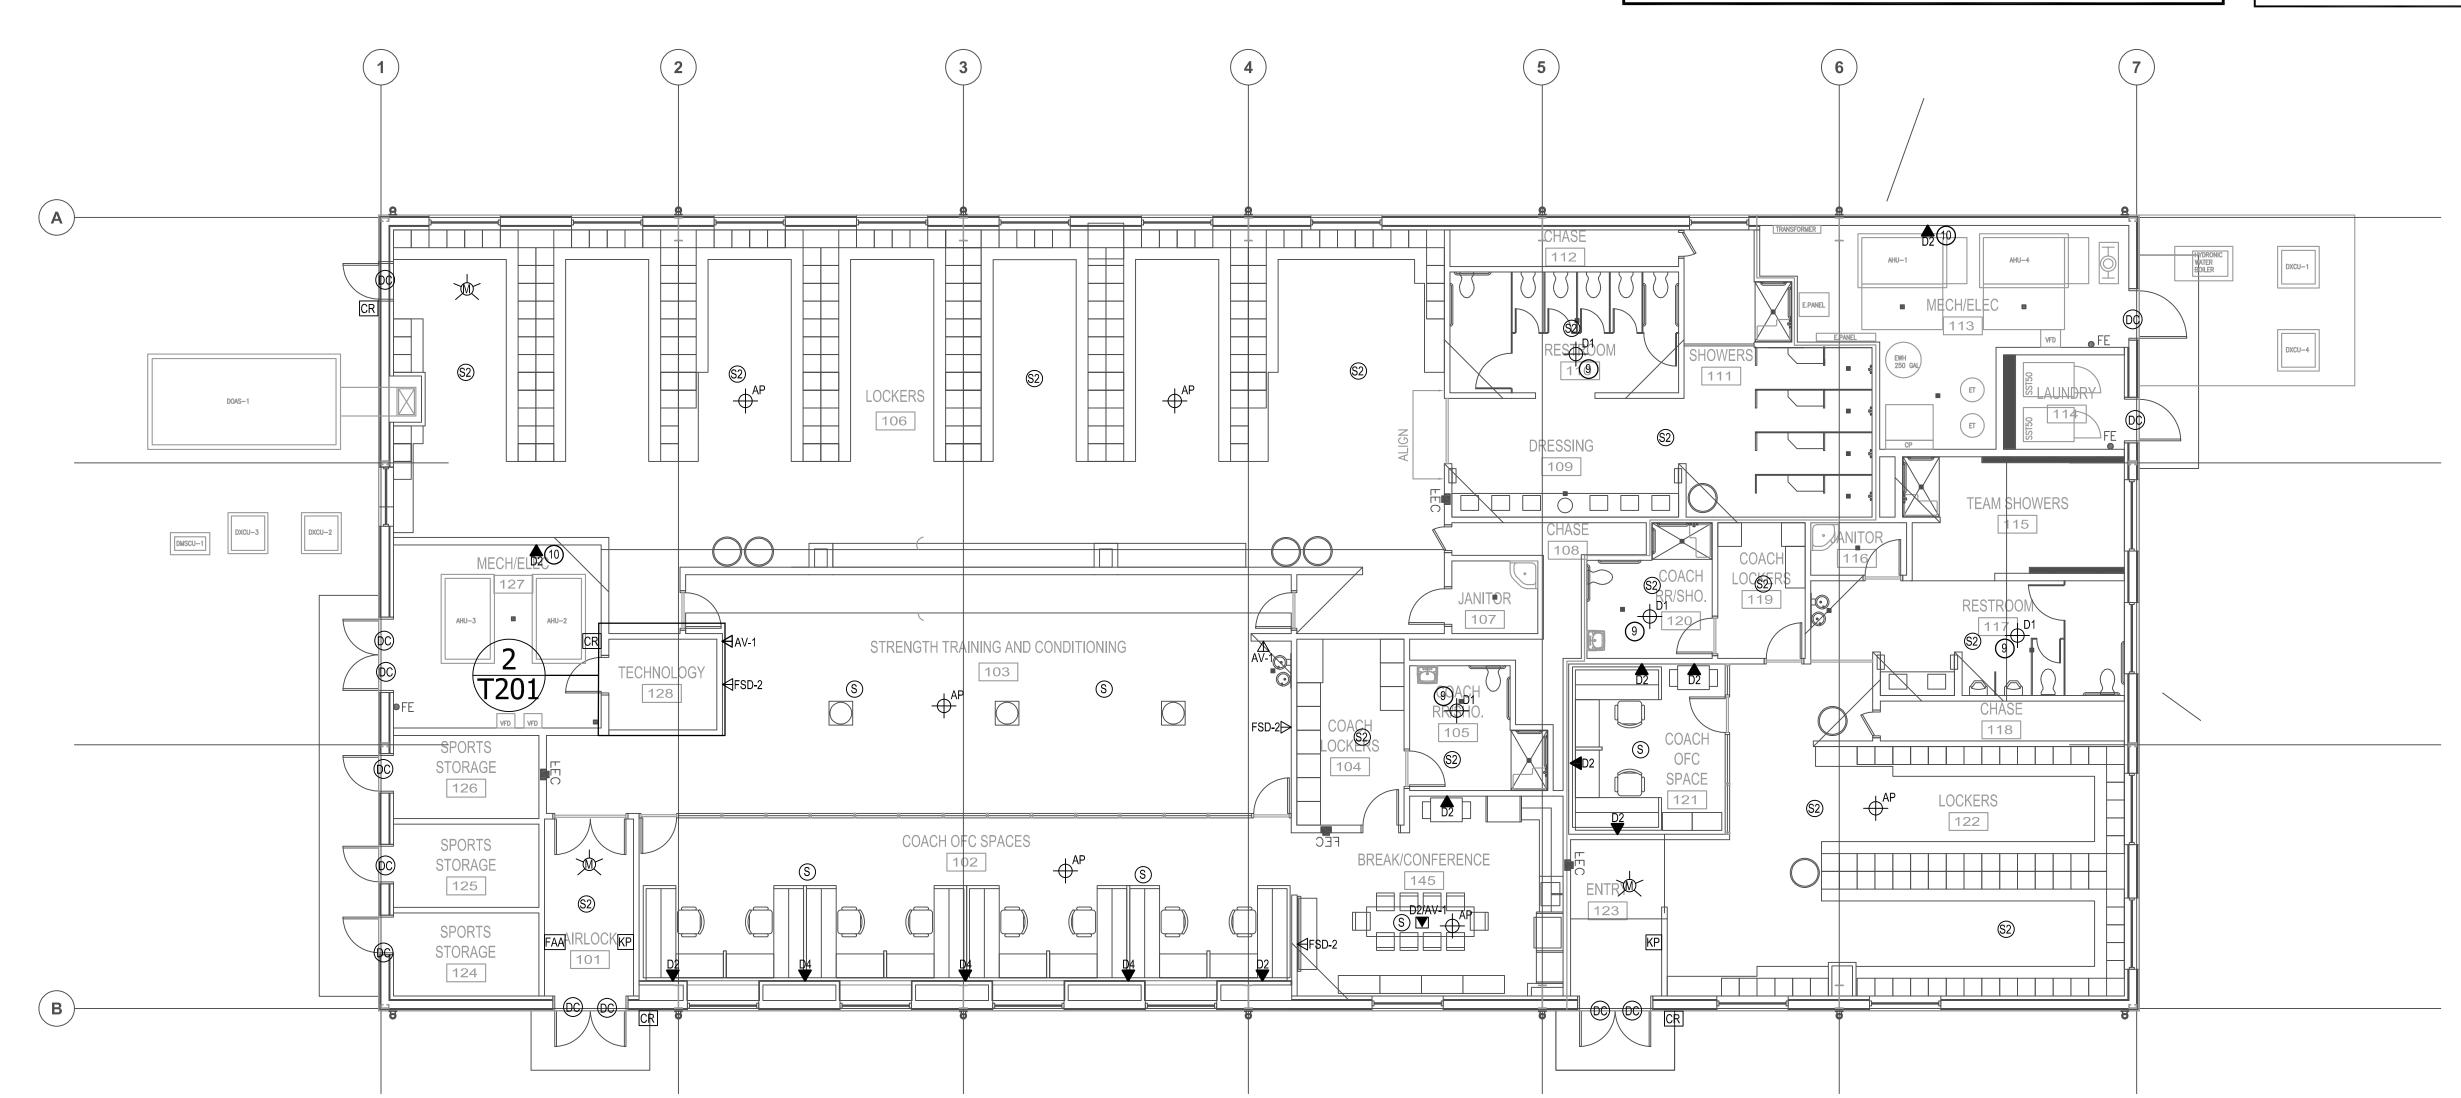

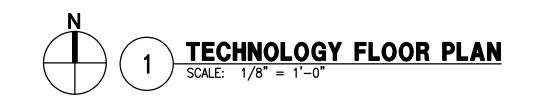

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Project No. 2021-04159-00

21021 PROJECT NUMBER

BRADLEY KALMANS 04-18-2022

HOUSE

FIELD

JXILIARY

WEST BROOK AL

100% REVIEW DATE: 01/12/2022 DESIGN DEVELOPMENT

BIDS & CONSTRUCTION DATE: 04/18/2022

REVISION:

REVISION:

DRAWINGS SHEET TITLE **TECHNOLOGY** FLOOR PLAN