

1 CODE ANALYSIS SHEET
SCALE: 1/8" = 1'-0"

NOTE:
1. SCATTERED OCCUPANCY OVER 12 HOUR PERIOD FOR VARIOUS SPORTS
2. MAXIMUM OCCUPANCY LOAD WILL BE IDENTIFIED WITH SIGNAGE

Code Analysis
Applicable Codes:
2015 IBC
2015 International Energy Conservation Code
2015 International Plumbing Code
2015 International Mechanical Code
2015 International Fire Code
2014 National Electric Code

Area Tabulation:
Total Ground Floor Area 9,850 sf
Girls Field House 7,356 sf
Boys Field House 2,579 sf

Chapter 3 - Use and Occupancy
Group A3 Assembly
Chapter 5 - General Building and Height and Area
Type IIIB-Non-Sprinklered

Allowable Building Height: 85 ft
Allowable Number of Stories Above Grade Plane: 3
Allowable Area Factor: A-3/ NS/ 9,500 sf
• NS = Buildings not equipped throughout with an automatic sprinkler system.

Area Increase due to frontage (506.3)
 $W = (L1 \times W1 + L2 \times W2 + L3 \times W3 + L4 \times W4) / F$
L1=67 W1=30
L2=148 W2=30
L3=67 W3=30
L4=148 W4=0 (Tennis courts)
 $W = (67 \times 30 + 148 \times 30 + 67 \times 30 + 148 \times 0) / 282$
 $W = (2,010 + 4,440 + 2,010 + 0) / 282$
 $W = 3,460 / 282$
W=30

Amount of Increase (506.3.3)
 $I_f = [F/P - 0.25] / W/30$
F=282
P=430
 $I_f = [282/430 - 0.25] / 30/30$
 $I_f = 0.66 - 0.25$
 $I_f = 0.41$

Type IIIB (506.2.3 Allowable Area - Equation 5-2)
 $A_a = (A + (NS \times I_f)) \times S_a$
 $A_a = (9,500 + (9,500 \times 0.41)) \times 1$
 $A_a = (9,500 + 3,895) \times 1$
 $A_a = 13,395 \times 1$
 $A_a = 13,395 \text{ sf Max Allowable Area}$

Type IIIB
Exterior - Unprotected Non Combustible, Interior - Any material permitted by this code

Chapter 6 - Table 601 Fire Resistance Rating Requirements for Building Elements (Hours)

| Primary Structural Frame (See Section 202) | Type IIIB |
|--|---------------|
| Bearing Walls | 0 |
| Exterior | 2 |
| Interior | 0 |
| Non Bearing Walls and Partitions | 0 |
| Exterior | See Table 602 |

Non Bearing Walls and Partitions Interior 0
Floor Construction and Associated Members (see Section 202) 0
Roof Construction and Associated Members (see Section 202) 0

Fire Extinguisher for Class A Fire Hazards (Table 906.3(1))
Ordinary (Moderate) Hazard Occupancy
Minimum rated single extinguisher: 2-A
Maximum floor area per unit of A: 1,500 sf
Maximum floor area for extinguisher: 11,250 sf
Maximum distance of travel to extinguisher: 75 ft

Occupant Load
Maximum Floor Area per Occupant Table 1004.1.2
Accessory Storage Areas, mech. equip. room 300 gross
Assembly Areas without fixed seats
Concentrated (chairs only-not fixed) 7 net
Exercise Rooms 50 gross
Locker Rooms 50 gross

1004.3 Posting of occupant load. Every room or space that is an assembly occupancy shall have the occupant load of the room or space posted in a conspicuous place, near the main exit or exit access doorway from the room or space. Posted signs shall be of an approved legible permanent design and shall be maintained by the owner or the owner's authorized agent.

Section 1005 - Means of Egress Signage

1005.3.2 Other egress components. The capacity, in inches, of means of egress components other than stairways shall be calculated by multiplying the occupant load served by such component by a means of egress capacity factor of 0.2 inch per occupant.

Min. Number of Exits or Access to Exits per Story (Table 1006.3.1)
Occupant load per story Min. no. of exits/access to exits from story
1-500 2
501-1,000 3
More than 1,000 4

1007.1.1 Two exits or exit access doorways. Where two exits, exit access doorways, exit access stairways or ramps, or any combination thereof, are required from any portion of the exit access, they shall be placed a distance apart equal to not less than one-half of the length of the maximum overall diagonal dimension of the building or area to be served measured in a straight line between them. Interlocking or scissor stairways shall count as one exit stairway.

1010.1.2.1 Direction of swing. Pivot or side-hinged swinging doors shall swing in the direction of egress travel where serving a room or area containing an occupant load of 50 or more persons or a Group H occupancy.

1010.1.10 Panic and fire exit hardware. Doors serving a Group H occupancy and doors exiting rooms or spaces with an occupant load of 50 or more in a Group A or E occupancy shall not be provided with a latch or lock other than panic hardware or fire exit hardware.

Exceptions:
1. A main exit of a Group A occupancy shall be permitted to be locking in accordance with Section 1010.1.9.3, Item 2.
2. Doors serving a Group A or E occupancy shall be permitted to be electromagnetically locked in accordance with Section 1010.1.9.9.

1020.4 Dead ends. Where more than one exit or exit access doorway is required, the exit access shall be arranged such that there are no dead ends in corridors more than 20 feet in length.

1029.7 Travel distance
Exits and aisles travel distance to an exit door.
Non sprinklered Buildings - 200 ft max
Sprinklered Buildings - 250 ft max

2015 INTERNATIONAL ENERGY CONSERVATION CODE COMPLIANCE SUMMARY

CLIMATE ZONE: 2A Jefferson County (Warm-Humid) PRESCRIPTIVE METHOD: C402 - C406

INSULATION MATERIAL AND R-VALUES

ROOFS

INSULATION ENTIRELY ABOVE ROOF DECK: [NA, R25 c]

METAL BUILDINGS: [NA, R-19 + R-11 LS]

ATTIC AND OTHER: [NA, R-38]

WALLS, ABOVE GRADE

MASS: [NA, R-5.7c]

METAL BUILDING: [NA, R13 + R-6.5c]

METAL FRAMED: [NA, R-13 + R-5c]

WOOD FRAMED: [NA, R-13 + R-3.8c, R-20]

WALLS, BELOW GRADE

NO REQUIREMENT

FLOORS

MASS: [NA, R-6.3c]

JOIST FRAMING: [NA, R-39]

SLAB-ON-GRADE FLOORS

UNHEATED SLABS: NO REQUIREMENT

HEATED SLABS: [NA, R-7.5 FOR 12" BELOW]

OPAQUE DOORS: [NA, R-4.75]

FENESTRATION

VERTICAL

FIXED FENESTRATION: U-FACTOR 0.50 MIN, 0.27 ACTUAL
 OPERABLE FENESTRATION: U-FACTOR 0.65 MIN, 0.33 ACTUAL
 ENTRANCE DOORS: U-FACTOR 0.83 MIN, 0.33 ACTUAL

PF = [0.14]

MINIMUM REQUIREMENTS

| SHGC | SEW | N |
|----------------|------------|------------|
| PF < 0.2 | [0.25, NA] | [0.33, NA] |
| 0.2 ≤ PF < 0.5 | [0.30, NA] | [0.37, NA] |
| PF ≥ 0.5 | [0.40, NA] | [0.40, NA] |

SHGC ACTUAL: 0.25

SKYLIGHTS

U-FACTOR [NA, 0.65 MIN, 0.33 ACTUAL]

SHGC [NA, 0.35 MIN, 0.33 ACTUAL]

ROOF SOLAR REFLECTANCE AND THERMAL EMITTANCE (3-YEAR), OR SOLAR REFLECTANCE INDEX (3-YEAR) FOR LOW SLOPE ROOFS C402.3
 R aged = 0.33 (3-year aged solar reflectance min. 0.55, and 3-year aged thermal emittance min. of 0.75)

CALCULATED % OF WINDOWS IN EACH EXTERIOR WALL C402.4

Max. allowable % window openings in exterior walls - 30% C402.4.1

[Not more than 40% of the gross above-grade wall area shall be permitted to be vertical fenestration, provided all of the following requirements are met]

- Building not greater than 2 story above grade, not less than 50% of the net floor area is within a daylight zone. [NA] [Complies] [Not Compliant]
- Building not greater than 3 or more stories above grade, not less than 50% of the net floor area is within a daylight zone. [NA] [Complies] [Not Compliant]
- Daylight responsive controls complying with C405.2.3.1 are installed in daylight zones. [NA] [Complies] [Not Compliant]
- Visible Transmittance (VT) of vertical fenestration is not less than 1.1 times solar heat gain coefficient (SHGC). [NA] [Complies] [Not Compliant]

Maximum allowable area of skylight area - 3% of gross roof area

ACTUAL FENESTRATION CALCULATIONS:

| | | |
|----------------|-----|---------------|
| NORTH WALL(S): | 4% | <30% COMPLIES |
| SOUTH WALL(S): | 9% | <30% COMPLIES |
| EAST WALL(S): | 14% | <30% COMPLIES |
| WEST WALL(S): | 10% | <30% COMPLIES |
| ROOF SKYLIGHT | 0% | <03% COMPLIES |

MINIMUM SKYLIGHT FENESTRATION AREA C402.4.2

Enclosed space greater than 2,500 SF floor area directly under roof?

YES X NO
 Skylight Not Required

75% of ceiling area with ceiling height greater than 15 feet

YES X NO
 Skylight Not Required

Uses as an office, lobby, atrium, concourse, corridor, storage space, gymnasium/exercise center, convention center, automotive service area, manufacturing space, nonrefrigerated warehouse, retail store, distribution/sorting area, transportation depot or workshop

YES X NO
 Skylight Not Required

TOTAL DAYLIGHT ZONE UNDER SKYLIGHTS SHALL BE OF NOT LESS THAN 3% WHERE SKYLIGHTS HAVE A VT OF AT LEAST 0.40

OR

= MINIMUM SKYLIGHT EFFECTIVE APERTURE OF AT LEAST 1%,
 = 0.85 x Skylight Area x Skylight VT x WF
 Daylight Zone Under Skylight

WF (well factor)


= 0.9 if light well depth < 2 ft

= 0.7 if light well depth ≥ 2 ft

AIR LEAKAGE - THERMAL ENVELOPE (Mandatory) C402.5

Air Leakage requirements will be met by: Materials, Assemblies Testing during construction

DIAGRAM ILLUSTRATING AIR BARRIER

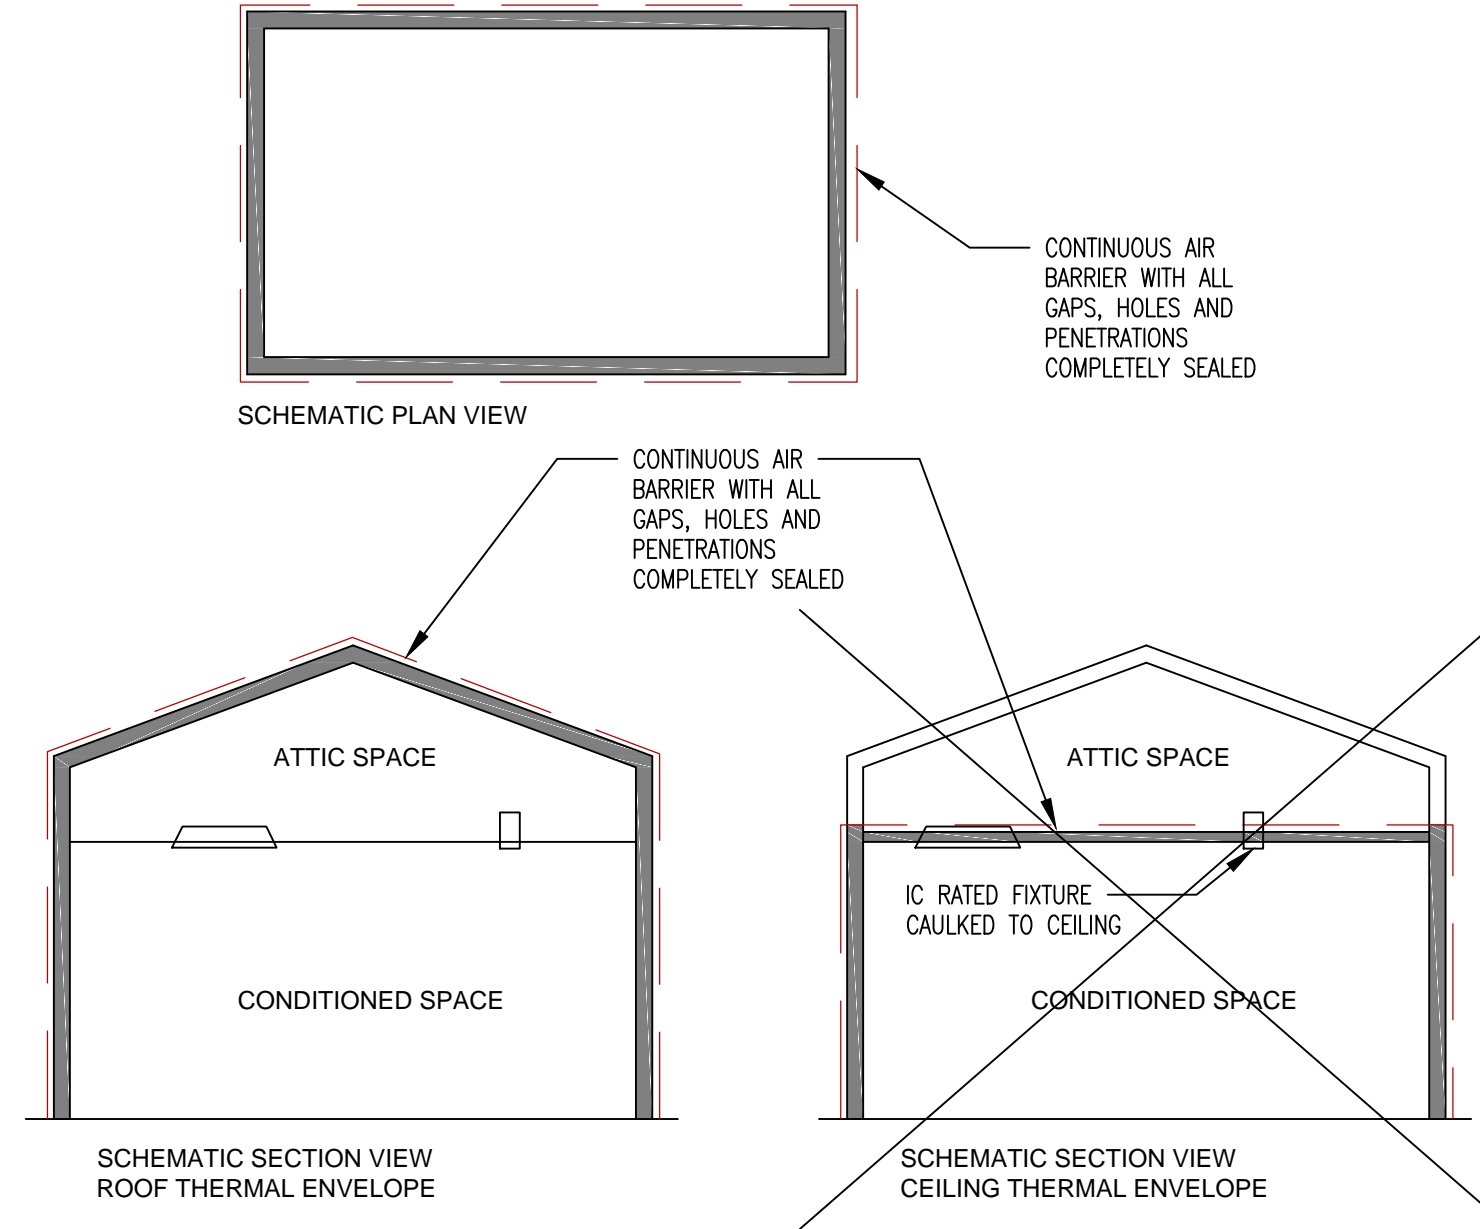

C402.5 Air Leakage - thermal envelope (Mandatory)

- Continuous air barrier shall be provided throughout the building envelope. Permitted to be located on inside or outside of building envelope, located within the assemblies composing the envelope, or combination thereof.
- Air Barrier Construction shall comply with following:
 - Continuous for entire thermal envelope and across joints
 - Seams shall be sealed
 - Penetrations shall be caulked or gasketed
 - Recessed lighting shall be
 - IC Rated
 - Labeled having air leakage rate of less than 2.0 cfm
 - Sealed with gasket or caulk between housing and interior wall or ceiling covering.

Acceptable Air Barriers Materials (with joints sealed)

- Min 3/8" thick plywood
- Min 3/8" oriented stranded board (OSB)
- Min 3/8" extruded polystyrene insulation board
- Min 3/8" foil-back polyisocyanurate insulation board
- Min 1 1/2" closed-cell spray foam min density 1.5 pcf
- Min 4 1/2" open-cell spray foam density between 0.4 and 4.5 pcf
- Min 1/2" interior or exterior gypsum board
- Min 1/2" cement board
- Bulk-up roofing membrane
- Modified bituminous roof membrane
- Fully adhered single-ply roof membrane
- Min 5/8" portland cement / sand parg or gypsum plaster
- Cast-in-place precast concrete
- Fully grouted concrete block masonry
- Sheet steel or aluminum
- Solid or hollow masonry constructed of clay or shale masonry units

Acceptable Air Barriers Assemblies

- Concrete masonry walls coated with
 - 1 application block filler, or
 - 2 applications of a paint or sealer coating
- Masonry walls constructed of clay or shale masonry, min 4 inches width
- Portland cement stucco or plaster min 1/2" thick

| FENESTRATION ASSEMBLY | MAXIMUM RATE (CFM / FT ²) | TEST PROCEDURE |
|--|---------------------------------------|---|
| Windows | 0.20 | AAMA/WDMA/CSA101/ I.S.2/A440 |
| Sliding Doors | 0.20 | |
| Swinging Doors | 0.20 | |
| Skylights - with condensation weepage openings | 0.30 | NFR 400 |
| Skylights - All others | 0.20 | |
| Curtain Walls | 0.06 | NFR 400 or ASTM E 283 at 1.57 psf (75 Pa) |
| Storefront Glazing | 0.06 | |
| Commercial glazed swinging entrance doors | 1.00 | |
| Revolving Doors | 1.00 | ANSI/DASMA 105, NFR 400, or ASTM E283 at 1.57 psf (75 Pa) |
| Garage Doors | 0.40 | |
| Rolling Doors | 1.00 | |
| High-speed doors | 1.30 | |



C402.5.7 VESTIBULES

Exception 1. Not required in climate zones 1 & 2.

C403 MECHANICAL SYSTEMS

C404 SERVICE WATER HEATING (MANDATORY)

C404 ELECTRICAL POWER AND LIGHTING SYSTEMS

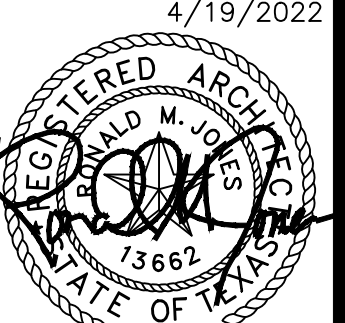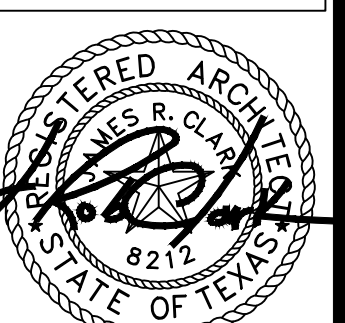

WEST BROOK AUXILIARY FIELD HOUSE


Beaumont Independent School District

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| DESIGN DEVELOPMENT | <input type="checkbox"/> |
| DATE: ---- | |
| BIDS & CONSTRUCTION | <input checked="" type="checkbox"/> |
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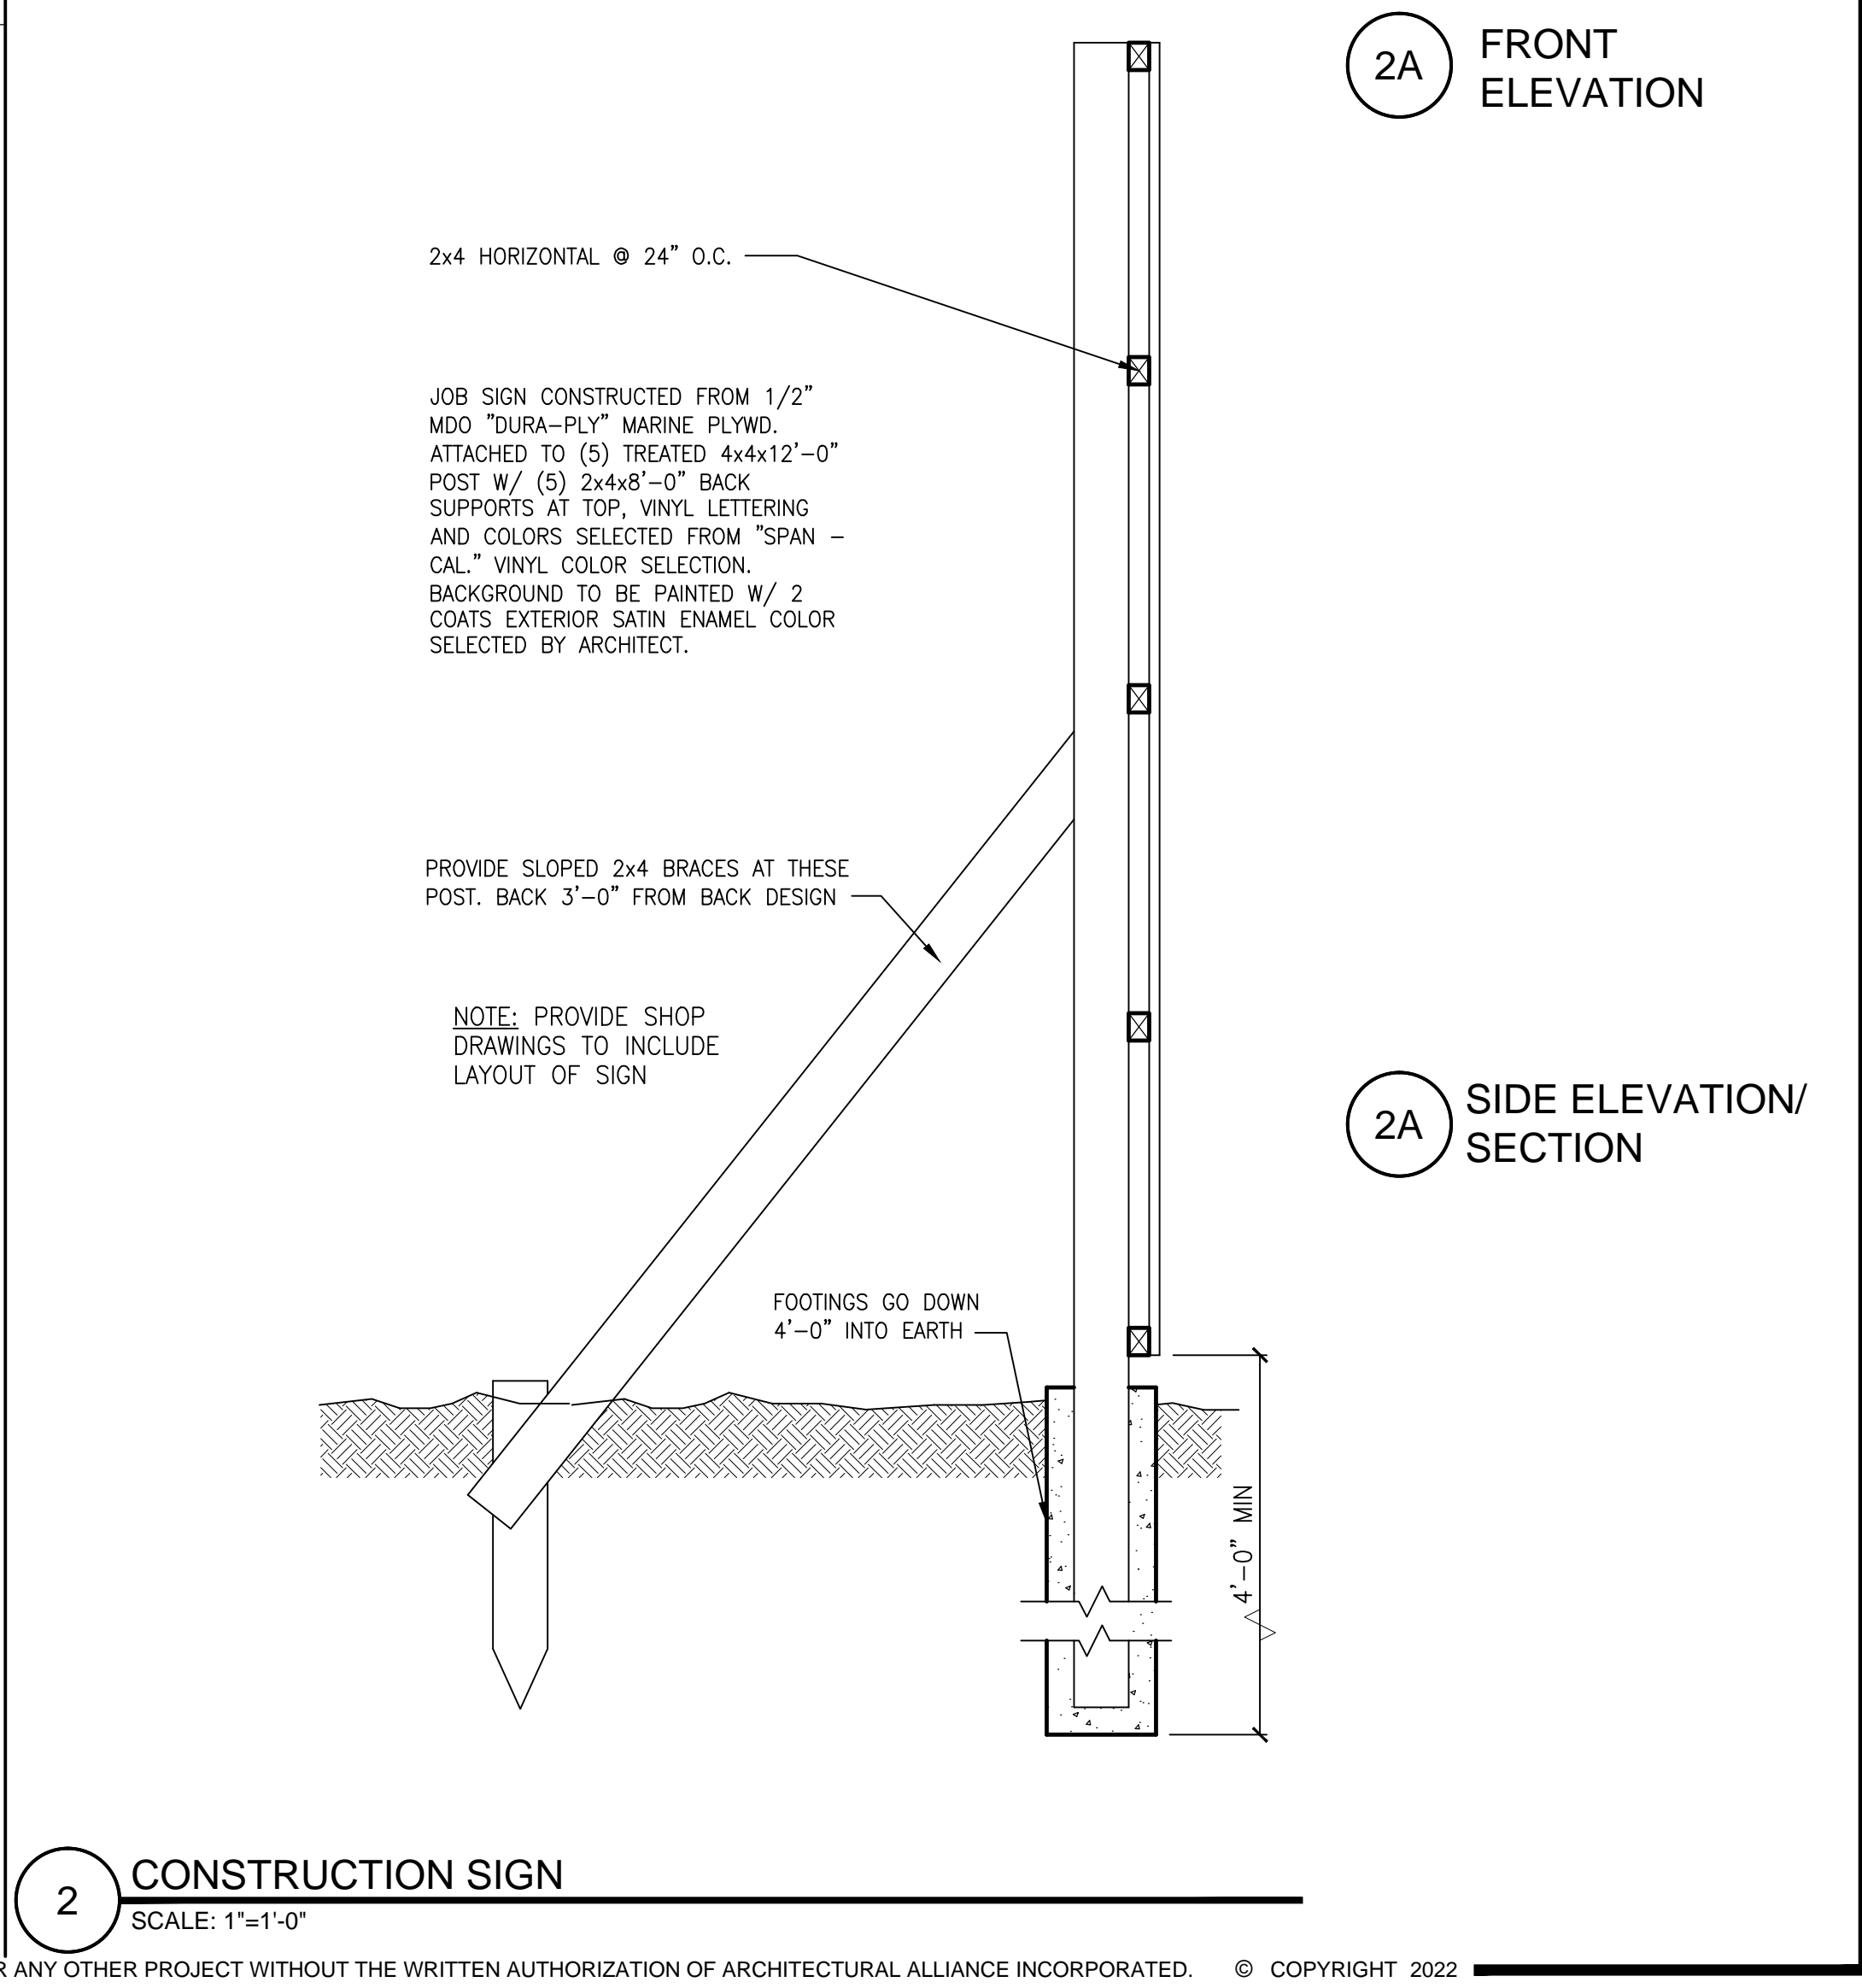
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ENERGY CODE COMPLIANCE

SHEET NUMBER
EC100
 PROJECT NUMBER
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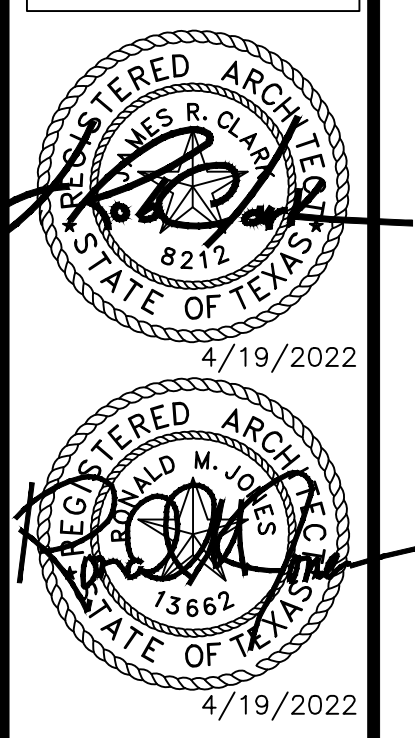
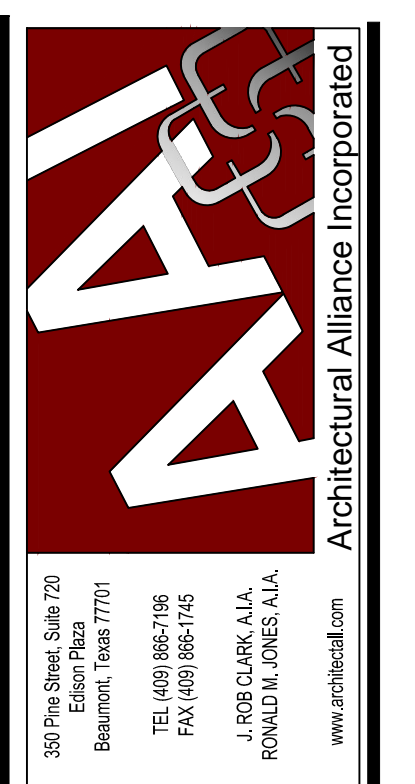
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1 SITE PLAN
SCALE: 1"=20'-0"



2 CONSTRUCTION SIGN
SCALE: 1"=1'-0"

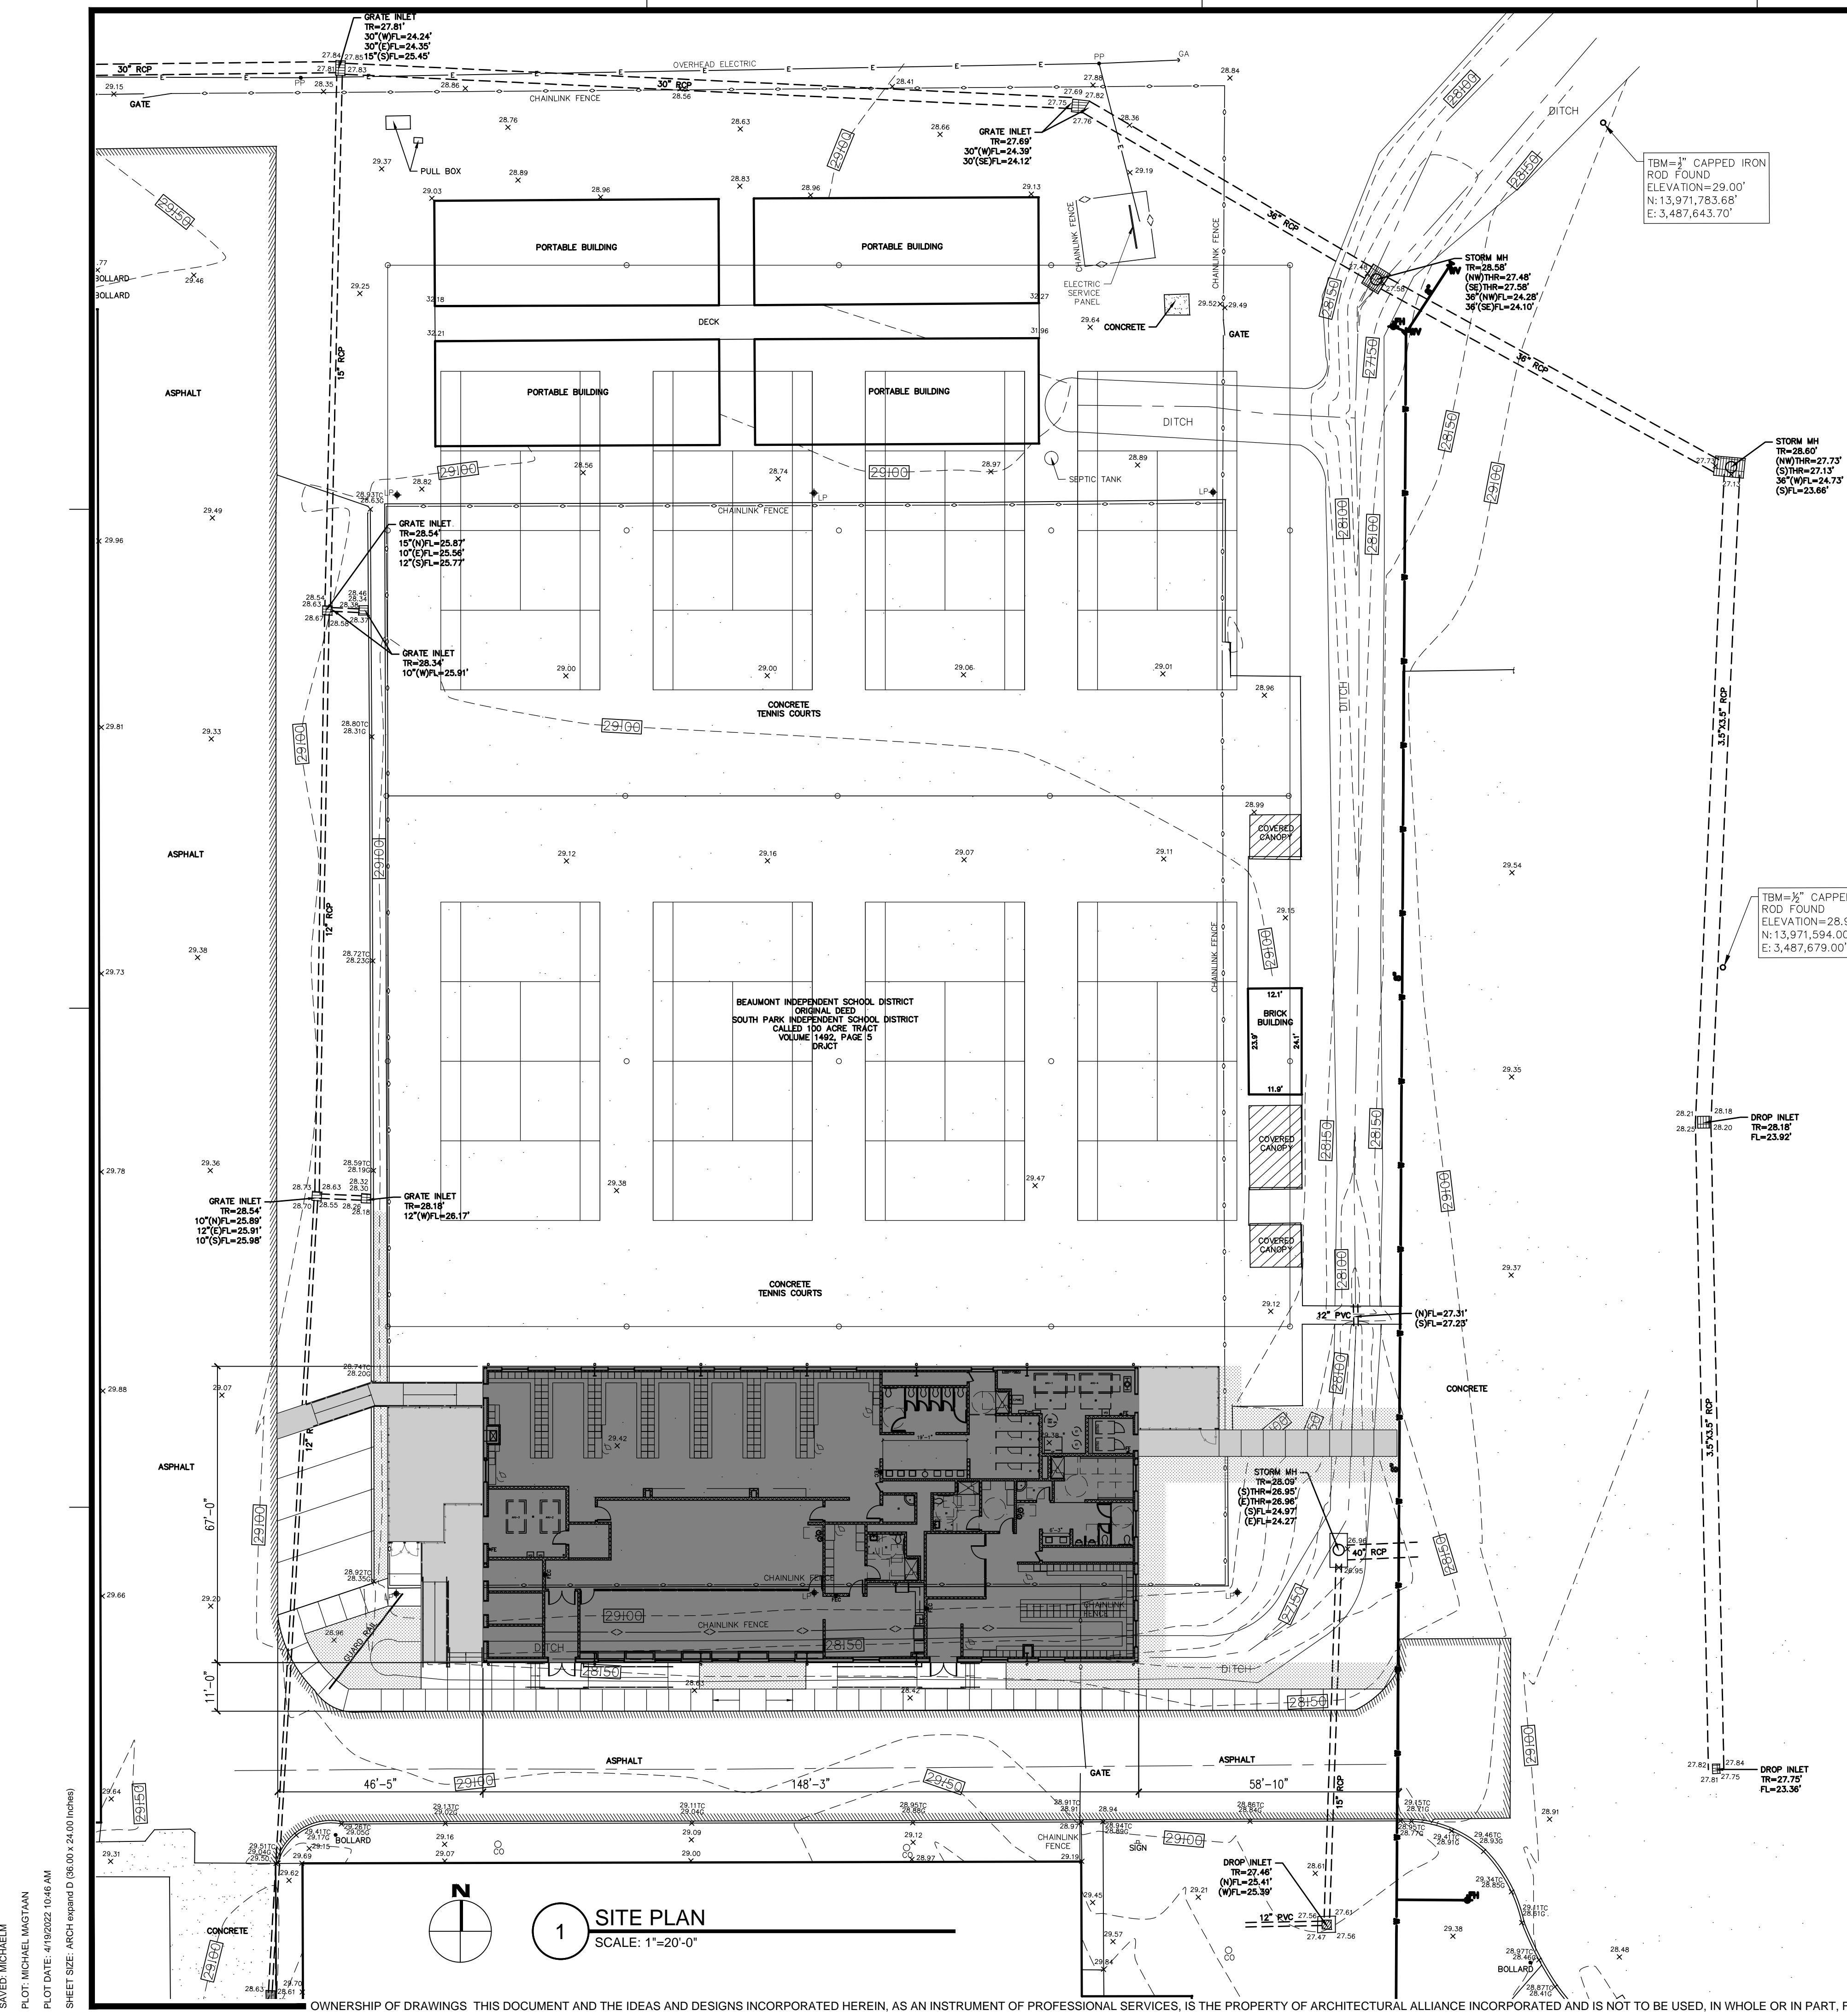


WEST BROOK AUXILIARY FIELD HOUSE
Beaumont Independent School District
Beaumont, TX 77706

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| DATE: | ---- |
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| REVISION: | DATE: _____ |

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| PROJECT NUMBER | 21021 |

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NEW CONSTRUCTION NOTES

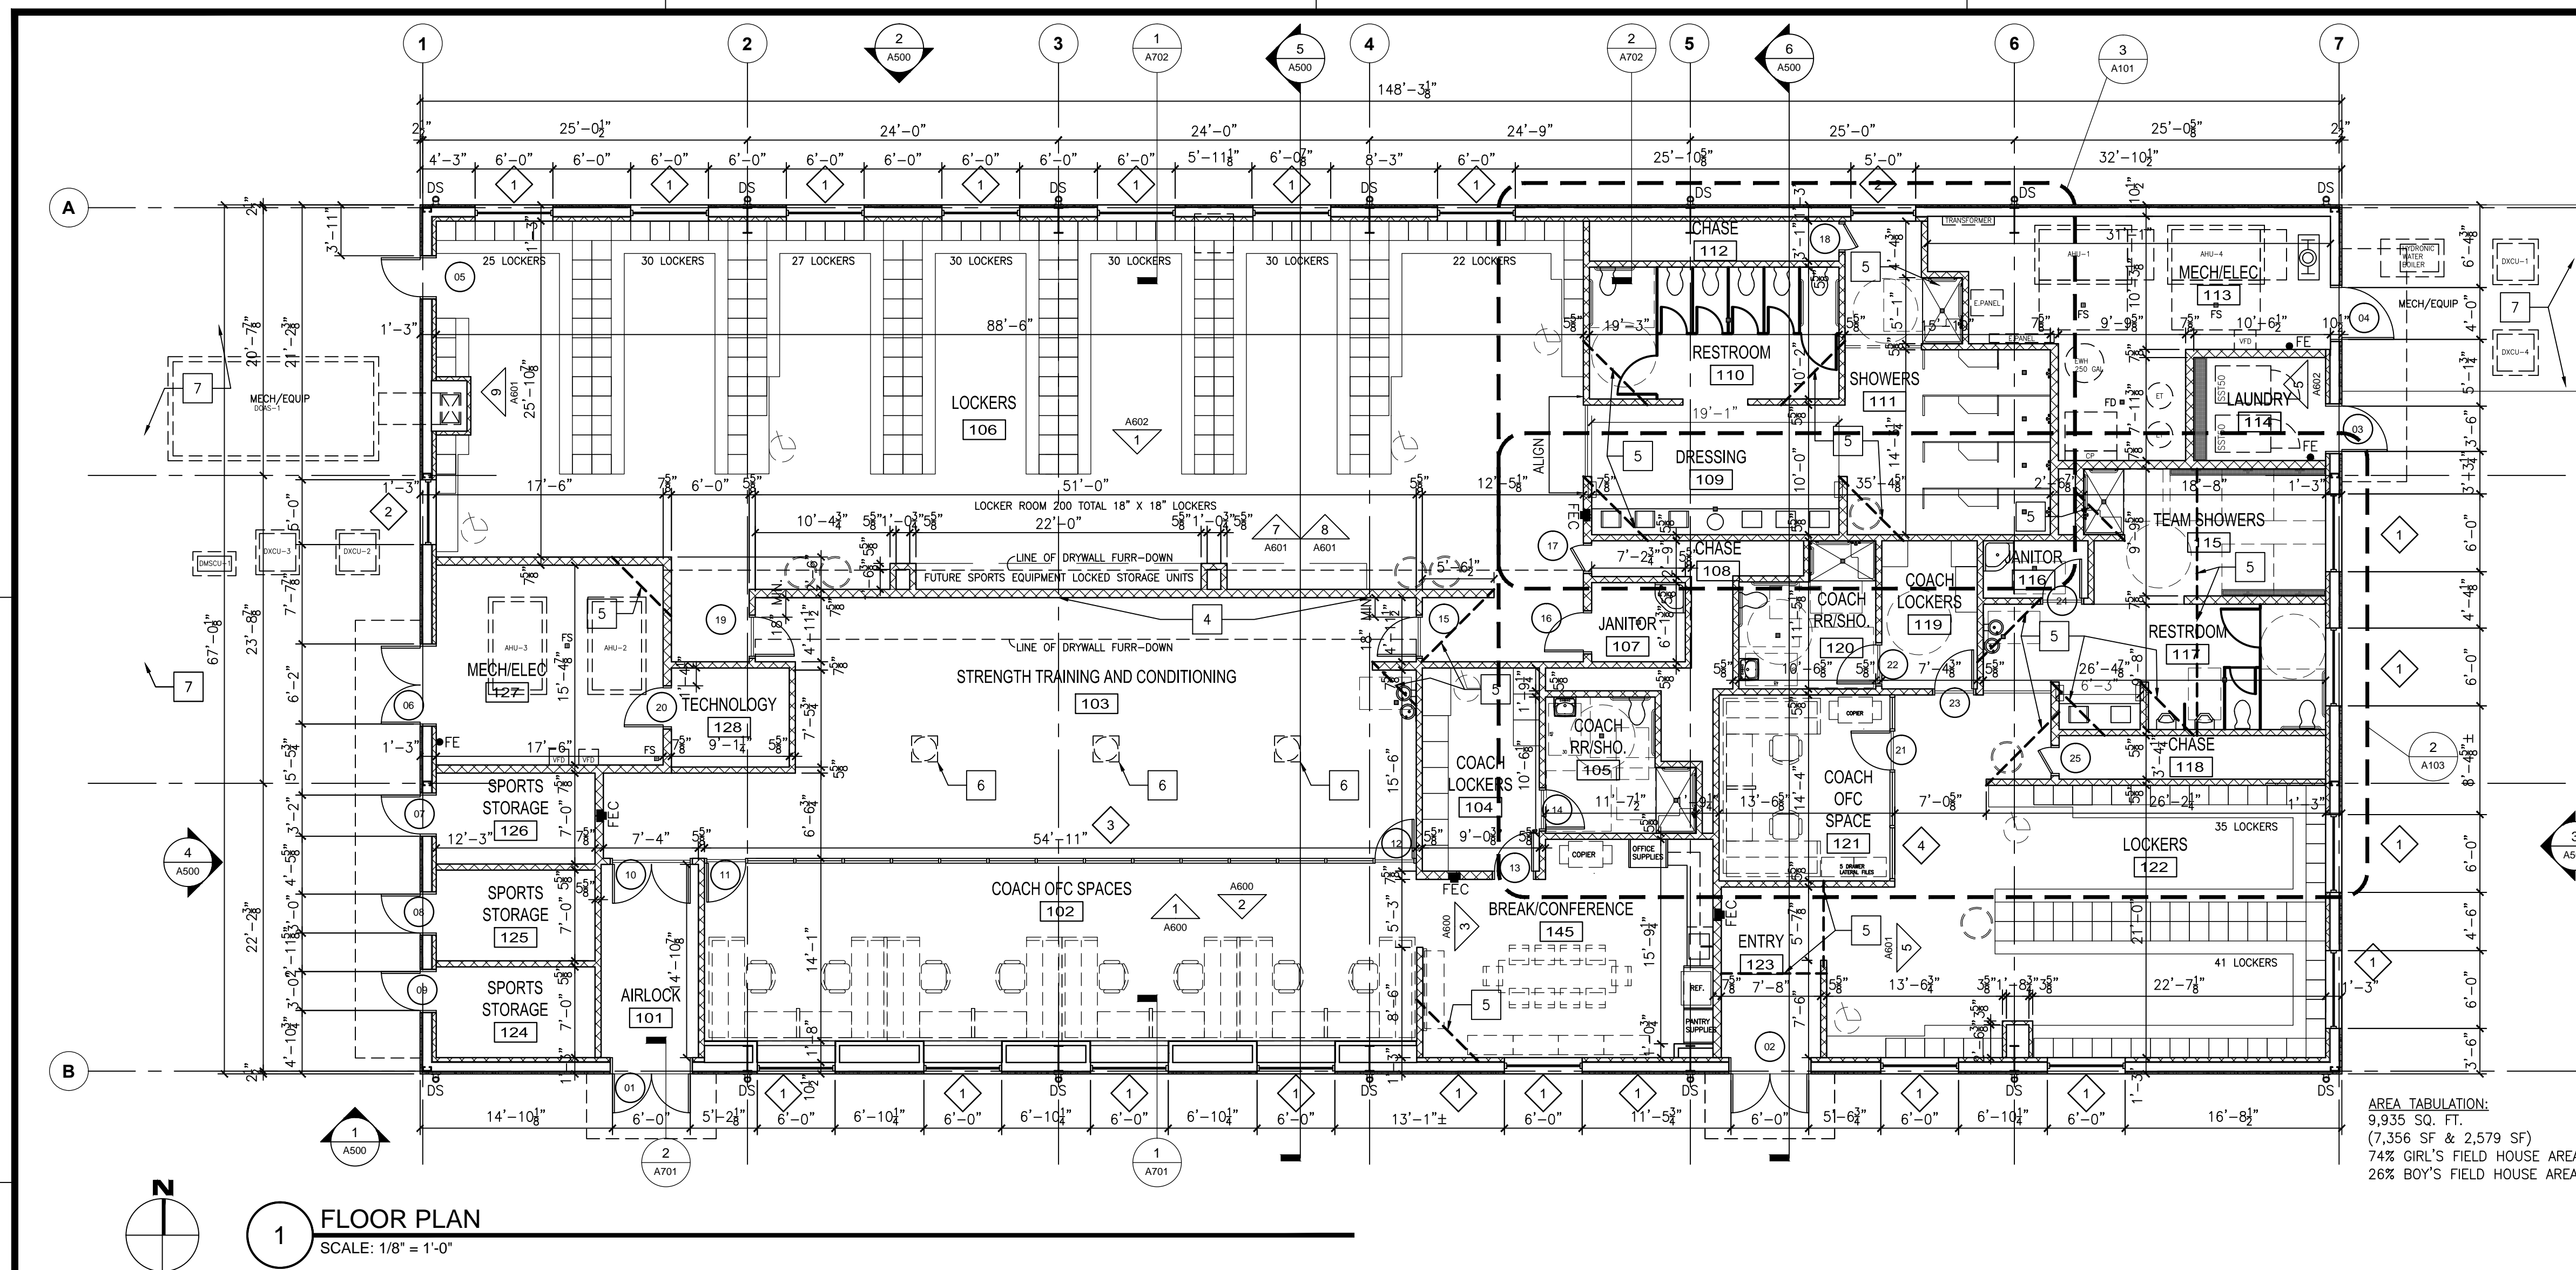- 1-HR. RATED ENCLOSURE AT LAUNDRY
- MAXIMUM OCCUPANT LOAD SIGN AT ASSEMBLY OCCUPANCY, REF. SIGNAGE PLAN
- ALTERNATE #1: CERAMIC TILE WALL FINISH AT RESTROOMS
- BRACE TO FRAME ABOVE
- 3X3X1/2" STEEL ANGLE WALL BRACE, TYPICAL, REF. STRUCT.
- OPTIONAL 22" DIAMETER SOLATUBE DAYLIGHTING SYSTEM WITH PREMANUFACTURED ROOF CURB BY ROOFER
- 7'-6" HIGH GALV. CHAINLINK FENCE WITH 3" DIA. SCHED. 40 POSTS SPACED @ 6'-0" O.C., 2-3/8" SCHED. 40 TOP AND BOTTOM SUPPORT RAILS AND 2" MESH WITH TWIST KNUCKLE CONFIG.; AROUND MECHANICAL ENCLOSURE. PROVIDE 6'-0" WIDE PAIR GATES AT WEST ENCLOSURE AND SINGLE 4'-0" WIDE GATE AT EAST ENCLOSURE WITH LOCKING HARDWARE(S).

TOILET ACCESSORY SCHEDULE

MODEL NUMBERS TAKEN FROM BOBRICK CATALOG



| ITEM | MODEL NUMBER | DESCRIPTION |
|-------|--|--|
| TS 3 | XLERATOR HAND DRYER WITH S.S. RECESS WALL BOX (ADA COMPLIANT) | RECESS MOUNTED MOUNTED HAND DRYER WITH STAINLESS STEEL RECESS KIT |
| TS 4 | OWNER FURNISHED, OWNER INSTALLED SURFACE MOUNTED TOILET TISSUE DISPENSER | OWNER FURNISHED, OWNER INSTALLED SURFACE MOUNTED TOILET TISSUE DISPENSER. PROVIDE BLOCKING IN WALL. |
| TS 11 | B-2116 CLOTHES HOOK | SURFACE MOUNTED HEAVY DUTY CLOTHES HOOK ONE PIECE ASSEMBLY HOOK AND FLANGE BRASS CASTING WITH SATIN NICKEL PLATED FINISH TO MATCH SATIN STAINLESS STEEL FINISH |
| TS 12 | B-223x24 24" MOP/BROOM HOLDER | SURFACE MOUNTED 24" LONG MOP AND BROOM HOLDER |
| TS 17 | B-5181 ADA SURFACE MOUNTED FOLD DOWN PHENOLIC SHOWER SEAT | SURFACE MOUNTED REVERSIBLE PHENOLIC FOLD DOWN. CONTRACTOR SHALL VERIFY HAND OF UNIT AND PROVIDE STRUCTURALLY SOUND BLOCKING ON CMU WALLS |
| TS 21 | OWNER FURNISHED, OWNER INSTALLED SURFACE MOUNTED SOAP DISPENSER | OWNER FURNISHED, OWNER INSTALLED SURFACE MOUNTED SOAP DISPENSER. PROVIDE BLOCKING IN WALL. |
| TS 22 | B-165 2448 24"x48" MIRROR AND WELDED STAINLESS STEEL FRAME | 1/4" THK. x 24" x 48" TEMPERED GLASS MIRROR IN SATIN FINISH STAINLESS STEEL ONE PIECE CHANNEL FRAME MOUNTED WITH TAMPER PROOF HANGERS |
| TS 25 | B-6806 x 36 B-6806 x 42 B-6806 | STANDARD ACCESS TOILET STALL SATIN FINISH STAINLESS STEEL GRAB BARS 36" AND 42" IN 1 1/2" DIAMETER CONCEALED MOUNTING |
| TS 31 | B-6806 x 48 | SATIN FINISH STAINLESS STEEL GRAB BAR 48" LONG IN 1 1/2" DIAMETER CONCEALED MOUNTING |
| TS 32 | B-6806 x 24 | SATIN FINISH STAINLESS STEEL GRAB BAR 24" LONG IN 1 1/2" DIAMETER CONCEALED MOUNTING |
| TS50 | BOBRICK 6047 X36 EXTRA-HEAVY DUTY SHOWER CURTAIN RODS | TYPE 304 STAINLESS STEEL, SATIN FINISH. 18-GAUGE 1 1/2" DIAMETER ROD. 2 1/2" SQUARE FLANGES |
| | BOBRICK 204-1 S.S. SHOWER CURTAIN HOOKS | STAINLESS STEEL, SHOWER HOOKS SNAPS OPEN |
| | BOBRICK 204-3 70 X 72 SHOWER CURTAIN | SHOWER CURTAIN OPAQUE, MATTE, WHITE VINYL, ANTI-BACTERIAL, FIRE-RETARDANT, NICKEL PLATED BRASS GROMMETS, |

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REGISTERED ARCHITECT
STATE OF TEXAS
8217
4/19/2022

REGISTERED ARCHITECT
STATE OF TEXAS
13667
4/19/2022

WEST BROOK AUXILIARY FIELD HOUSE
Beaumont Independent School District
8750 Phelan Blvd
Beaumont, TX 77706

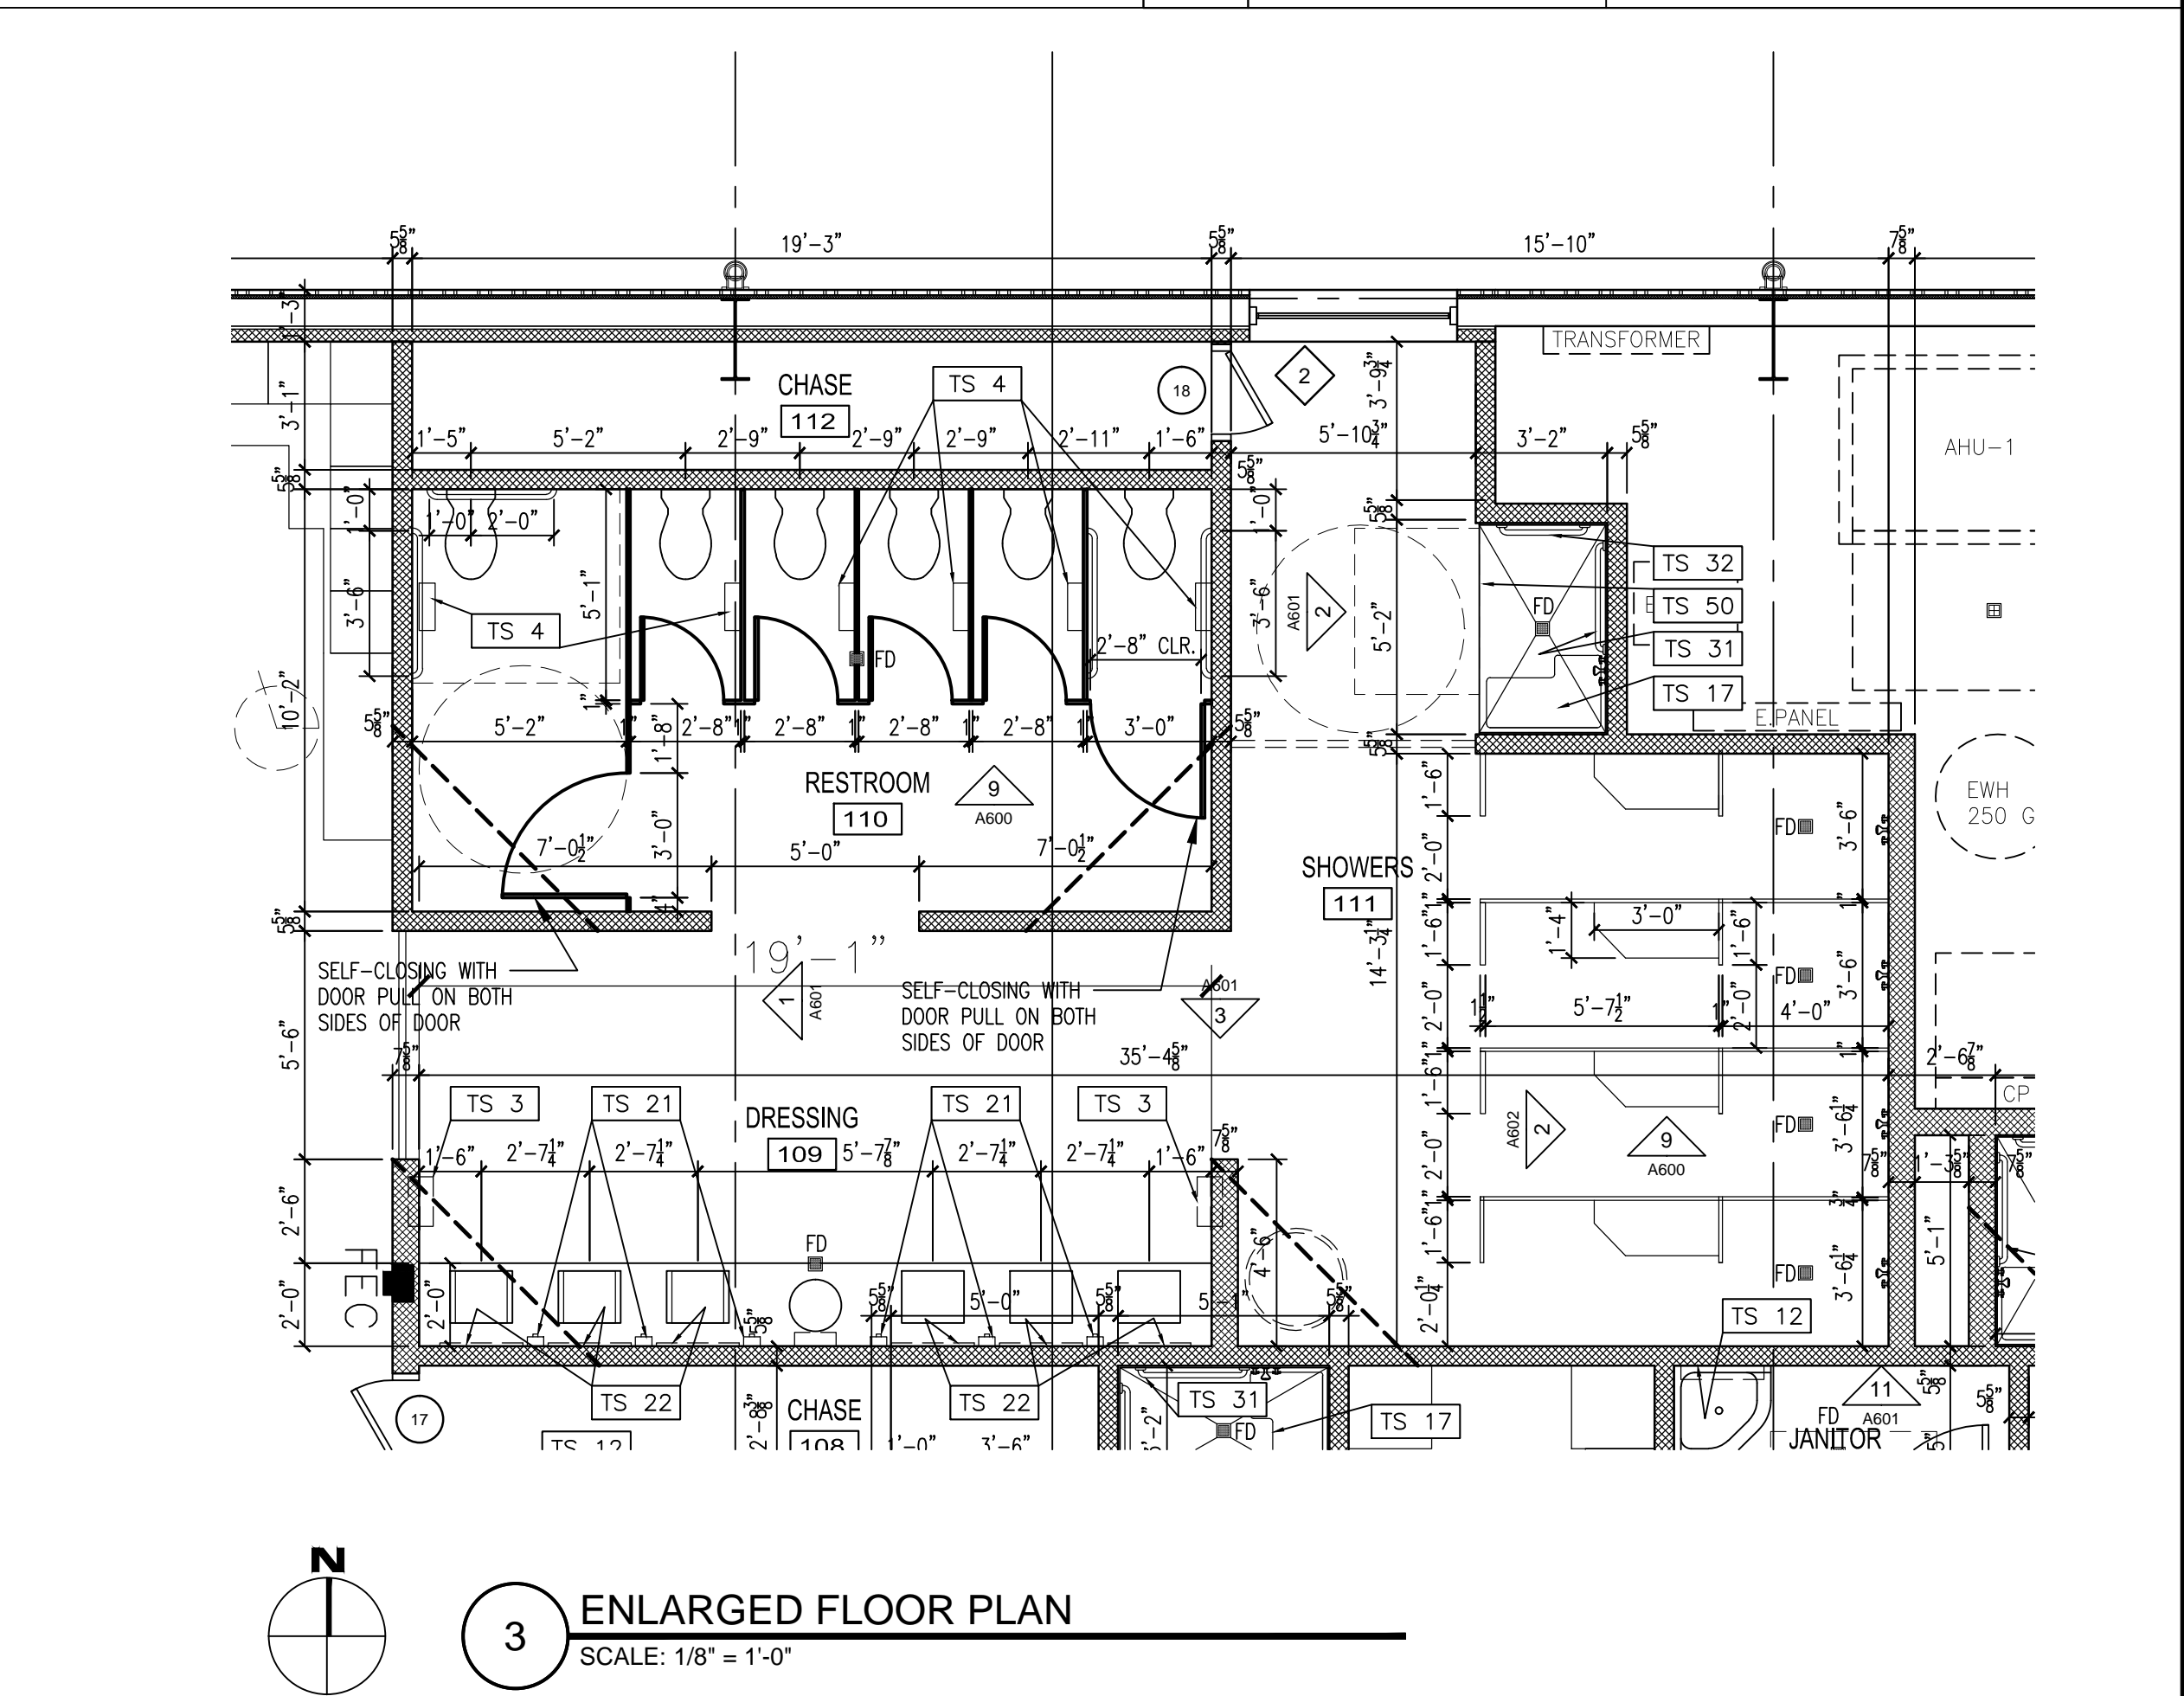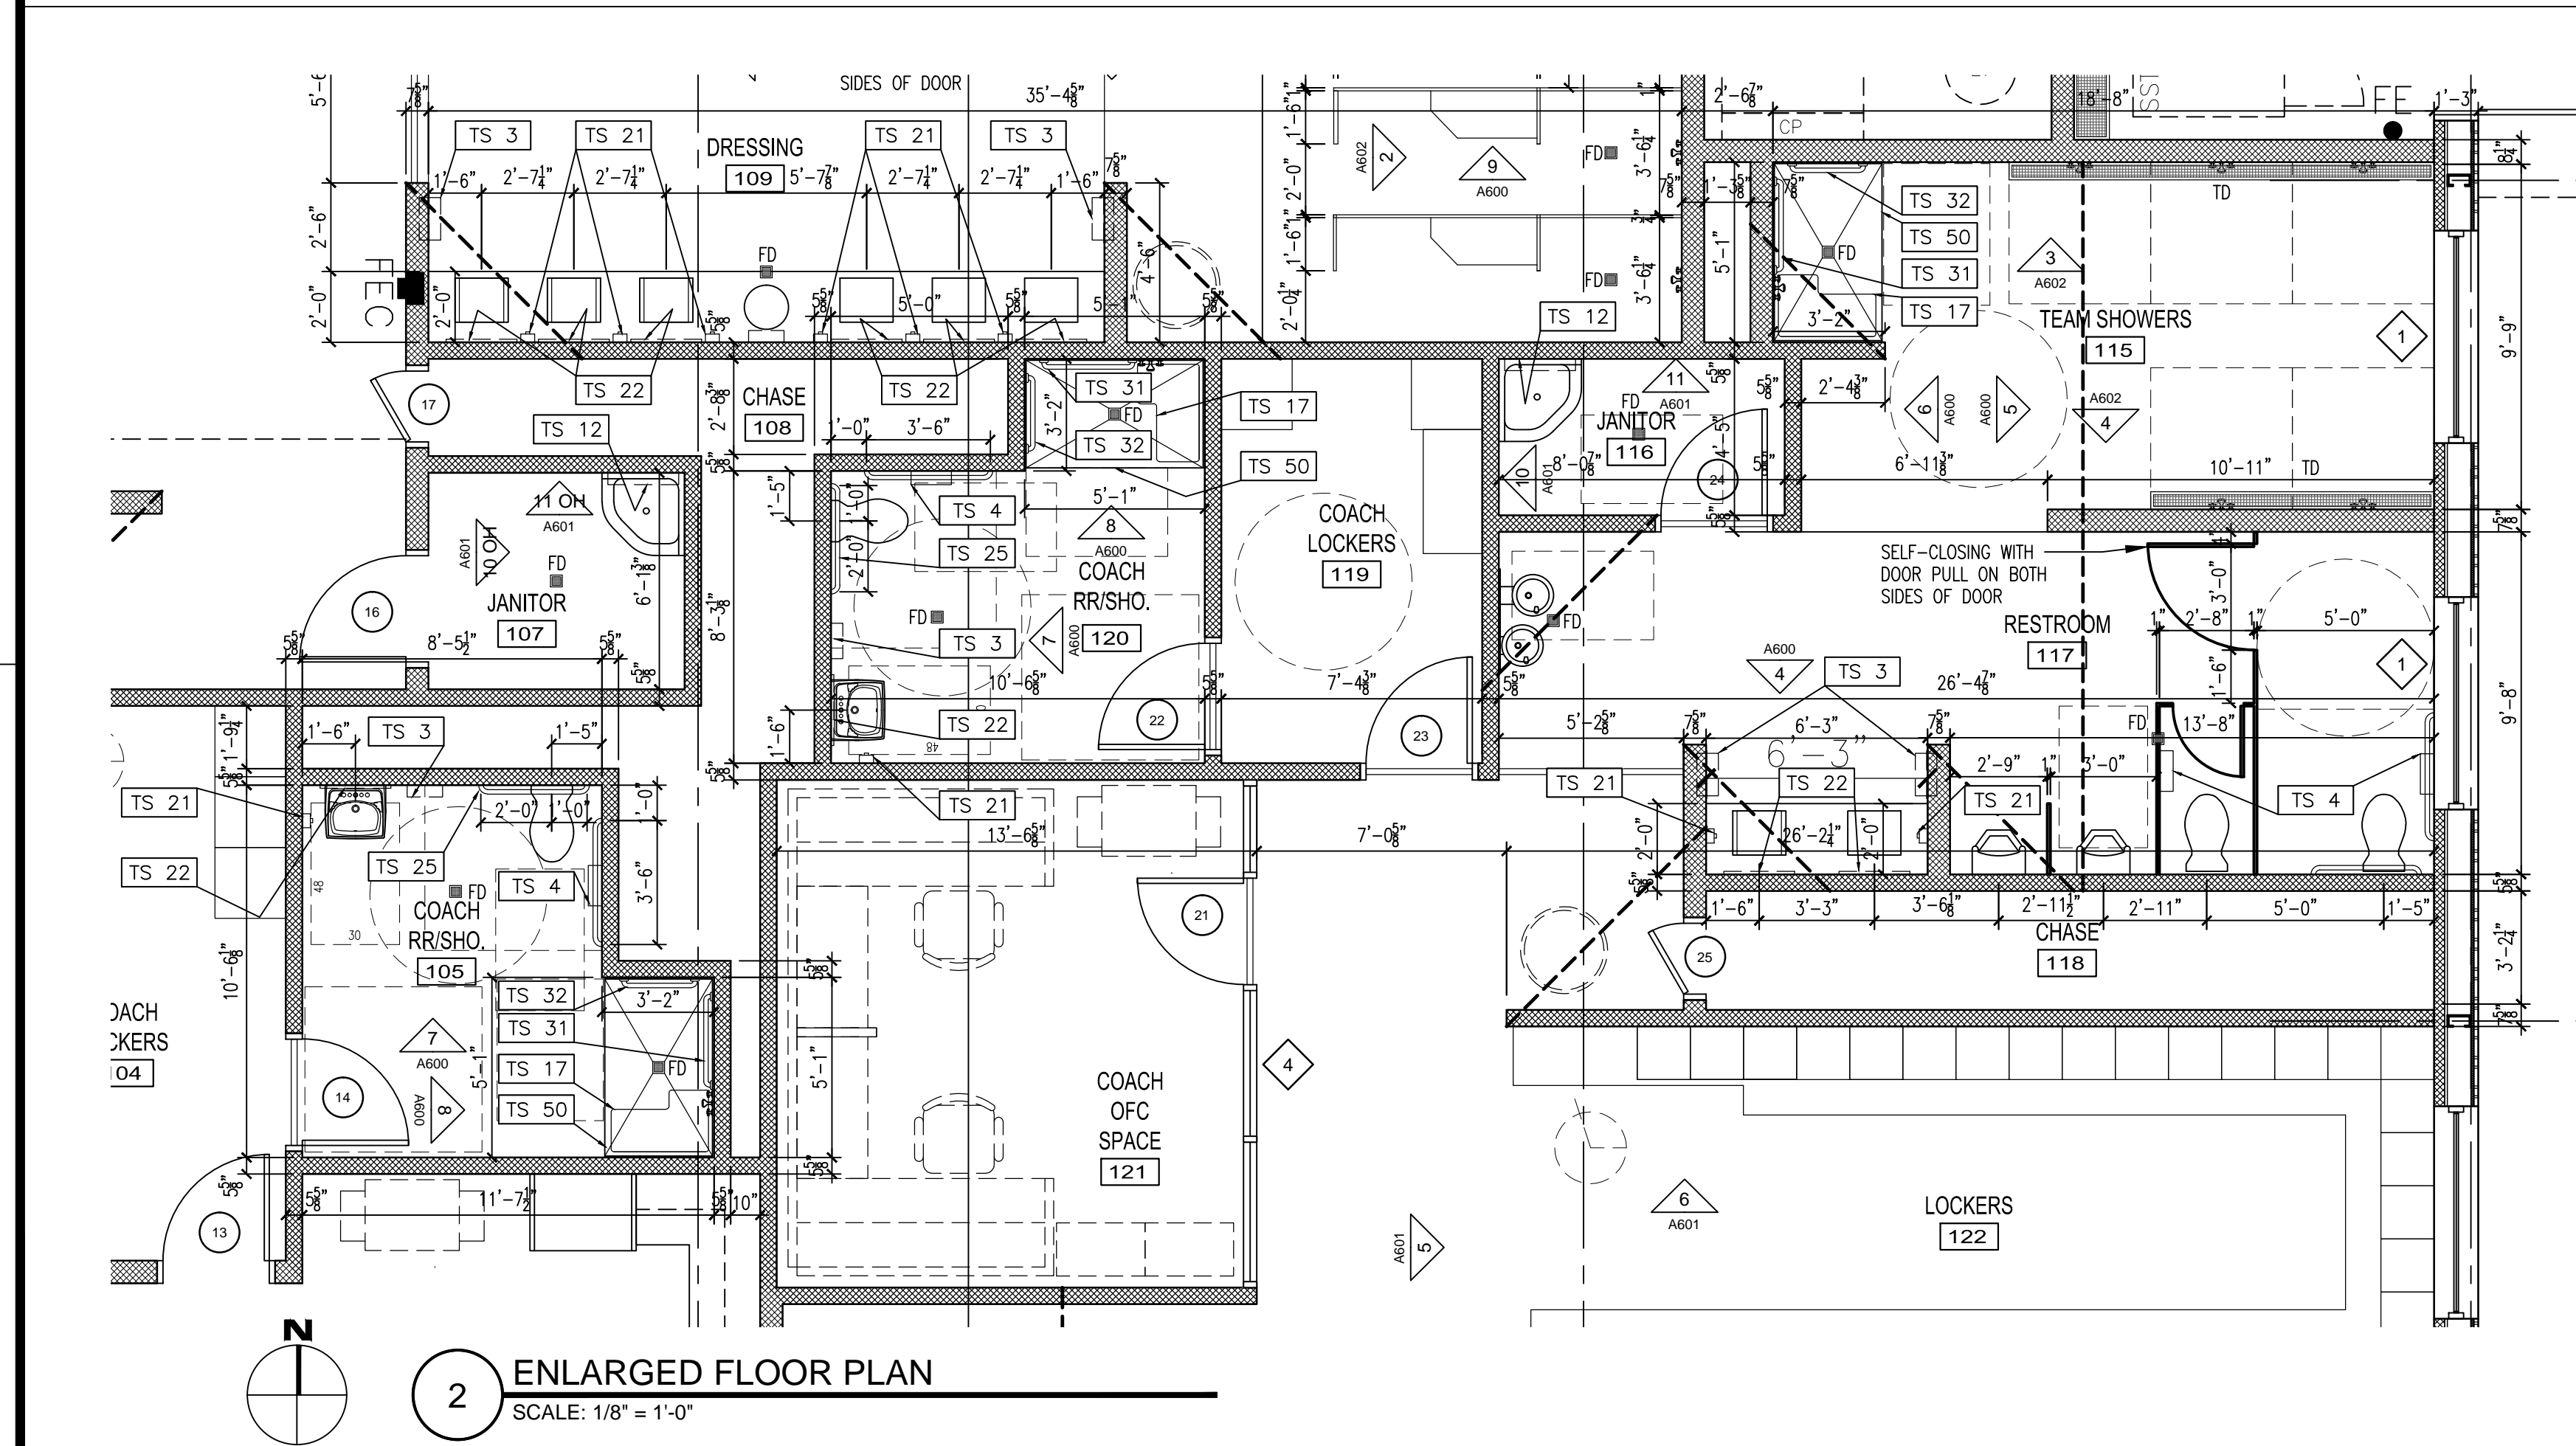

ISSUED FOR SCHEMATIC DESIGN
DATE: 1/26/2021

DESIGN DEVELOPMENT
DATE: _____

BIDS & CONSTRUCTION
DATE: 4/18/2022

REVISION: _____
DATE: _____

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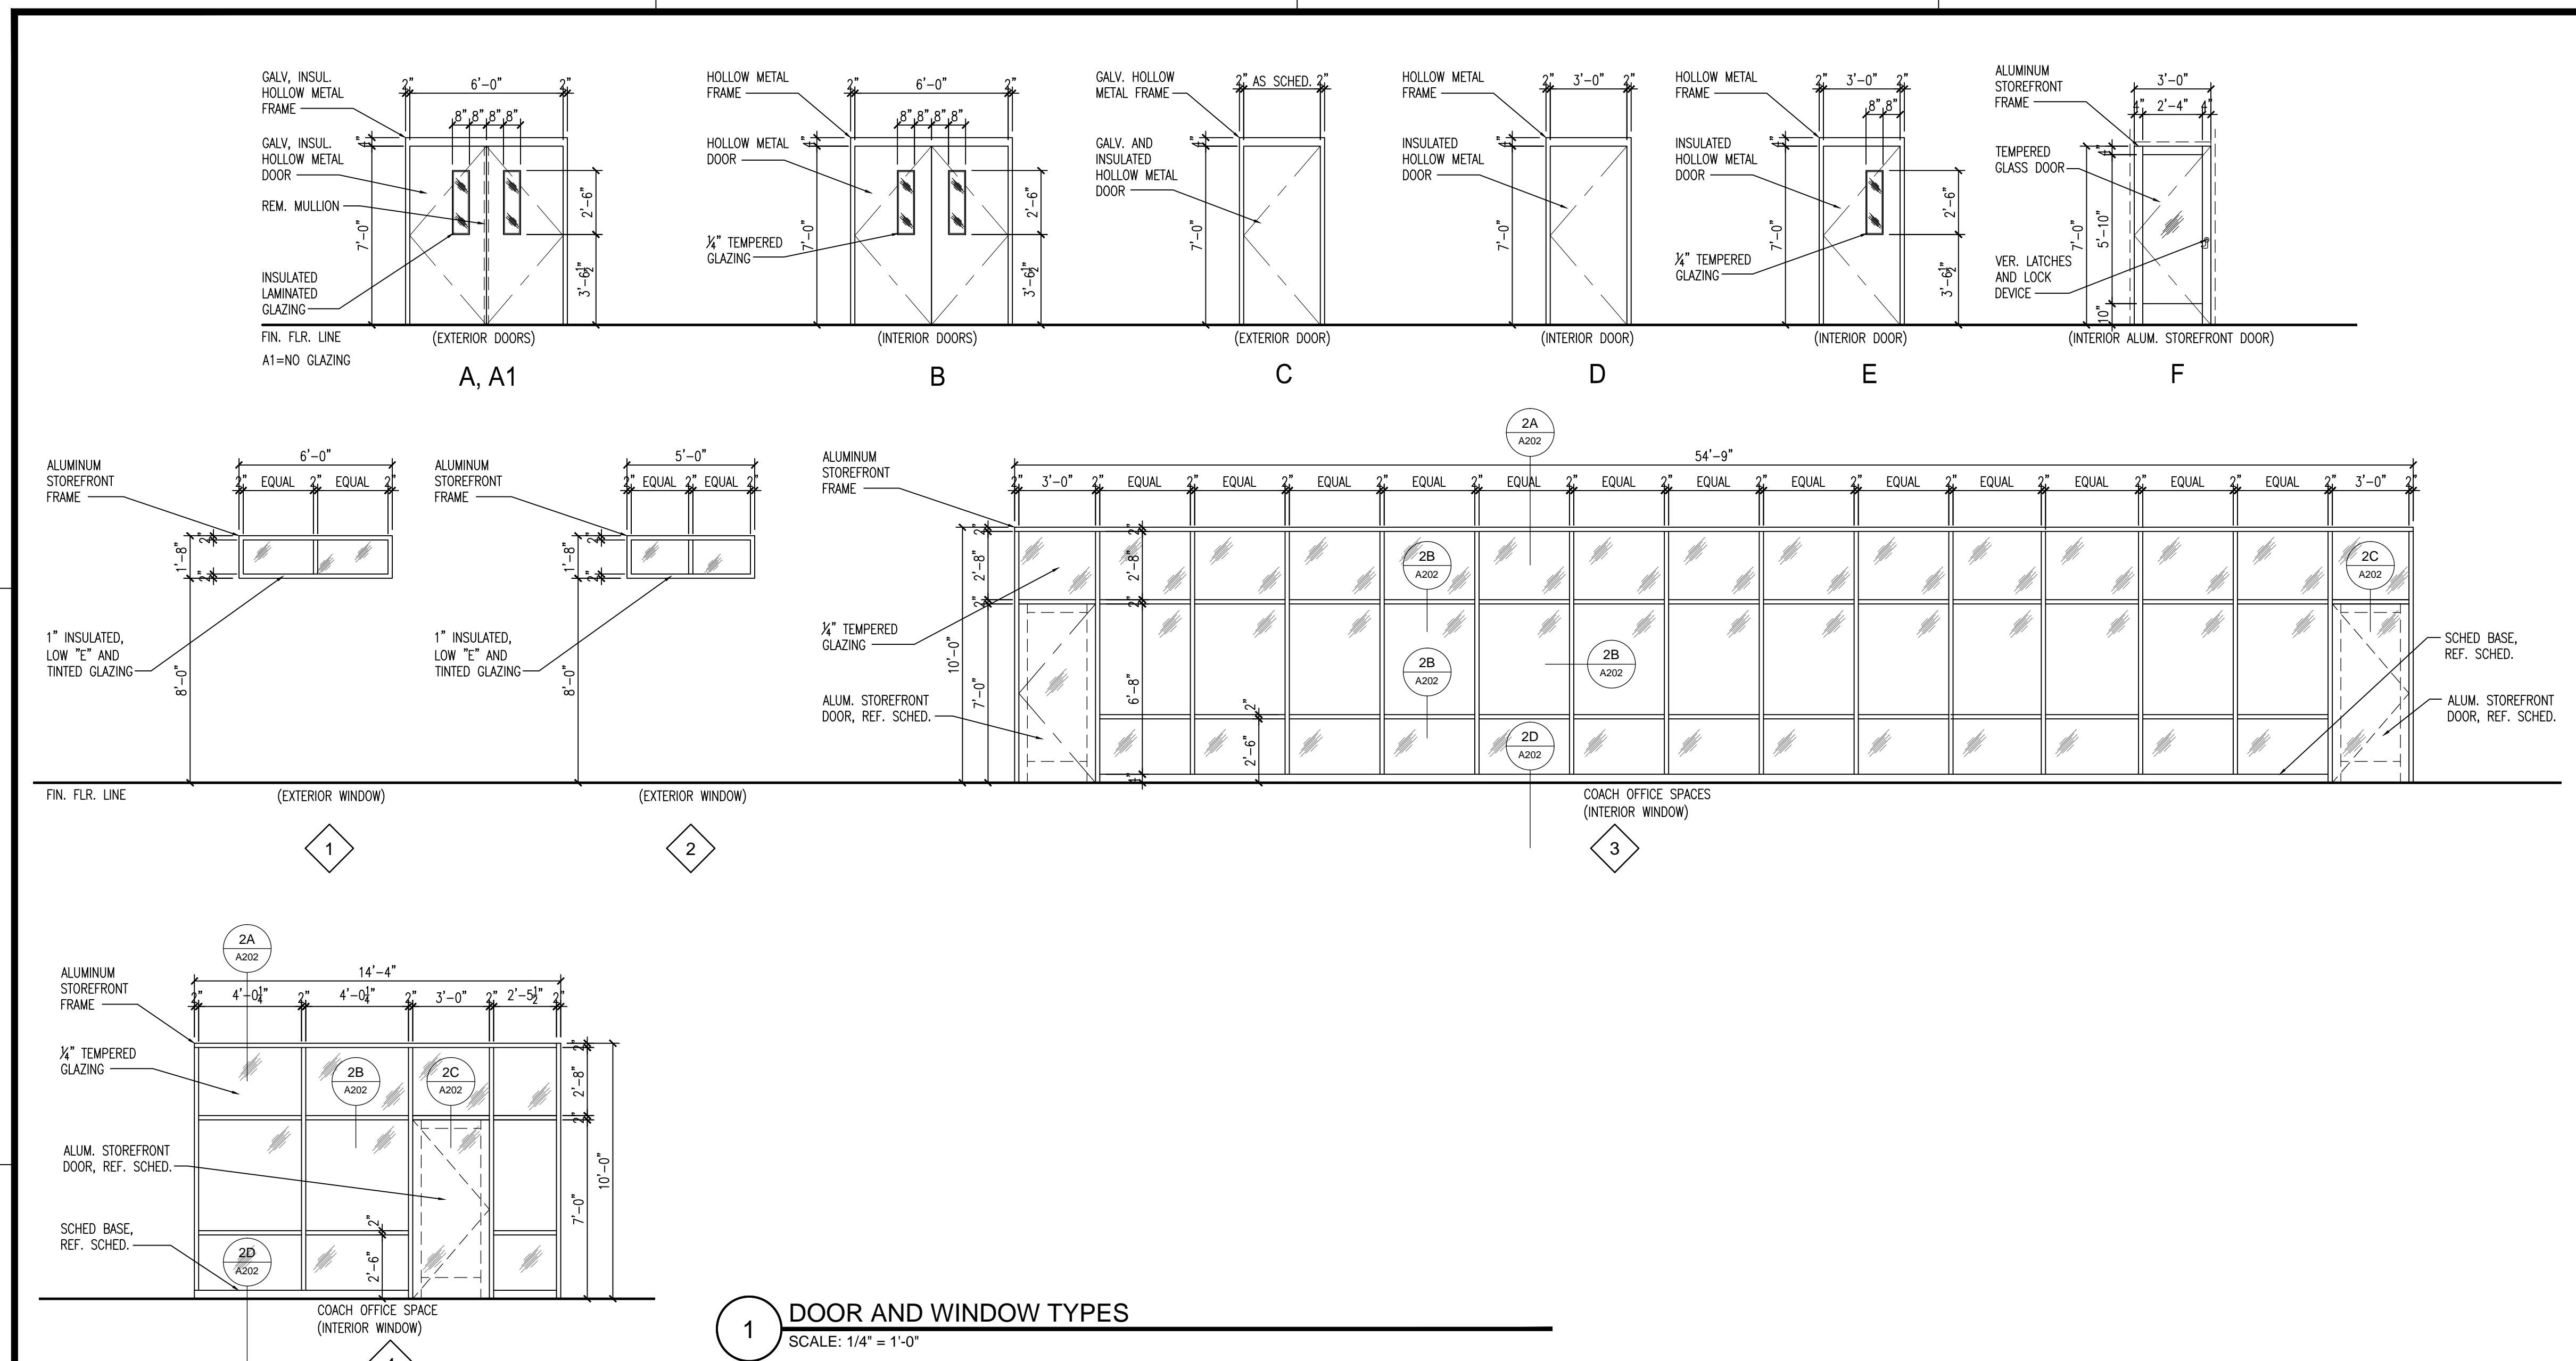
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FLOOR PLAN

SHEET NUMBER
A101

PROJECT NUMBER
21021


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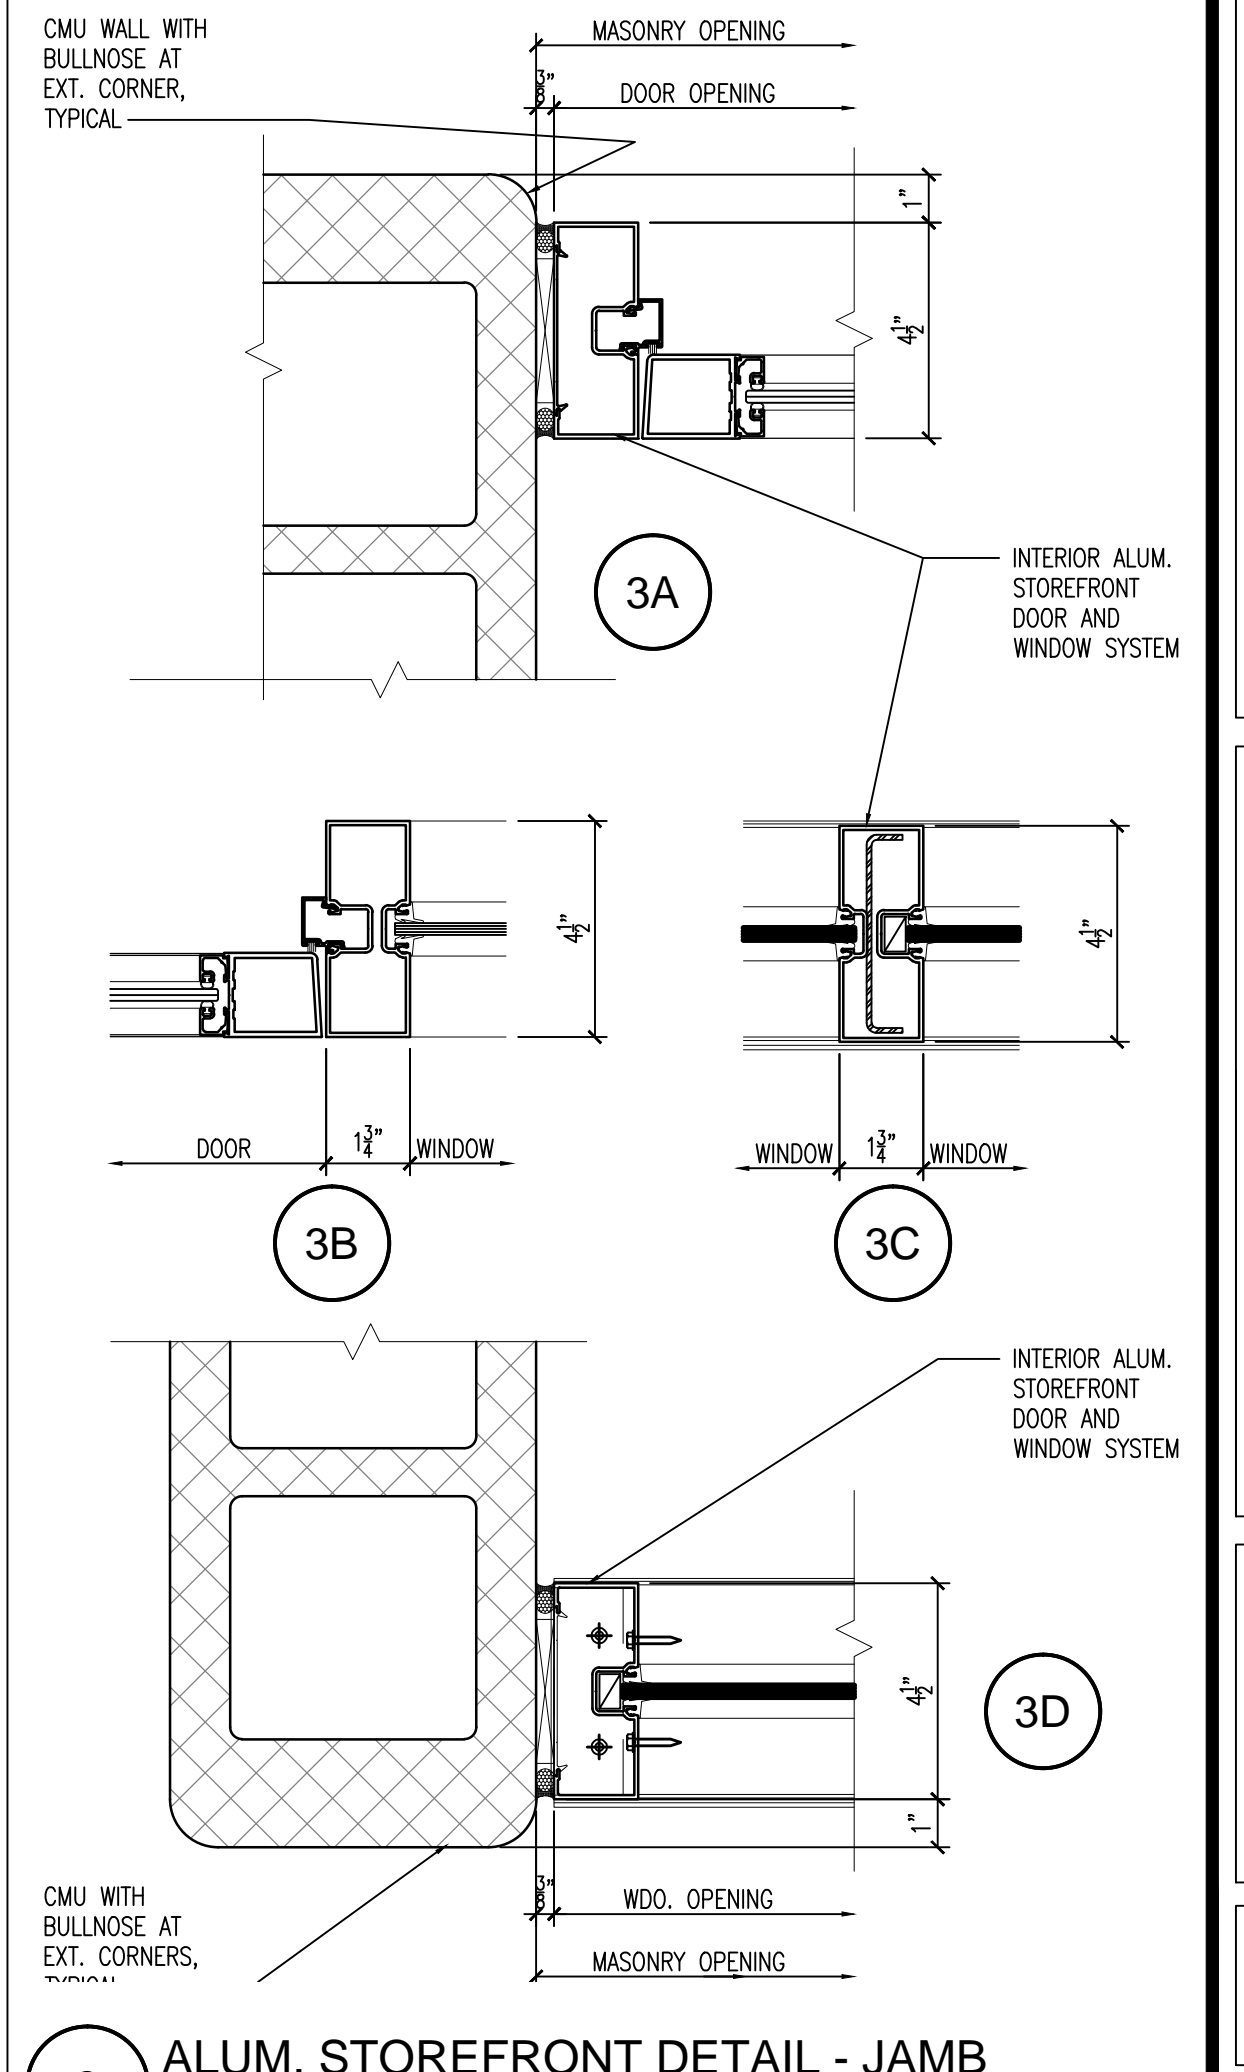
1 DOOR AND WINDOW TYPES
SCALE: 1/4" = 1'-0"

| DOOR NUMBER | DOOR TYPE | DOOR SIZE | | | DOOR MATERIAL | VISION PANEL | FRAME MATERIAL | WALL THICKNESS | FRAME DETAIL | | | HARDWARE | NOTES | DOOR NUMBER |
|-------------|-----------|-----------|--------|-----------|---------------|--------------|----------------|----------------|--------------|----------|------|----------|-------|-------------|
| | | WIDTH | HEIGHT | THICKNESS | | | | | HEAD | JAMB | SILL | | | |
| 1 | A | 6'-0" | 7'-0" | 1 3/4" | MTL | X | MTL | 1'-3" | 1/A202 | 2/A202 | -- | X X X | -- | 1 |
| 2 | A | 6'-0" | 7'-0" | 1 3/4" | MTL | X | MTL | 1'-3" | 1/A202 | 2/A202 | -- | X X X | -- | 2 |
| 3 | D | 3'-6" | 7'-0" | 1 3/4" | MTL | -- | MTL | 1'-3" | 1/A202 | 2/A202 | -- | X | -- | 3 |
| 4 | D | 4'-0" | 7'-0" | 1 3/4" | MTL | -- | MTL | 10. 1/2" | 1/A202 | 2/A202 | -- | X | -- | 4 |
| 5 | D | 3'-0" | 7'-0" | 1 3/4" | MTL | -- | MTL | 1'-3" | 1/A202 | 2/A202 | -- | X X | -- | 5 |
| 6 | A1 | 6'-0" | 7'-0" | 1 3/4" | MTL | -- | MTL | 1'-3" | 1/A202 | 2/A202 | -- | X X X | -- | 6 |
| 7 | D | 3'-0" | 7'-0" | 1 3/4" | MTL | -- | MTL | 1'-3" | 1/A202 | 2/A202 | -- | X | -- | 7 |
| 8 | D | 3'-0" | 7'-0" | 1 3/4" | MTL | -- | MTL | 1'-3" | 1/A202 | 2/A202 | -- | X | -- | 8 |
| 9 | D | 3'-0" | 7'-0" | 1 3/4" | MTL | -- | MTL | 1'-3" | 1/A202 | 2/A202 | -- | X | -- | 9 |
| 10 | B | 6'-0" | 7'-0" | 1 3/4" | MTL | X | MTL | 5 5/8" | 8/A202 | 11/A202 | -- | X | -- | 10 |
| 11 | F | 3'-0" | 7'-0" | 1 3/4" | AL/GL | -- | AL | 4 1/2" | 2A/A202 | 3A/A202 | -- | X | -- | 11 |
| 12 | F | 3'-0" | 7'-0" | 1 3/4" | AL/GL | -- | AL | 4 1/2" | 2A/A202 | 3A/A202 | -- | X | -- | 12 |
| 13 | D | 3'-0" | 7'-0" | 1 3/4" | MTL | -- | MTL | 7 5/8" | 10/A202 | 11A/A202 | -- | X | -- | 13 |
| 14 | D | 3'-0" | 7'-0" | 1 3/4" | MTL | -- | MTL | 5 5/8" | 10/A202 | 11A/A202 | -- | X | -- | 14 |
| 15 | E | 3'-0" | 7'-0" | 1 3/4" | MTL | X | MTL | 5 5/8" | 10/A202 | 11A/A202 | -- | X | -- | 15 |
| 16 | D | 3'-0" | 7'-0" | 1 3/4" | MTL | -- | MTL | 7 5/8" | 7/A202 | 11/A202 | -- | X | -- | 16 |
| 17 | D | 2'-0" | 7'-0" | 1 3/4" | MTL | -- | MTL | 7 5/8" | 7/A202 | 11/A202 | -- | X | -- | 17 |
| 18 | D | 2'-0" | 7'-0" | 1 3/4" | MTL | -- | MTL | 5 5/8" | 10/A202 | 11A/A202 | -- | X | -- | 18 |
| 19 | E | 3'-0" | 7'-0" | 1 3/4" | MTL | X | MTL | 5 5/8" | 10/A202 | 11A/A202 | -- | X | -- | 19 |
| 20 | D | 3'-0" | 7'-0" | 1 3/4" | MTL | -- | MTL | 7 5/8" | 7/A202 | 11/A202 | -- | X | -- | 20 |
| 21 | F | 3'-0" | 7'-0" | 1 3/4" | AL/GL | -- | AL | 4 1/2" | 2A/A202 | 3A/A202 | -- | X | -- | 21 |
| 22 | D | 3'-0" | 7'-0" | 1 3/4" | MTL | -- | MTL | 5 5/8" | 10/A202 | 11A/A202 | -- | X | -- | 22 |
| 23 | D | 3'-0" | 7'-0" | 1 3/4" | MTL | -- | MTL | 5 5/8" | 10/A202 | 11A/A202 | -- | X | -- | 23 |
| 24 | D | 3'-0" | 7'-0" | 1 3/4" | MTL | -- | MTL | 5 5/8" | 7/A202 | 11/A202 | -- | X | -- | 24 |
| 25 | D | 2'-0" | 7'-0" | 1 3/4" | MTL | -- | MTL | 7 5/8" | 10/A202 | 11A/A202 | -- | X | -- | 25 |

4 DOOR SCHEDULE
SCALE: 1/4" = 1'-0"




2 ALUM. STOREFRONT DETAIL - SECTION
SCALE: 3/8" = 1'-0"

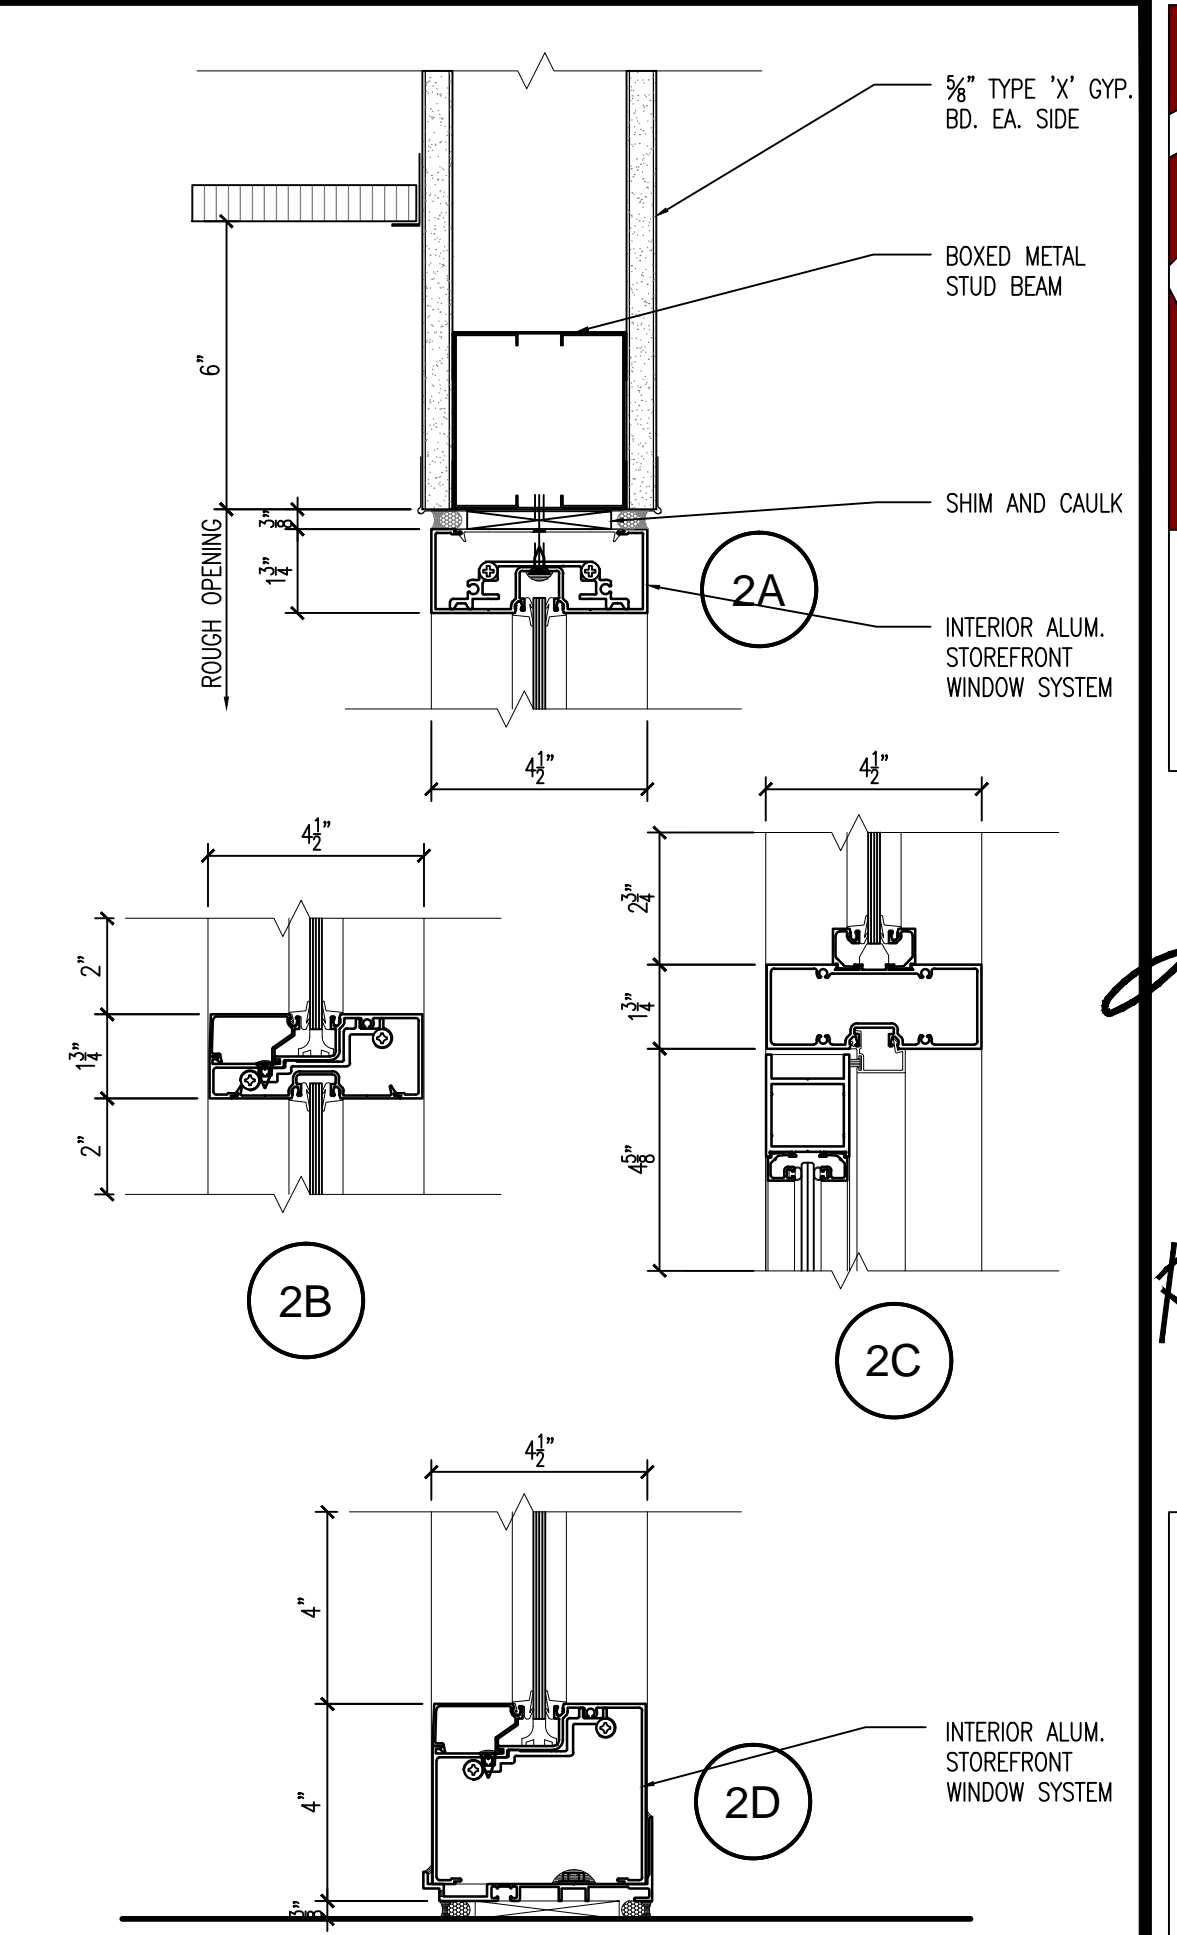


3 ALUM. STOREFRONT DETAIL - JAMB
SCALE: 3/8" = 1'-0"

Architectural Alliance Incorporated
3075 Eastman Blvd., Suite 720
Beaumont, Texas 77701
Tel: (409) 898-1146
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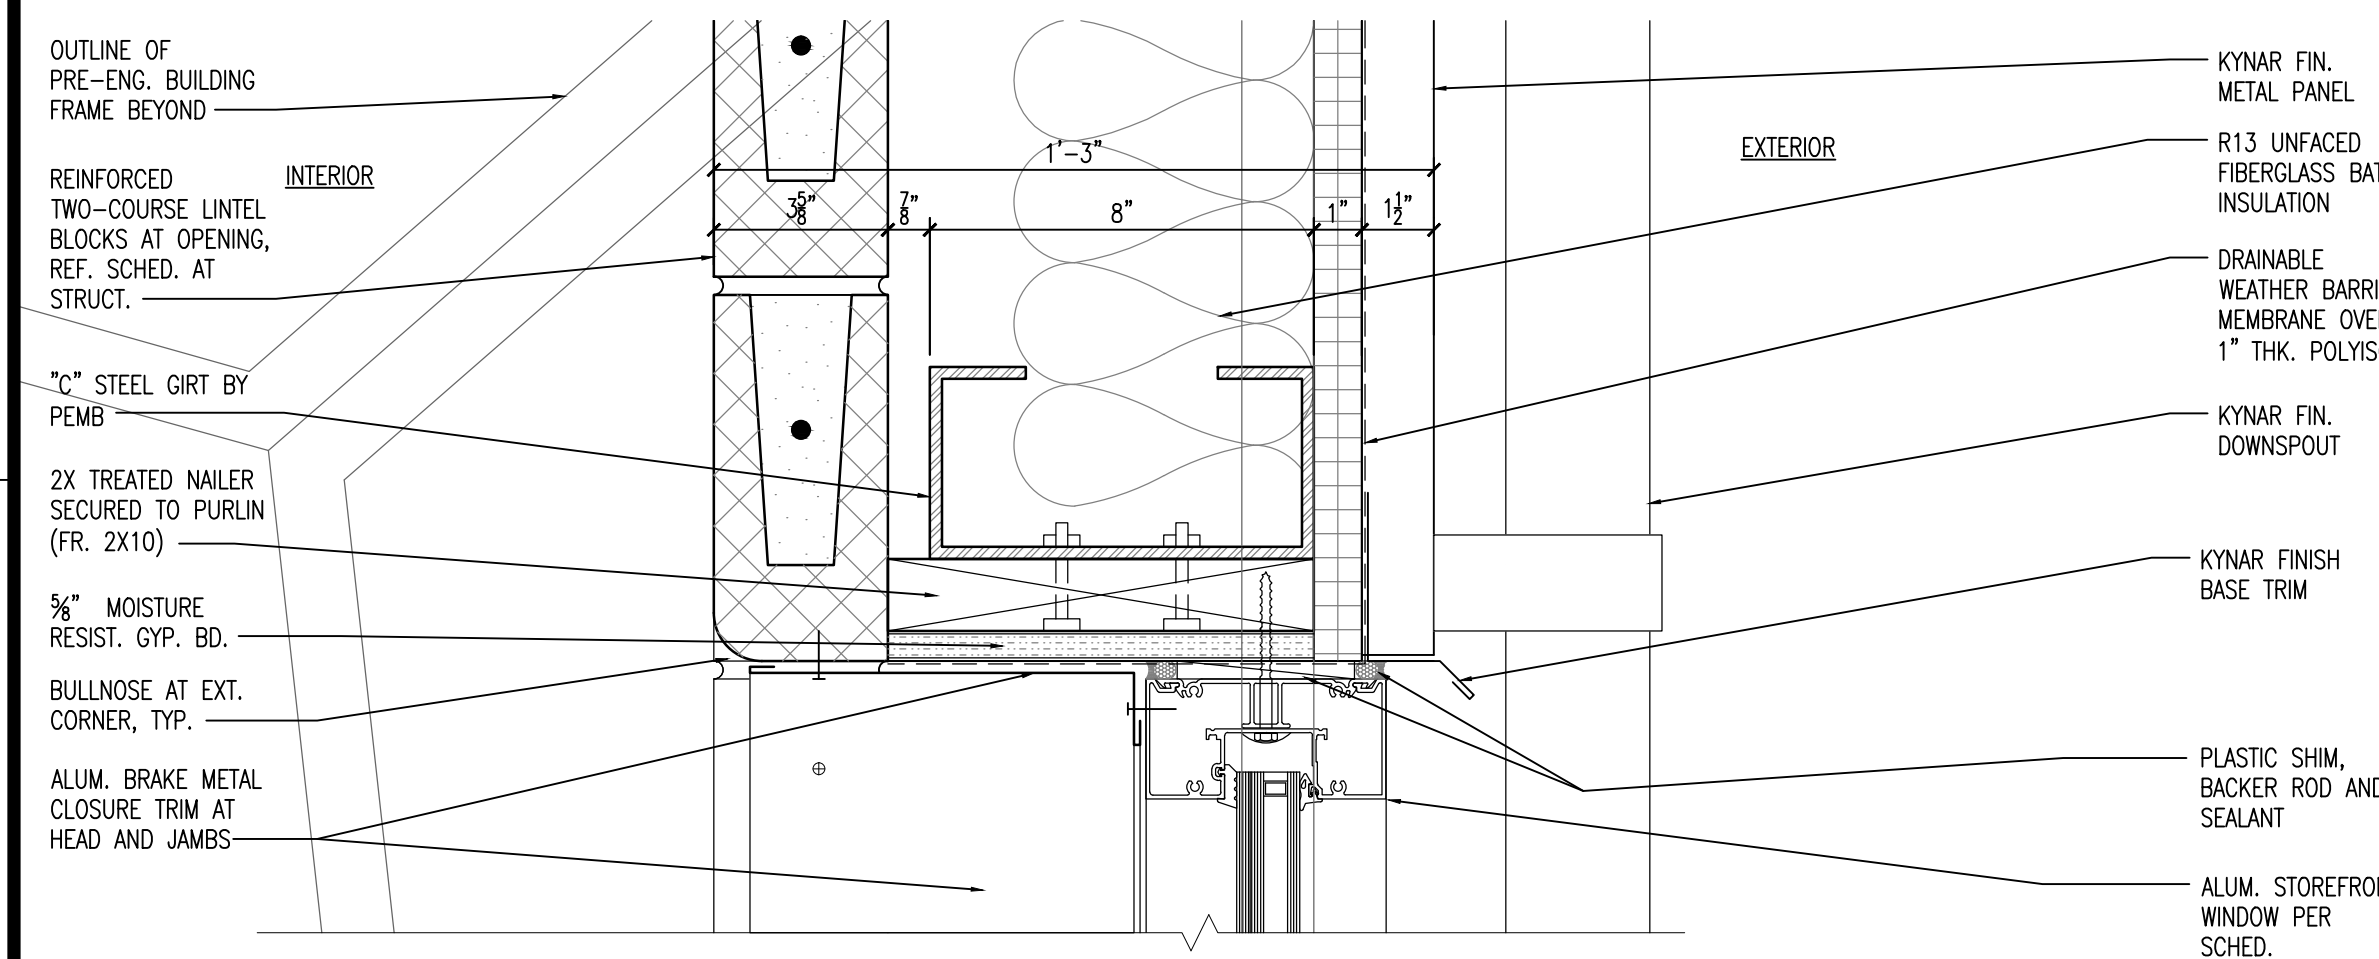

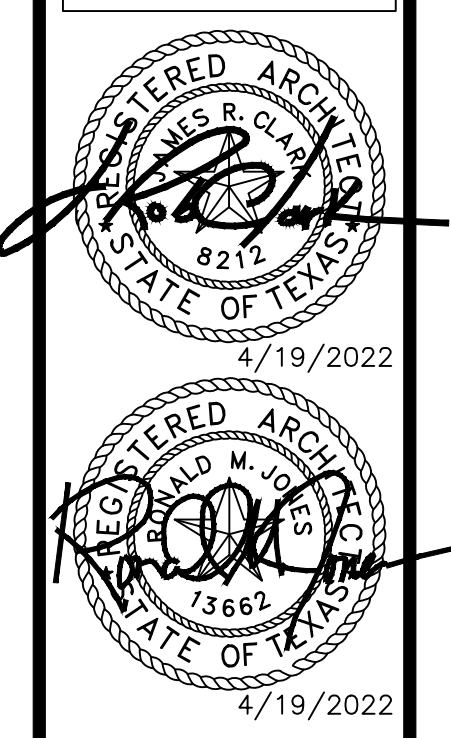
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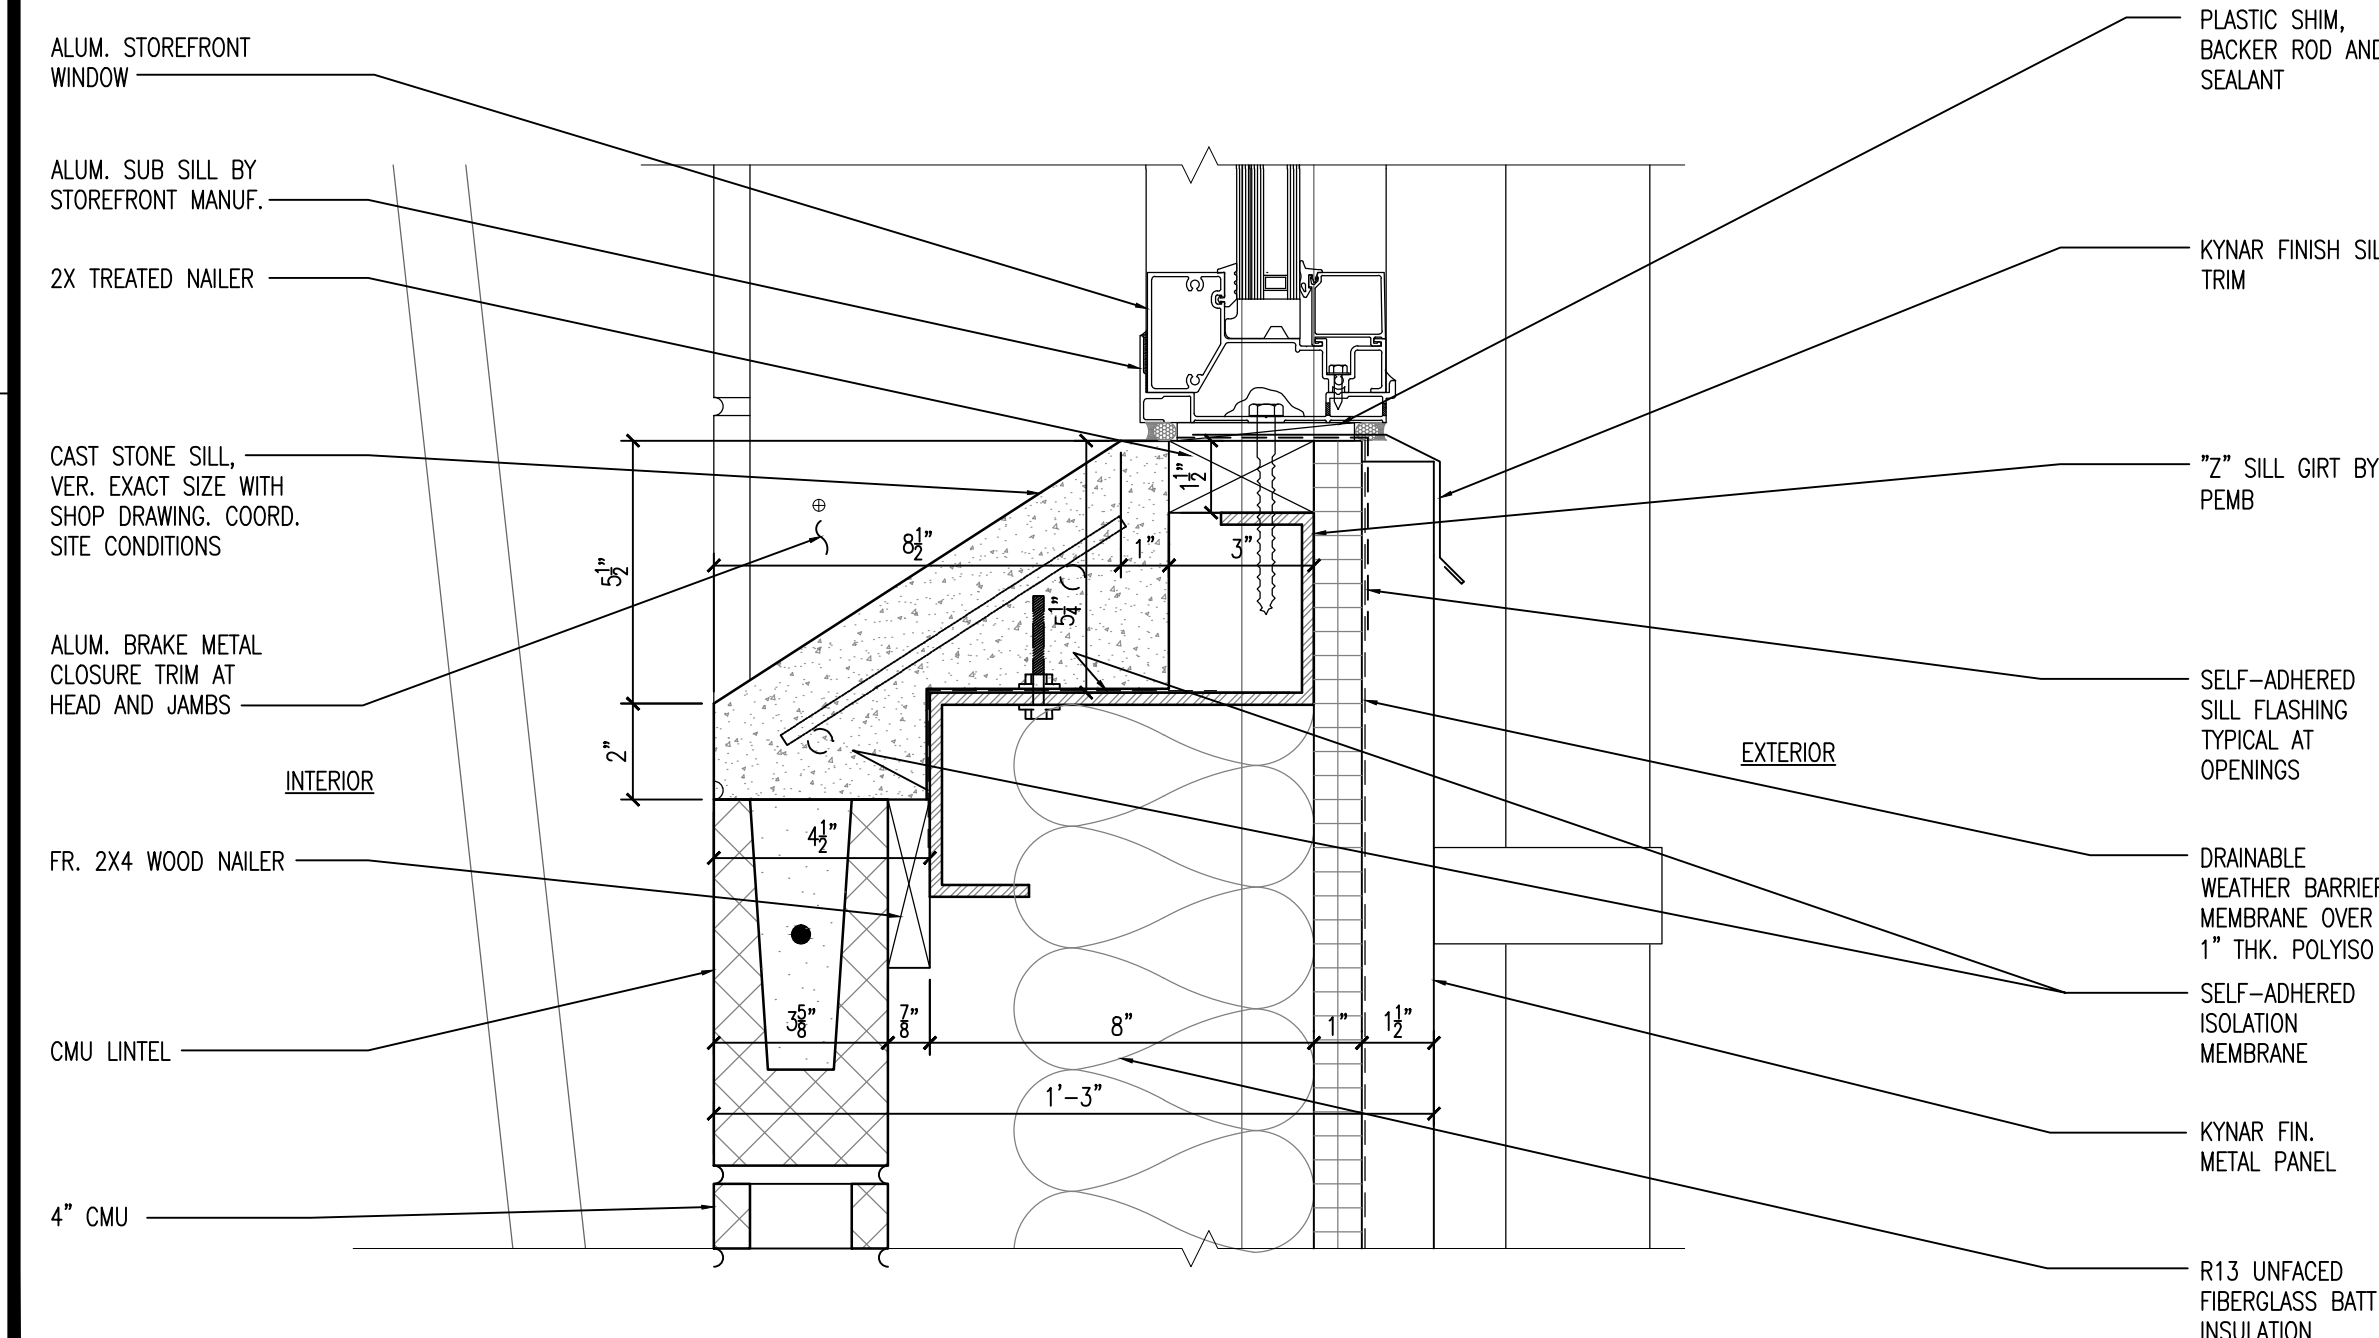
ISSUED FOR SCHEMATIC DESIGN
DATE: 1/26/2021
DESIGN DEVELOPMENT
DATE: -----
BIDS & CONSTRUCTION
DATE: 4/18/2022
REVISION: DATE: -----
REVISION: DATE: -----
REVISION: DATE: -----
DRAWINGS SHEET TITLE
DOOR SCHEDULE
SHEET NUMBER
A201
PROJECT NUMBER
21021




1 DOOR DETAIL - HEAD
SCALE: 3" = 1'-0"

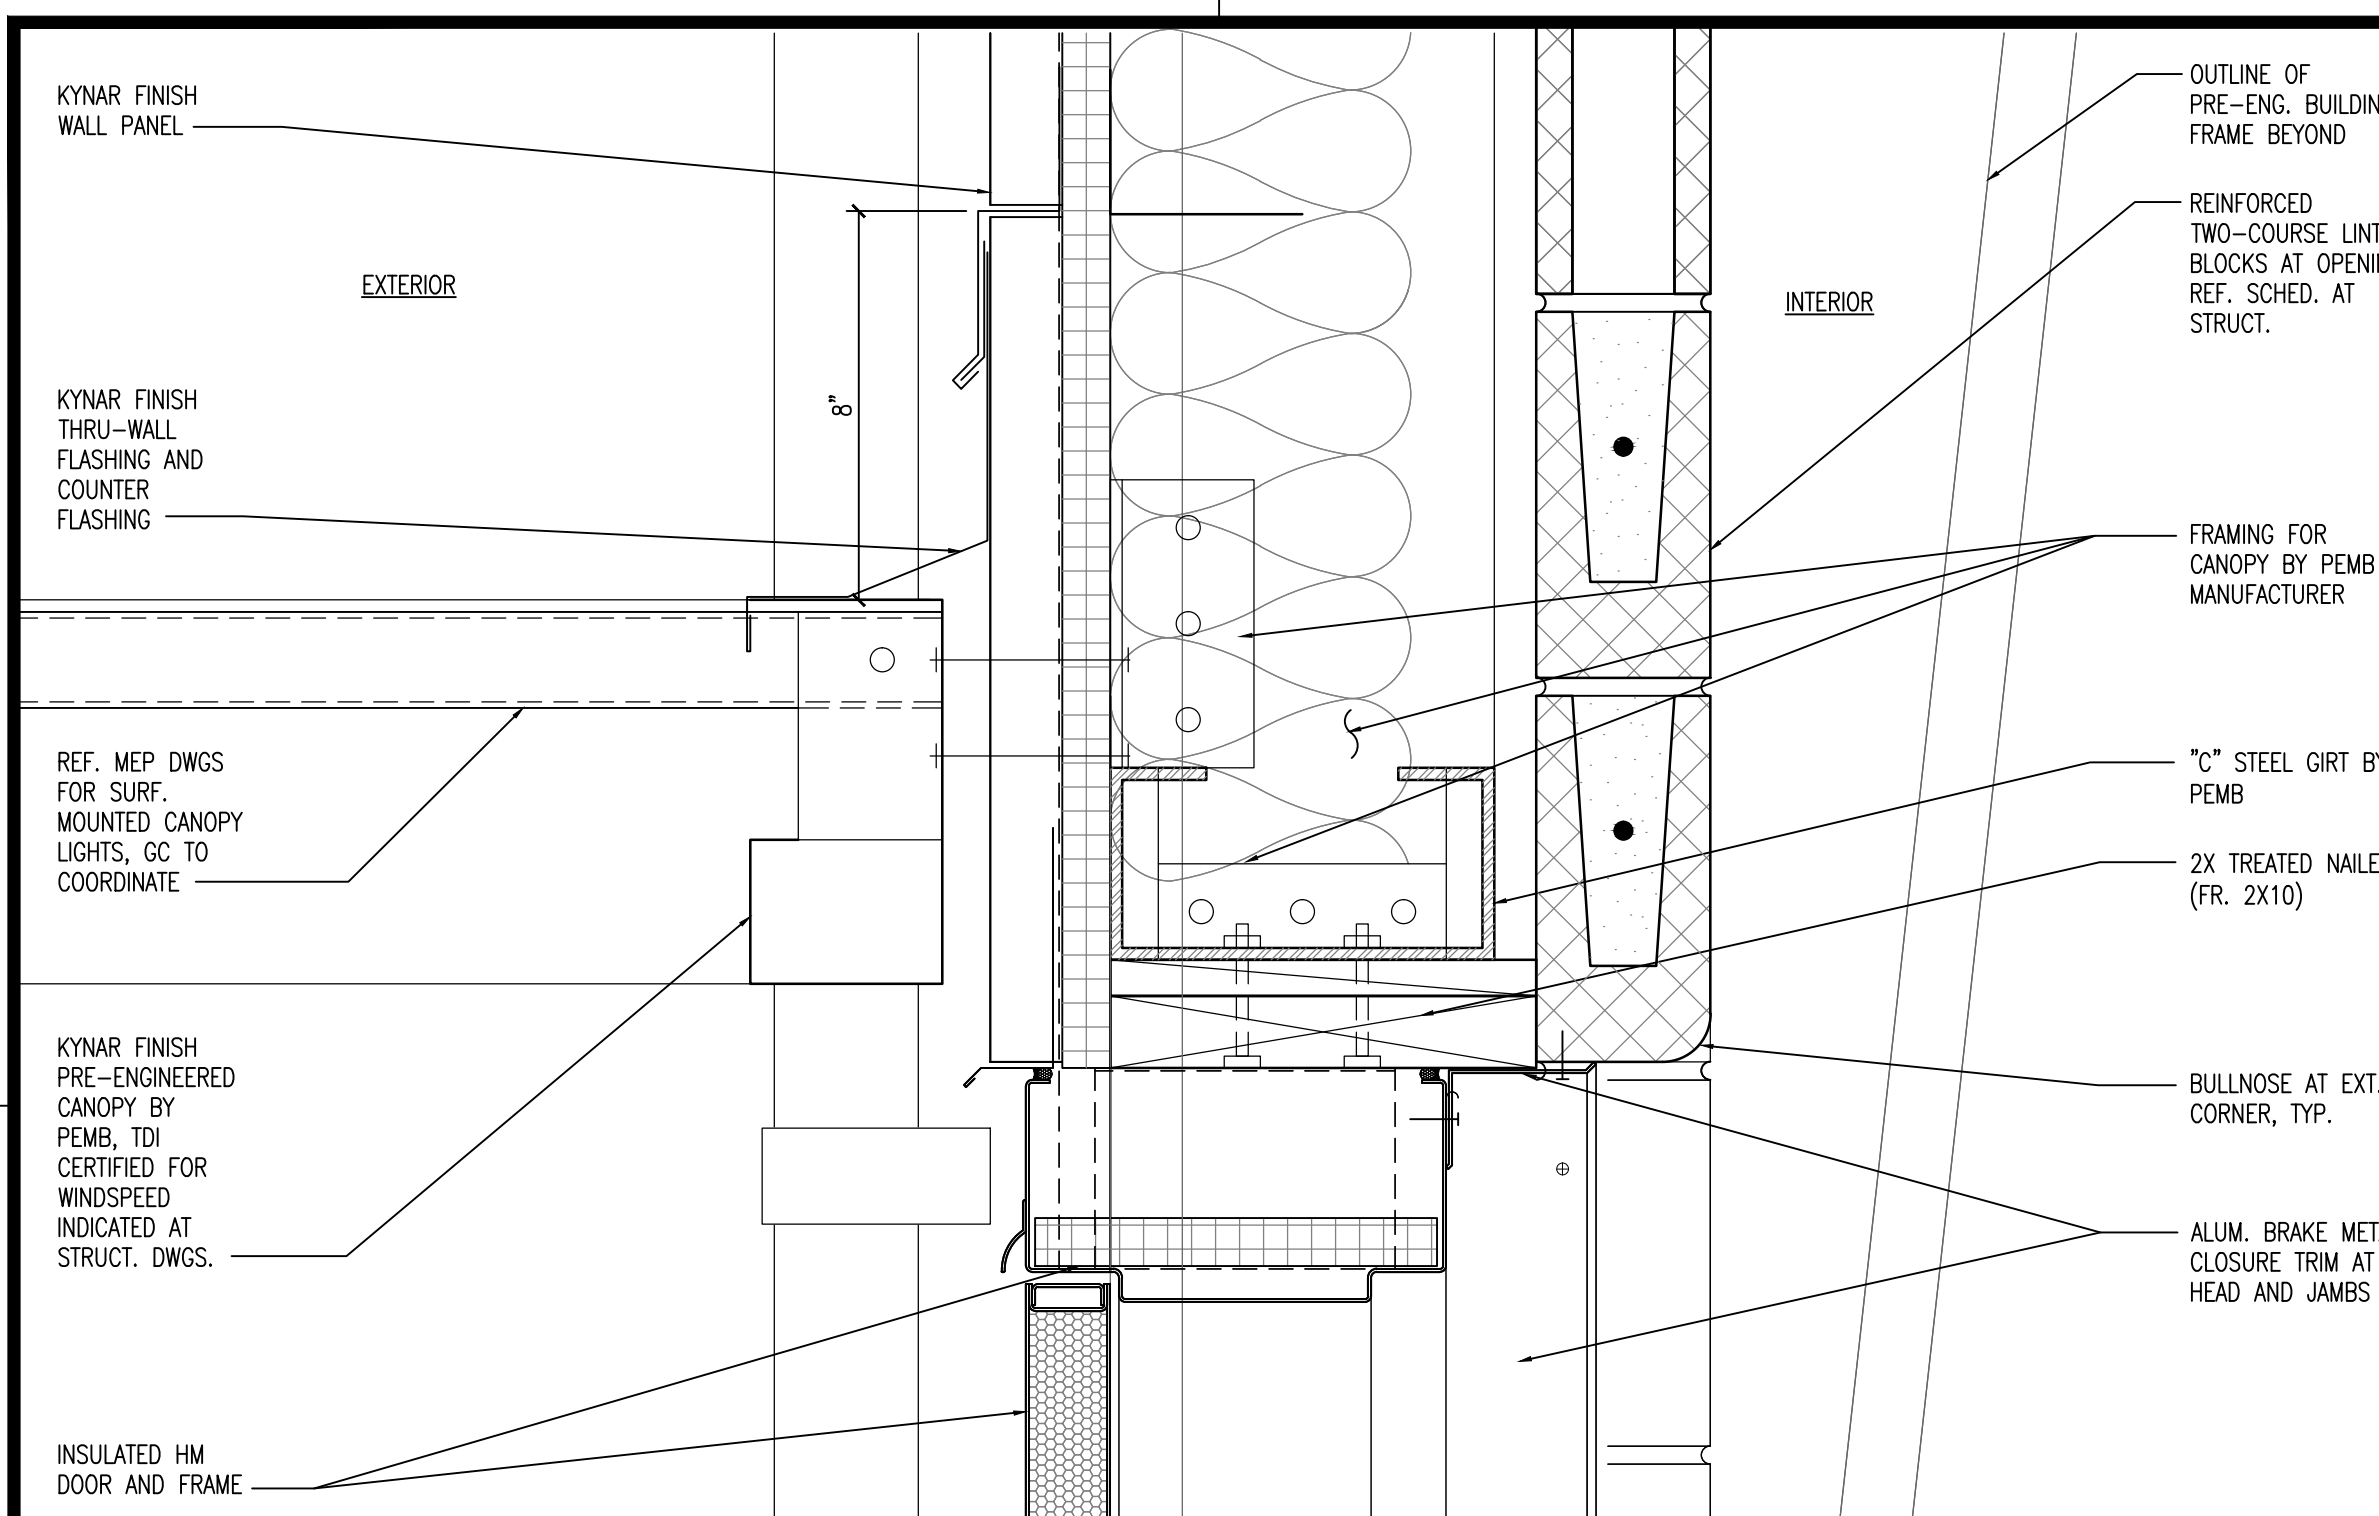


5 WINDOW DETAIL - HEAD
SCALE: 3" = 1'-0"




8 WINDOW DETAIL - SILL
SCALE: 3" = 1'-0"

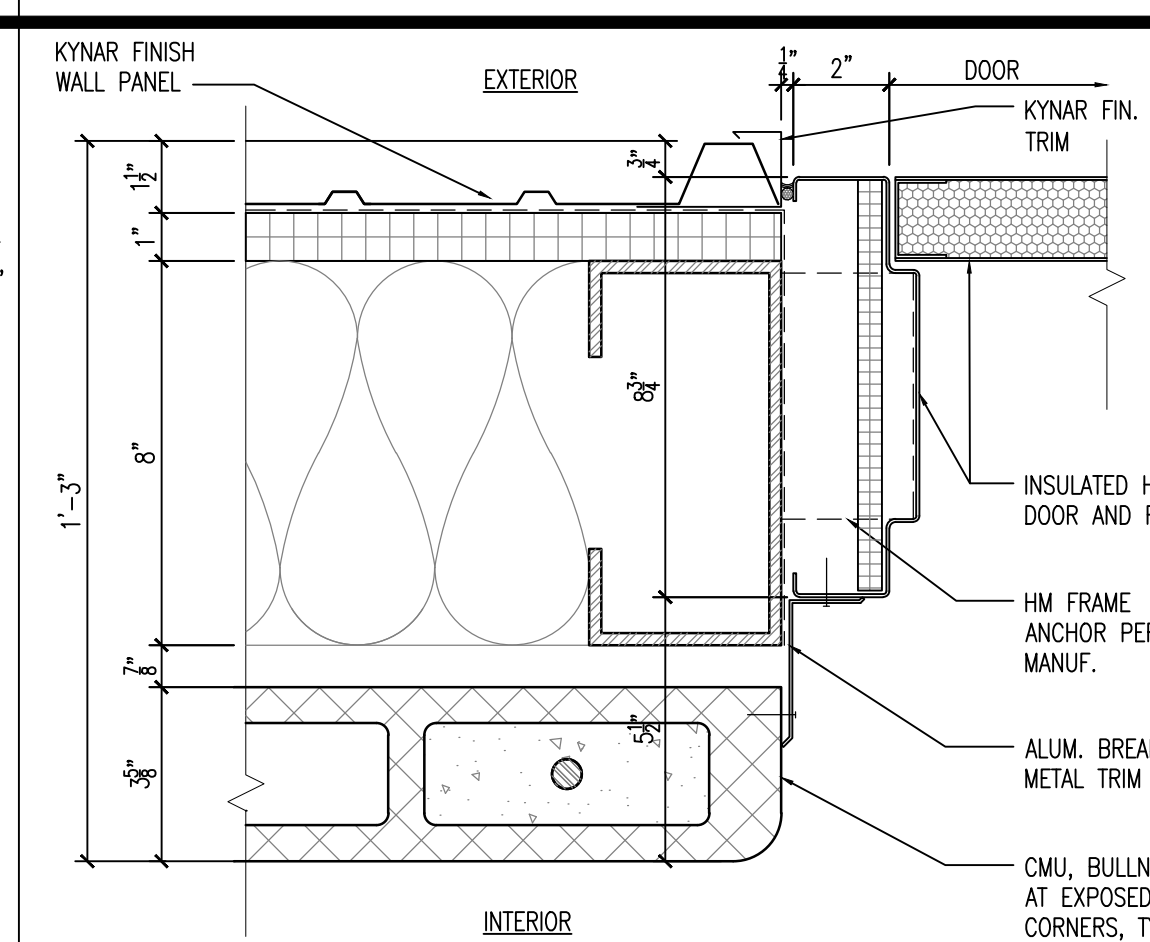


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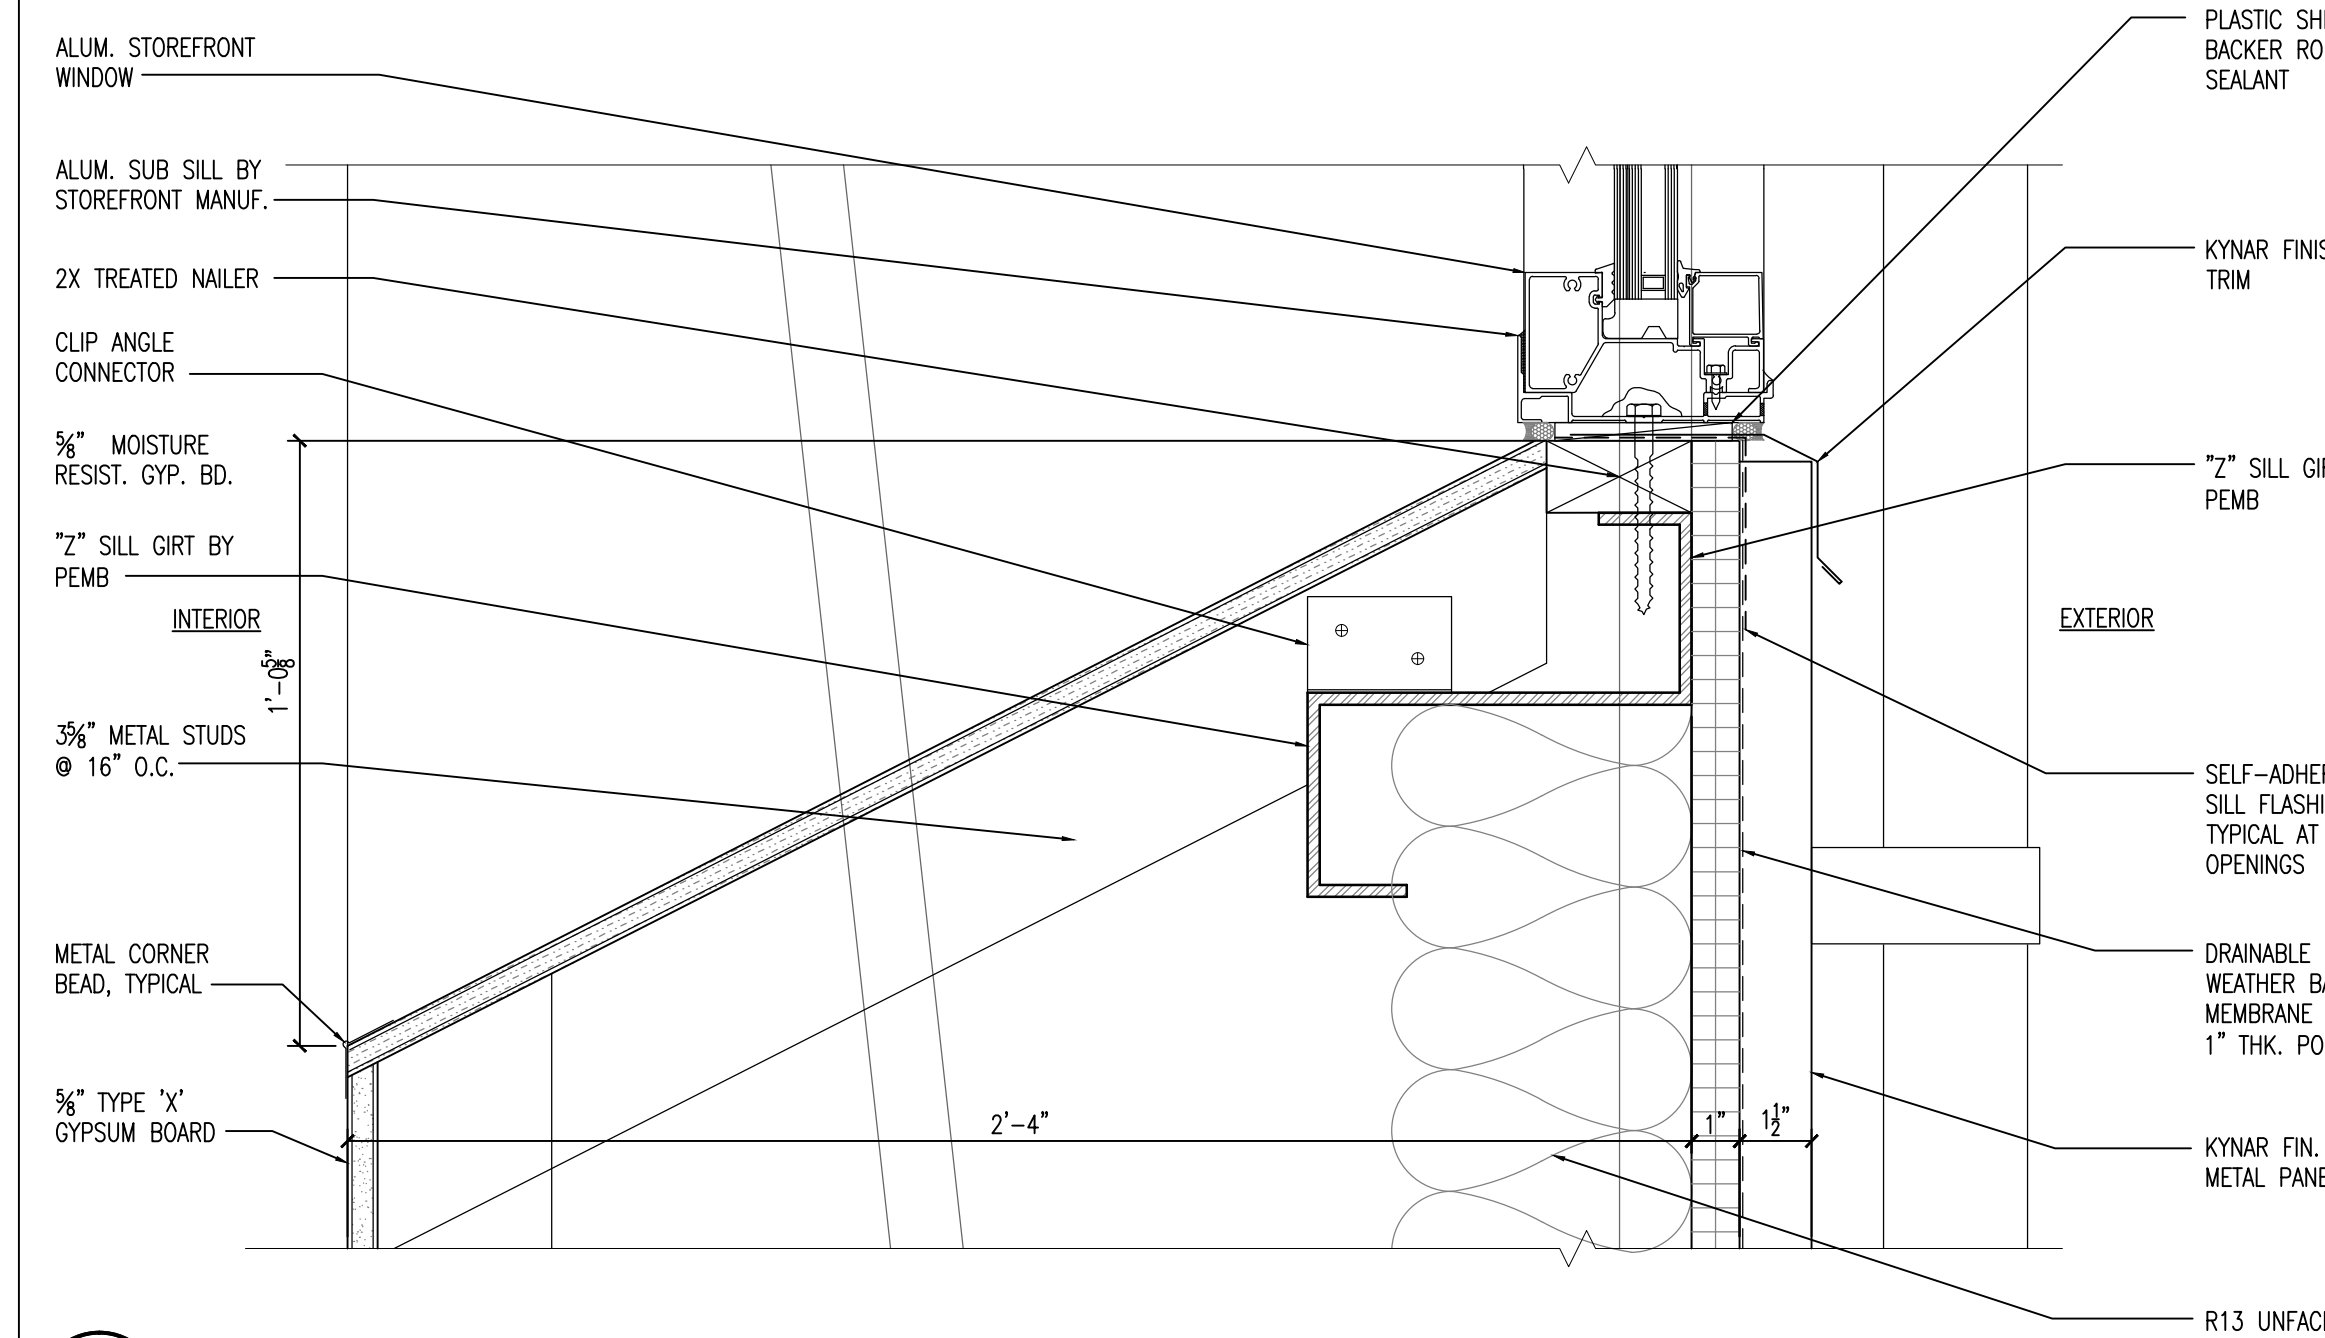
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SCALE: 3" = 1'-0"

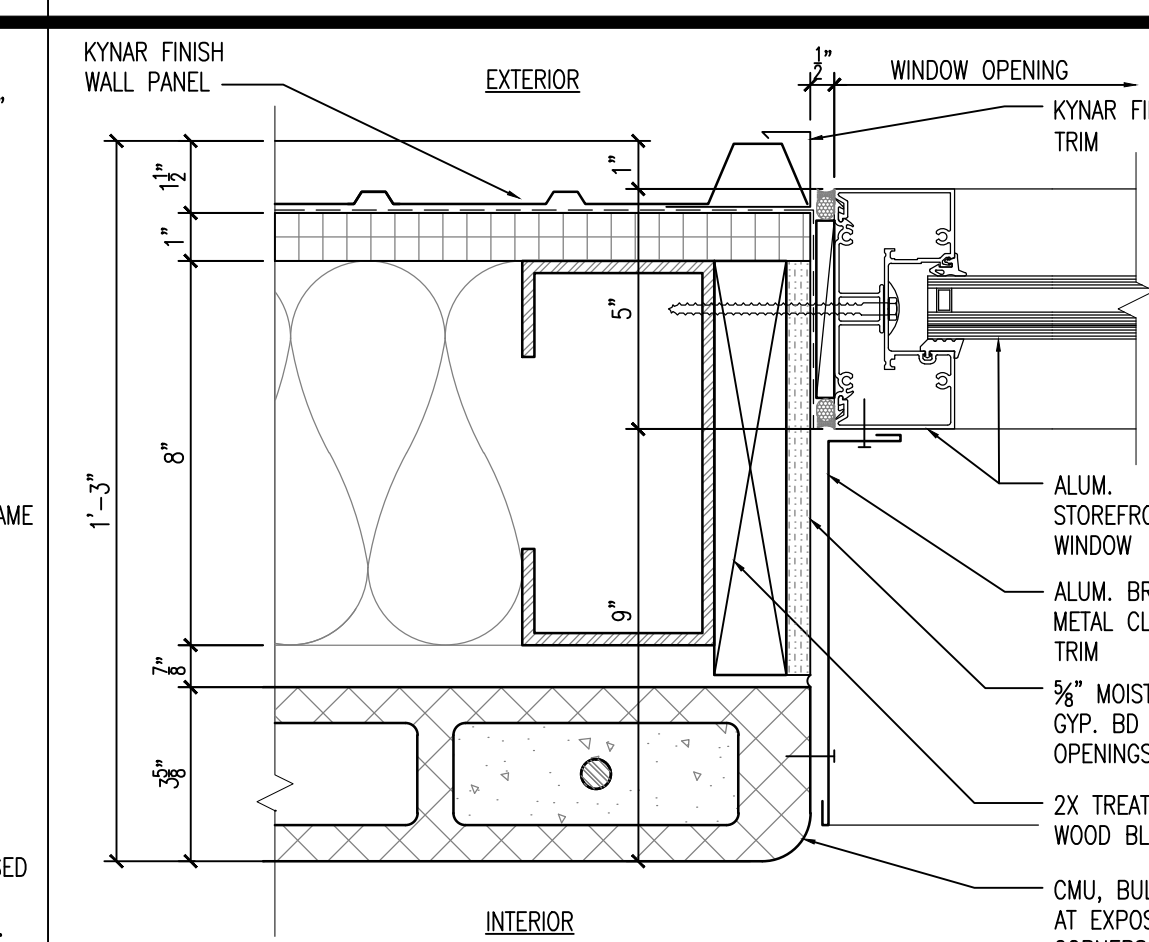


4 HM DOOR DETAIL - JAMB
SCALE: 3" = 1'-0"

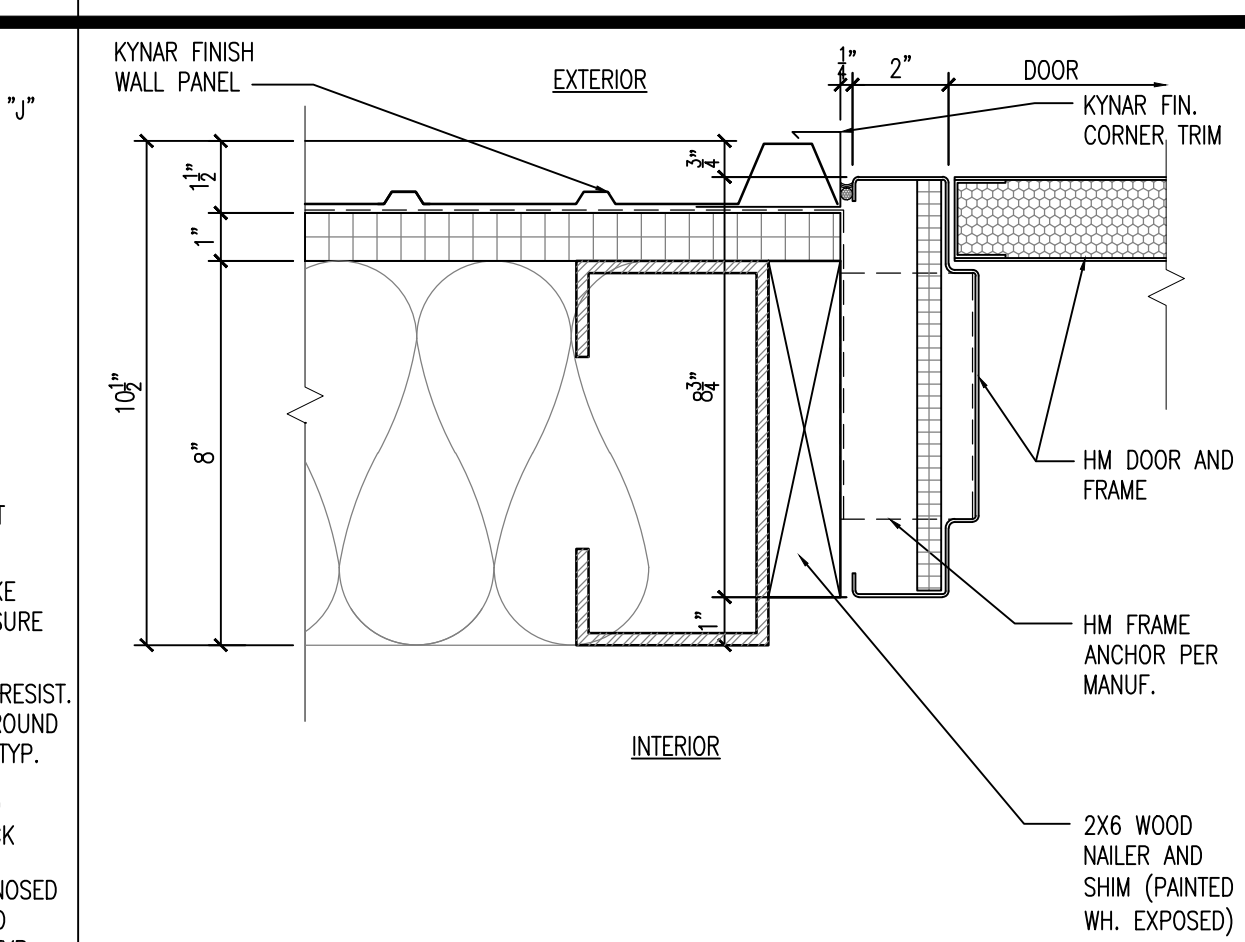


6 WINDOW DETAIL - HEAD
SCALE: 3" = 1'-0"

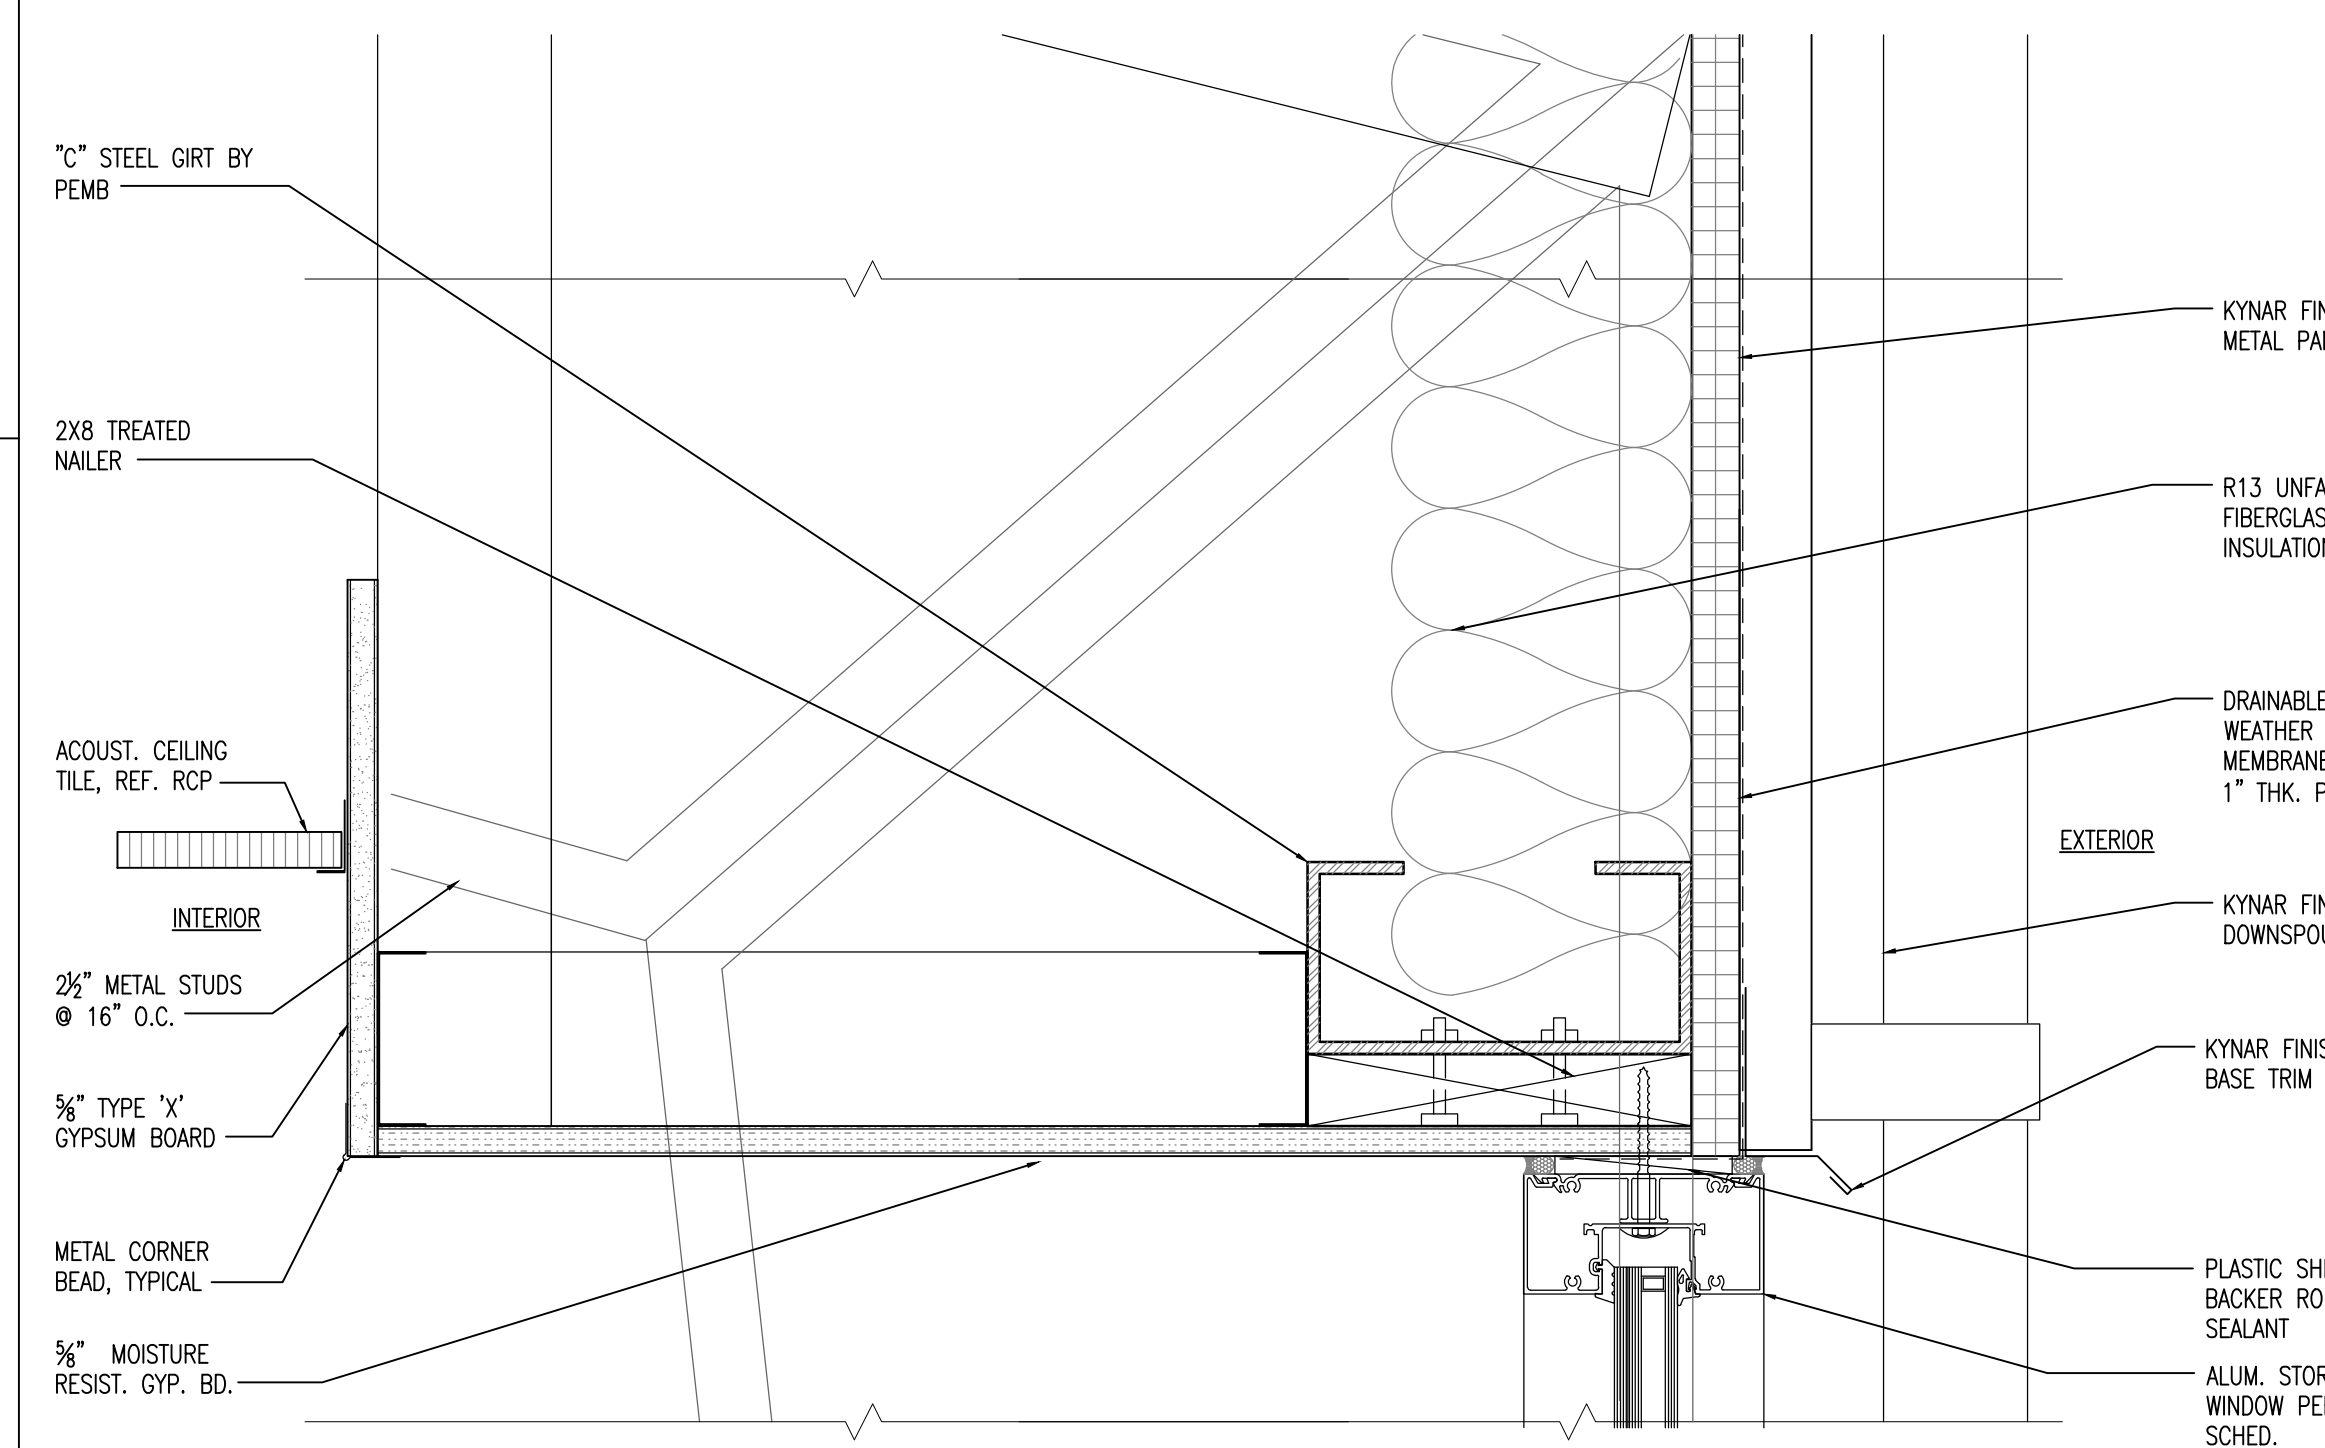


9 WINDOW DETAIL - SILL
SCALE: 3" = 1'-0"

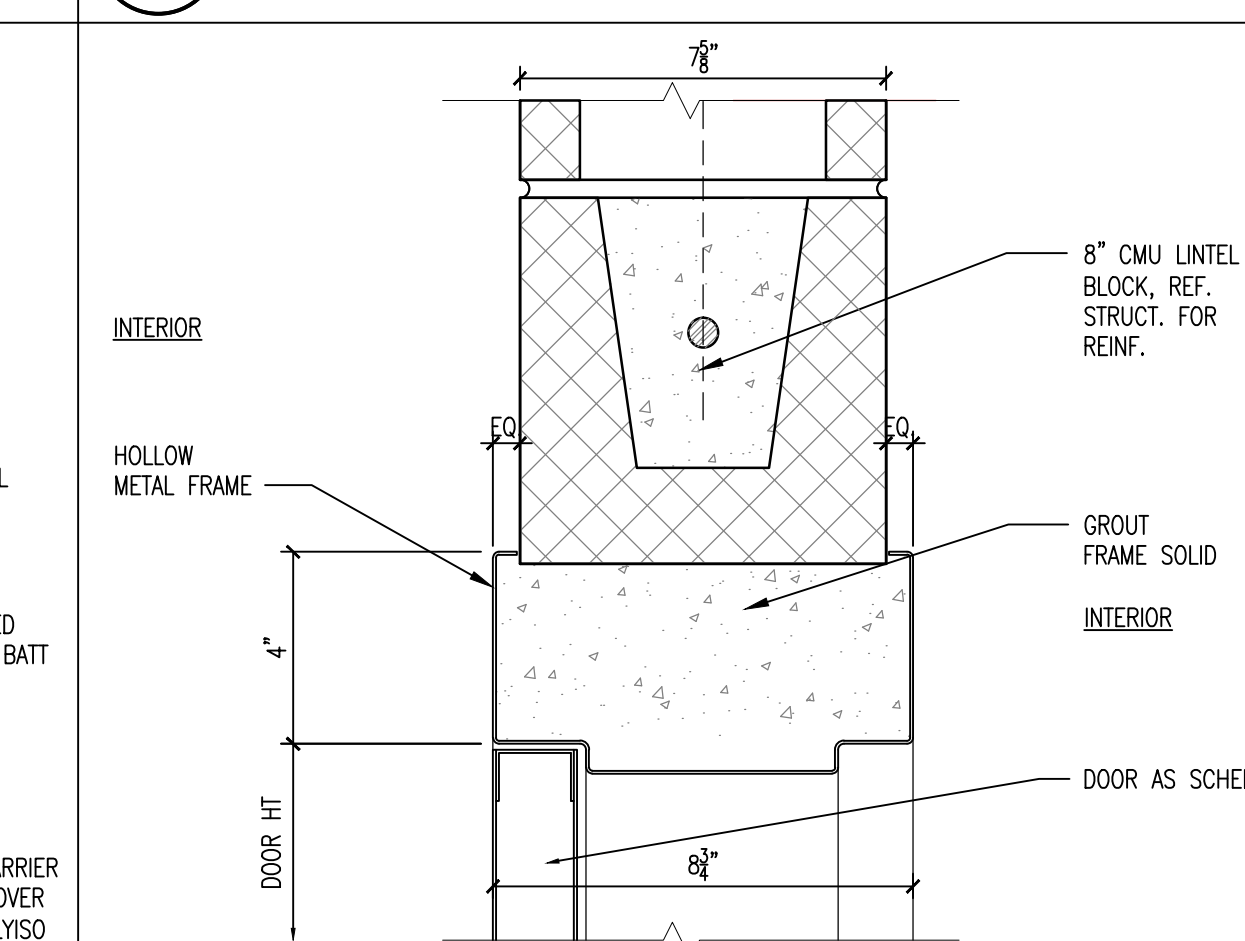


7 HM DOOR DETAIL - HEAD
SCALE: 3" = 1'-0"

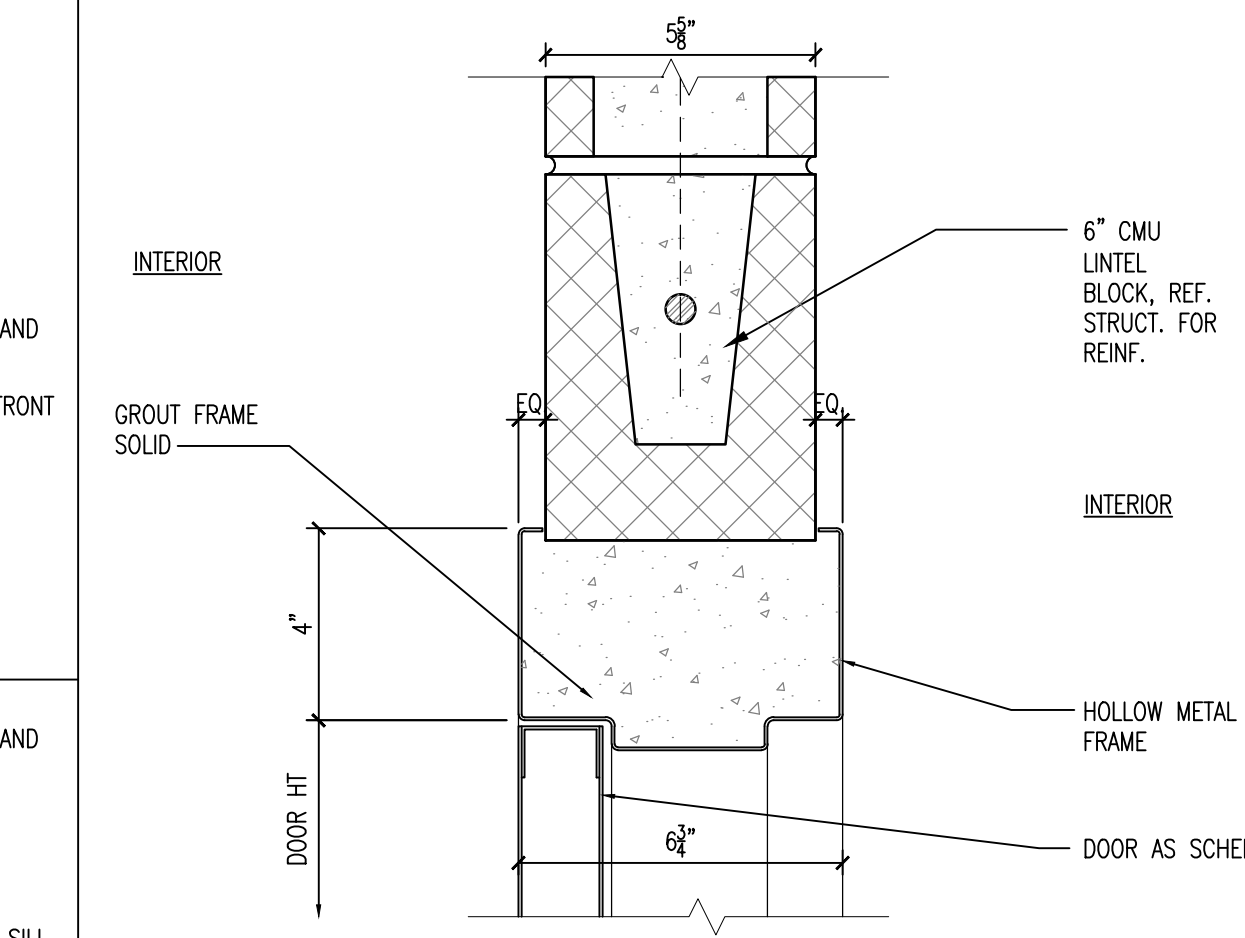

10 HM DOOR DETAIL - HEAD
SCALE: 3" = 1'-0"

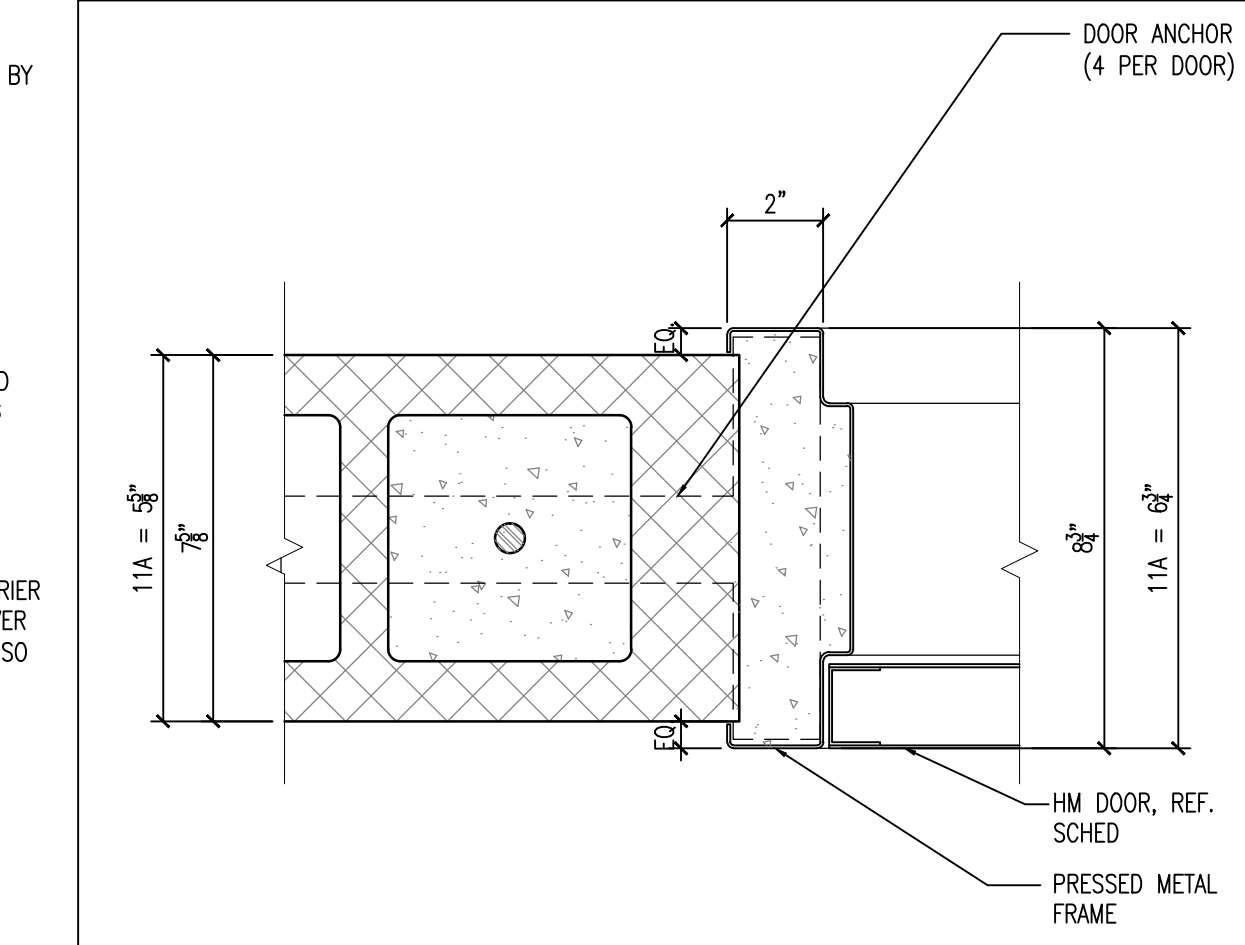

11 HM DOOR DETAIL - JAMB
SCALE: 3" = 1'-0"

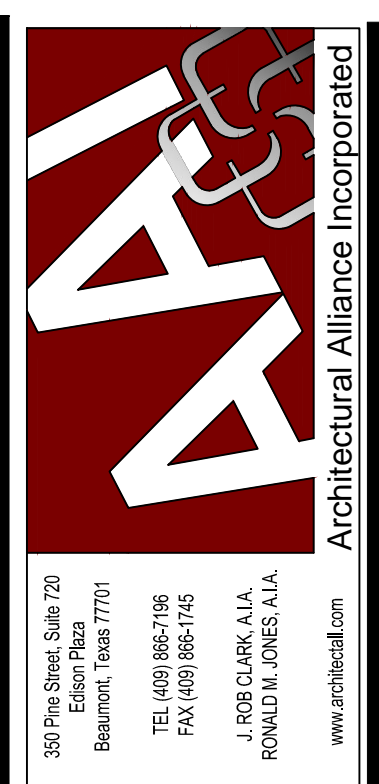


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| DATE: _____ | |
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| DATE: 4/18/2022 | |
| REVISION: | DATE: _____ |
| REVISION: | DATE: _____ |
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| DRAWINGS SHEET TITLE | |
| DOOR AND WINDOW DETAILS | |
| SHEET NUMBER | A202 |
| PROJECT NUMBER | 21021 |

SAVED: MICHAELM
PLOT: MICHAELM\G1TAN
PLOT DATE: 4/19/2022 8:23 AM
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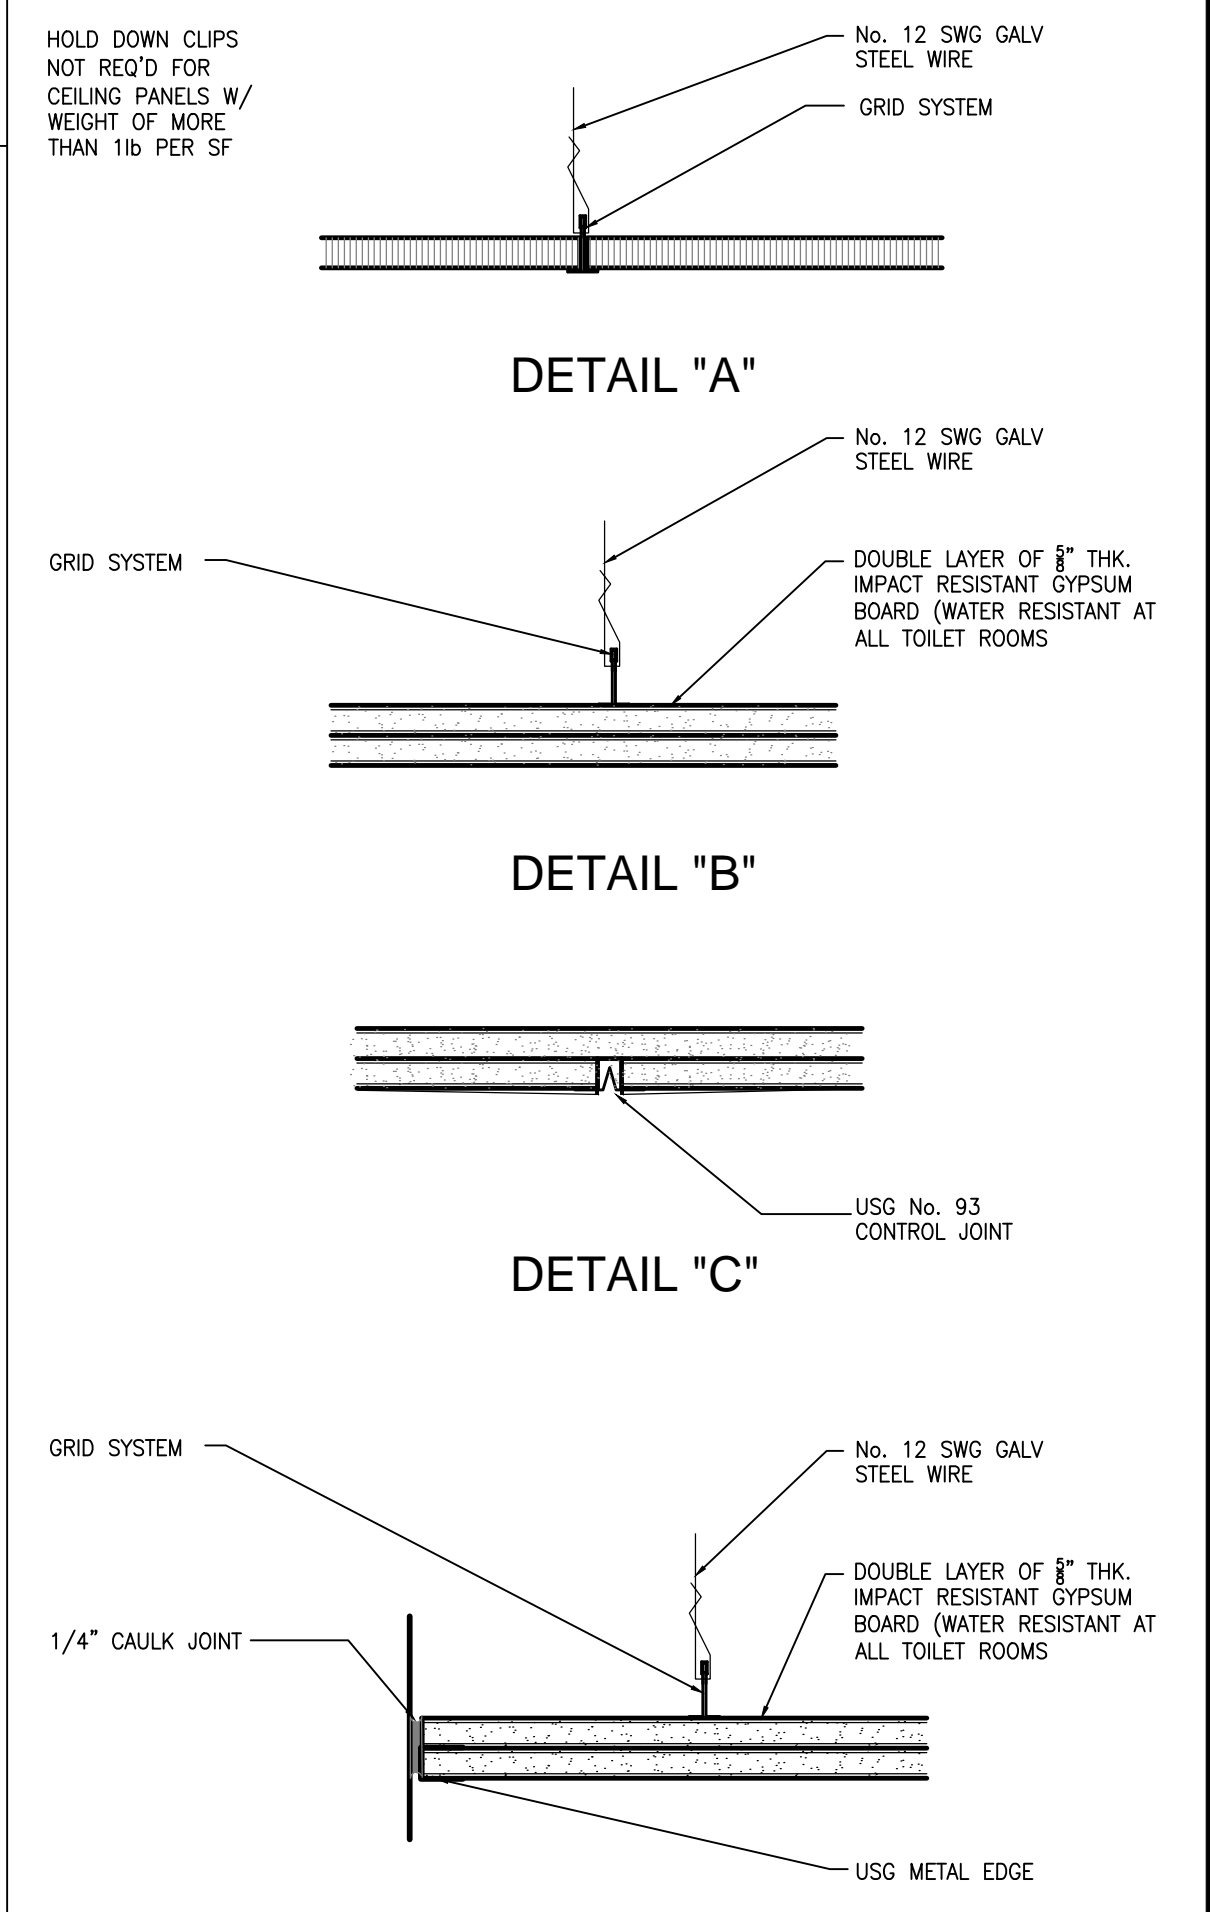


1 REFLECTED CEILING PLAN
SCALE: 1/8" = 1'-0"



CEILING LEGEND
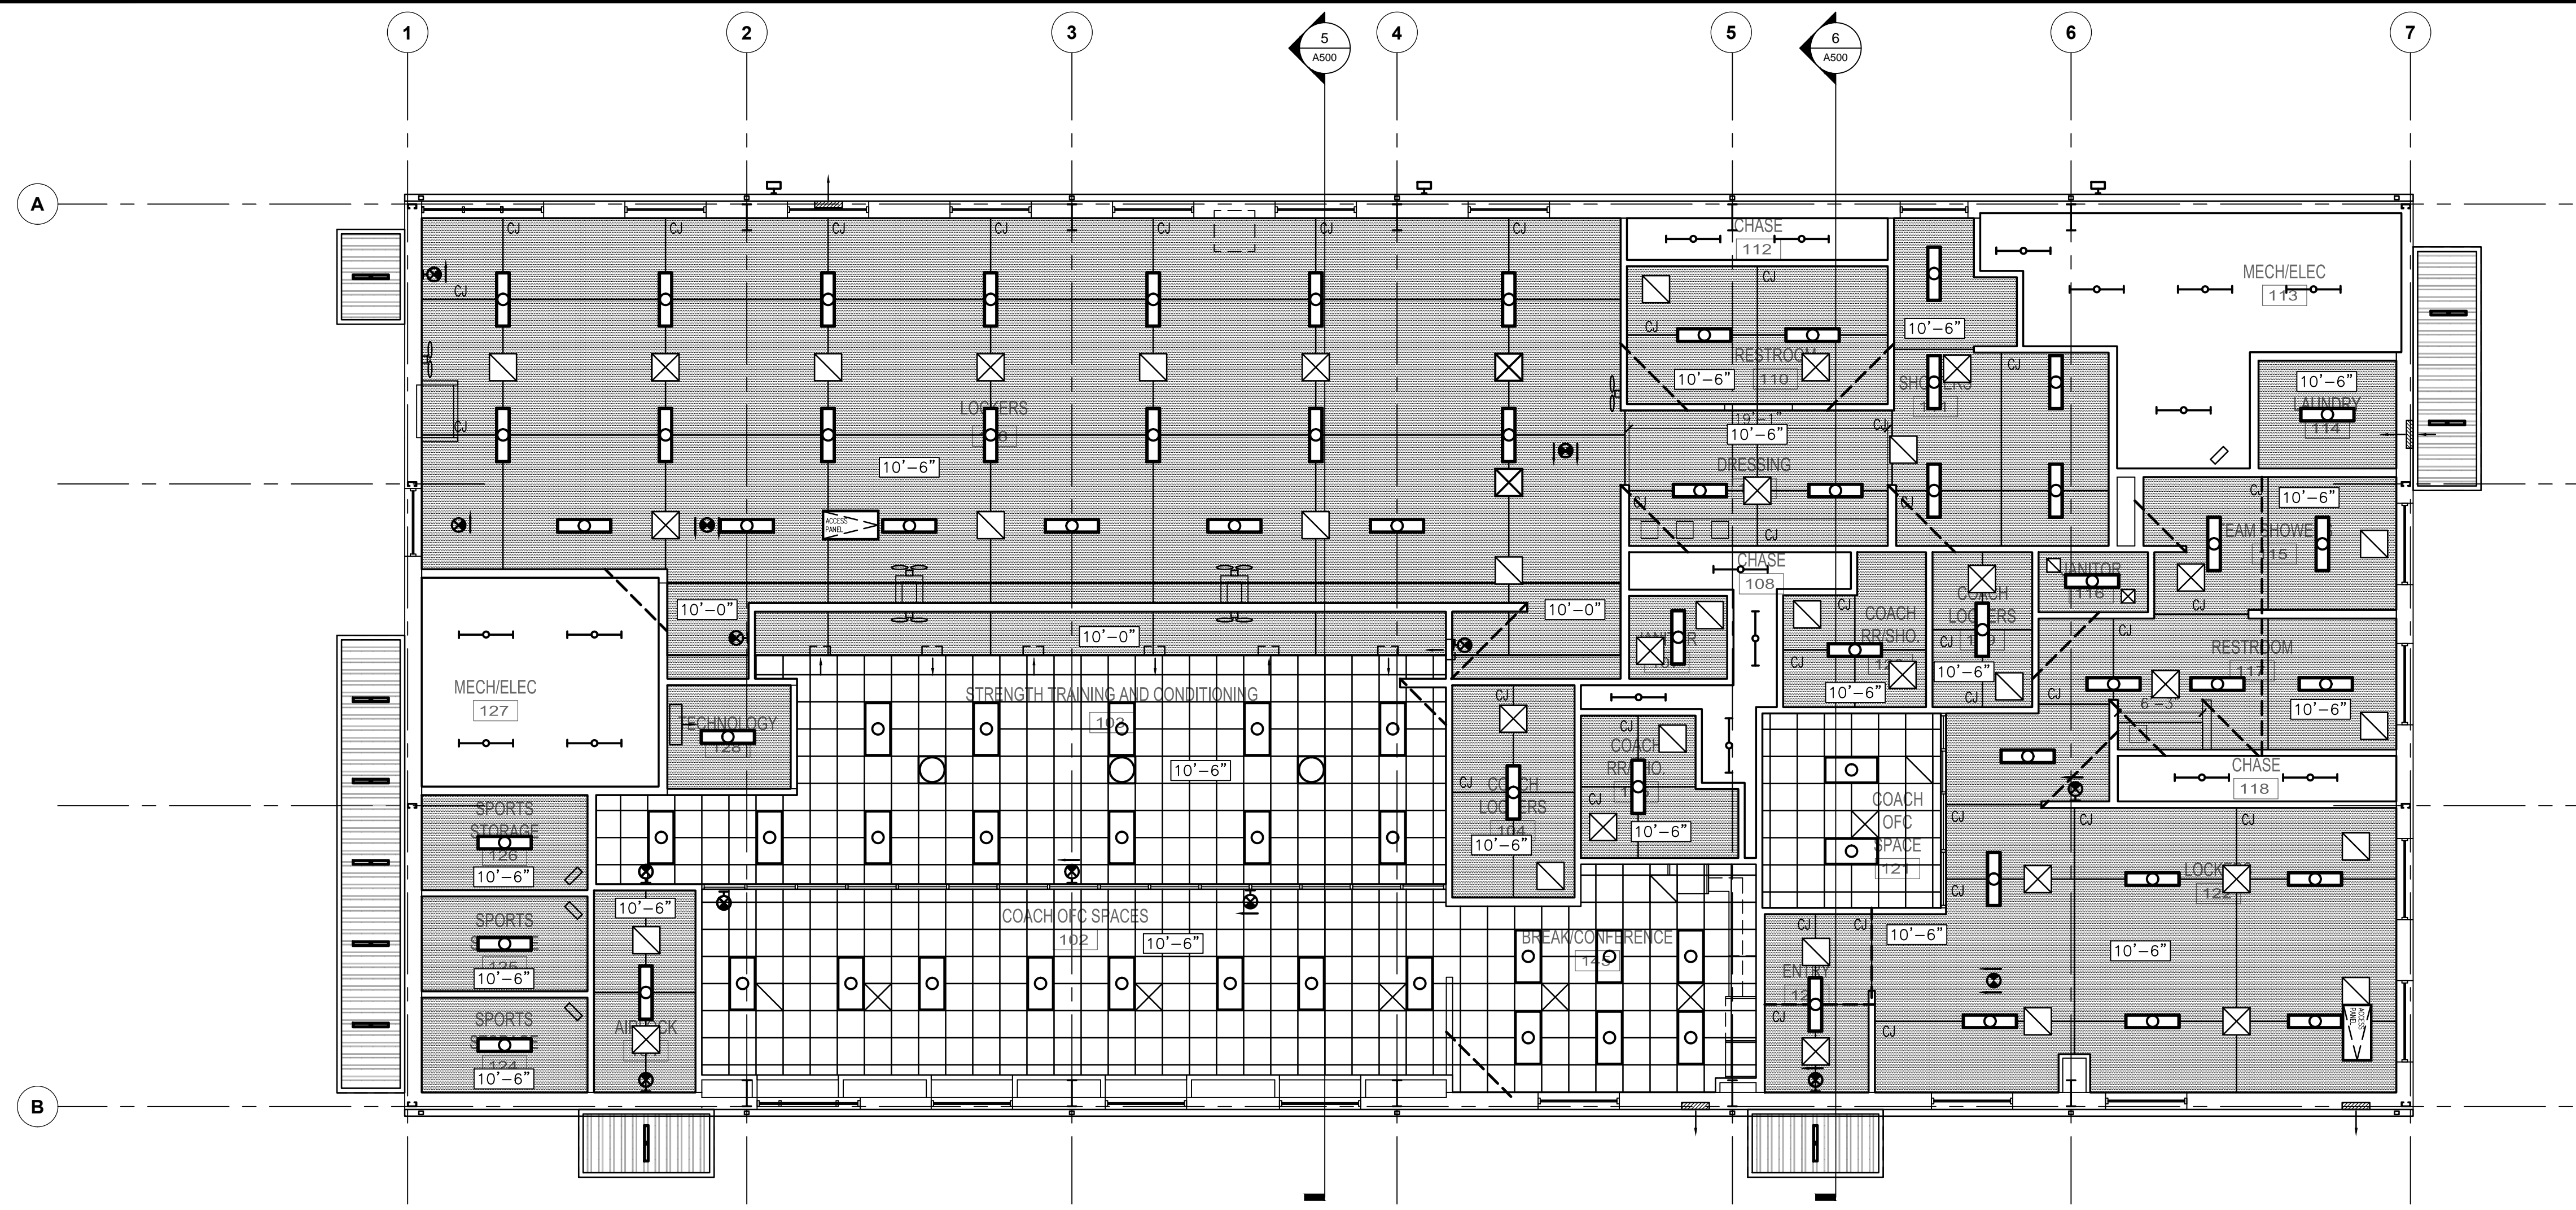
| | | | |
|--|---|--|---|
| | 2'-0" x 2'-0" ACOUST. CEILING TILES ON TEE GRID SUSPENSION SYSTEM | | CAN LIGHT, REF. MEP DWGS. |
| | 2 LAYERS OF 5/8" HIGH IMPACT XP MOISTURE RESISTANT GYPSUM BOARD ON TEE GRID SUSPENSION SYSTEM | | WALL MOUNTED LIGHT FIXTURE, REF. MEP DRAWINGS |
| | 2X4 LED LIGHT FIXTURE, REF. MEP DRAWINGS | | SURFACE MOUNTED STRIP LIGHT FIXTURE, REF. MEP DRAWINGS |
| | 2X2 LED LIGHT FIXTURE, REF. MEP DRAWINGS | | SUSP. STRIP LIGHT FIXTURE, REF. MEP DRAWINGS |
| | 1X4 LED LIGHT FIXTURE, REF. MEP DRAWINGS | | CEILING REGISTERS, REF. MEP DRAWINGS |
| | WALL MOUNTED EXIT LIGHT (DIRECTIONS, AS SHOWN) | | E.S. EXPOSED STRUCTURE |
| | CEILING MOUNTED EXIT LIGHT (DIRECTIONS, AS SHOWN) | | SOLATURE DAYLIGHTING SYSTEM AND CURB (14 TOTAL) |
| | | | 48X24 ALUM. POWDER COATE ACCESS PANEL (WHITE), VER. FINAL LOCATION AND HINGING WITH MEP DRAWINGS. |
| | | | 3X3X1/2" STEEL ANGLE WALL BRACE, TYPICAL, REF. STRUCT. |

- ### CEILING NOTES
- 2'-0" x 2'-0" ACOUSTICAL CEILING TILES ON SUSPENDED TEE GRID SYSTEM.
 - 2 LAYERS OF 5/8" HIGH IMPACT XP MOISTURE RESISTANT GYPSUM BOARD
 - ALL CEILING HEIGHT IS 10'-6" A.F.F. TYPICAL UNLESS NOTED OTHERWISE.
 - PROVIDE UNFACED BATT INSULATION ABOVE SUSPENDED ACOUSTICAL CEILING TILES AT TOILET FOR SOUND CONTROL.
 - KYNAR FINISH GUTTER AND DOWNSPOUT, TYP. REF. ROOF PLAN
 - UNDERSIDE OF PRE-ENGINEERED WALL HUNG METAL CANOPY (KYNAR FINISH)
 - EXPOSED UNDERSIDE OF STRUCTURE TO RECEIVE PAINT FINISH. ALL EXPOSED STEEL MATERIALS SHALL BE PRIMED AND PAINTED. VERIFY COLOR



2 CEILING DETAILS
SCALE: 3" = 1'-0"

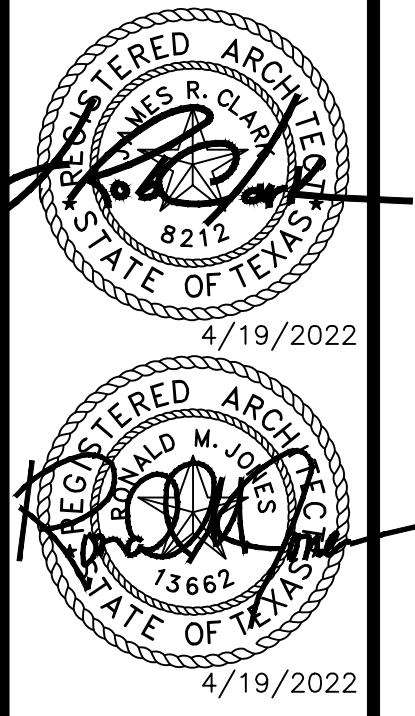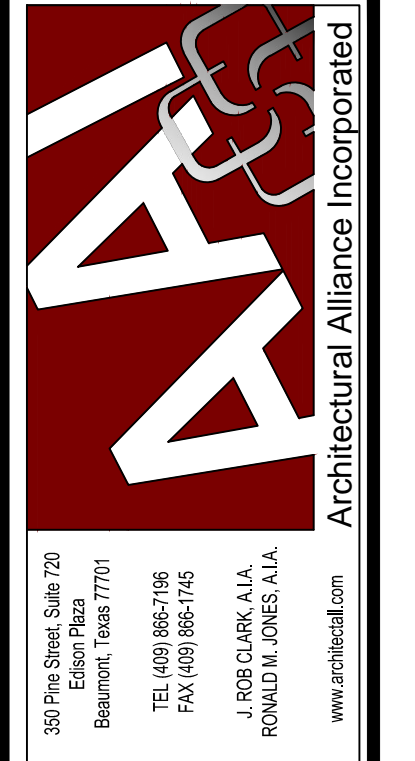


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| DATE: 4/18/2022 | |
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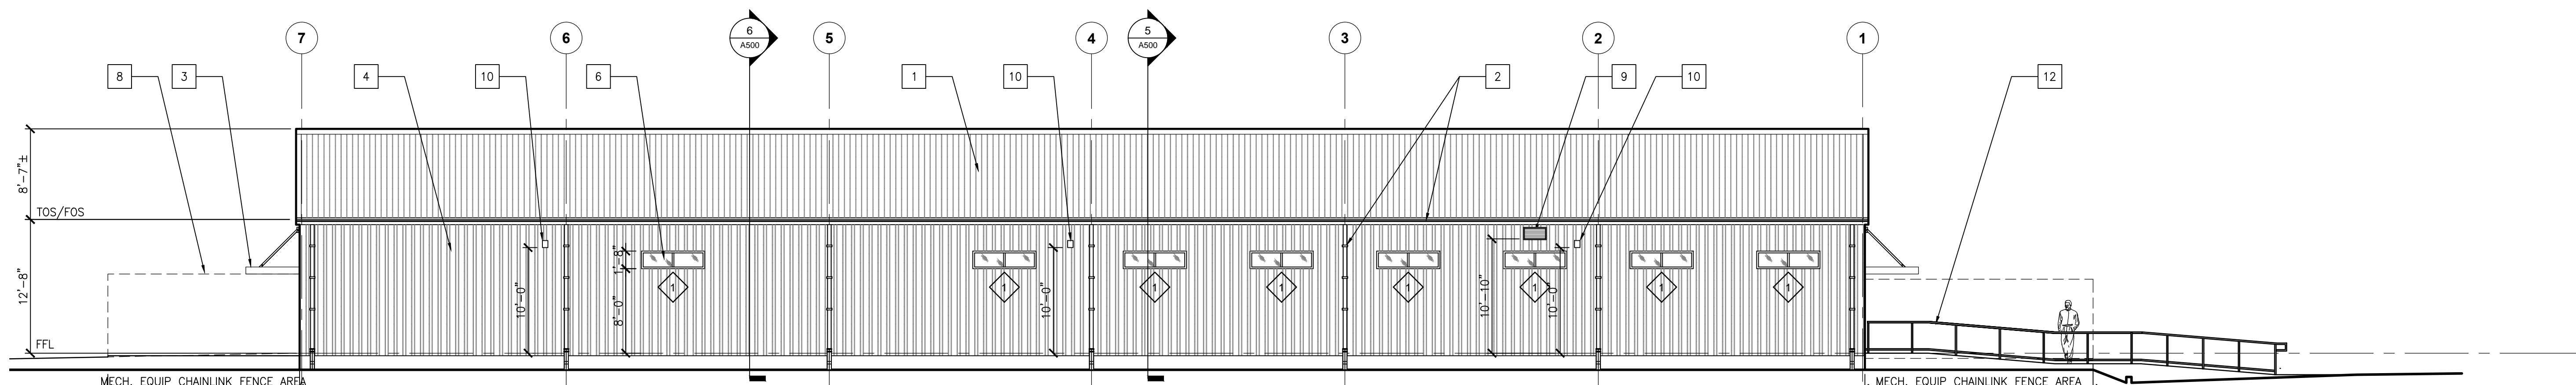
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| SHEET NUMBER | A301 |
| PROJECT NUMBER | 21021 |

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PLOT DATE: 4/19/2022 8:23 AM
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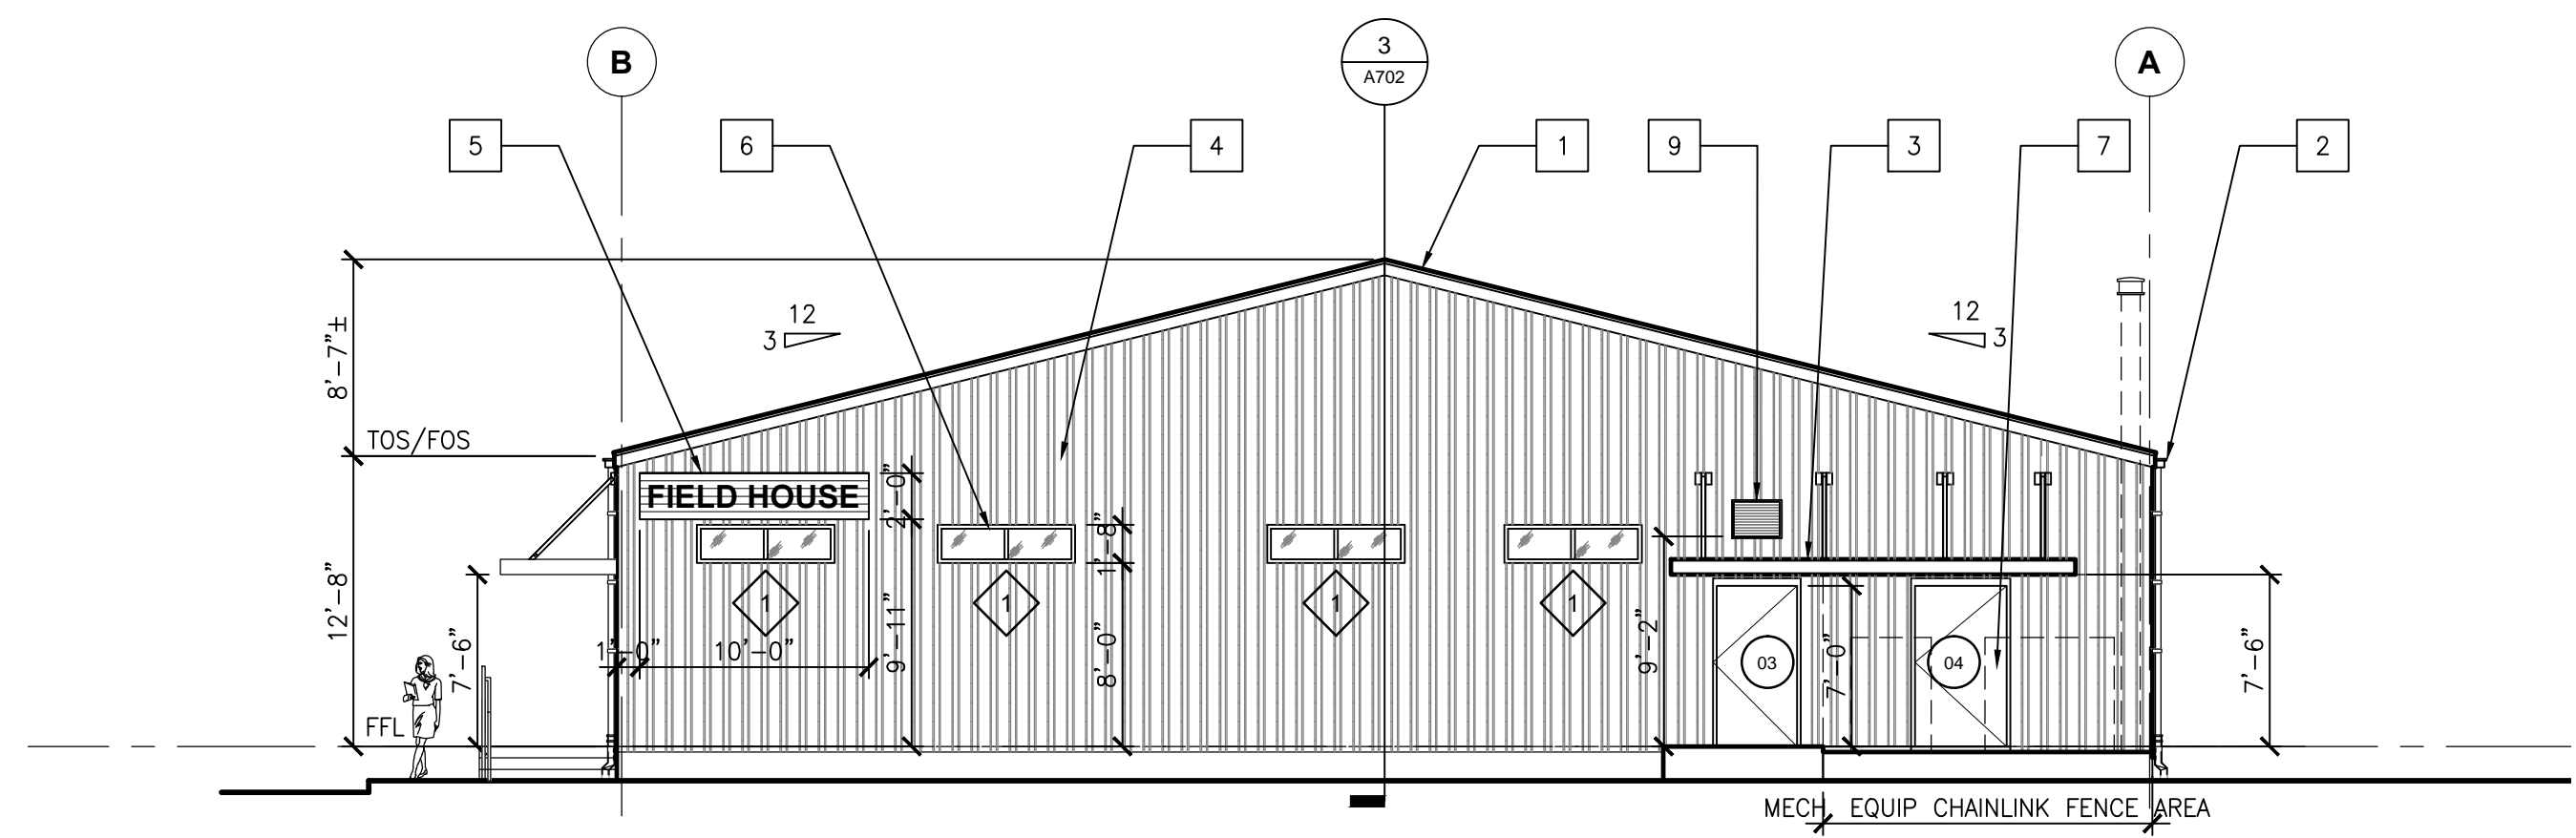


1 SOUTH ELEVATION
SCALE: 1/8" = 1'-0"


- ### KEYNOTES
1. KYNAR FINISH STANDING SEAM METAL ROOF - TDI RATED AND CERTIFIED FOR 144 MPH WINDSTORM RATING
 2. KYNAR FINISH GUTTER WITH WIRE GUARD COVER AND DOWNSPOUTS WITH CAST IRON BOOTS. TYPICAL
 3. KYNAR FINISH WALL-HUNG CANOPY WITH BRACKETS BY PEMB. - TDI RATED AND CERTIFIED FOR 144 MPH WINDSTORM RATING. REF. ELECT. FOR VAPOR SEALED SOFFIT LIGHTING.
 4. KYNAR FINISH "R" METAL PANELS
 5. WOOD-LOOK ALUMINUM SIDING ACCENT PANELS WITH 12" HIGH METALLIC FINISH ALUM. LETTERS WITH STAND-OFF
 6. ALUMINUM STOREFRONT WINDOWS - TDI RATED AND CERTIFIED FOR 144 WINDSTORM RATING, REF. WINDOW SCHED.
 7. INSULATED HOLLOW METAL EXTERIOR DOOR AND FRAME, TDI RATED AND CERTIFIED FOR 144 MPH WINDSTORM RATING, REF. DOOR SCHED.
 8. 7'-6" HIGH GALV. CHAINLINK FENCE WITH 3" DIA. SCHED. 40 POSTS SPACED @ 6'-0" O.C., 2-3/8" SCHED. 40 TOP AND BOTTOM SUPPORT RAILS AND 2" MESH WITH TWIST KNUCKLE CONFIG.; AROUND MECHANICAL ENCLOSURE. PROVIDE 6'-0" WIDE PAIR GATES AT WEST ENCLOSURE AND SINGLE 4'-0" WIDE GATE AT EAST ENCLOSURE WITH LOCKING HARDWARE(S).
 9. KYNAR FINISH EXHAUST LOUVER, REF. MECHANICAL DRAWINGS
 10. EXTERIOR WALL MOUNTED FIXTURE(S), REF. ELECTRICAL DRAWINGS
 11. KYNAR FINISH EXHAUST LOUVER OVER WOOD-LOOK ALUMINUM SIDING ACCENT PANEL. TOTAL OF (2). REF. SIGNAGE PLAN FOR MOUNTING HEIGHT.
 12. TDLR COMPLIANT CONCRETE RAMP AND STEPS WITH 1 1/2" DIA. HOT DIPPED GALVANIZED PROTECTIVE GUARDS AND HAND RAILS. TYPICAL
 13. 2-LAYERS OF IMPACT RESISTANT GYPSUM BOARD AND 2" INPRO 150 HIGH IMPACT VINYL CORNER GUARD. VERIFY COLOR.

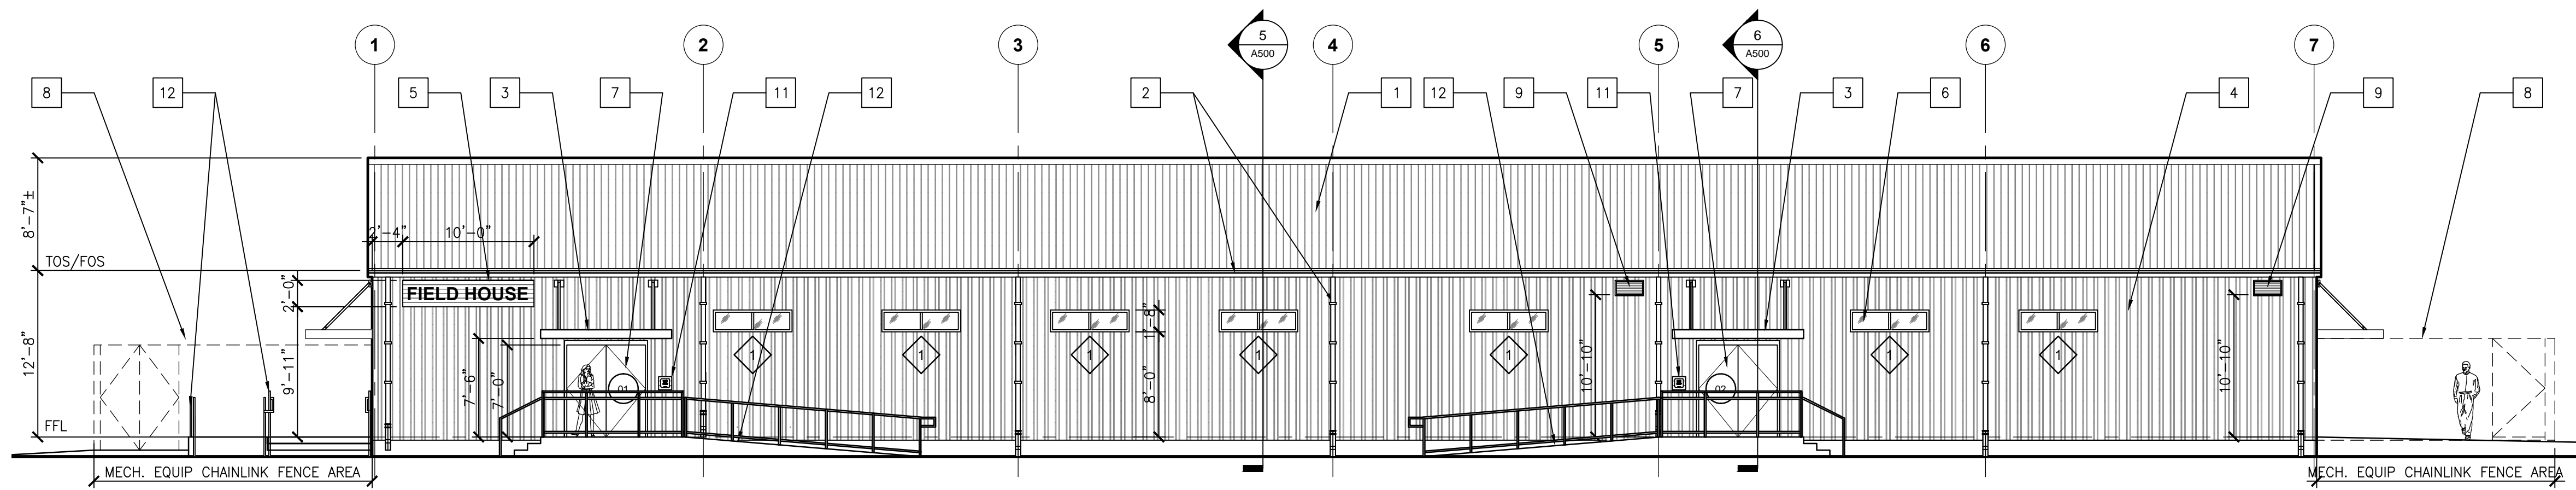


2 NORTH ELEVATION
SCALE: 1/8" = 1'-0"




3 EAST ELEVATION
SCALE: 1/8" = 1'-0"

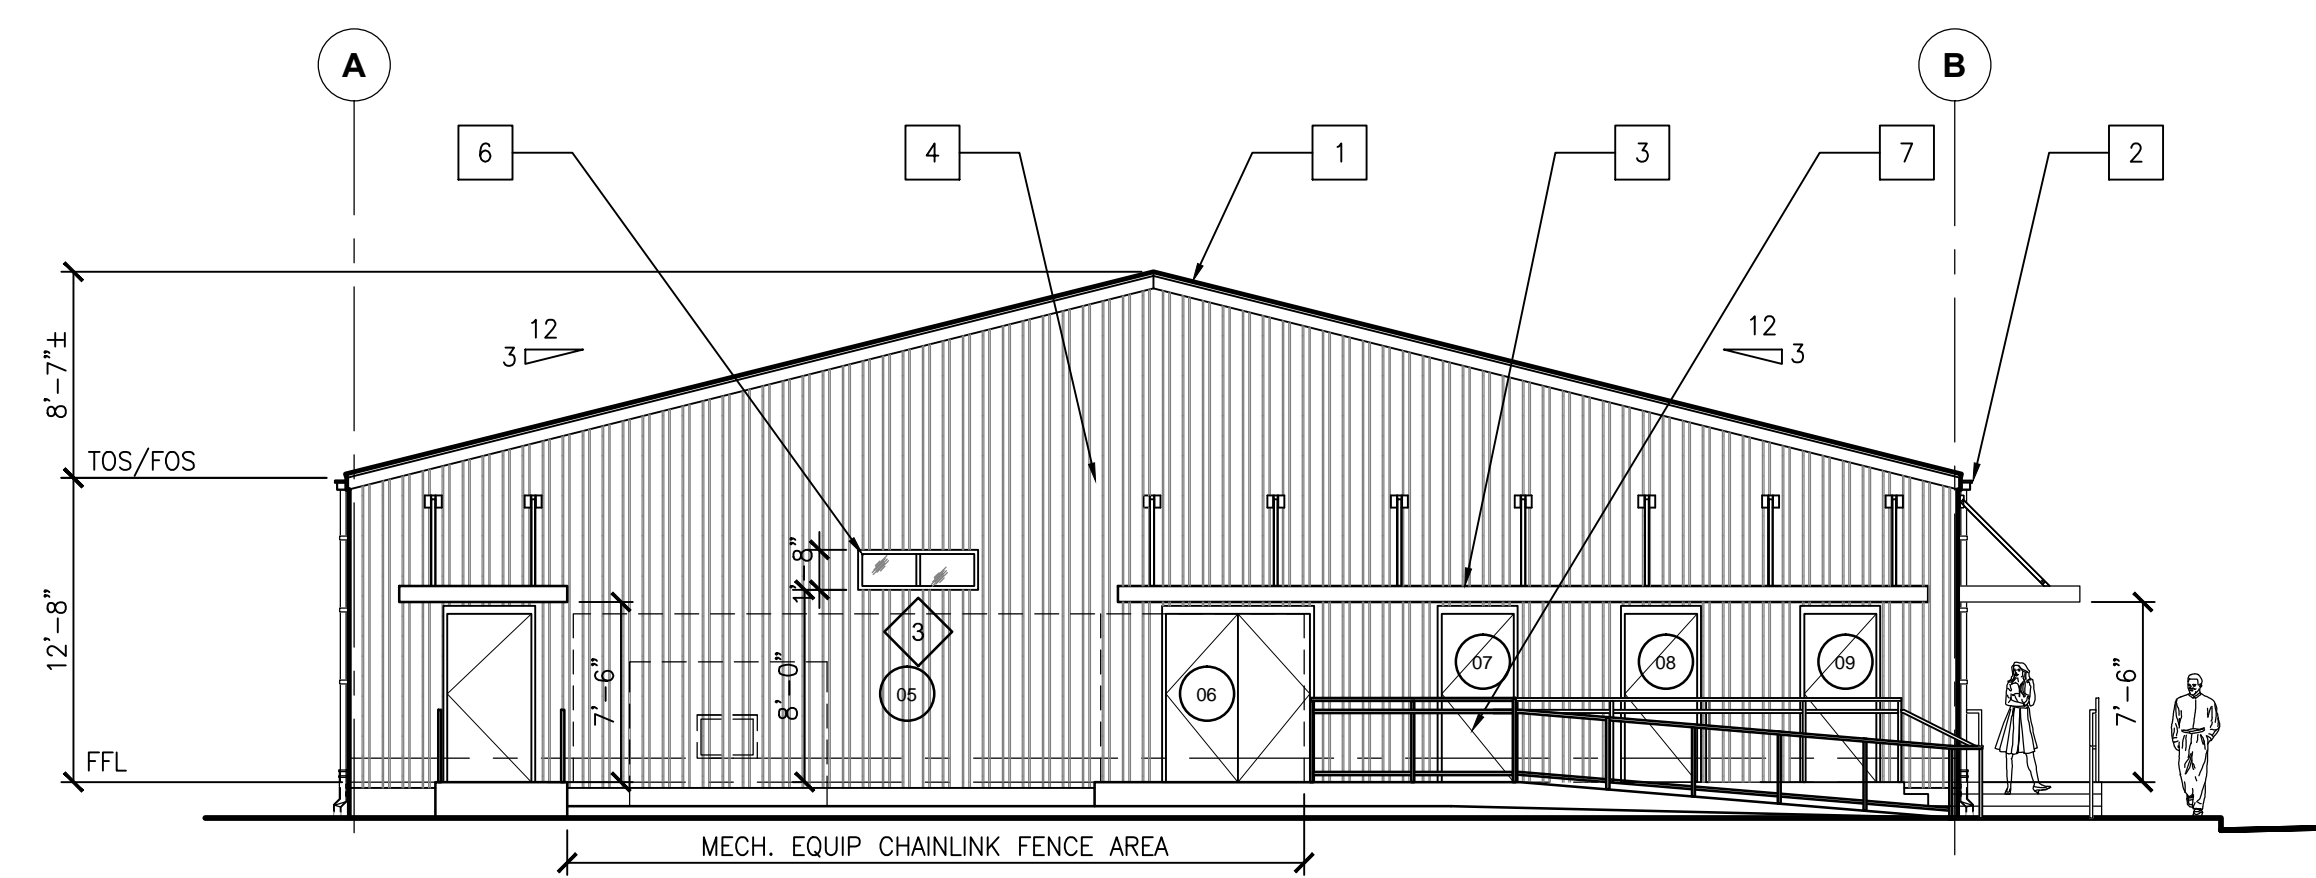


4 WEST ELEVATION
SCALE: 1/8" = 1'-0"

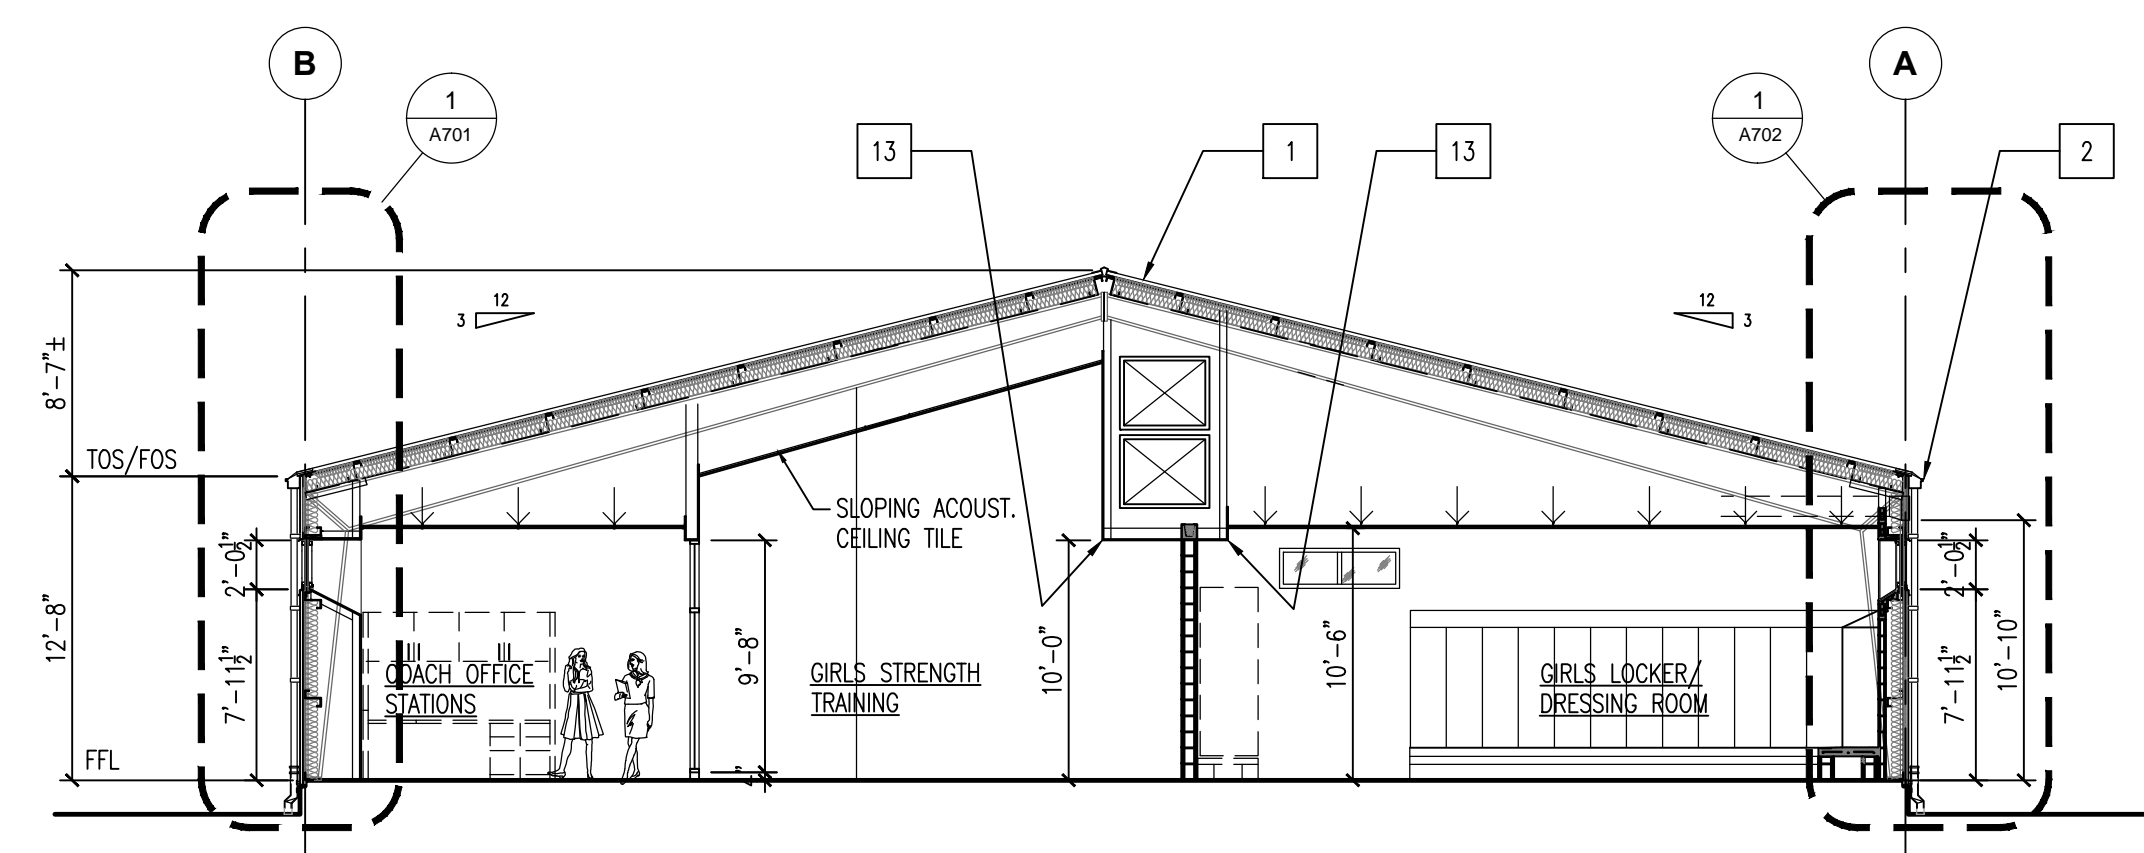


5 CROSS SECTION
SCALE: 1/8" = 1'-0"

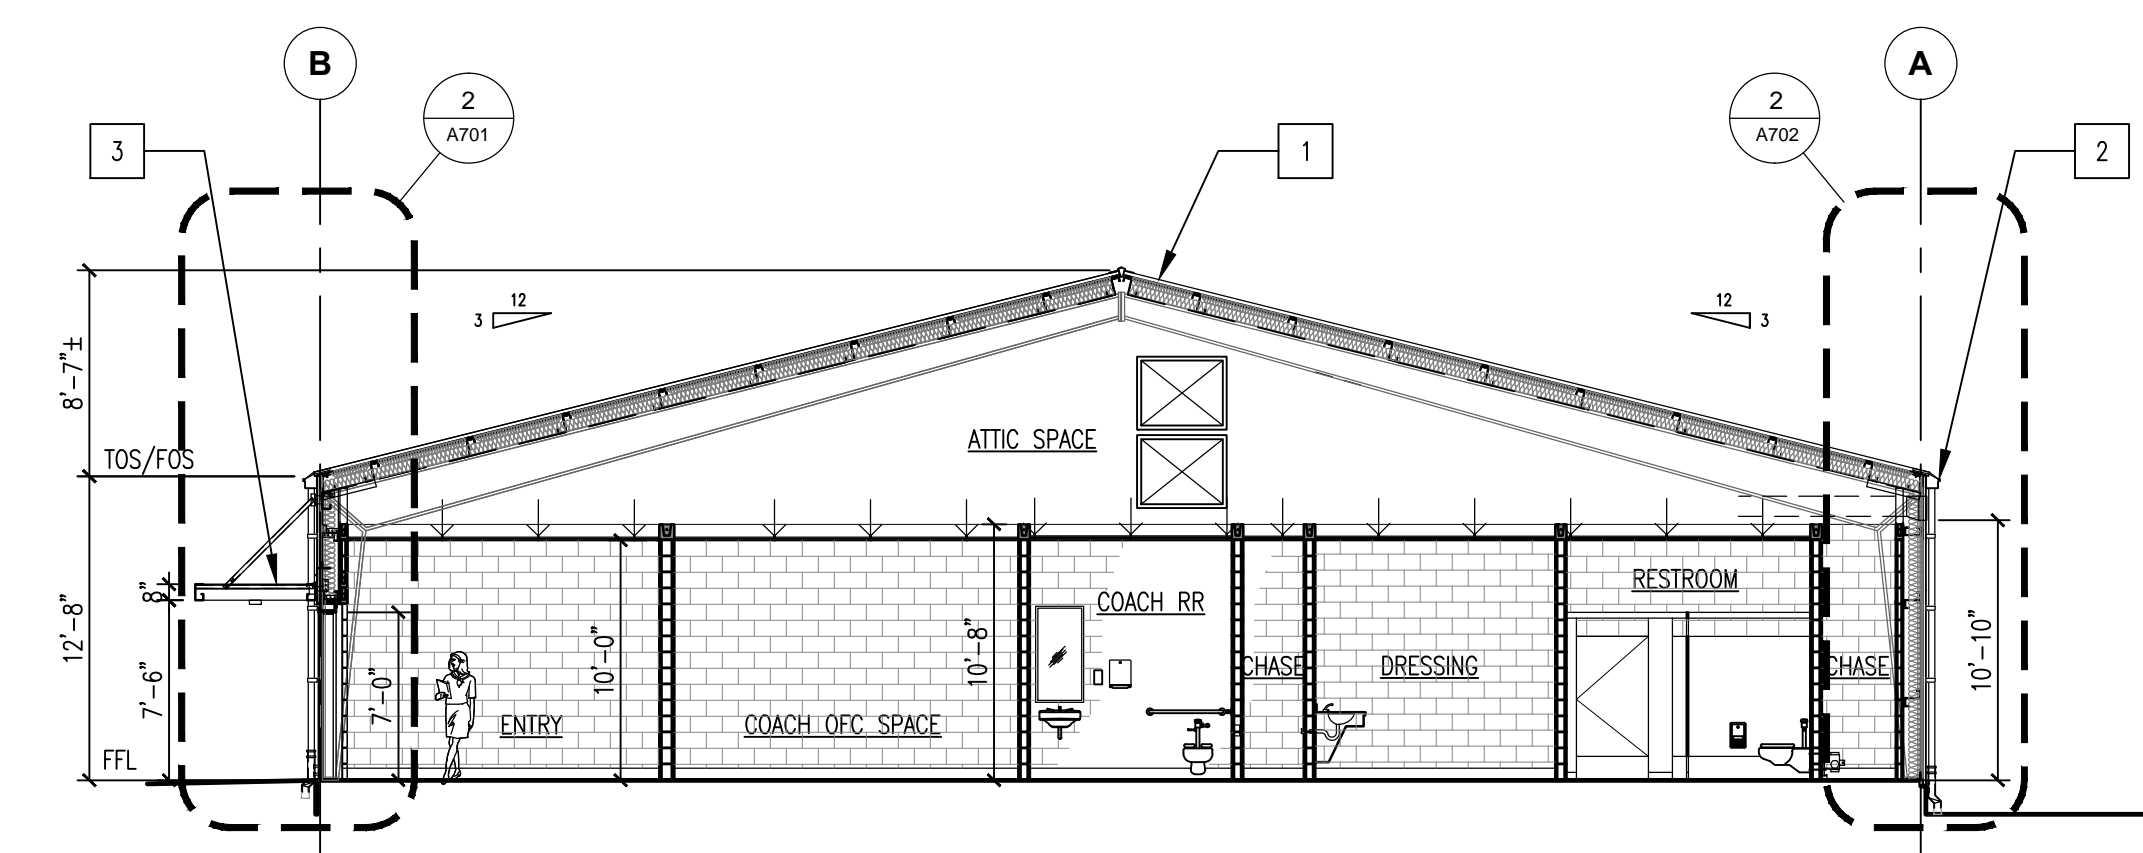

6 CROSS SECTION
SCALE: 1/8" = 1'-0"

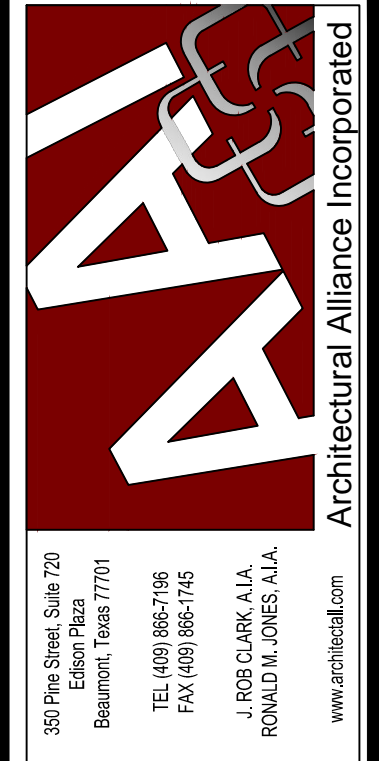

3075 S.W. 10th Street
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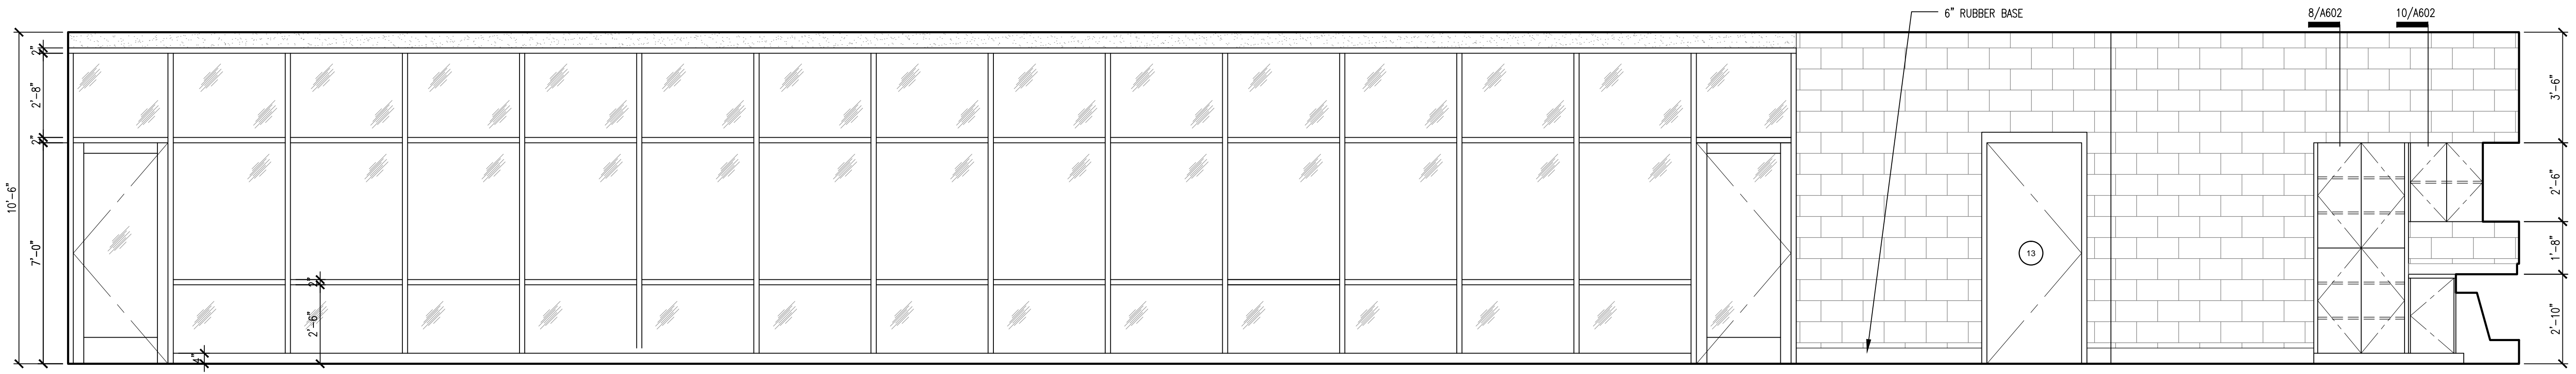
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| DATE: 4/18/2022 | |
| REVISION: | |
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| DATE: | |
| REVISION: | |
| DATE: | |

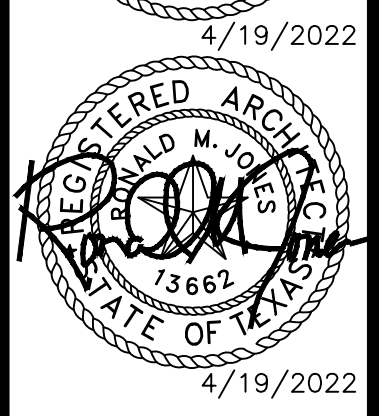DRAWINGS SHEET TITLE
EXTERIOR ELEVATIONS & BUILDING SECTIONS


SHEET NUMBER
A500

PROJECT NUMBER
21021


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PLOT DATE: 4/19/2022 8:24 AM
SHEET SIZE: ARCH (standard D) (36.00 x 24.00 inches)




1 COACH OFFICE SPACES 102 & BREAK/CONFERENCE 145
SCALE: 3/8" = 1'-0"

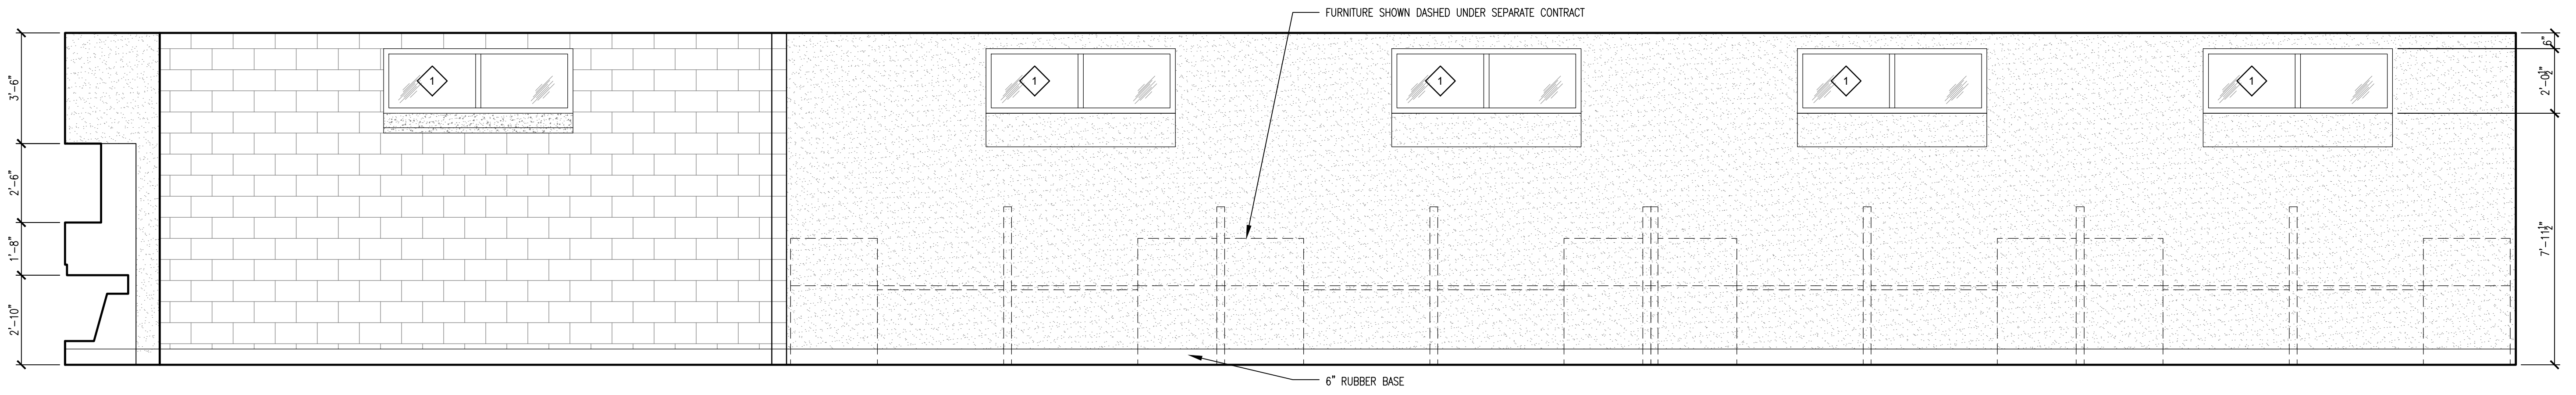


2 COACH OFFICE SPACES 102 & BREAK/CONFERENCE 145
SCALE: 3/8" = 1'-0"

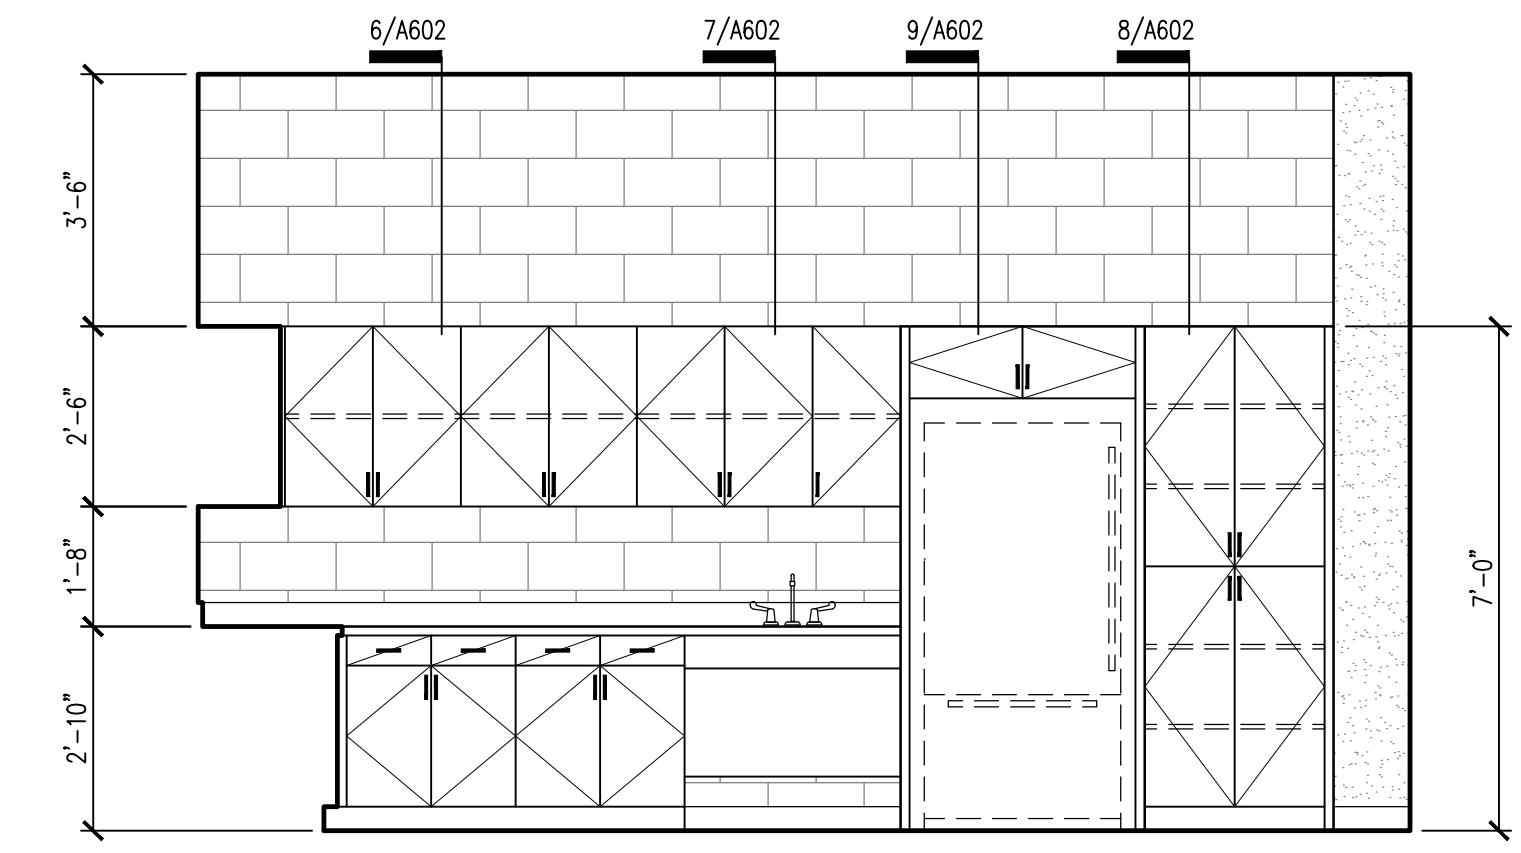


3 BREAK/ CONFERENCE 145
SCALE: 3/8" = 1'-0"

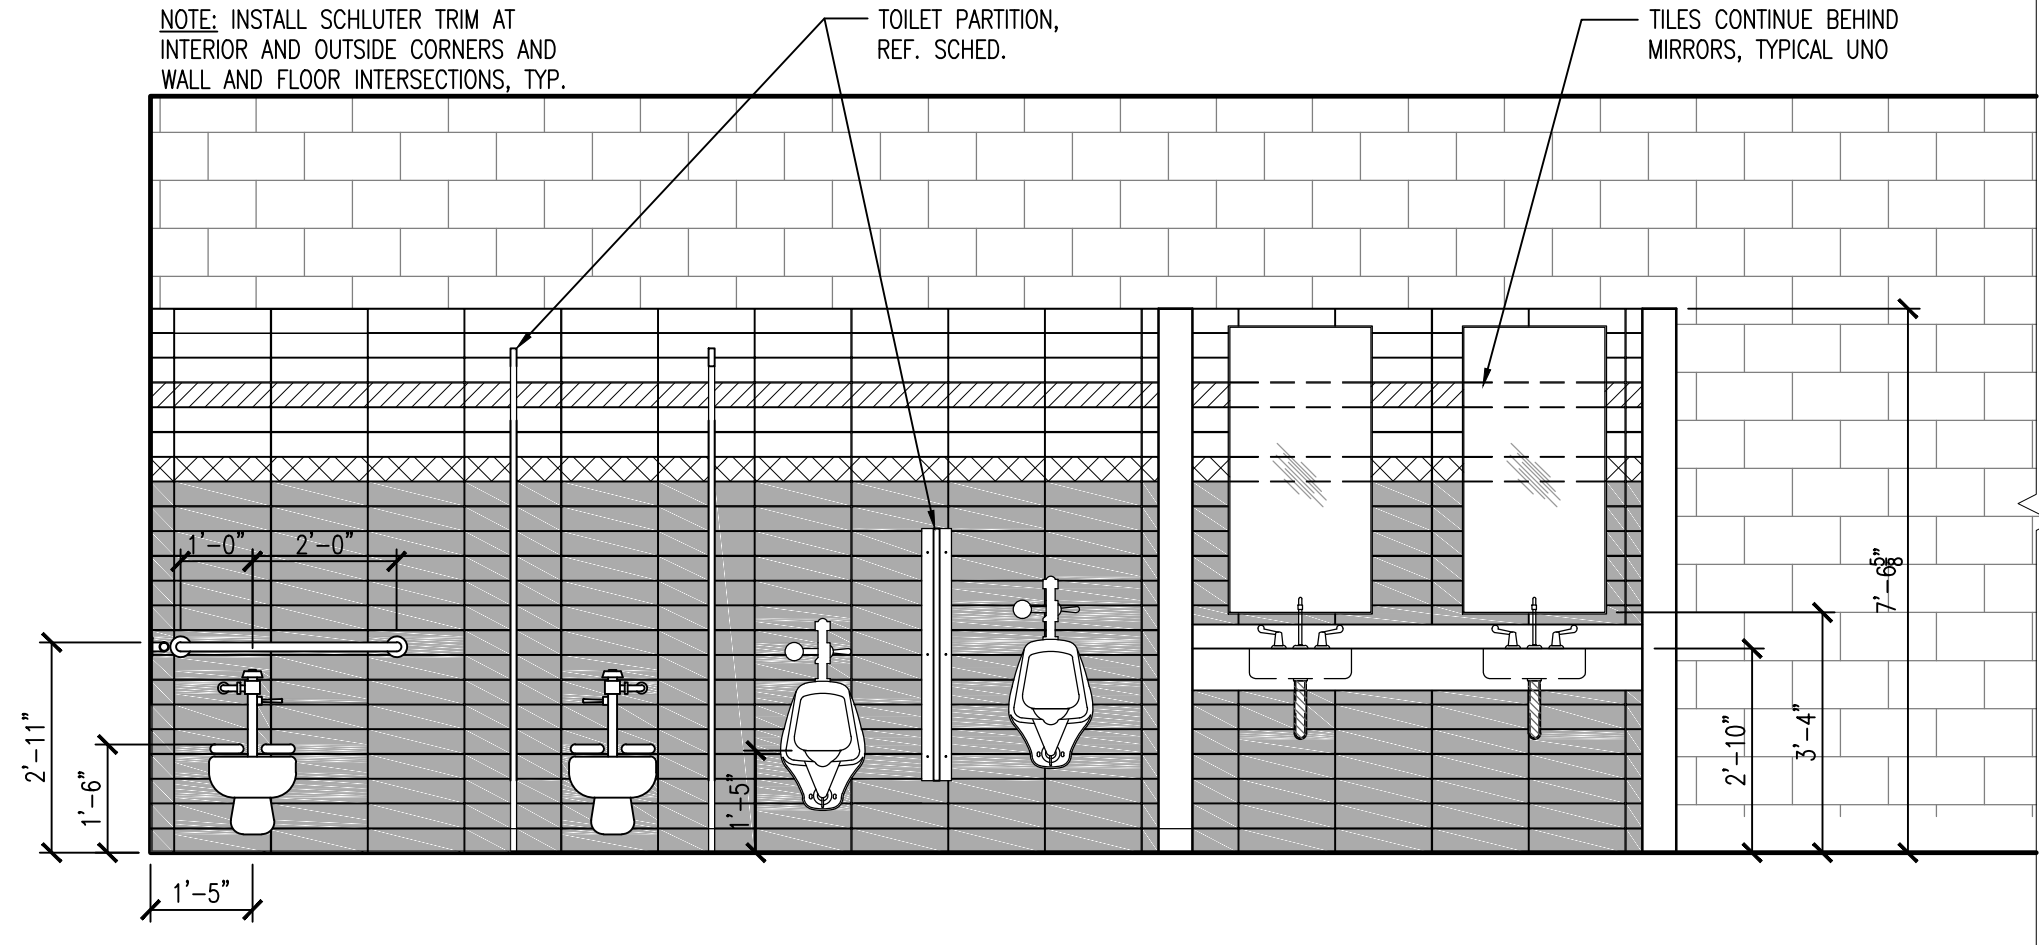


4 RESTROOM 117
SCALE: 3/8" = 1'-0"

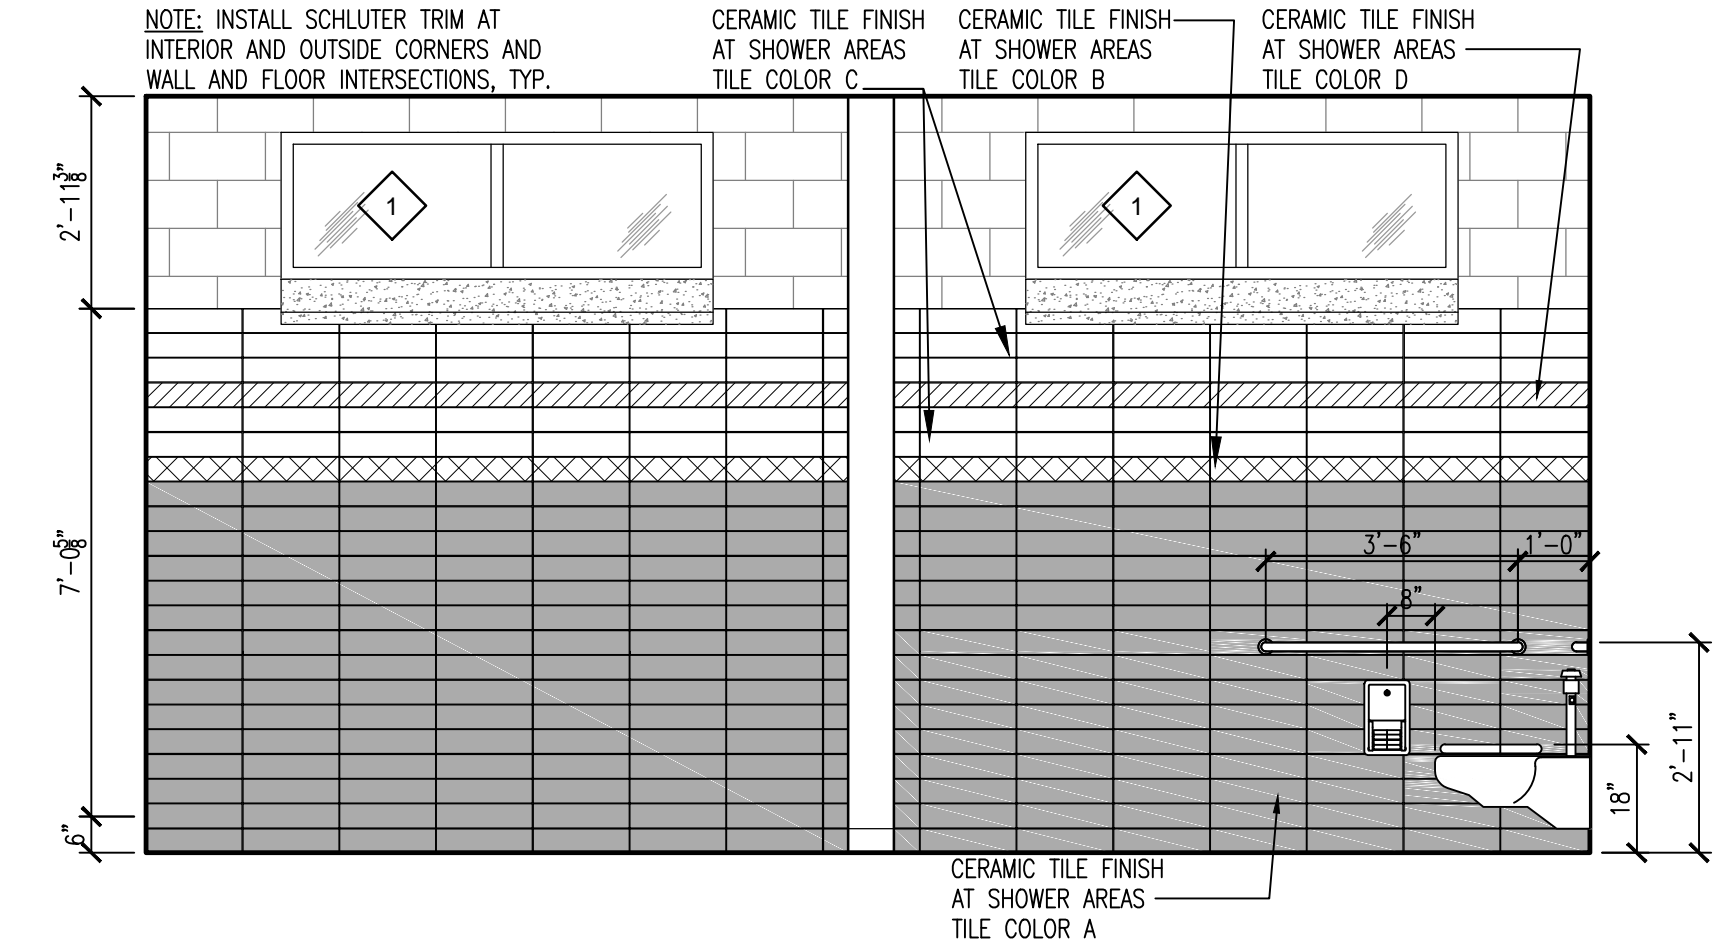


5 COACH RR/ SHOWER 120
SCALE: 3/8" = 1'-0"

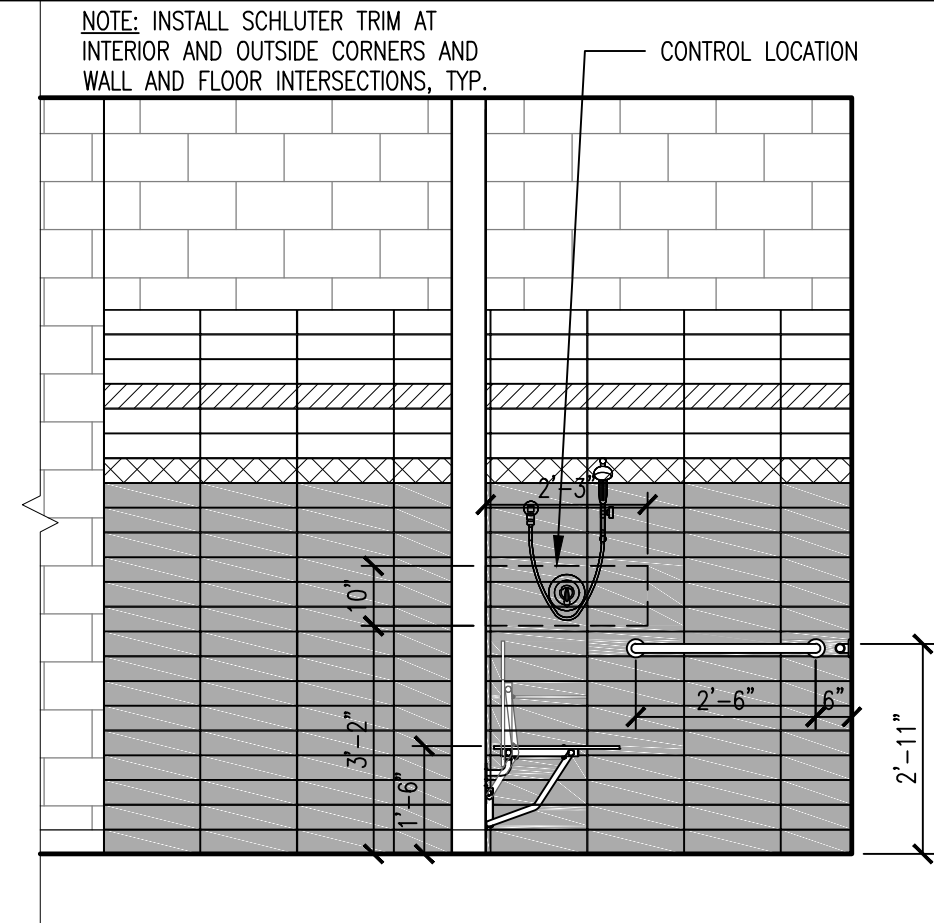


6 TEAM SHOWERS 115
SCALE: 3/8" = 1'-0"

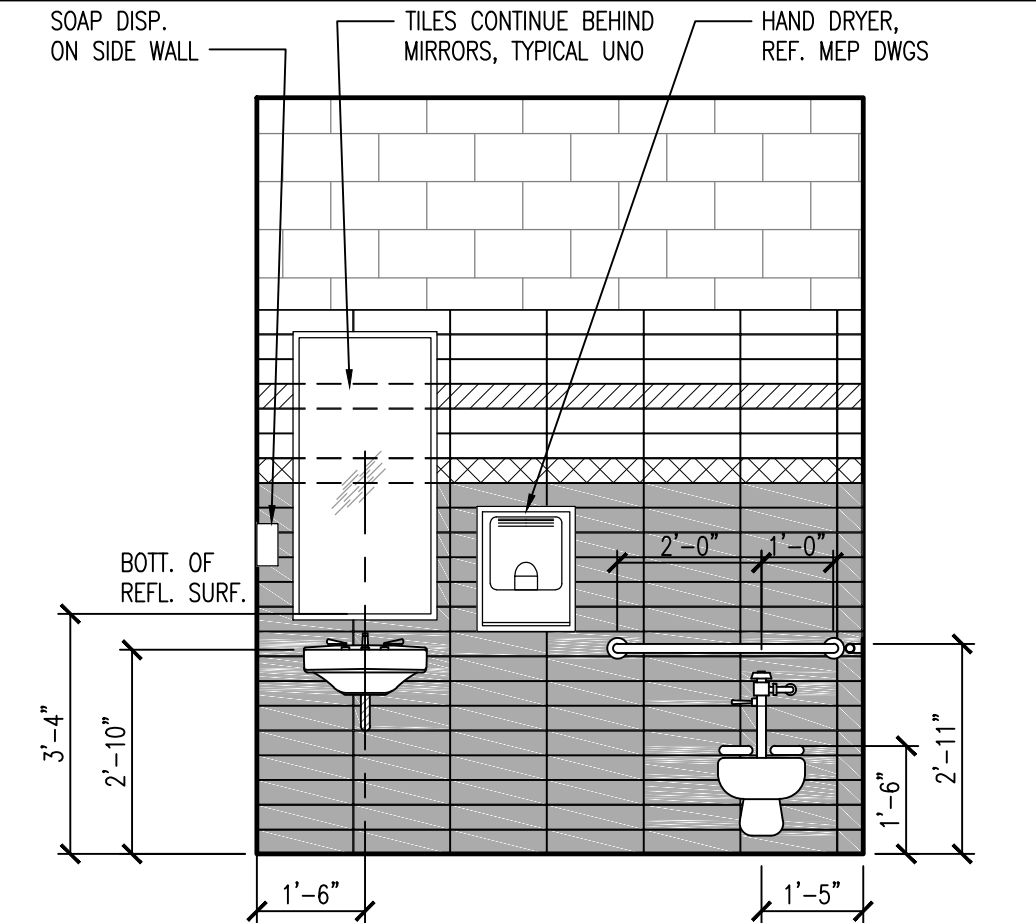




7 COACH RR/ SHO. 120 & 105
SCALE: 3/8" = 1'-0"

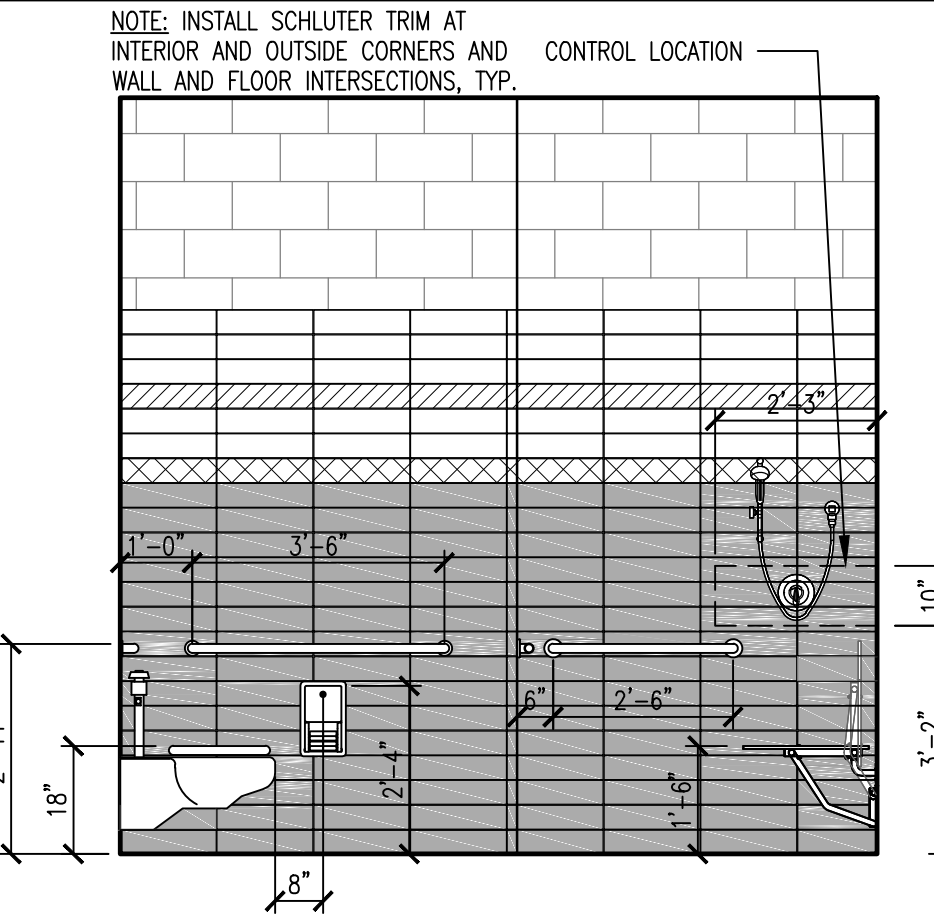

8 COACH RR/ SHO. 120 & 105
SCALE: 3/8" = 1'-0"

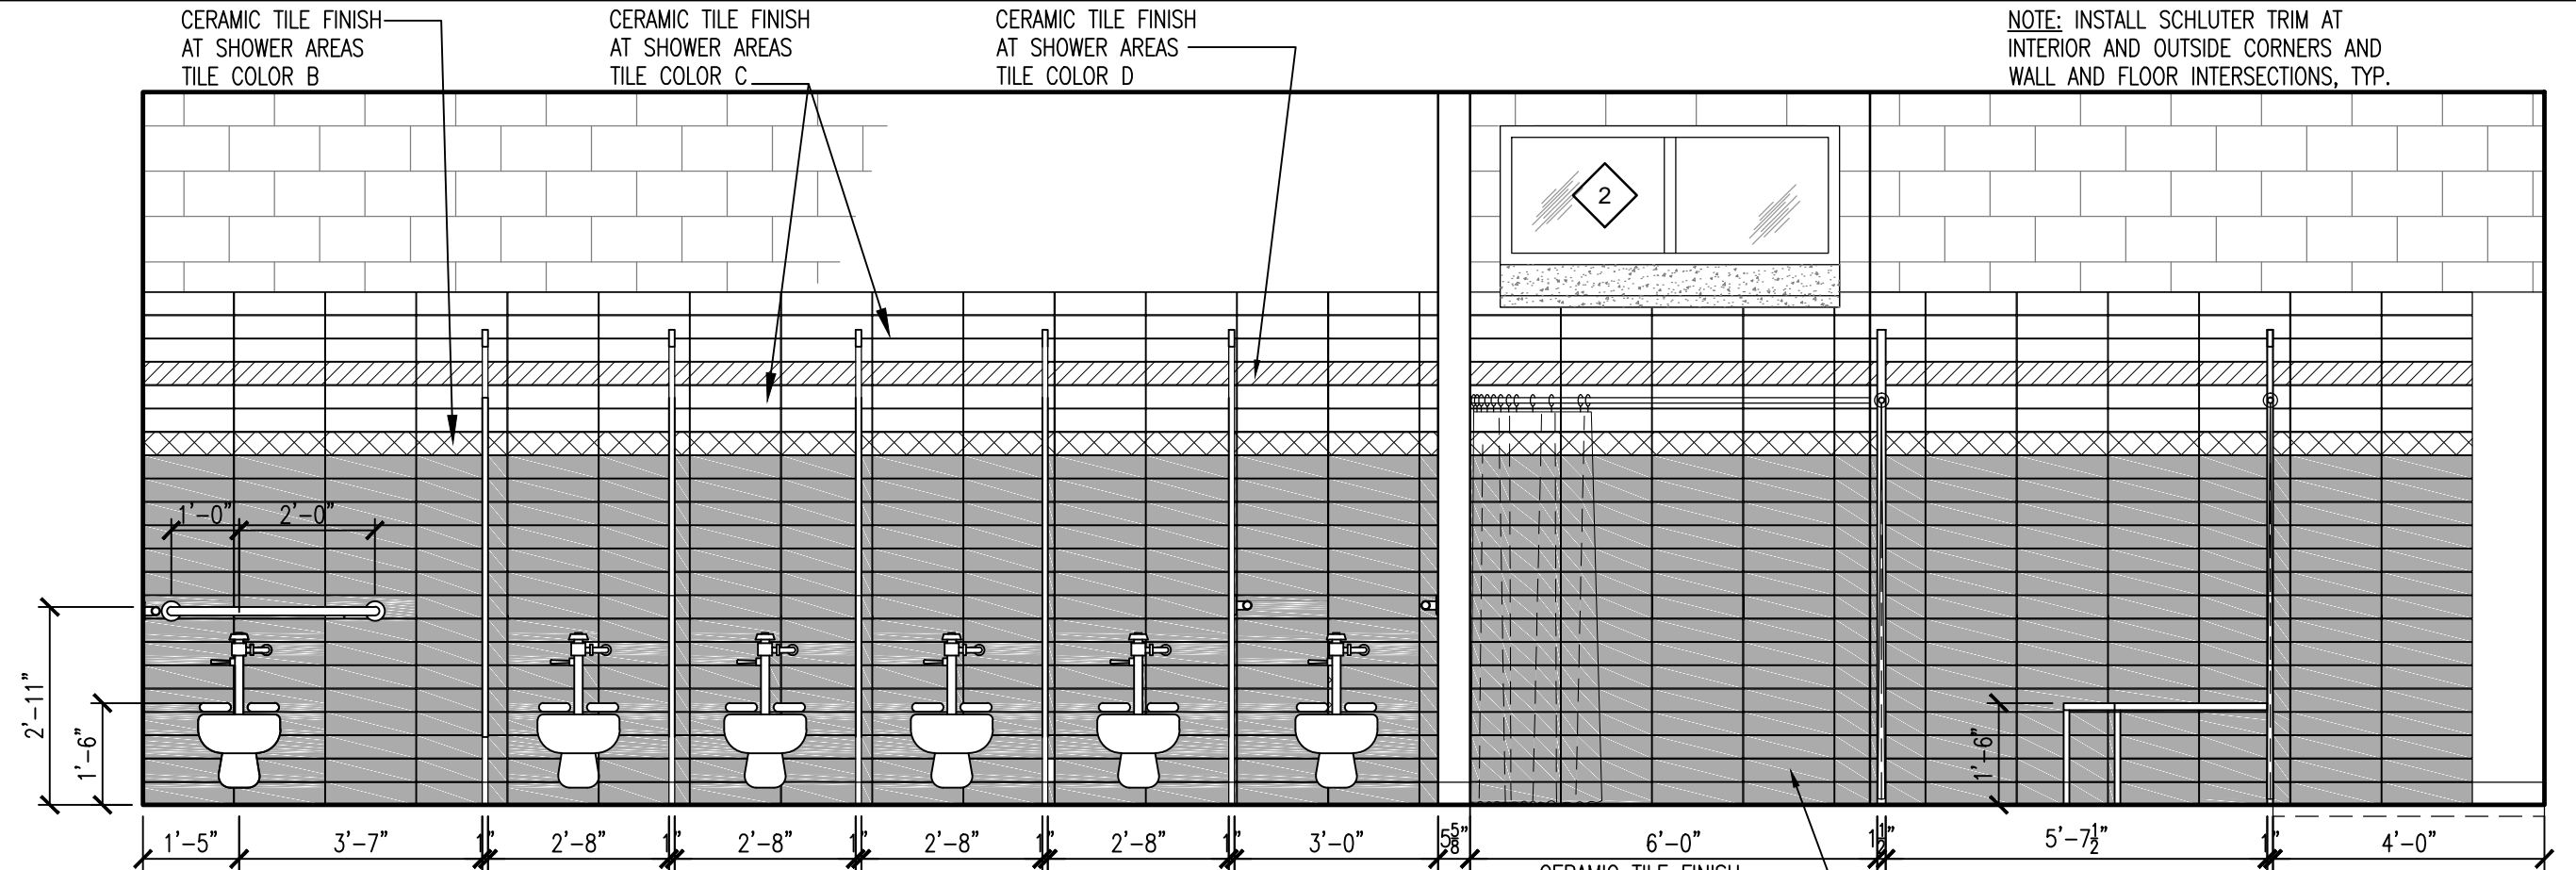

9 RESTROOM 110 & SHOWERS 111
SCALE: 3/8" = 1'-0"

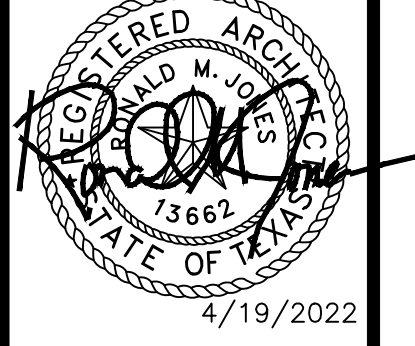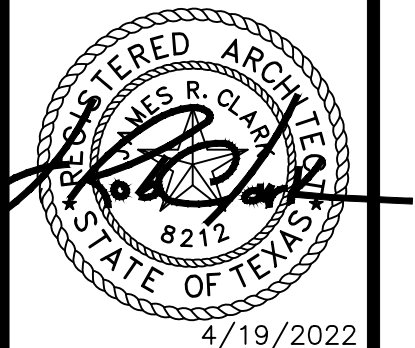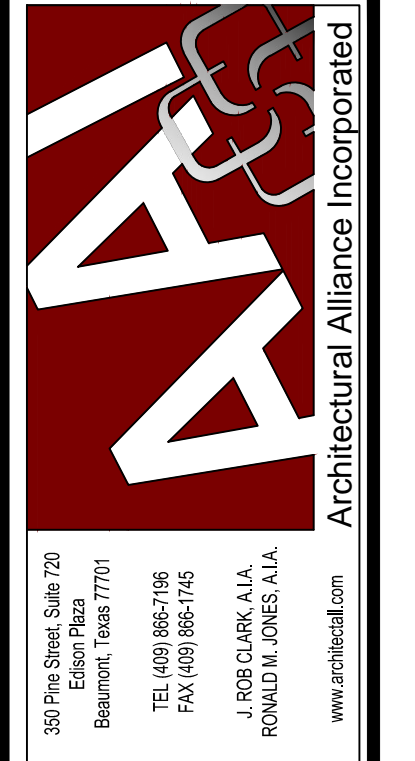








WEST BROOK AUXILIARY FIELD HOUSE
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8750 Phelan Blvd
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| BIDS & CONSTRUCTION | <input checked="" type="checkbox"/> |
| DATE: 4/18/2022 | |
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| REVISION: | DATE: |
| REVISION: | DATE: |

DRAWINGS SHEET TITLE
INTERIOR ELEVATIONS

SHEET NUMBER
A600
PROJECT NUMBER
21021

SAVED: MICHAELM
PLOT DATE: 4/19/2022 9:24 AM
SHEET SIZE: ARCH (standard D) (36.00 x 24.00 inches)

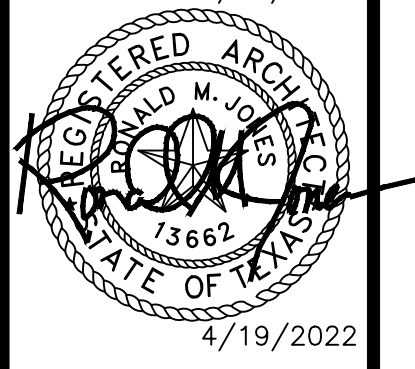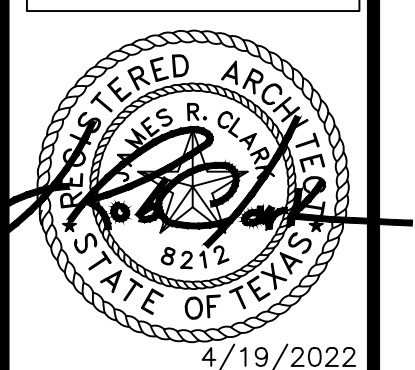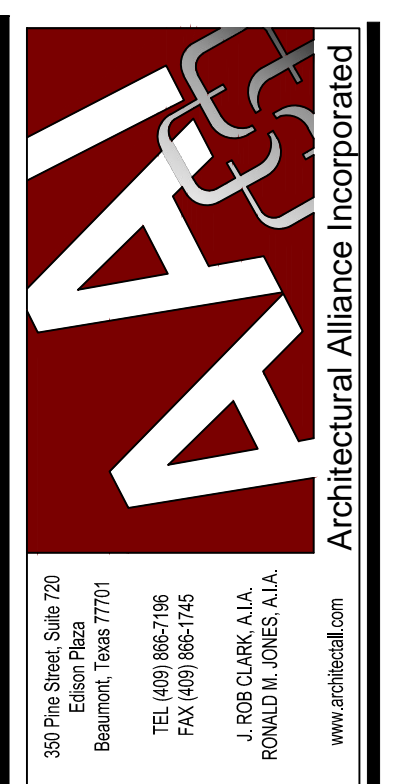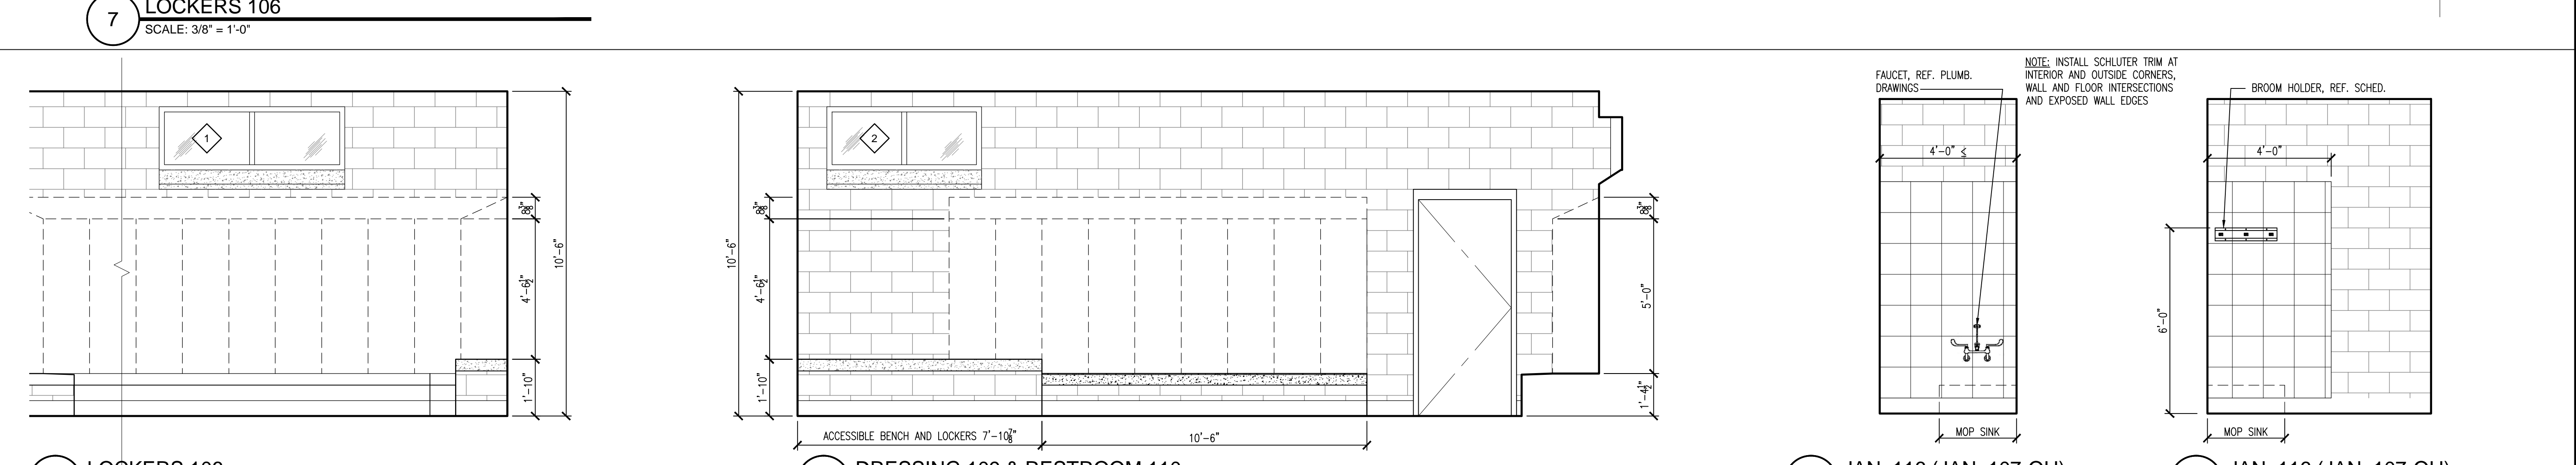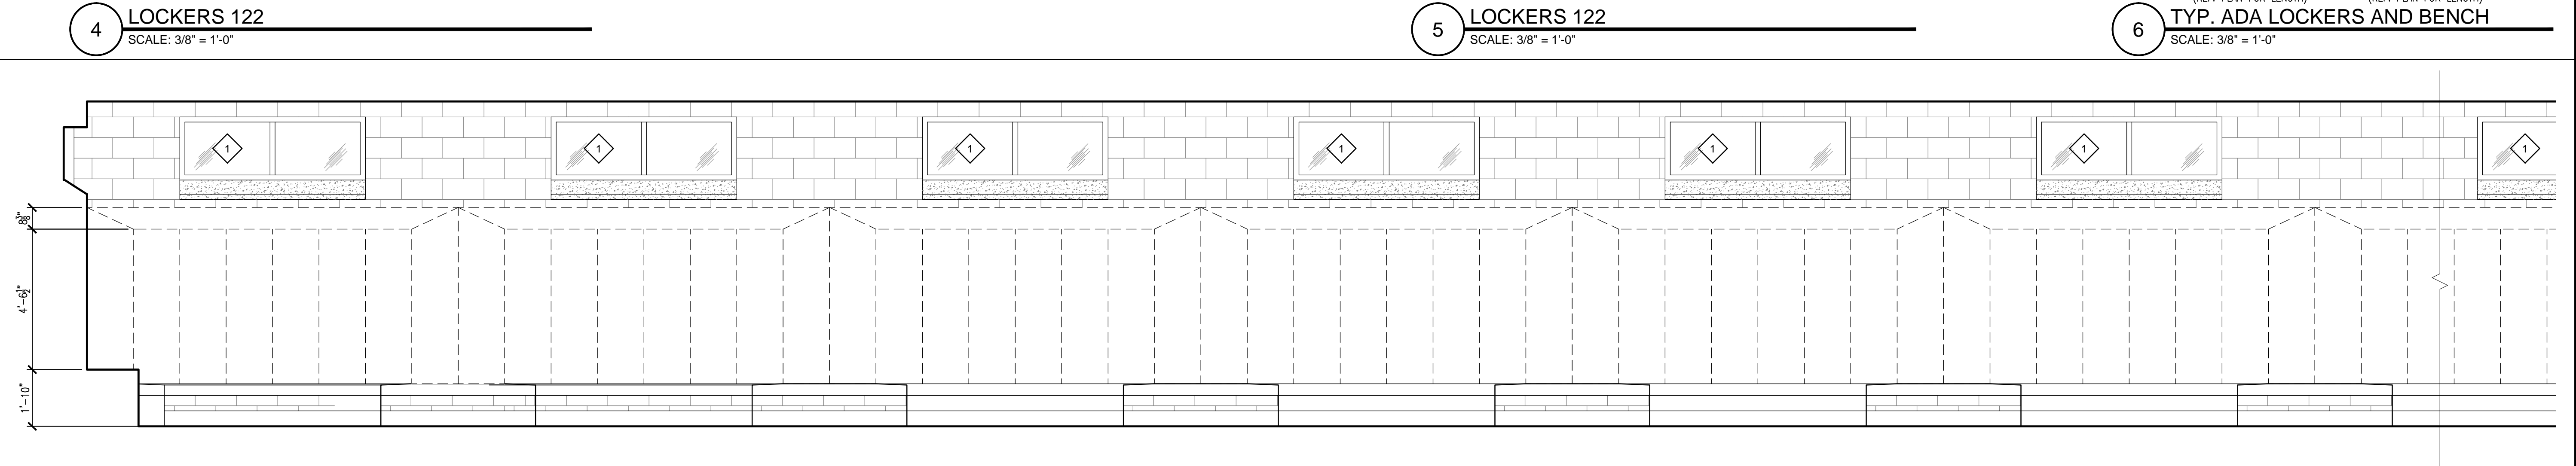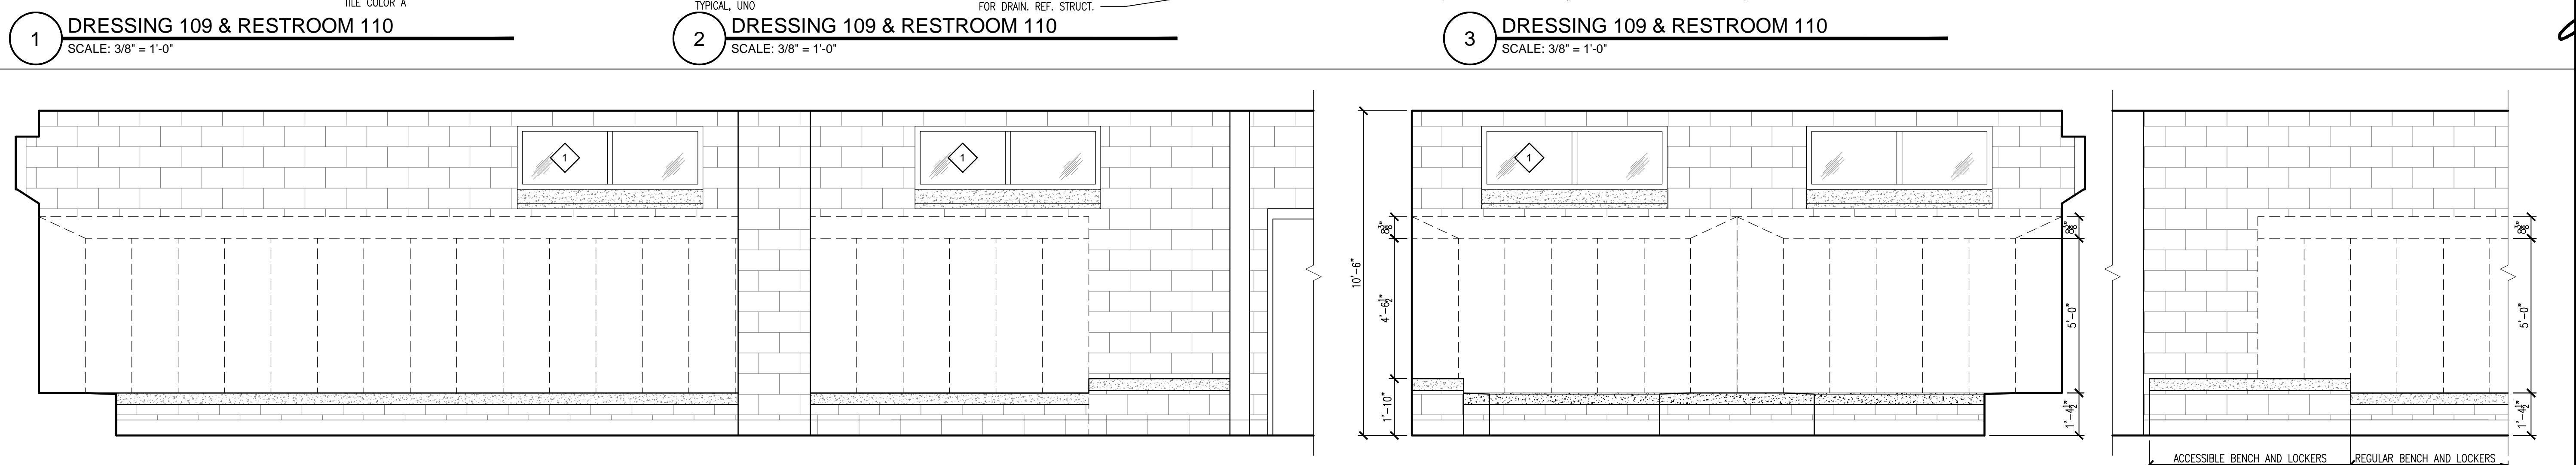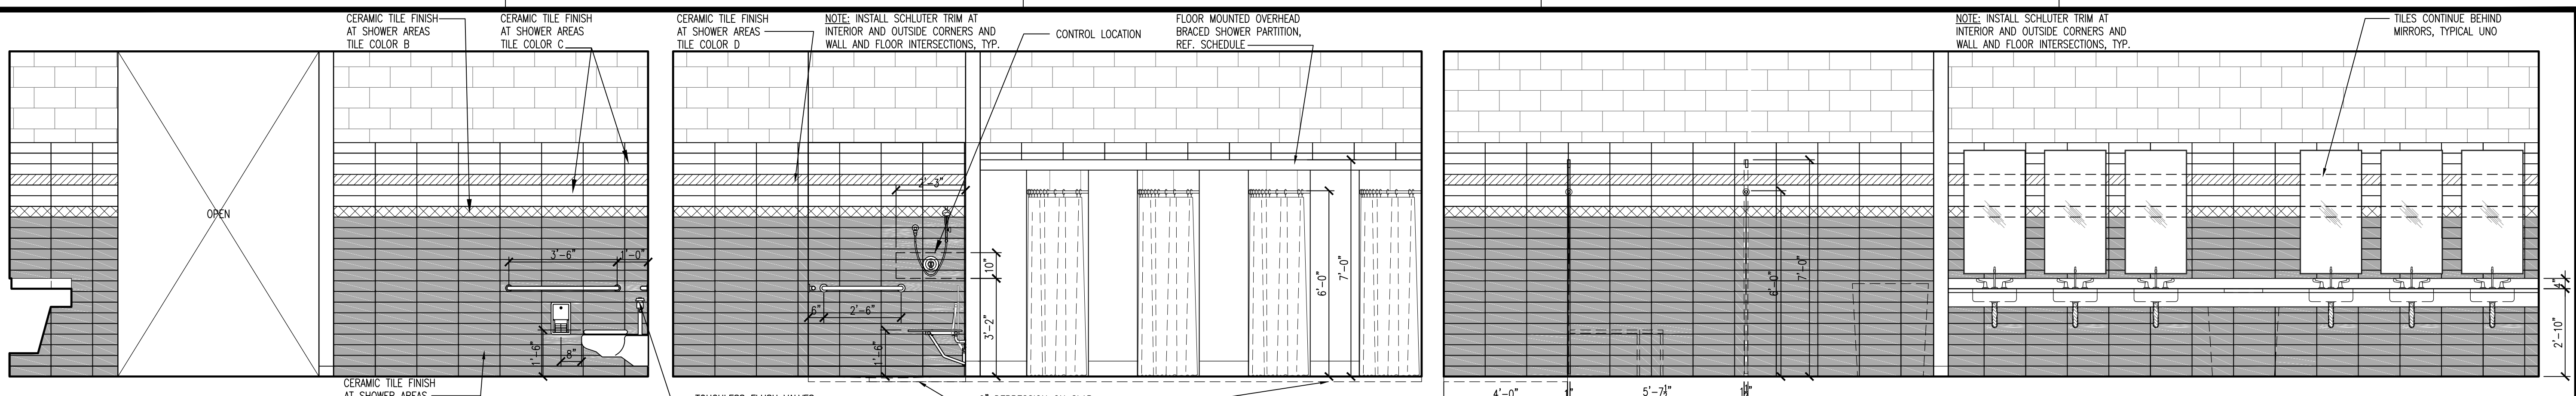


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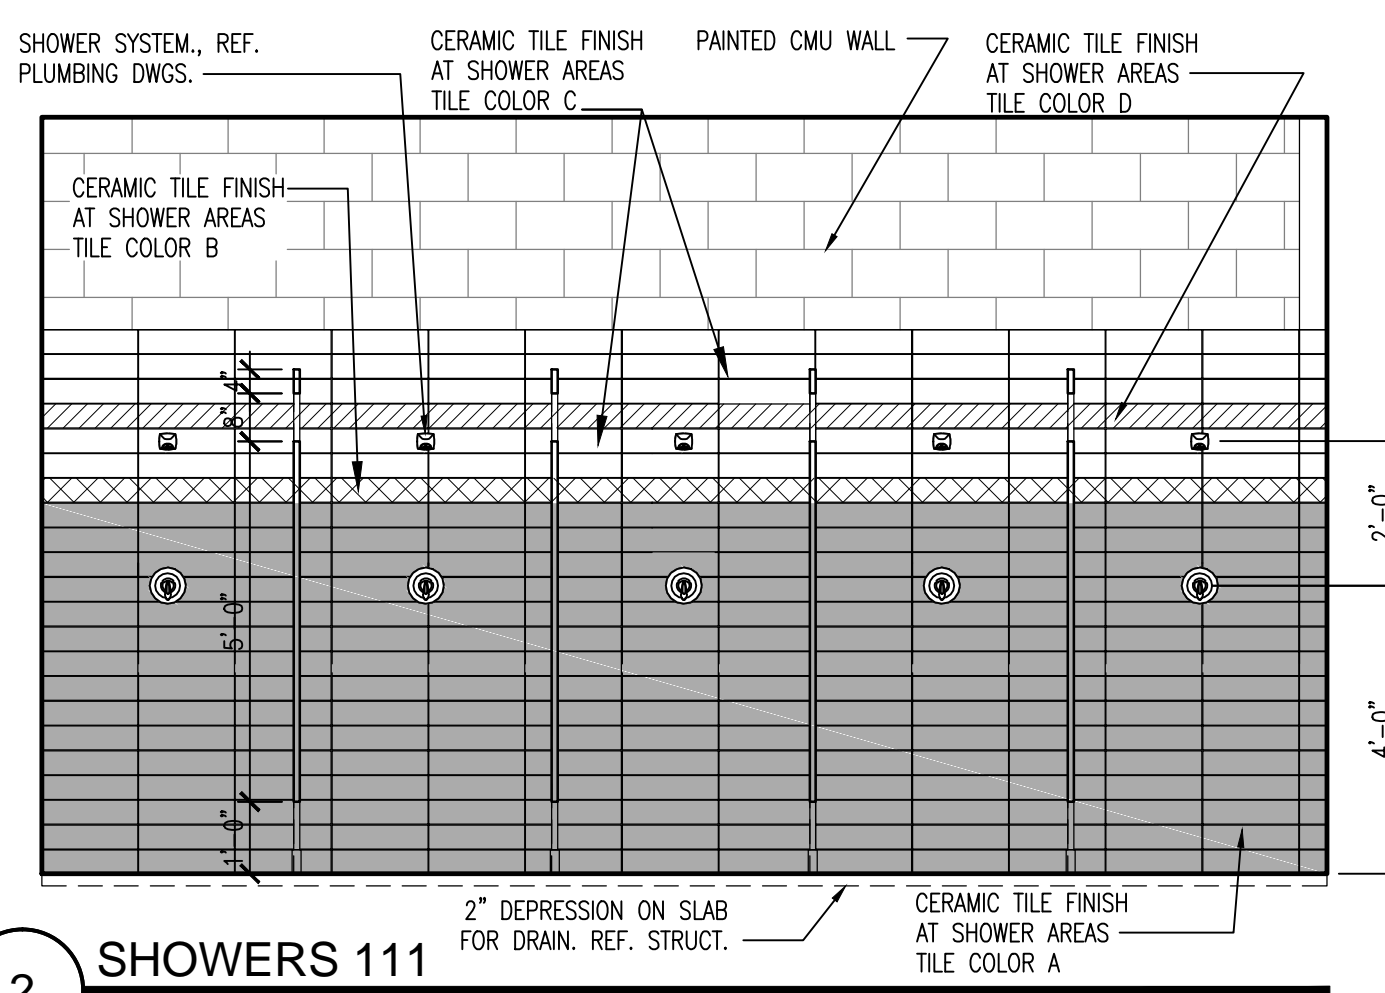
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| REVISION: | DATE: |

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| DRAWINGS SHEET TITLE | INTERIOR ELEVATIONS |
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| PROJECT NUMBER | 21021 |


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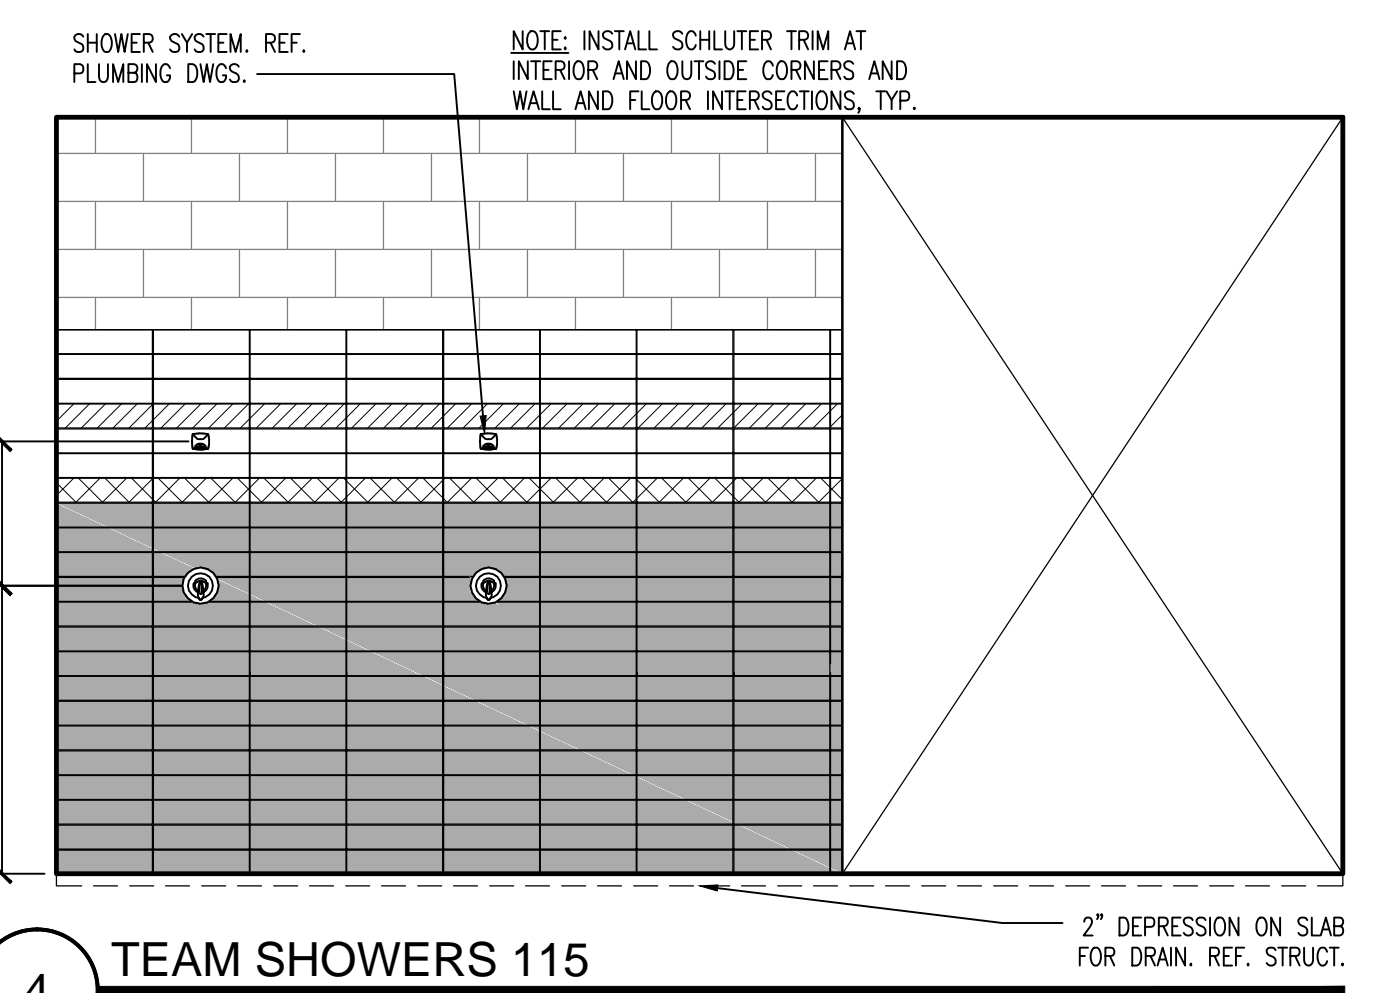
1 LOCKERS 106
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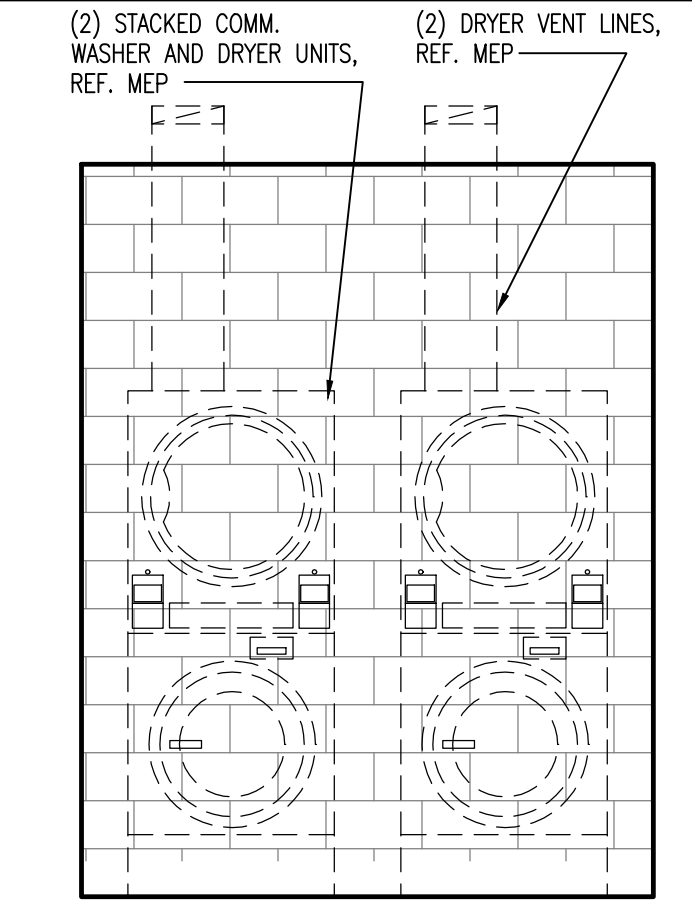
2 SHOWERS 111
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3 TEAM SHOWERS 115
SCALE: 3/8" = 1'-0"

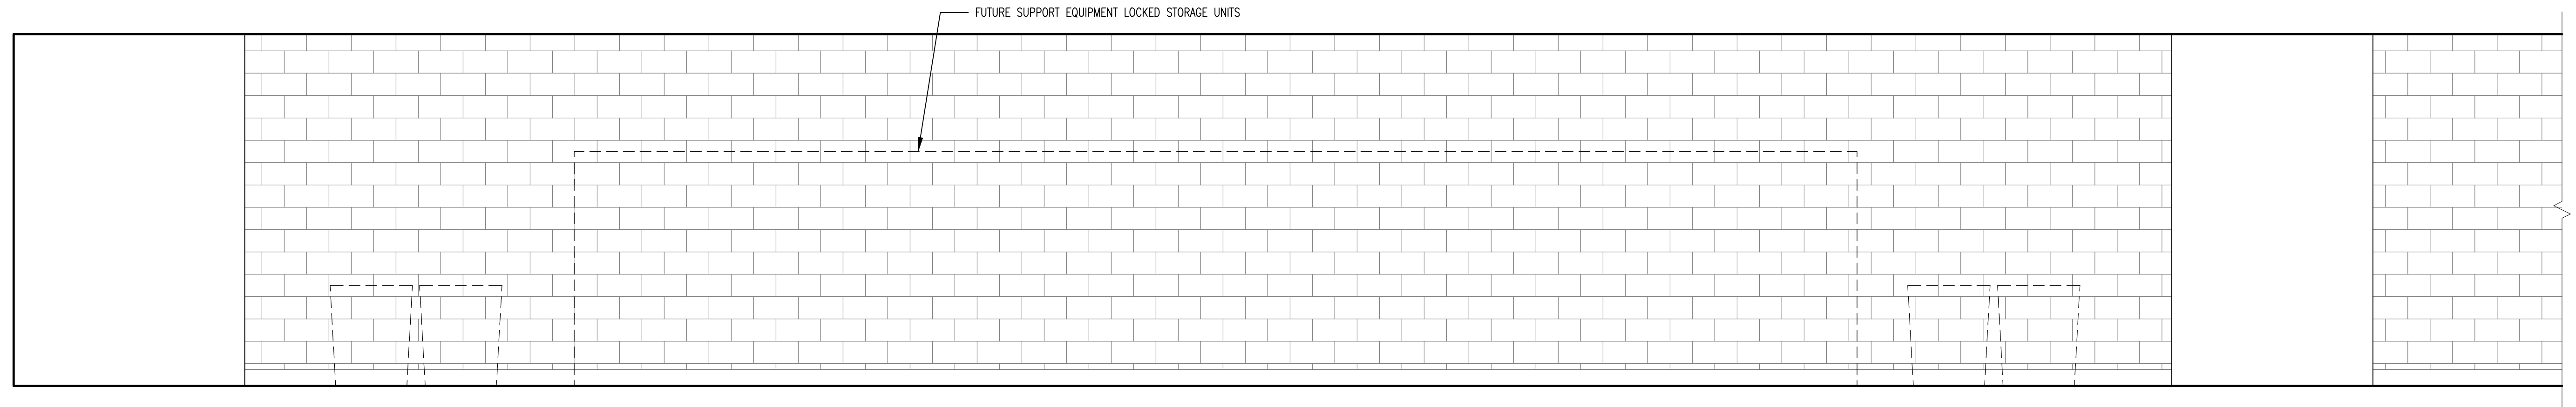


4 TEAM SHOWERS 115
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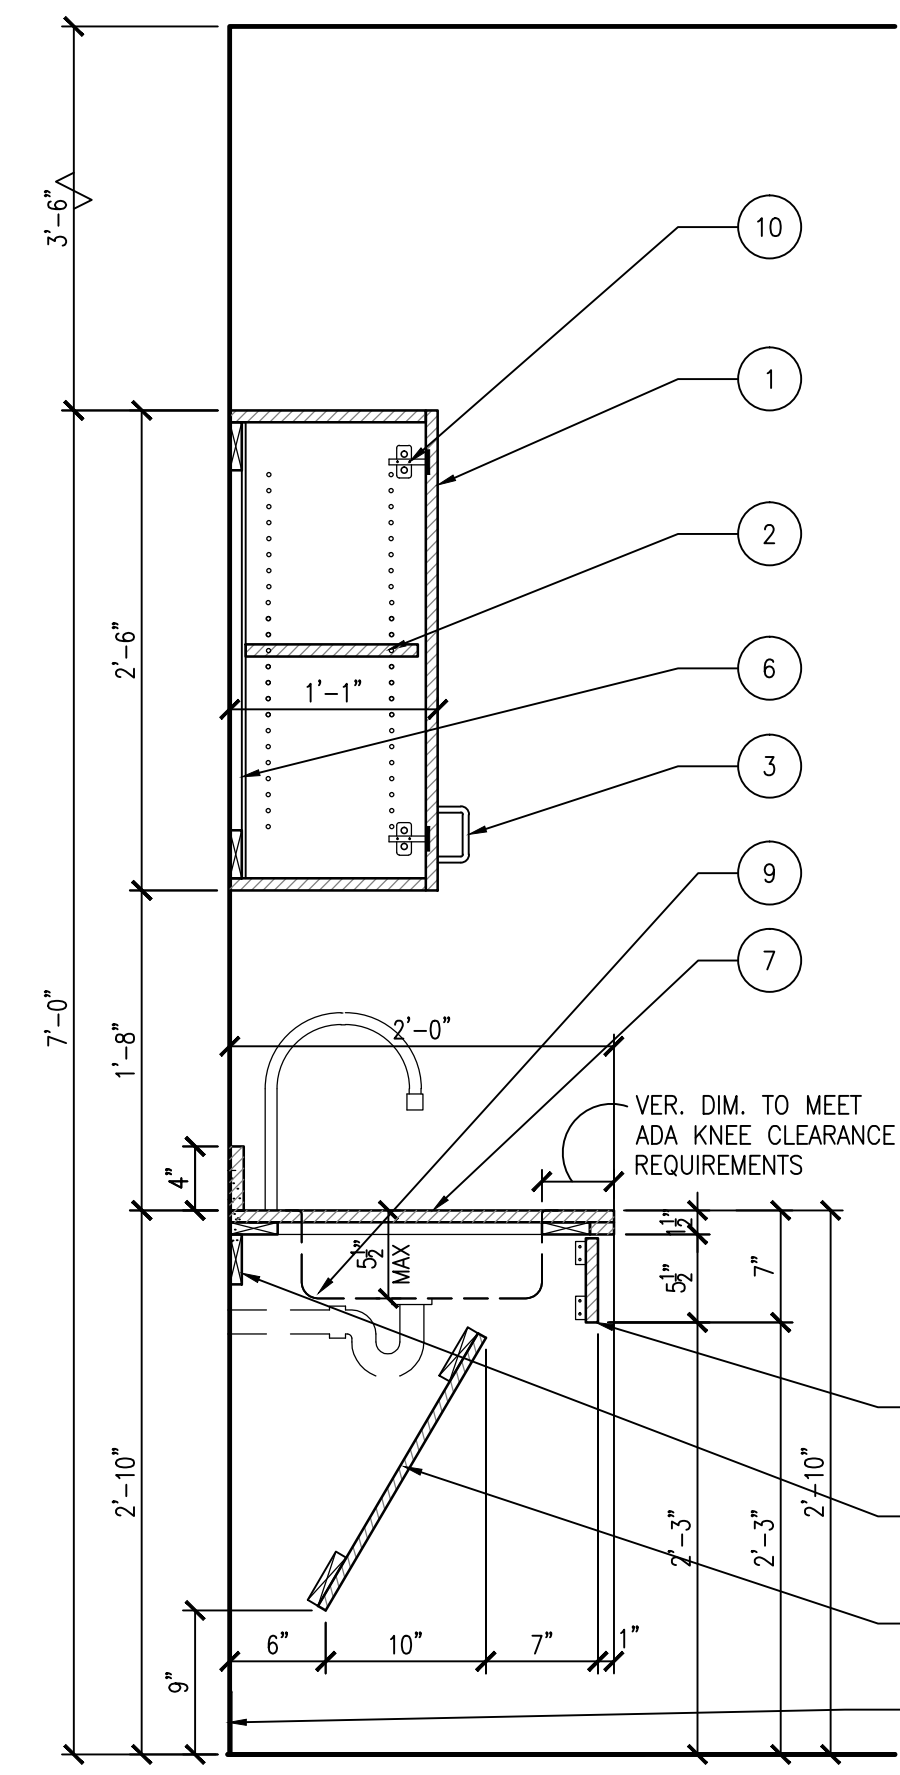
5 LAUNDRY 114
SCALE: 3/8" = 1'-0"

CASEWORK SECTION KEY NOTES


1. PLASTIC LAMINATE EXTERIOR FINISH
2. MELAMINE INTERIOR
3. WIRE PULL
4. ADJUSTABLE PLASTIC LAMINATE SHELVES
5. GROOVE BOTTOM SIDE OF ALL ADJUSTABLE SHELVES TO RECEIVE PINS OR PROVIDE HOLD-DOWN CLIPS
6. 1/2" THK. PLYWOOD BACK WITH MELAMINE FINISH
7. PLASTIC LAMINATE COUNTERTOP, 4" BACK SPLASH AND END SPLASH
8. SCHED. BASE ON TOE KICK/ SCHED. BASE
9. STAINLESS STEEL SINK AND FAUCET, REF. PLUMBING DRAWINGS
10. BLUM 170 DEGREE OVERLAY HINGE
11. FIXED PLASTIC LAMINATE CUBBIES
12. FIXED HANGING ROD
13. PLASTIC LAMINATE REMOVABLE SHIELD
14. 2X4 LEDGER
15. ADA COMPLIANT SINK AND FAUCET - REF. PLUMBING DRAWINGS
16. 6" DIAMETER STAINLESS STEEL GROMMET TRIM RING
17. FULL EXTENSION GLIDE-OUT
18. WASTE BASKET, VERIFY SIZE TO CLEAR GROMMET CUT-OUT ON CABINET FACE PANEL
19. ADA RECESSED MOUNTED DIAPER CHANGER, REFER. TOILET ACCESSORY SCHEDULE
20. PLASTIC LAMINATE FINISH OVER 1/2" PLYWOOD
21. 3" DIAMETER STAINLESS STEEL GROMMET RING
22. 1/2" ALUM. REVEAL
23. SPEED BRACE 15X18 METAL BRACKET OVER WOOD NAILER
24. REMOVABLE STAINLESS STEEL DRIP PAN WITH 2" LIP AND HEMMED EDGES TO CATCH WATER FROM BAPTISMAL GOWNS
25. QUARTZ TOP AND SPLASH, PROVIDE 3/4" PLYWOOD BACKING AT COUNTERTOP APPLICATION.

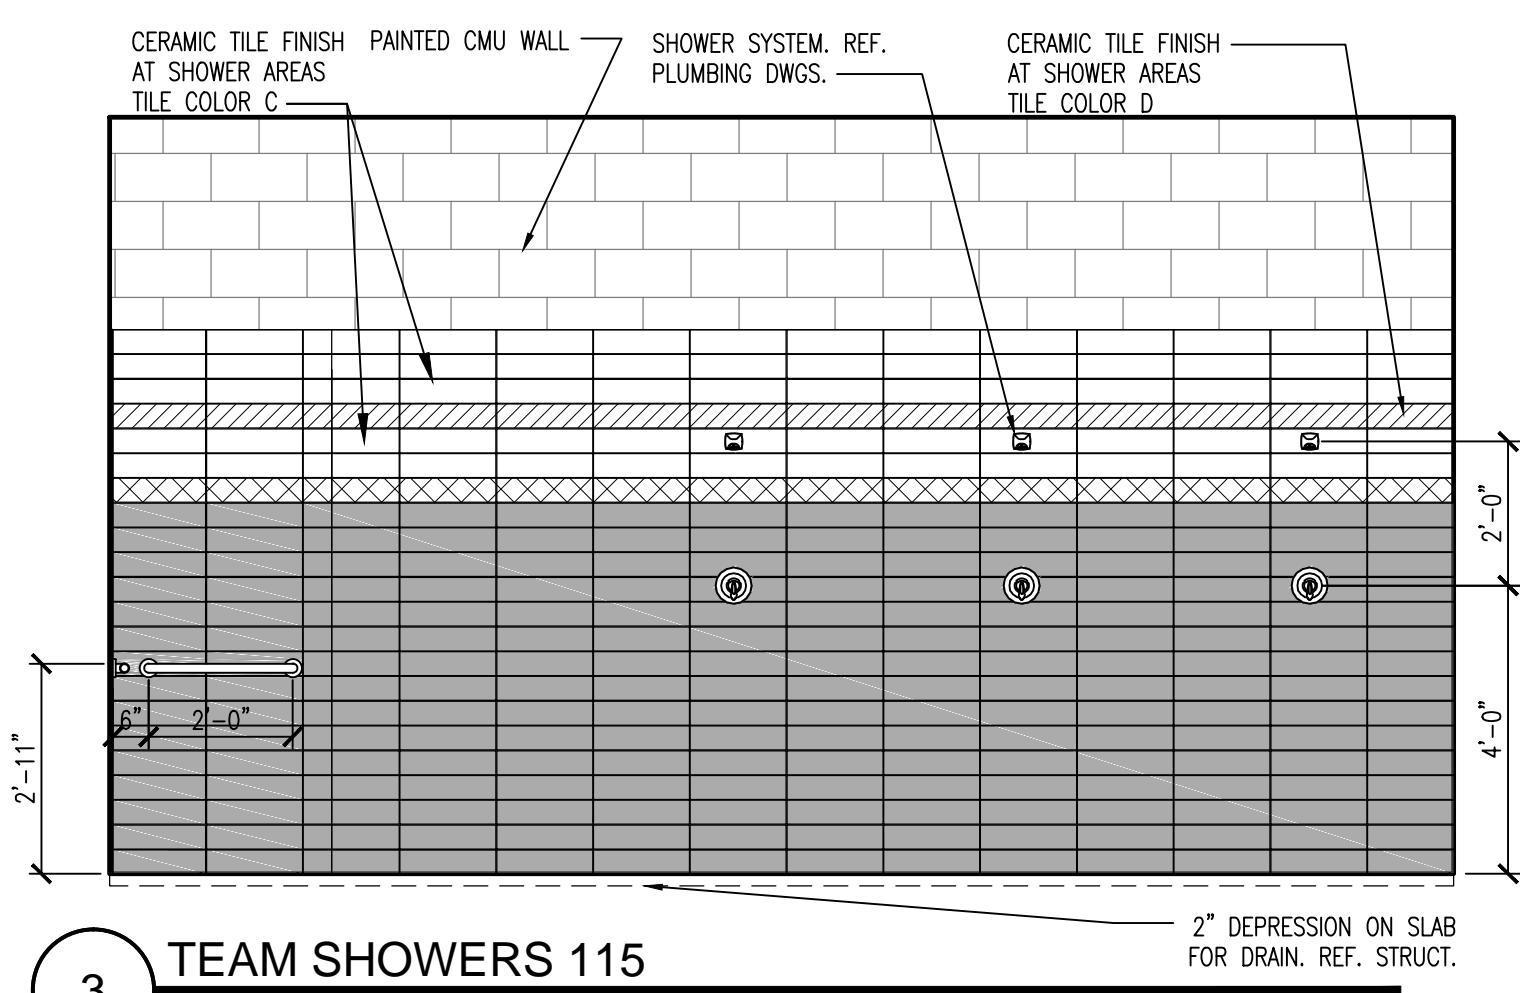


6 MILLWORK SECTION
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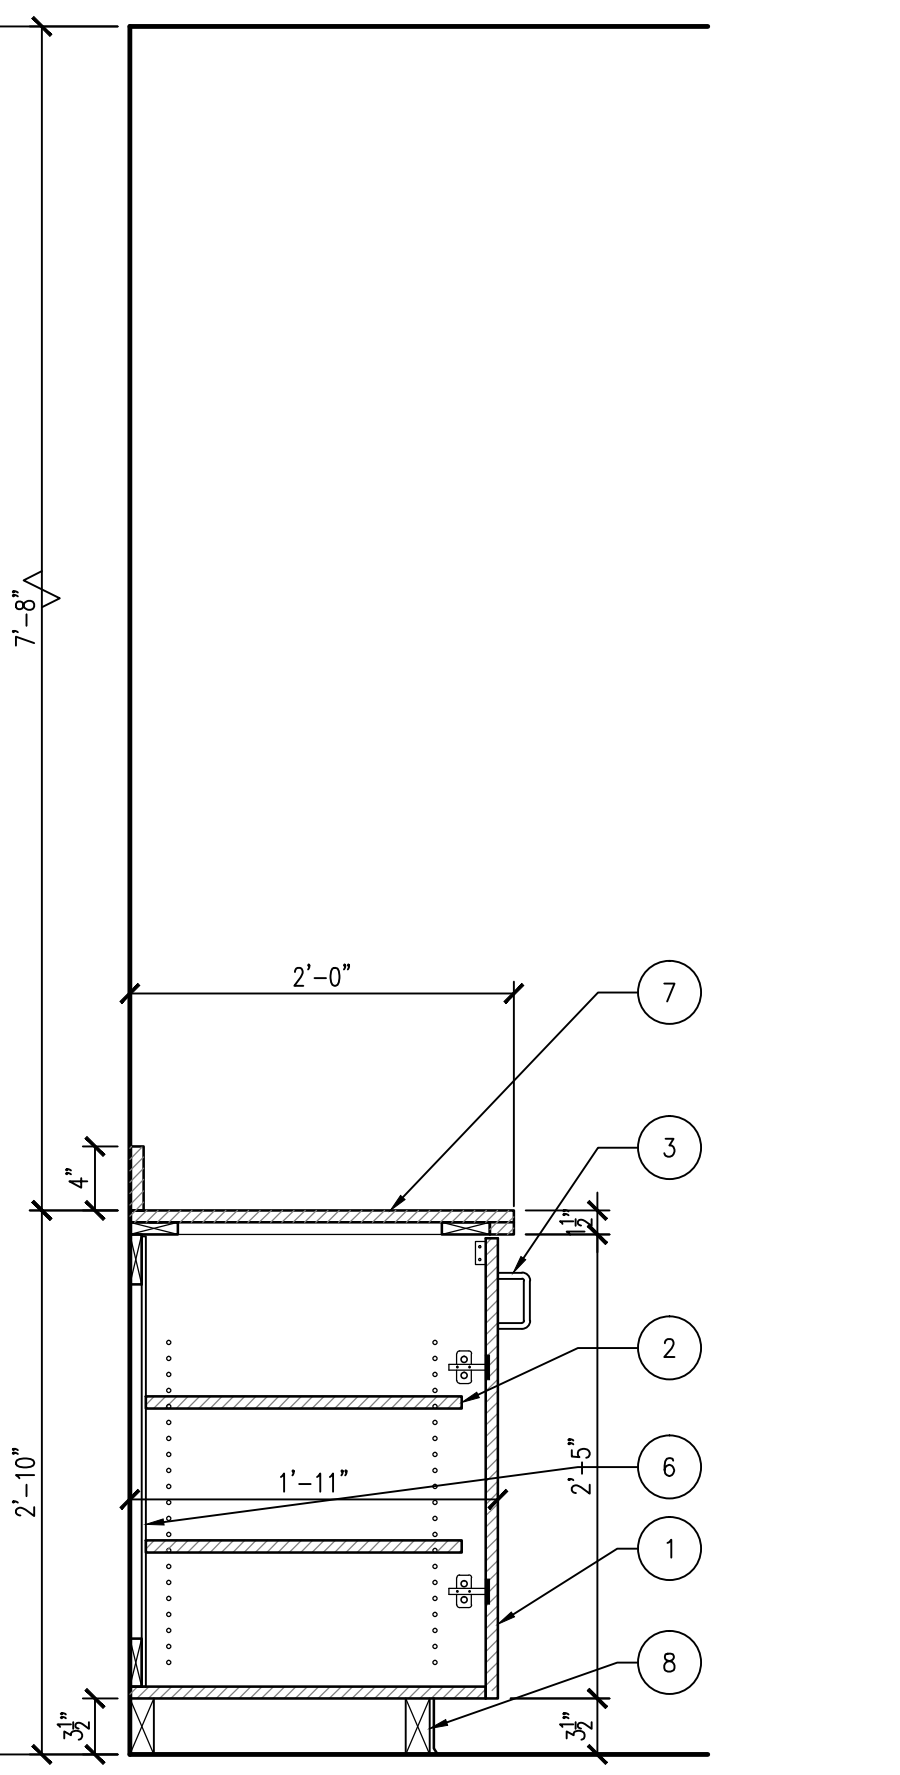
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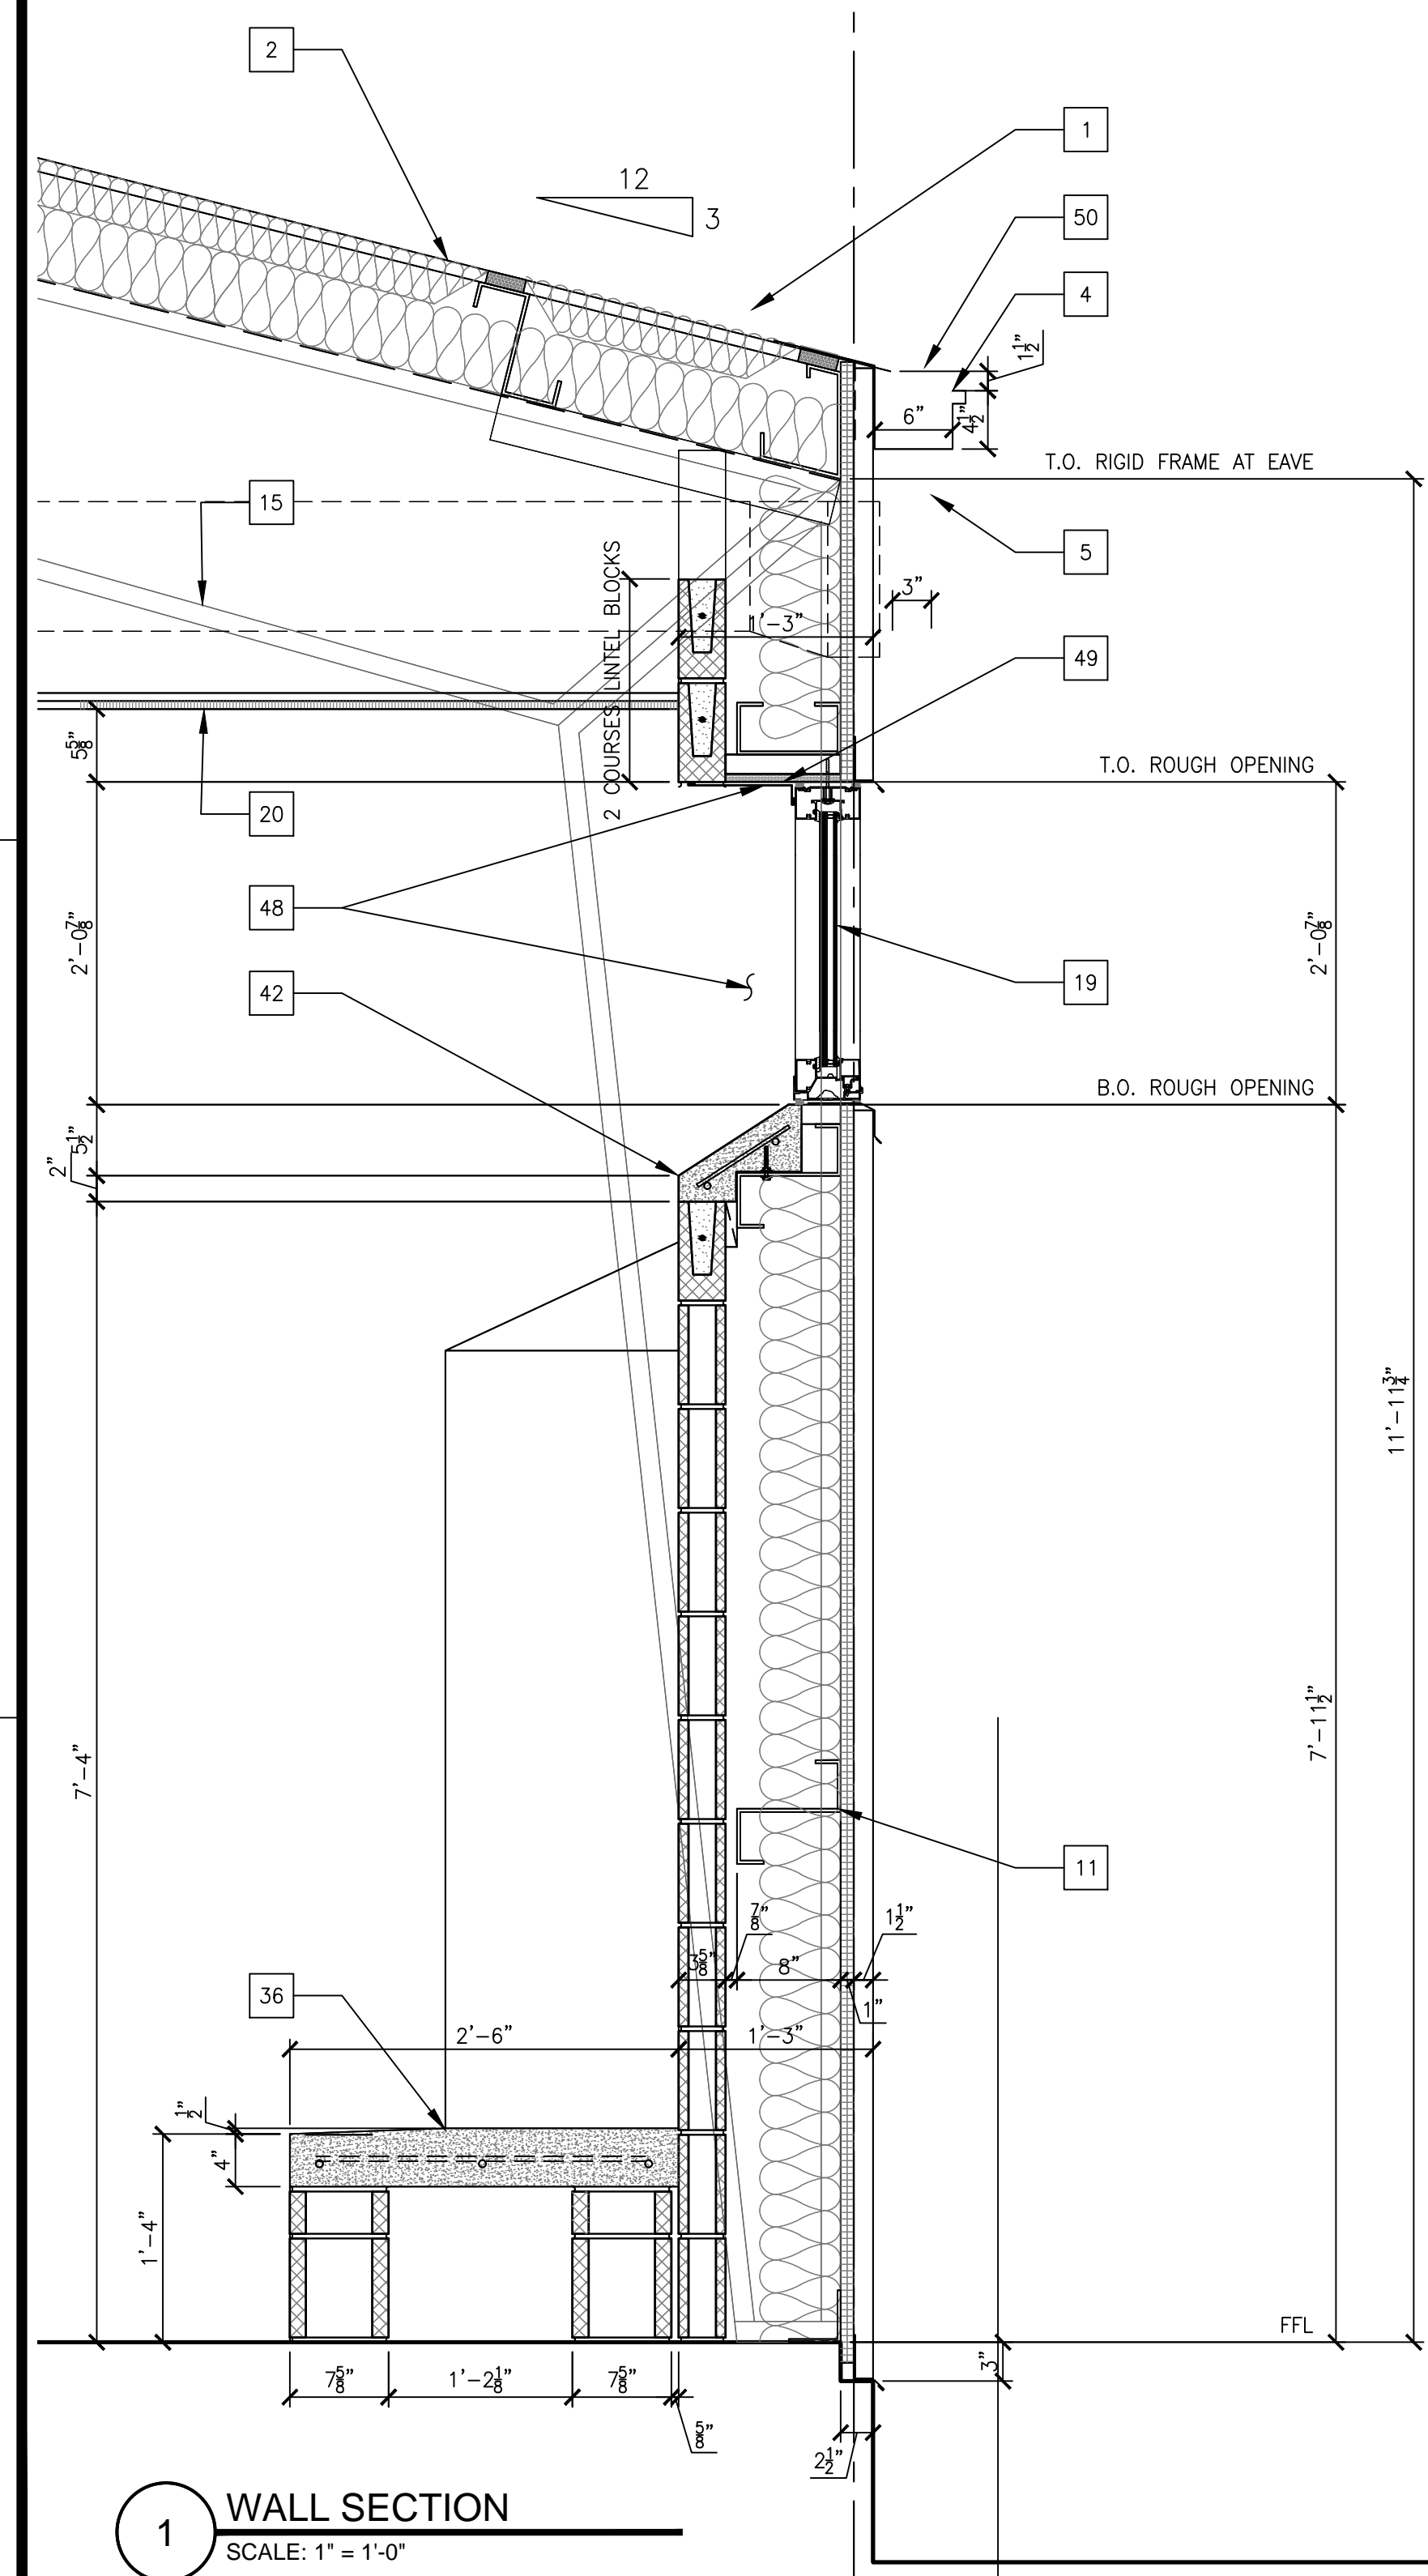
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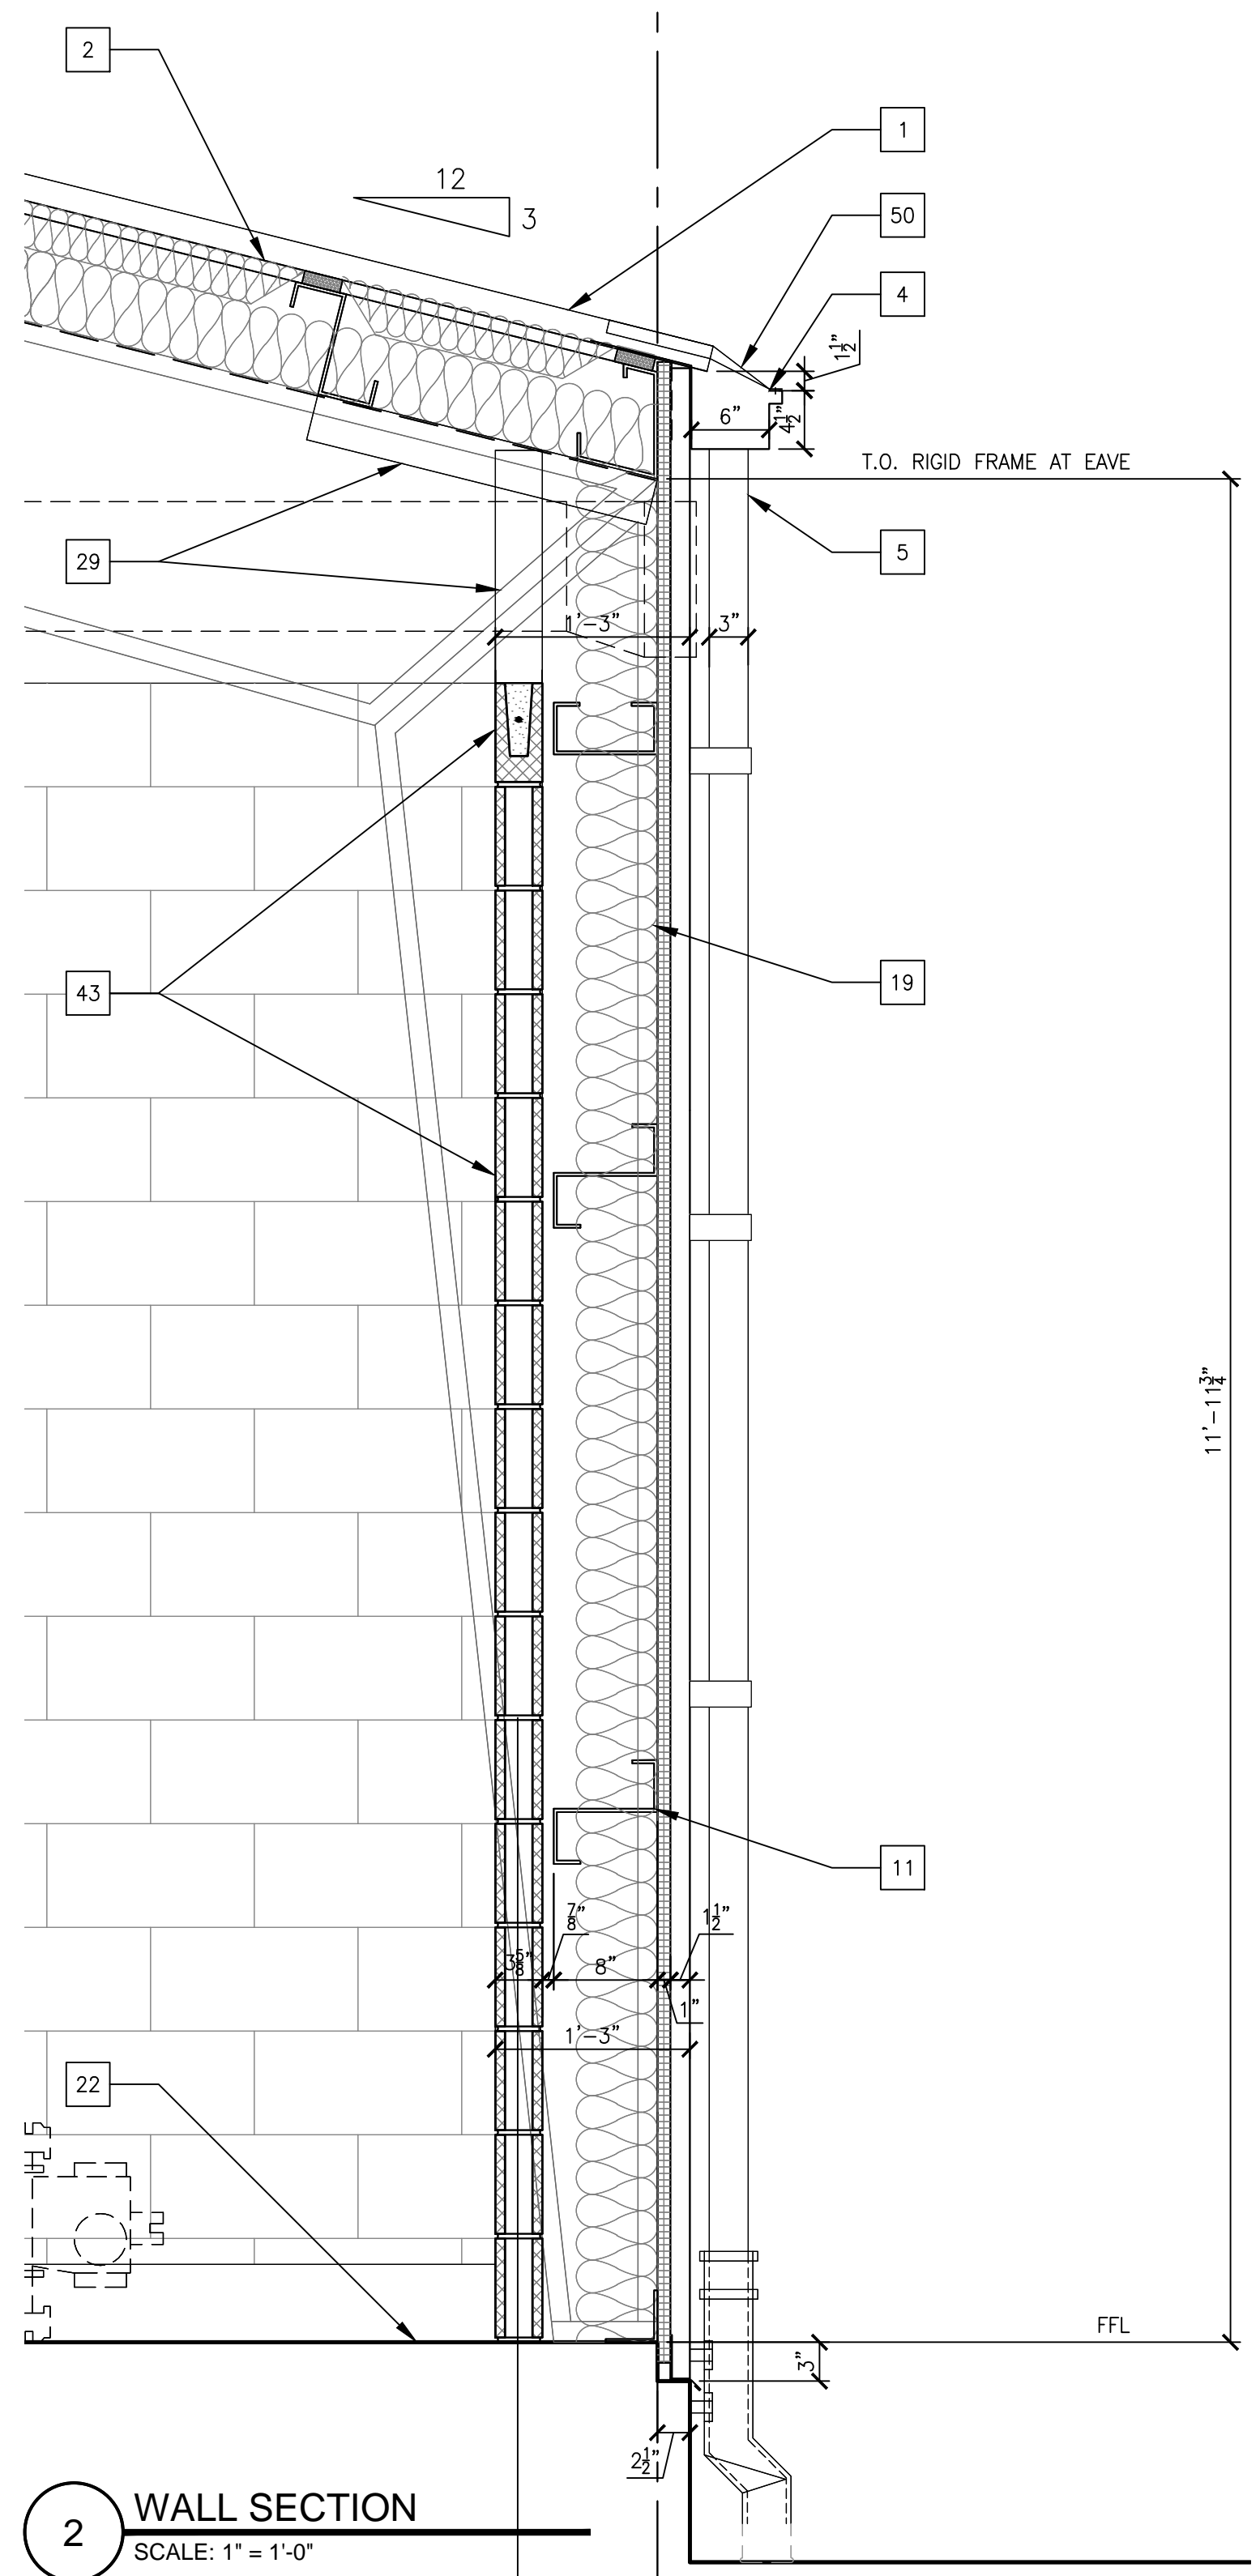
9 MILLWORK SECTION
SCALE: 1" = 1'-0"

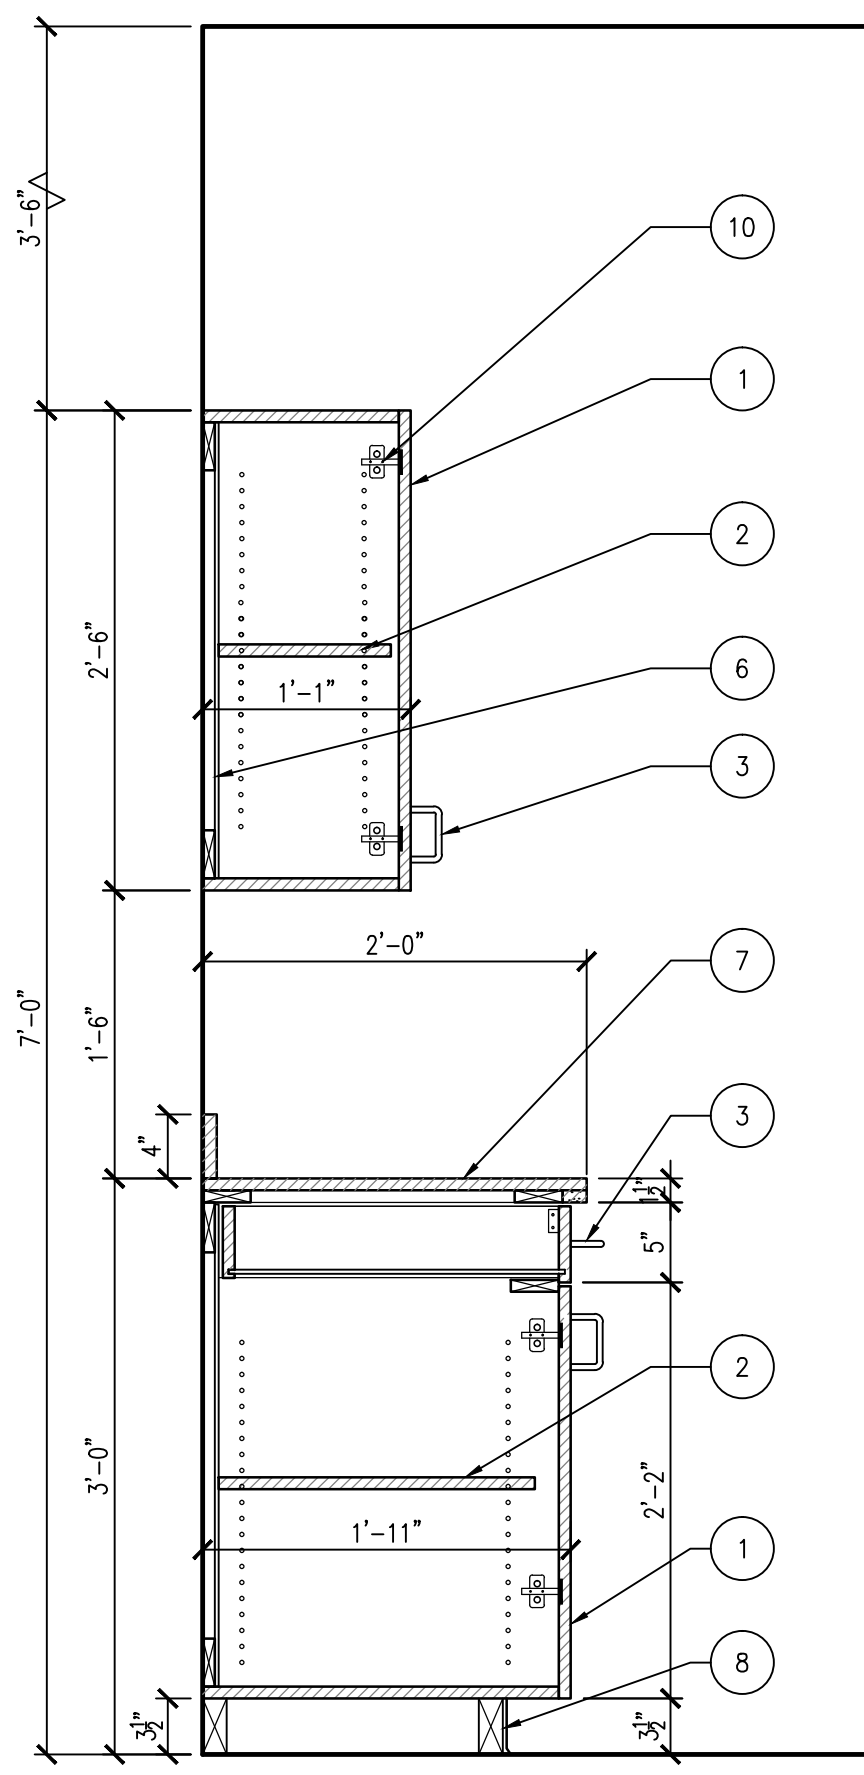


10 MILLWORK SECTION
SCALE: 1" = 1'-0"

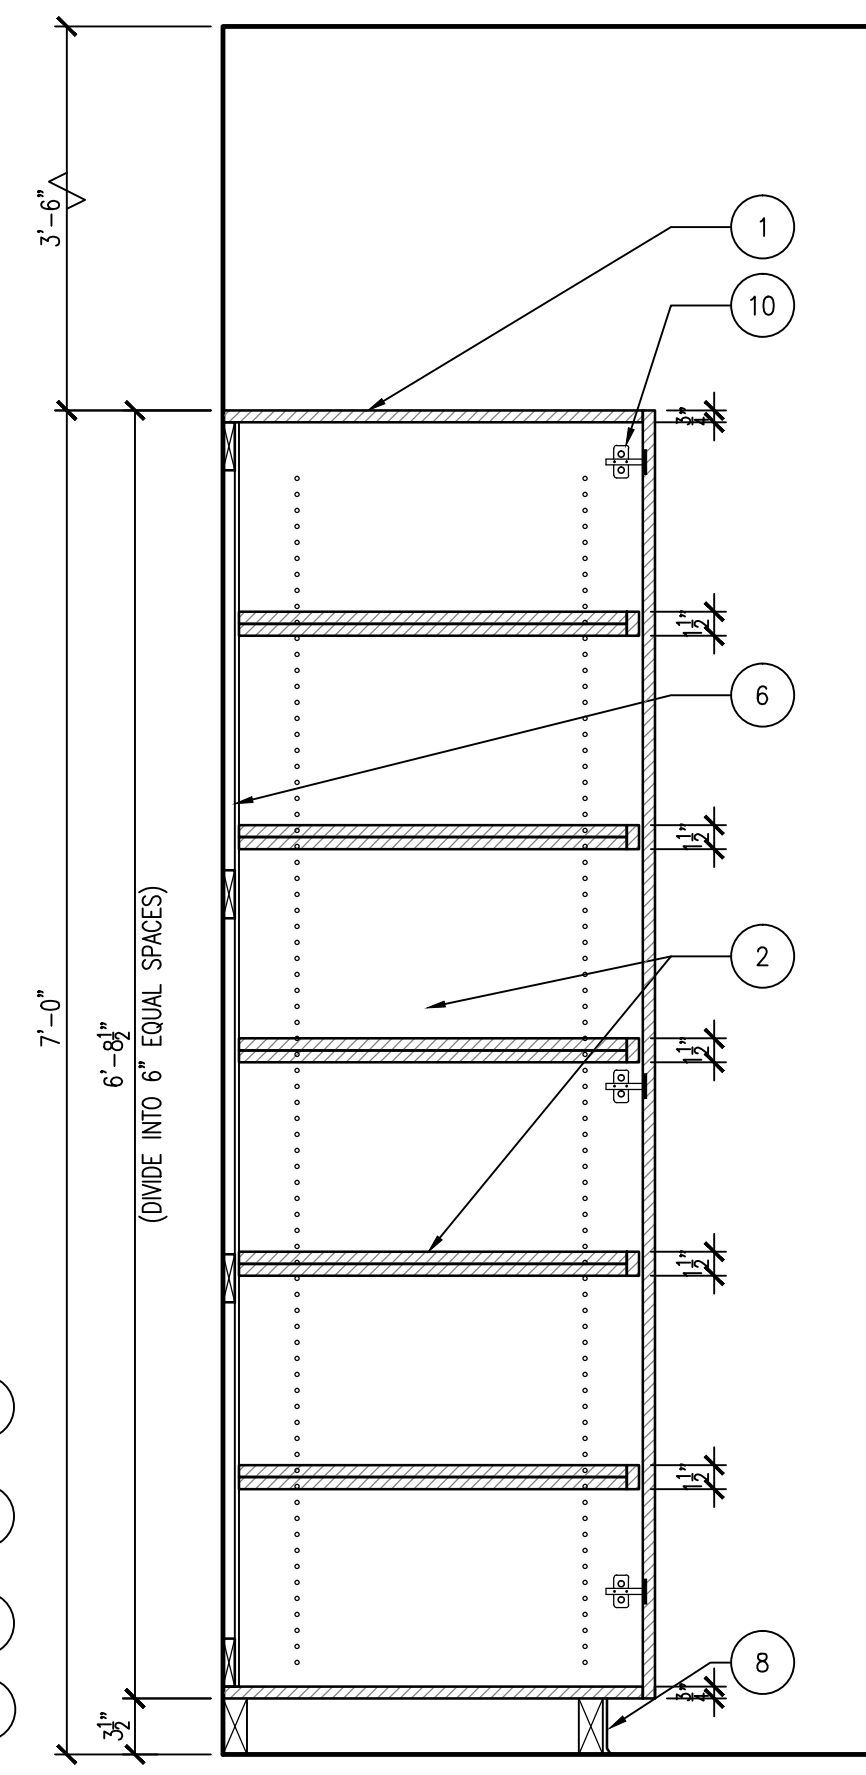

1 WALL SECTION
 SCALE: 1" = 1'-0"

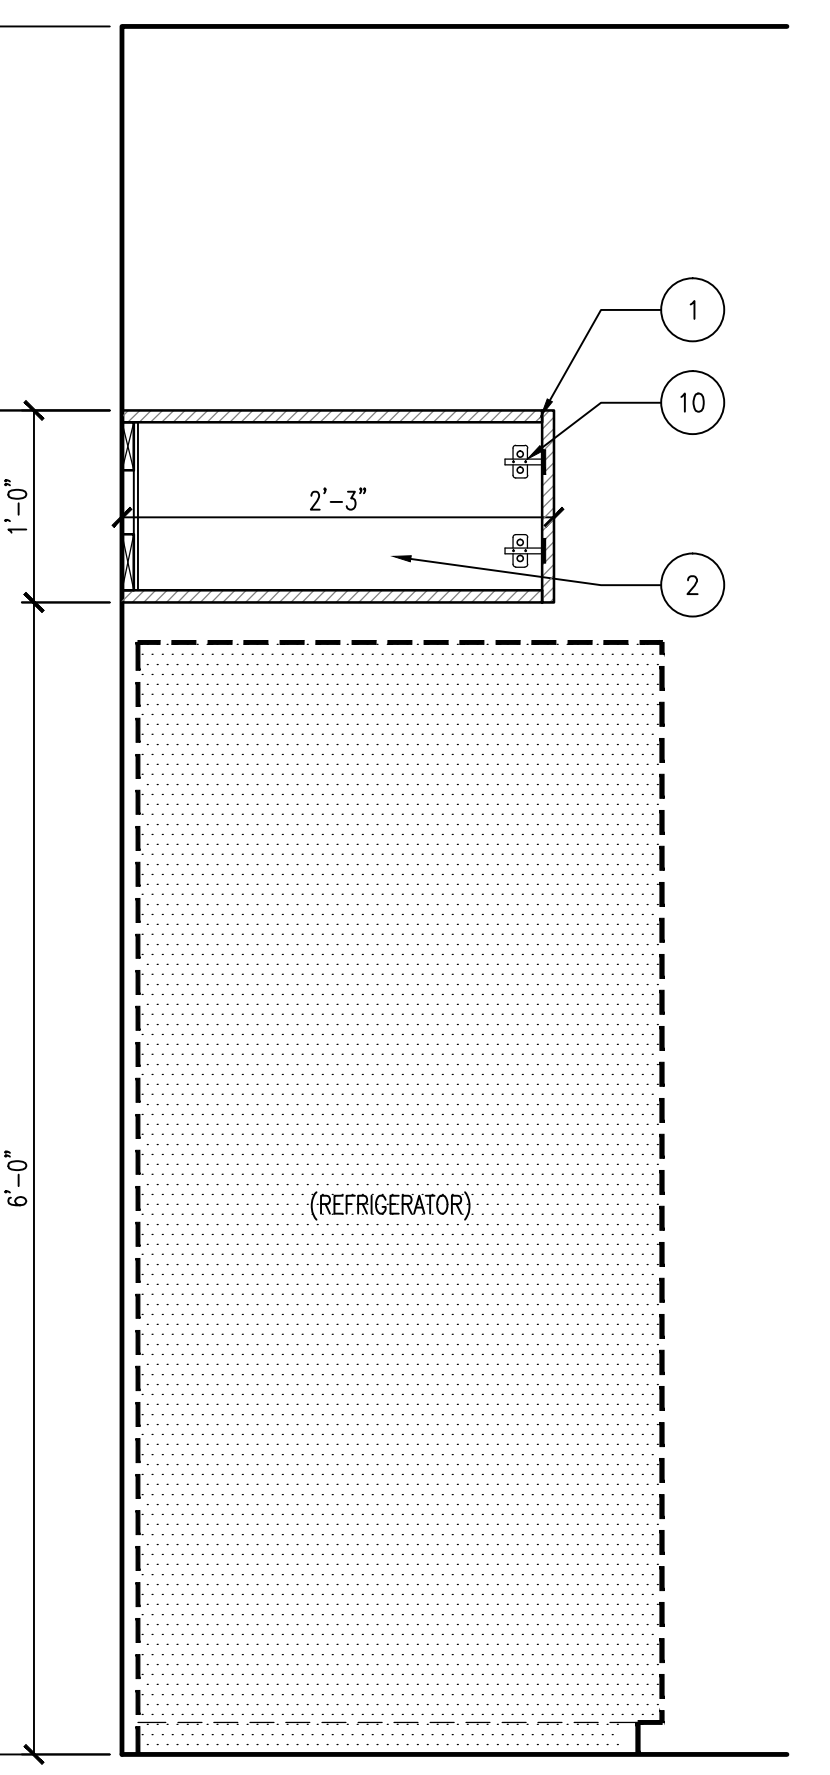


2 WALL SECTION
 SCALE: 1" = 1'-0"

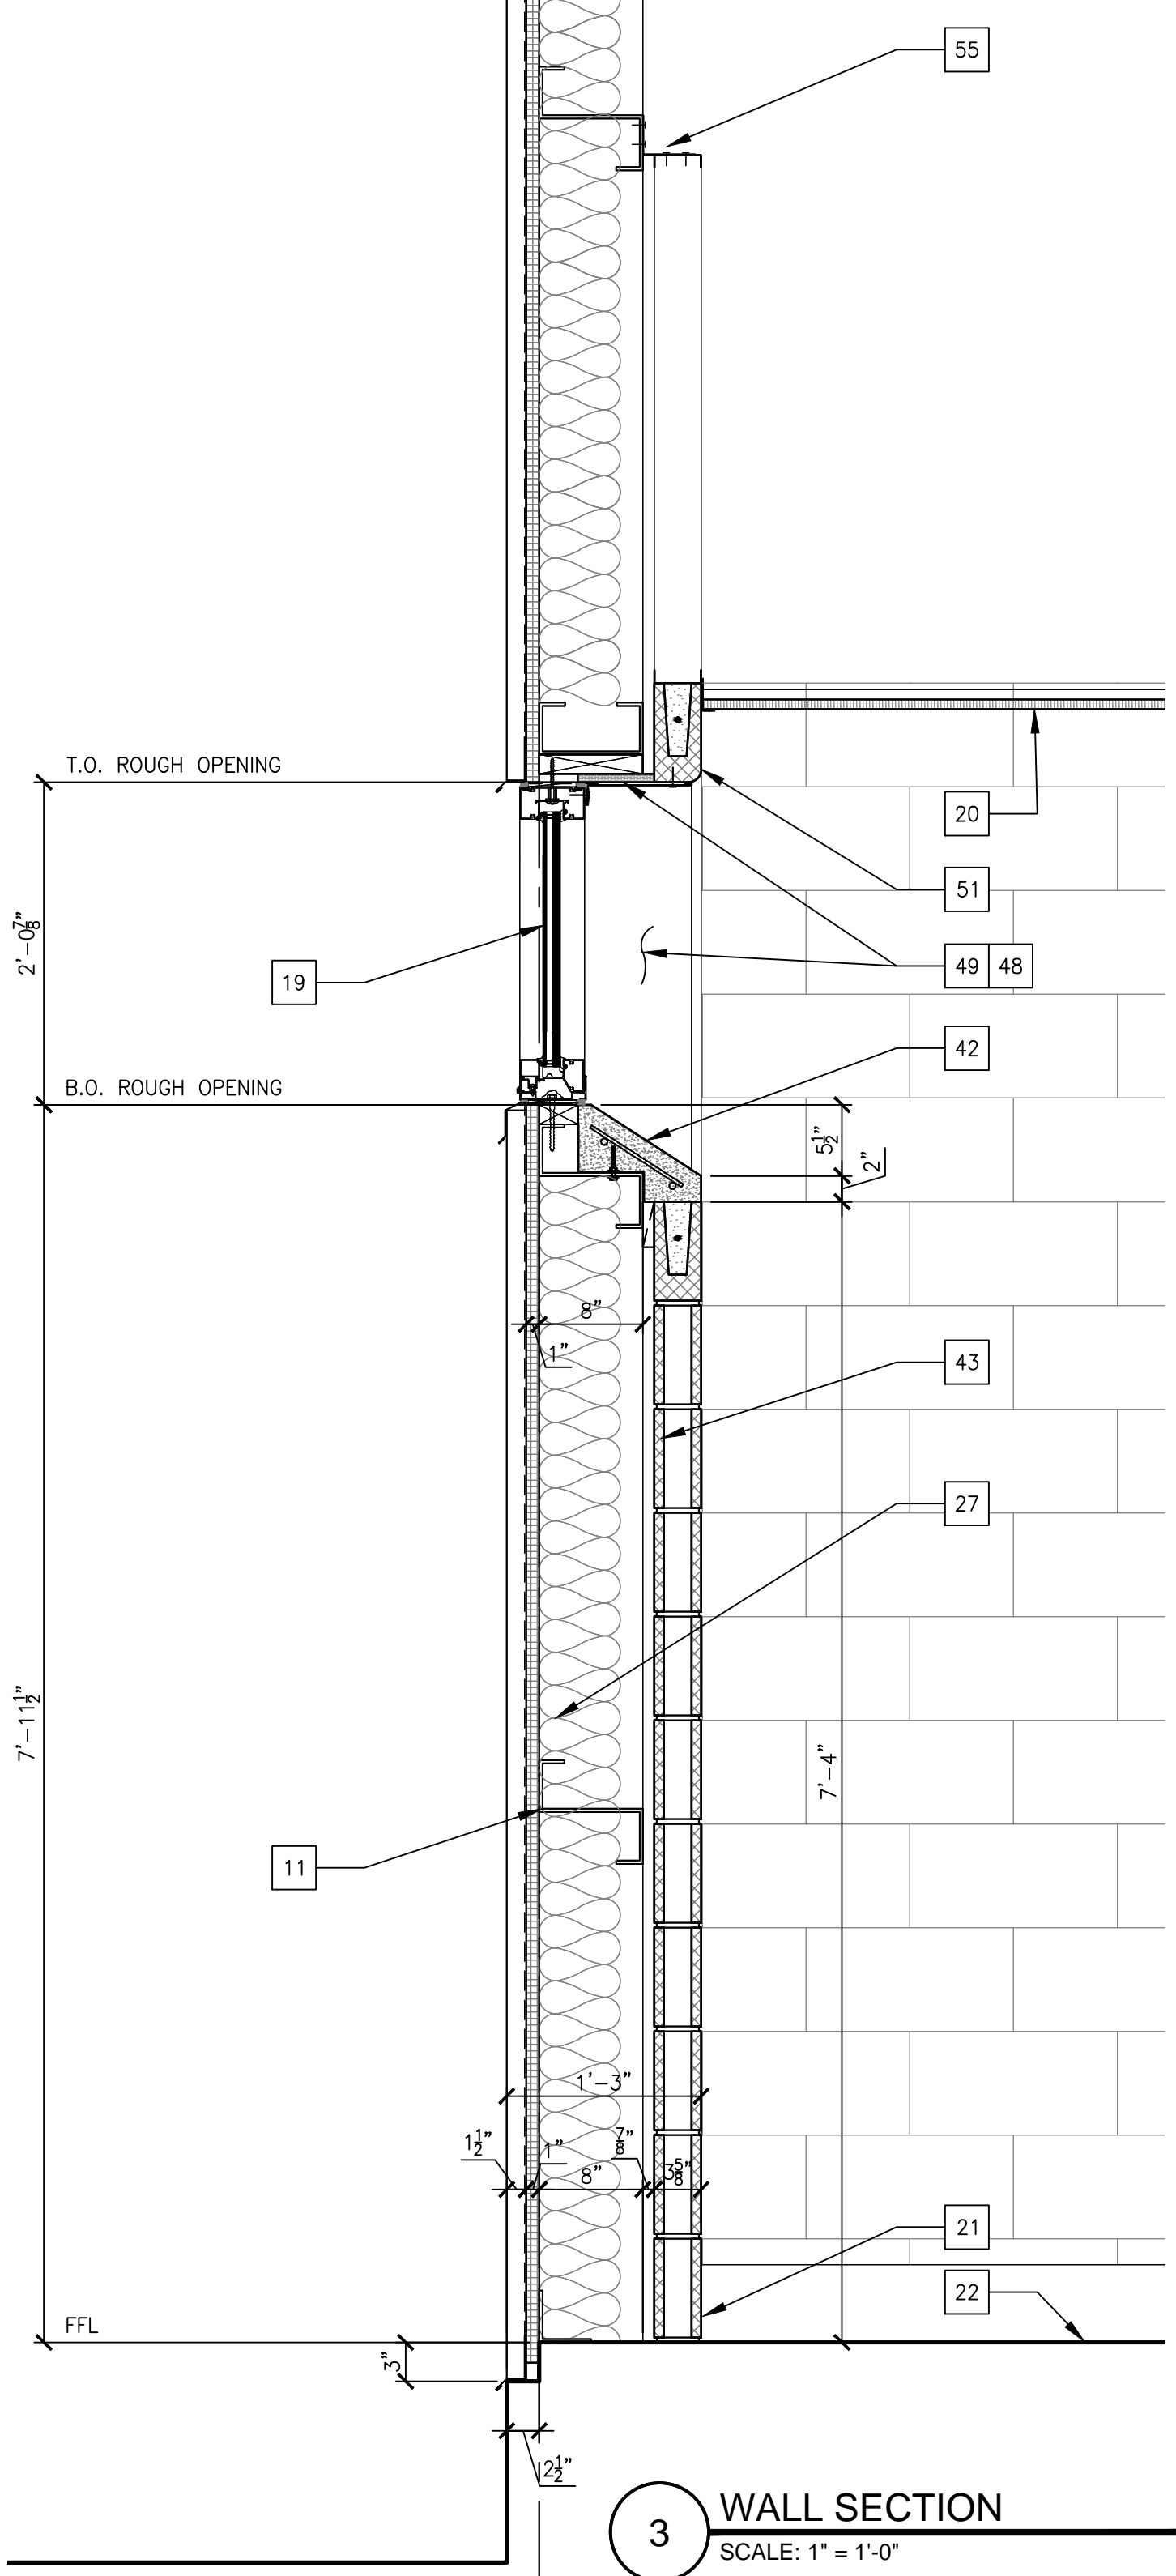

3 WALL SECTION
 SCALE: 1" = 1'-0"

KEYNOTES


1. KYNAR FINISH STANDING SEAM METAL ROOF
2. LINER SYSTEM WITH 1X3 THERMAL SPACER BLOCKS, R-19 TOP LAYER DRAPED OVER THERMAL SPACER BLOCK LINED STEEL PURLINS, R-11 BOTTOM LAYER VINYL FACED INSTALLED IN BETWEEN PURLINS AND HELD IN PLACE BY GALV. STEEL BANDS ANCHORED TO STEEL PURLINS.
3. KYNAR FINISH RAKE TRIM
4. KYNAR FINISH GUTTER WITH STRAPS AT 2'-0" O.C.
5. KYNAR FINISH DOWNSPOUT WITH STRAPS AT 2'-0" O.C.
6. PRE-ENGINEERED WALL HUNG METAL CANOPY WITH BRACKETS ENGINEERED FOR WINDSTORM RATING SPECIFIED AT STRUCT. DRAWINGS - KYNAR FINISH BY PRE-ENG. METAL BLDG. MANUFACTURER
7. KYNAR FINISH METAL PANEL SIDING WITH OUTSIDE/INSIDE CLOSURE (WHERE NEEDED) OVER DRAINABLE TYEKE WEATHER BARRIER OVER 1" POLYISO BOARD OVER STEEL GIRT/SPANDREL BEAM
8. KYNAR FINISH METAL PANEL SIDING (LAID HORIZONTALLY) OVER DRAINABLE TYEKE WEATHER BARRIER OVER 1" POLYISO BOARD OVER 6" METAL STUDS SPACED AT 8" O.C., REF. STRUCTURAL FOR SPACING OF METAL STUDS.
9. LONGBOARD ALUMINUM SIDING LAID HORIZONTALLY
10. BUILDING SIGNAGE: METALLIC LETTERS WITH STAND-OFF. VERIFY TEXT WITH OWNER
11. 8" STEEL GIRT, REF. PEMB DRAWINGS
12. 3 5/8" METAL STUDS WITH ONE LAYER OF 5/8" TYPE 'X' GYPSUM BOARD SPACED @ 16" O.C.
13. METAL CORNER BEAD, TYPICAL AT CORNERS
14. KYNAR FINISH THRU WALL FLASHING AND COUNTERFLASHING.
15. STRUCTURAL STEEL FRAME BY PRE-ENGINEERED METAL BUILDING MANUFACTURER. REF. SPECIFICATIONS.
16. STEEL ANGLE BY PEMB FOR CANOPY FLASHING ATTACHMENT
17. INSULATED HM DOOR AND FRAME, REF. SCHED.
18. STEEL SUPPORT FRAMING FOR ATTACHMENT OF APPENDAGES BY PEMB
19. ALUMINUM STOREFRONT WINDOW SYSTEM, TDI WINDSTORM RATED, PROVIDE ALUM. SUBSILL AND DAM EACH SIDE AT SILL, TYP.
20. FINISHED CEILING, REF. CEILING PLAN
21. BASE AS SCHED.
22. FINISHED FLOOR, REF. SCHED.
23. ADA ALUM. THRESHOLD, VERIFY RATING AT DOOR SCHED.
24. 15 MIL VAPOR BARRIER UNDER SLAB, REF. SPECIFICATION
25. SELF ADHERING AIR, VAPOR AND MOISTURE BARRIER AT WALL AND ROOF INTERSECTION, TYPICAL UNLESS NOTED OTHERWISE.
26. CORNER BEAD, TYP. AT CORNERS
27. R-13 UNFACED BATT INSUL. SECURED WITH POULTRY NETTING OR INSULATION HANGER
28. SELF ADHERED BASE FLASHING WITH TOP TERMINATION BAR, TYP.
29. 3/8" METAL STUD BRACING @ 4'-0" O.C. ATTACHED TO PURLINS, TYPICAL.
30. VAPOR SEALED EXTERIOR LIGHT, REF. ELECT. DWGS.
31. EXPOSED STRUCTURE PAINT ALL SURFACES BLACK FROM 20'-7" UP. REF. INTERIOR ELEVATIONS
32. KYNAR FINISH BASE TRIM WITH DRIP
33. PAINTED CAST IRON BOOT
34. CONCRETE SIDEWALK, REF. CIVIL
35. KYNAR FINISH EDGE TRIM
36. REINF. CONCRETE BENCH
37. STEEL BEAM, REF. PEMB DRAWINGS
38. STEEL ANGLE, REF. PEMB DRAWINGS
39. 3 5/8" METAL STUD @ 16" O.C. WITH 5/8" TYPE 'X' GYPSUM BOARD ON ONE SIDE
40. KYNAR FINISH SILL TRIM, SLOPED AND HEMMED AT LOW EDGE
41. ALUMINUM STOREFRONT WINDOW SYSTEM, TDI WINDSTORM RATED, PROVIDE ALUM. SUBSILL AND DAM EACH SIDE AT SILL, TYP.
42. CAST-IN PLACE CONCRETE SILL WITH REINFORCEMENT
43. CMU WALL WITH BOND BEAM, REF. STRUCT.
44. KYNAR FINISH PARAPET HIGH SIDE EAVE FLASH
45. CAST ALUMINUM BUILDING SIGN BY OWNER
46. APPLY SEALANT AROUND PENETRATIONS/INTERSECTIONS
47. KYNAR FINISH FLASHING AND CONT. CLEAT, APPLY SEALANT.
48. ALUMINUM CLOSURE BRAKE METAL TRIM
49. 3/8" MOISTURE RESIST. GYP. BD. AROUND WINDOW OPENINGS., TYP. U.N.O.
50. STAINLESS STEEL DIAMOND CUT MESH INSTALLED OVER GUTTER INLET WITH STAINLESS STEEL SCREWS TO PREVENT TENNIS BALL OBSTRUCTIONS
51. CMU LINTEL BLOCK(S) AT OPENINGS W/ BULLNOSE AT EXPOSED CORNER, TYP. REF. STRUCT. FOR NUMBER OF COURSES.
52. END WALL COLUMN BY PEMB
53. BEARING FRAME RAFTER BY PEMB
54. RAKE ANGLE BY PEMB
55. CLIP ANGLE CONNECTOR TO GIRT AND METAL STUDS

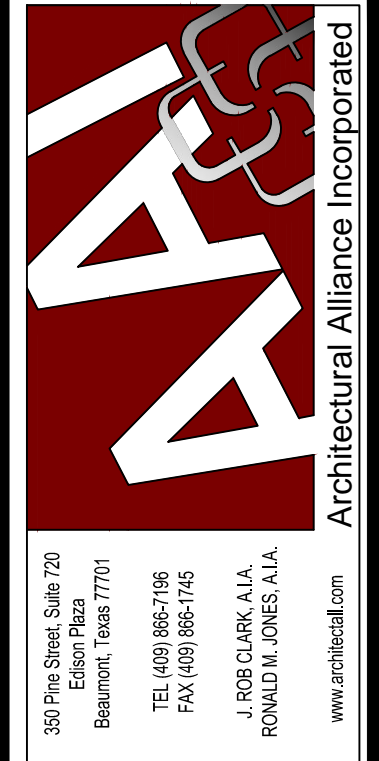

WEST BROOK AUXILIARY FIELD HOUSE
 Beaumont Independent School District
 8750 Phelan Blvd
 Beaumont, TX 77706

| | |
|-----------------------------|-------------------------------------|
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| DATE: 1/26/2021 | |
| DESIGN DEVELOPMENT | <input type="checkbox"/> |
| DATE: ---- | |
| BIDS & CONSTRUCTION | <input checked="" type="checkbox"/> |
| DATE: 4/18/2022 | |
| REVISION: | DATE: |
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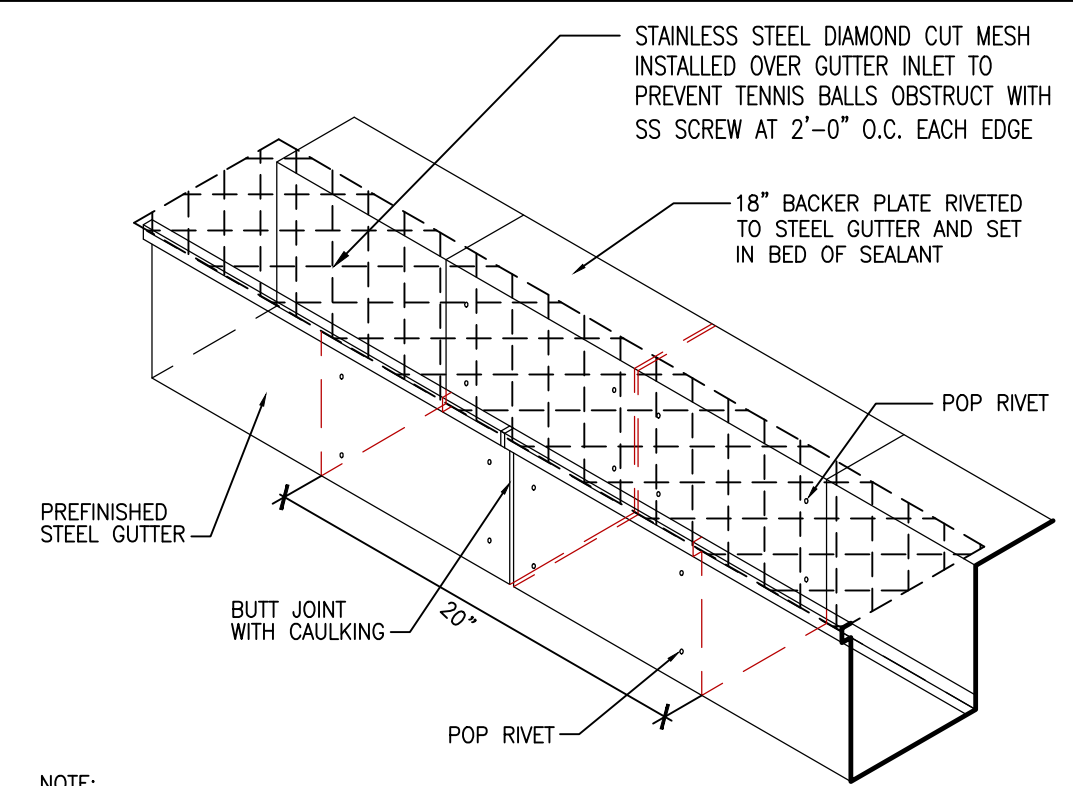
DRAWINGS SHEET TITLE
WALL SECTIONS
 SHEET NUMBER
A702
 PROJECT NUMBER
 21021

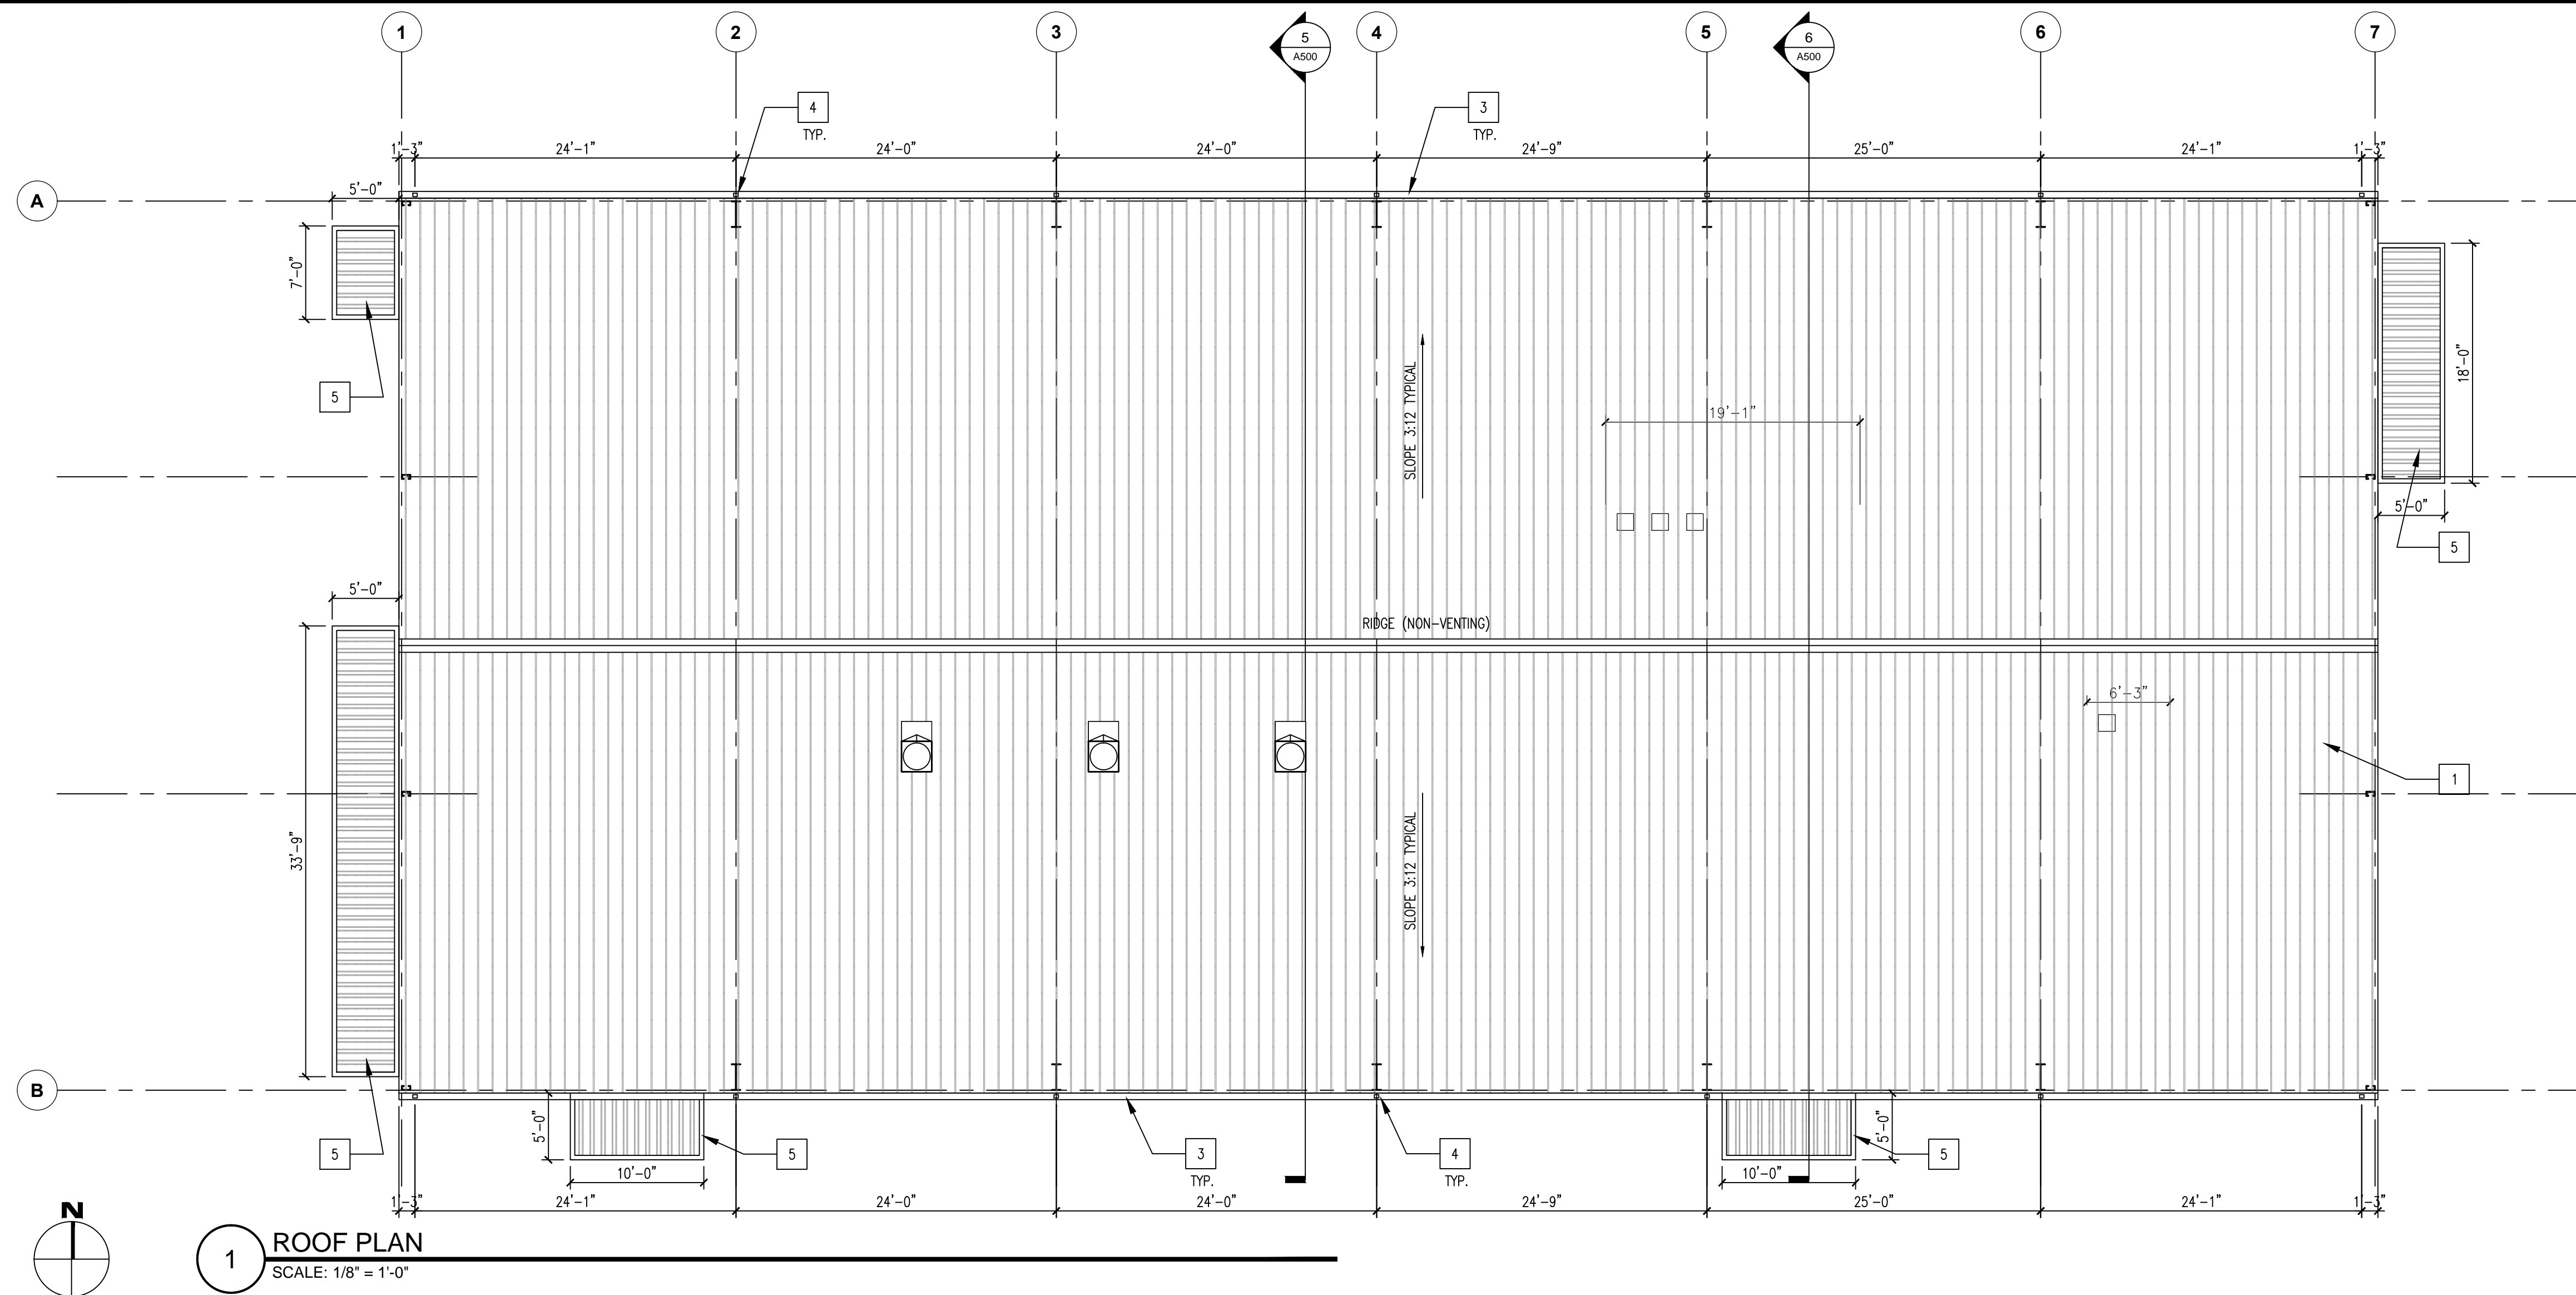

1 ROOF PLAN
SCALE: 1/8" = 1'-0"

ROOF NOTES

1. KYNAR FINISH STANDING SEAM METAL ROOF - TDI RATED AND CERTIFIED FOR 144 MPH WINDSTORM
2. NOT USED
3. KYNAR FINISH GUTTER WITH STRAPS AT 2'-0" O.C. MAX SPACING
4. KYNAR FINISH DOWNSPOUT WITH BRACKETS AT 3'-0" O.C. MAX SPACING
5. KYNAR FINISH WALL-HUNG CANOPY WITH BRACKETS BY PEMB - TDI RATED AND CERTIFIED FOR 144 MPH WINDSTORM (VERIFY LOCATION OF DRAIN OUTLET)
6. OPTIONAL SOLATUBE WITH PREMANUFACTURED CURB BY ROOF - TDI RATED AND CERTIFIED FOR 144 MPH WINDSTORM



2 GUTTER SPLICING DETAIL
SCALE: 1 1/2" = 1'-0"

AAI
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J. ROBB CLARK, A.I.A.
RONALD H. JONES, A.I.A.
www.aaiarch.com

REGISTERED ARCHITECT
STATE OF TEXAS
8217
4/19/2022

REGISTERED ARCHITECT
STATE OF TEXAS
13662
4/19/2022

WEST BROOK AUXILIARY FIELD HOUSE
Beaumont Independent School District

8750 Phelan Blvd
Beaumont, TX 77706


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DRAWINGS SHEET TITLE
ROOF PLAN

SHEET NUMBER
A900

21021
PROJECT NUMBER


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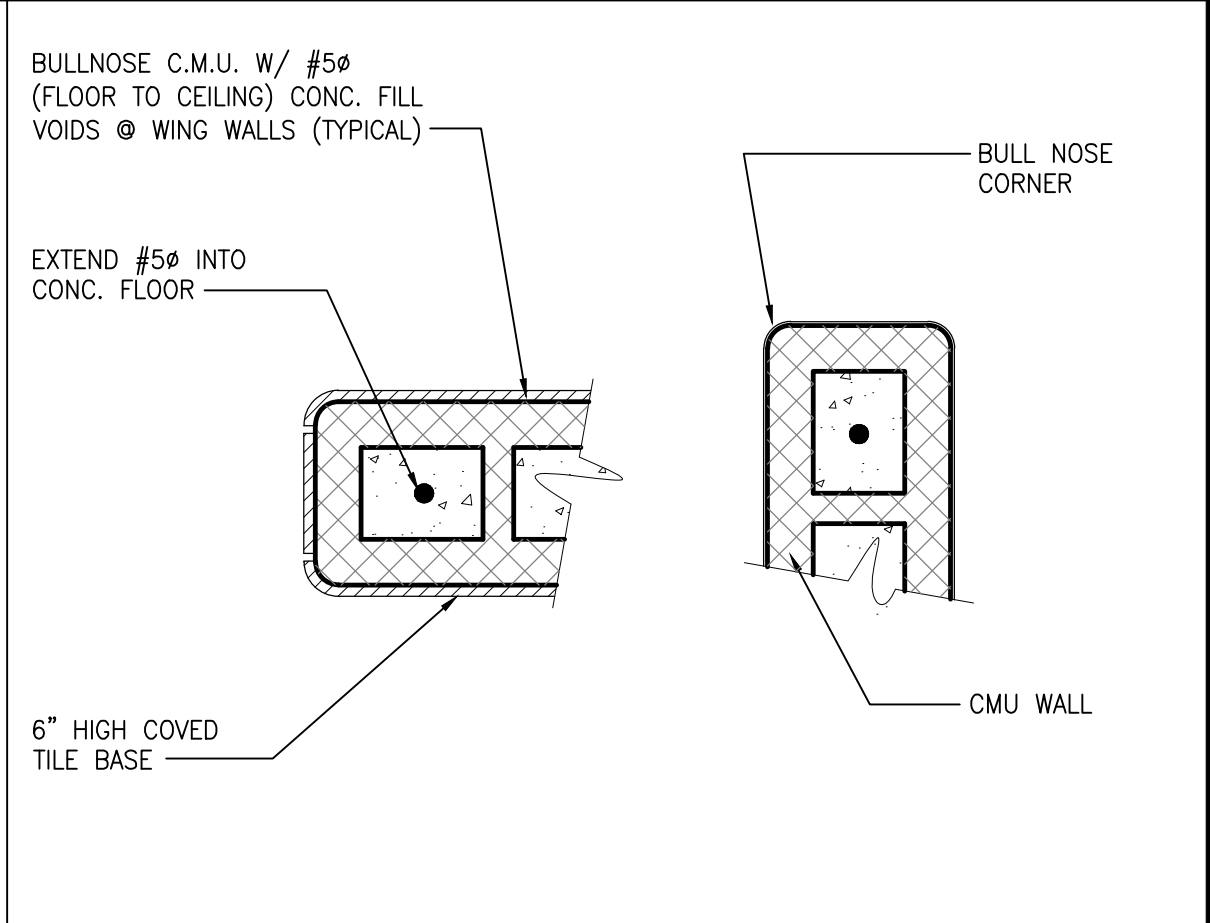
FINISH SCHEDULE

| | |
|--------------------------|---|
| FLOOR | F1 SEALED CONCRETE |
| | F2 (ALTERNATE #1) 1/2" EXERCISE RUBBER FLOORING AT STRENGTH TRAINING AND CONDITIONING 103 |
| | F3 AMERICAN OLEANS CERAMIC TILE COLOR TBD |
| | F4 (ALTERNATE #2) LVT TILES AT COACH OFC SPACES 102, BREAK/CONFERENCE 145, COACH LOCKERS 104, COACH LOCKERS 119, COACH OFC SPACE, 121 |
| BASE | B1 6" ROPPE RUBBER BASE |
| | B2 AMERICAN OLEANS 6" CERAMIC COVERED BASE |
| WALLS | W- VERIFY INTERIOR ELEVATIONS FOR CERAMIC WALL TILE PATTERN |
| | W1 SHERWIN WILLIAM PAINT - COLOR:TBD |
| | W2 AMERICAN OLEANS COLOR STORY CERAMIC WALL TILE TO HEIGHT INDICATED ON INTERIOR ELEVATIONS COLOR A 4X12 |
| | W3 AMERICAN OLEANS COLOR STORY CERAMIC WALL TILE TO HEIGHT INDICATED ON INTERIOR ELEVATIONS COLOR B 4X12 |
| | W4 AMERICAN OLEANS COLOR STORY CERAMIC WALL TILE TO HEIGHT INDICATED ON INTERIOR ELEVATIONS COLOR C 4X12 |
| | W5 AMERICAN OLEANS COLOR STORY CERAMIC WALL TILE TO HEIGHT INDICATED ON INTERIOR ELEVATIONS COLOR D 4X12 |
| CEILING | C1 ARMSTRONG FINE FISSURED HIGH NRC 1732 15/16 ANGLED TEGULAR 24" X 24" WITH 15/16 PRELUDE XL |
| | C2 2 LAYERS OF MOISTURE RESISTANT DRYWALL ON SUSPENSION GRID SYSTEM WITH EPOXY PAINTED FINISH (REFERENCE PLAN FOR CJ LOCATION) |
| | C3 EXPOSED STRUCTURE |
| PLASTIC LAMINATE | PL-1 WILSONART - (CABINET) COLOR:TBD |
| | PL-2 WILSONART - (COUNTERTOP) COLOR:TBD |
| QUARTZ COUNTERTOP | |


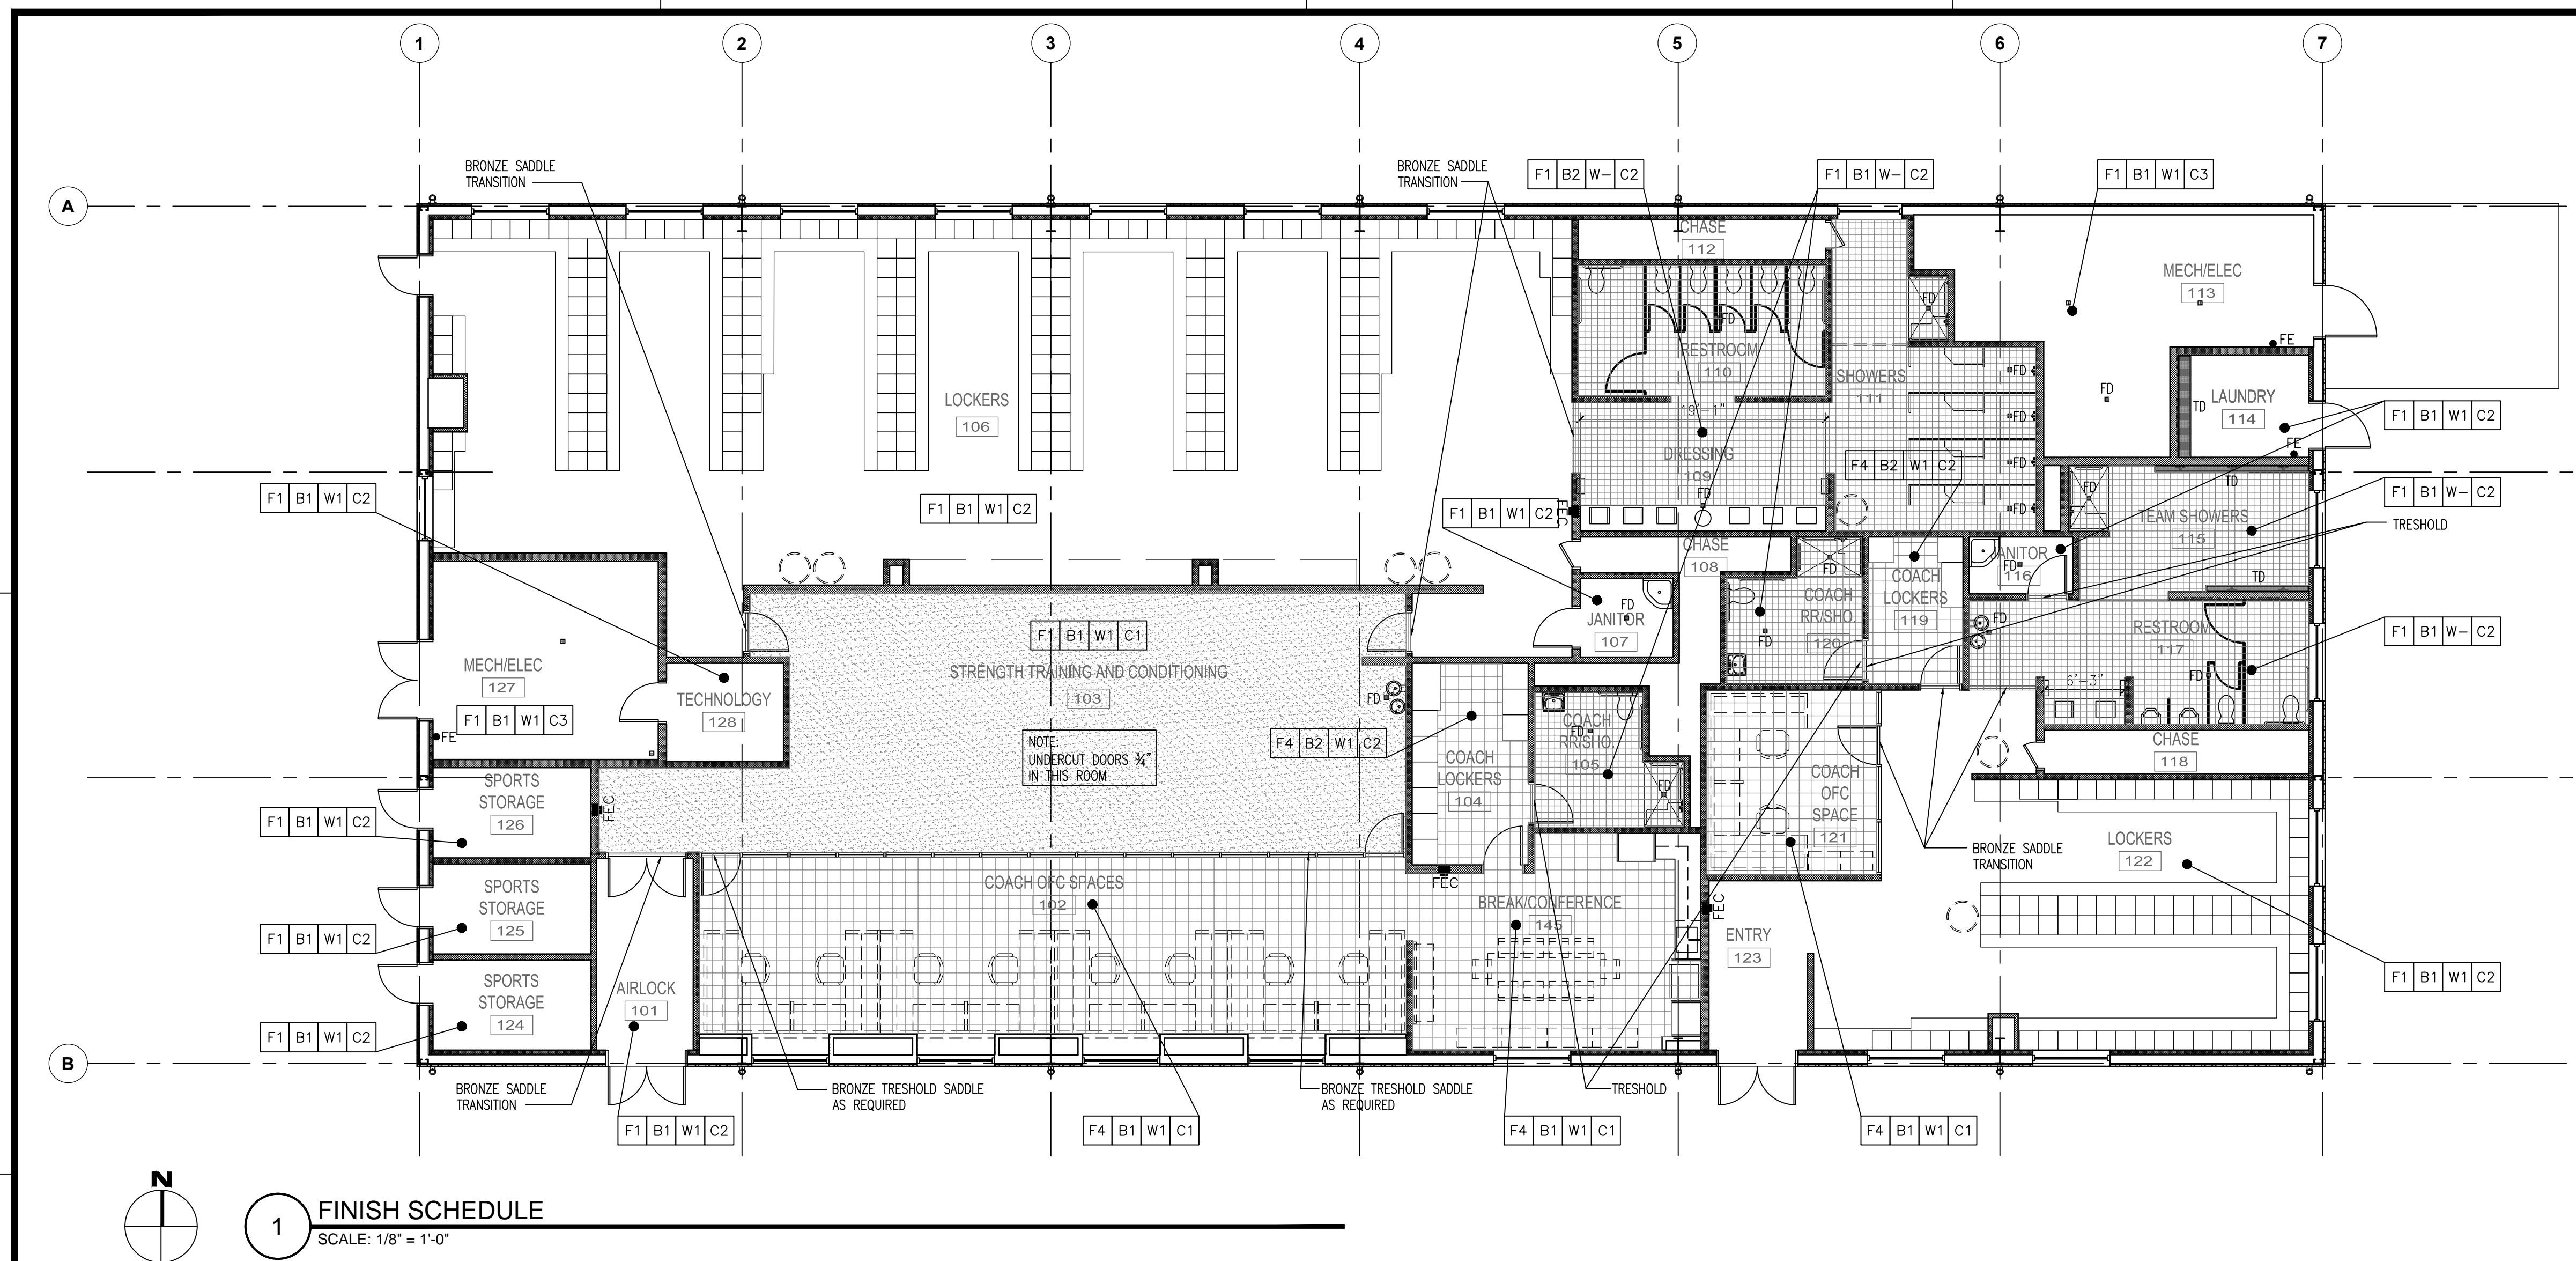
1 FINISH SCHEDULE
SCALE: 1/8" = 1'-0"



3 BULLNOSE - ISOMETRIC DETAIL
SCALE: NTS

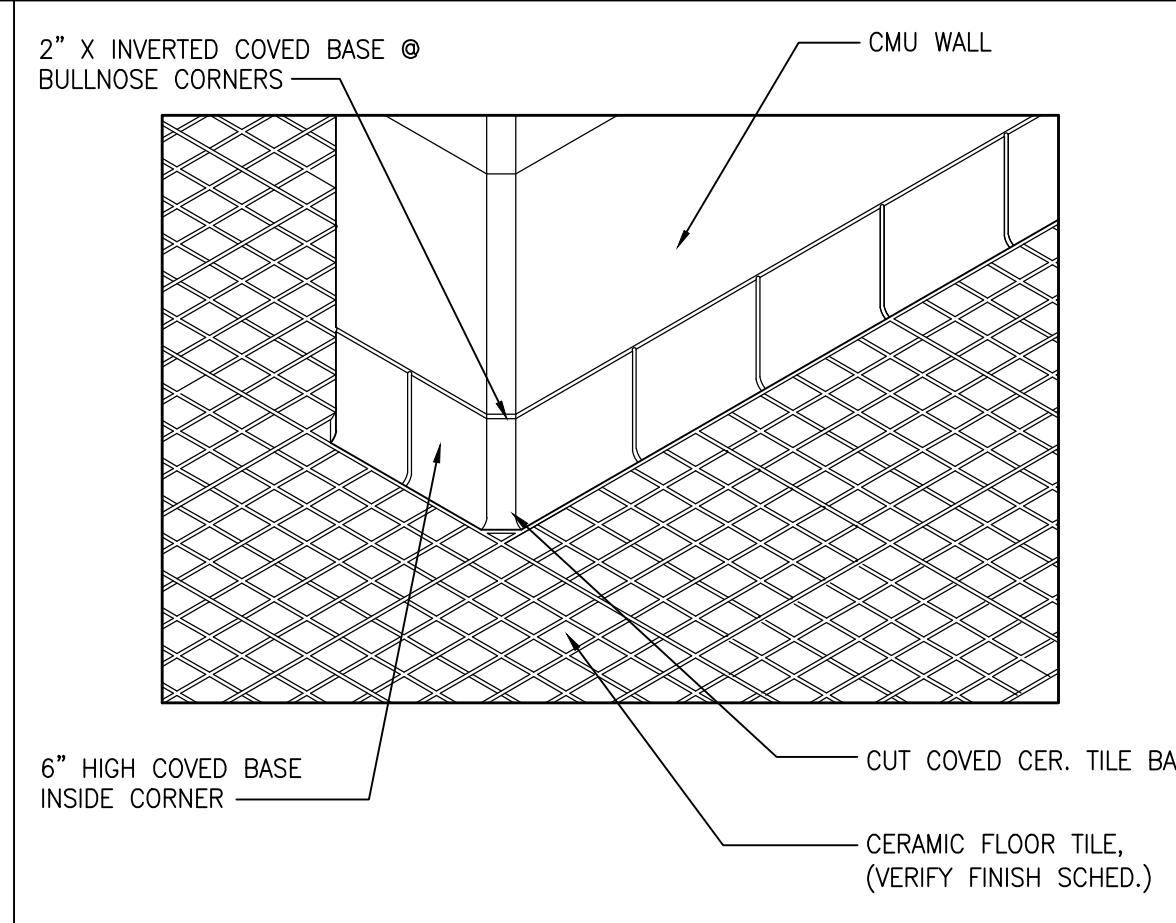

2 BULLNOSE DETAIL - PLAN
SCALE: NTS

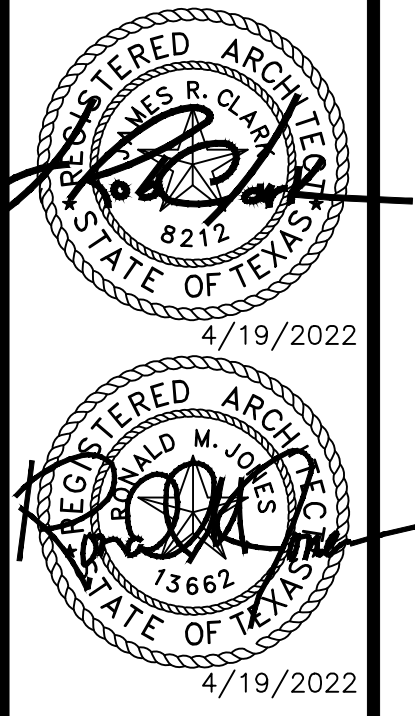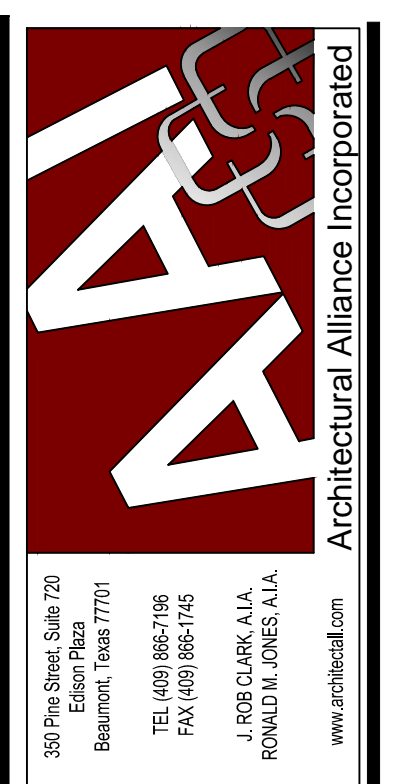


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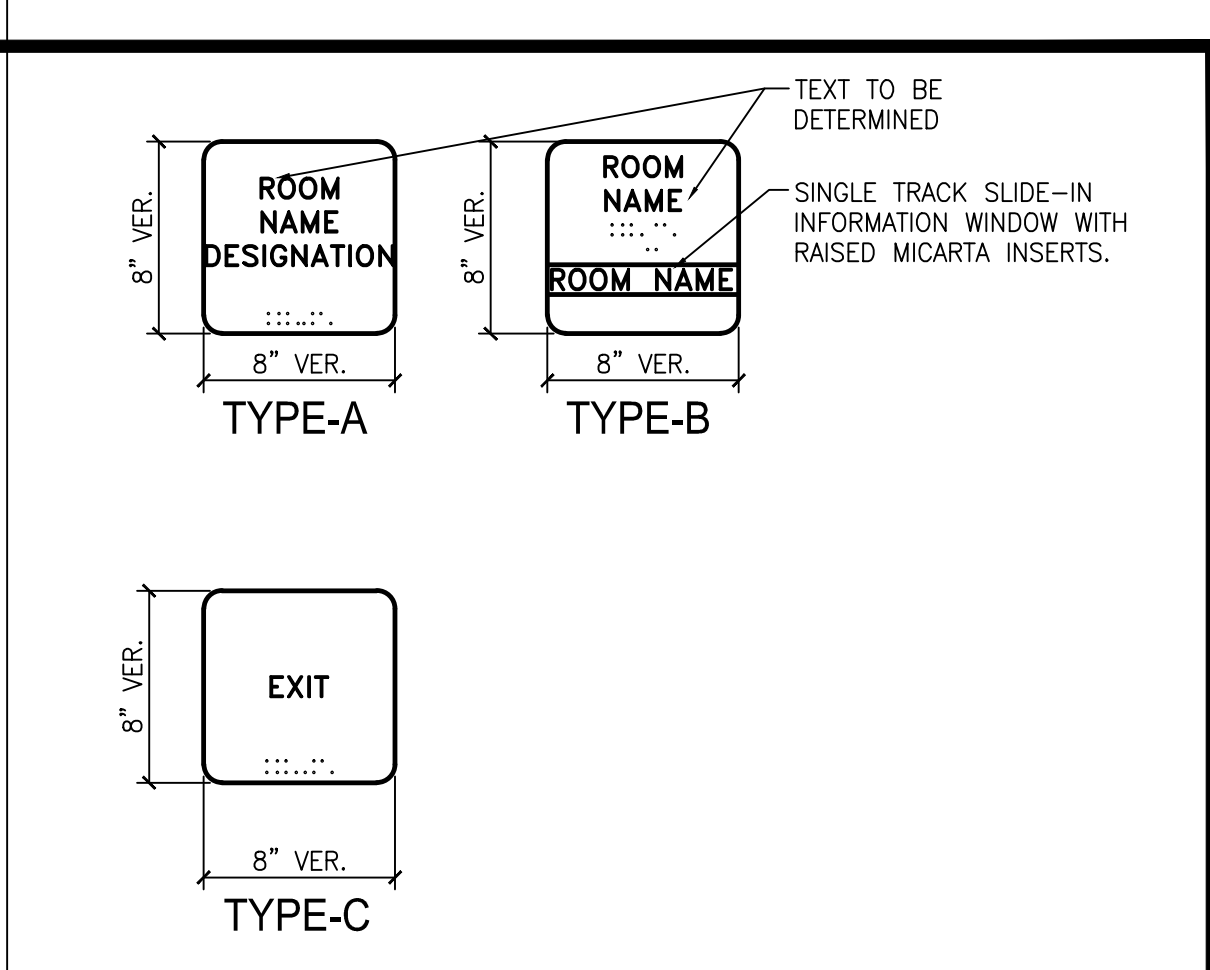
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| DESIGN DEVELOPMENT | <input type="checkbox"/> |
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| DATE: 4/18/2022 | |
| REVISION: | DATE: _____ |
| REVISION: | DATE: _____ |
| REVISION: | DATE: _____ |

| | |
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| DRAWINGS SHEET TITLE | FINISH SCHEDULE |
| SHEET NUMBER | F100 |
| PROJECT NUMBER | 21021 |

SAVED: MICHAELM
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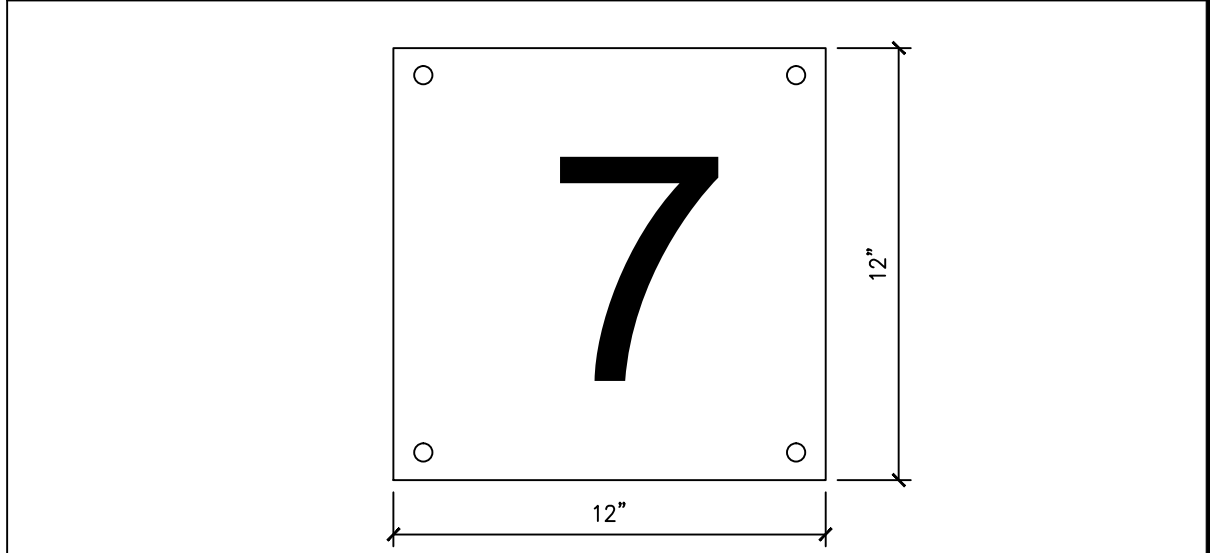
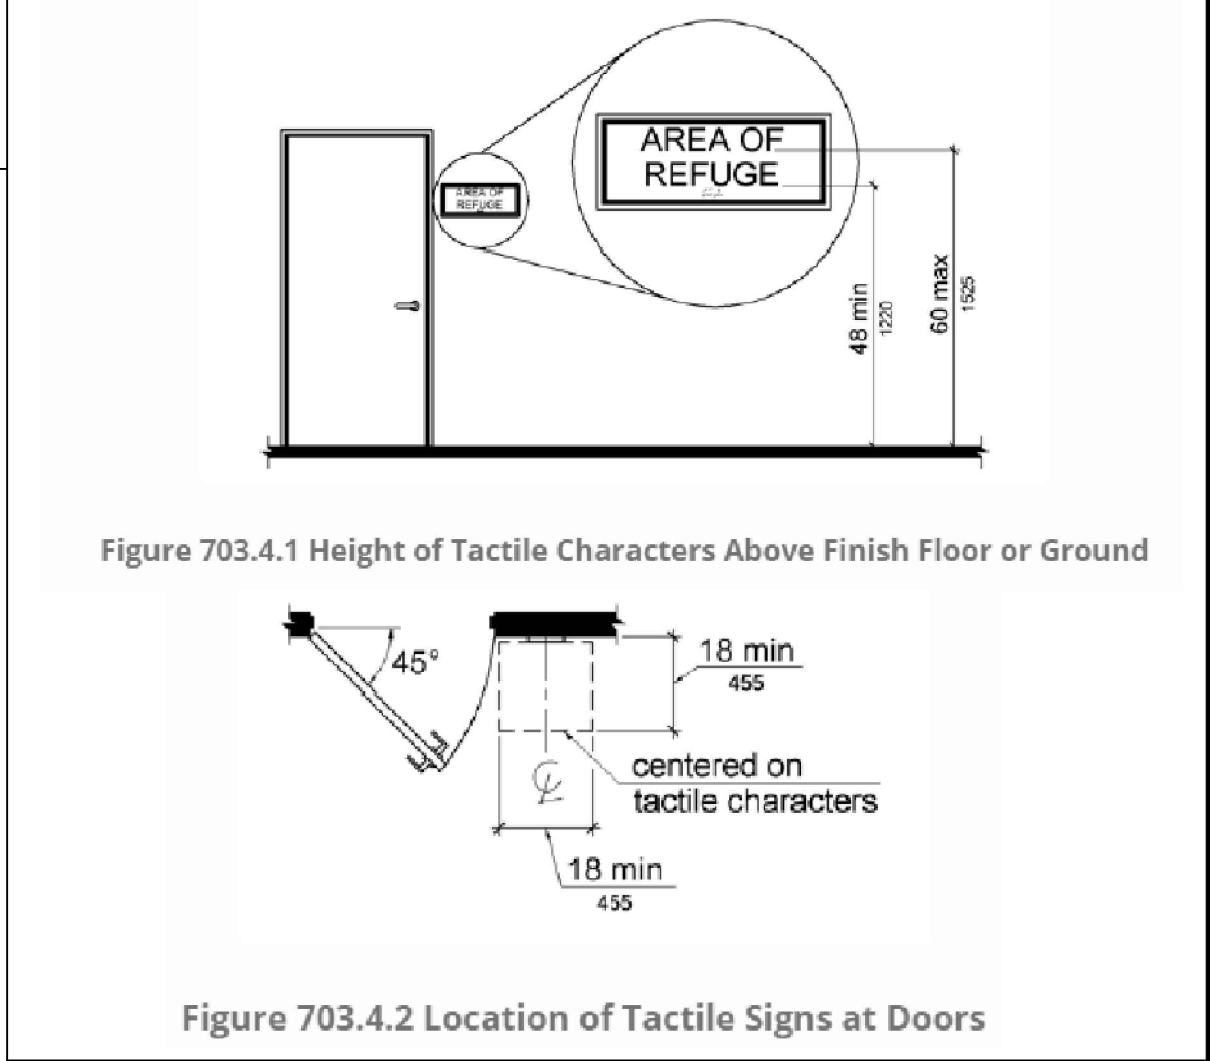
1 SIGNAGE FLOOR PLAN
SCALE: 1/8" = 1'-0"

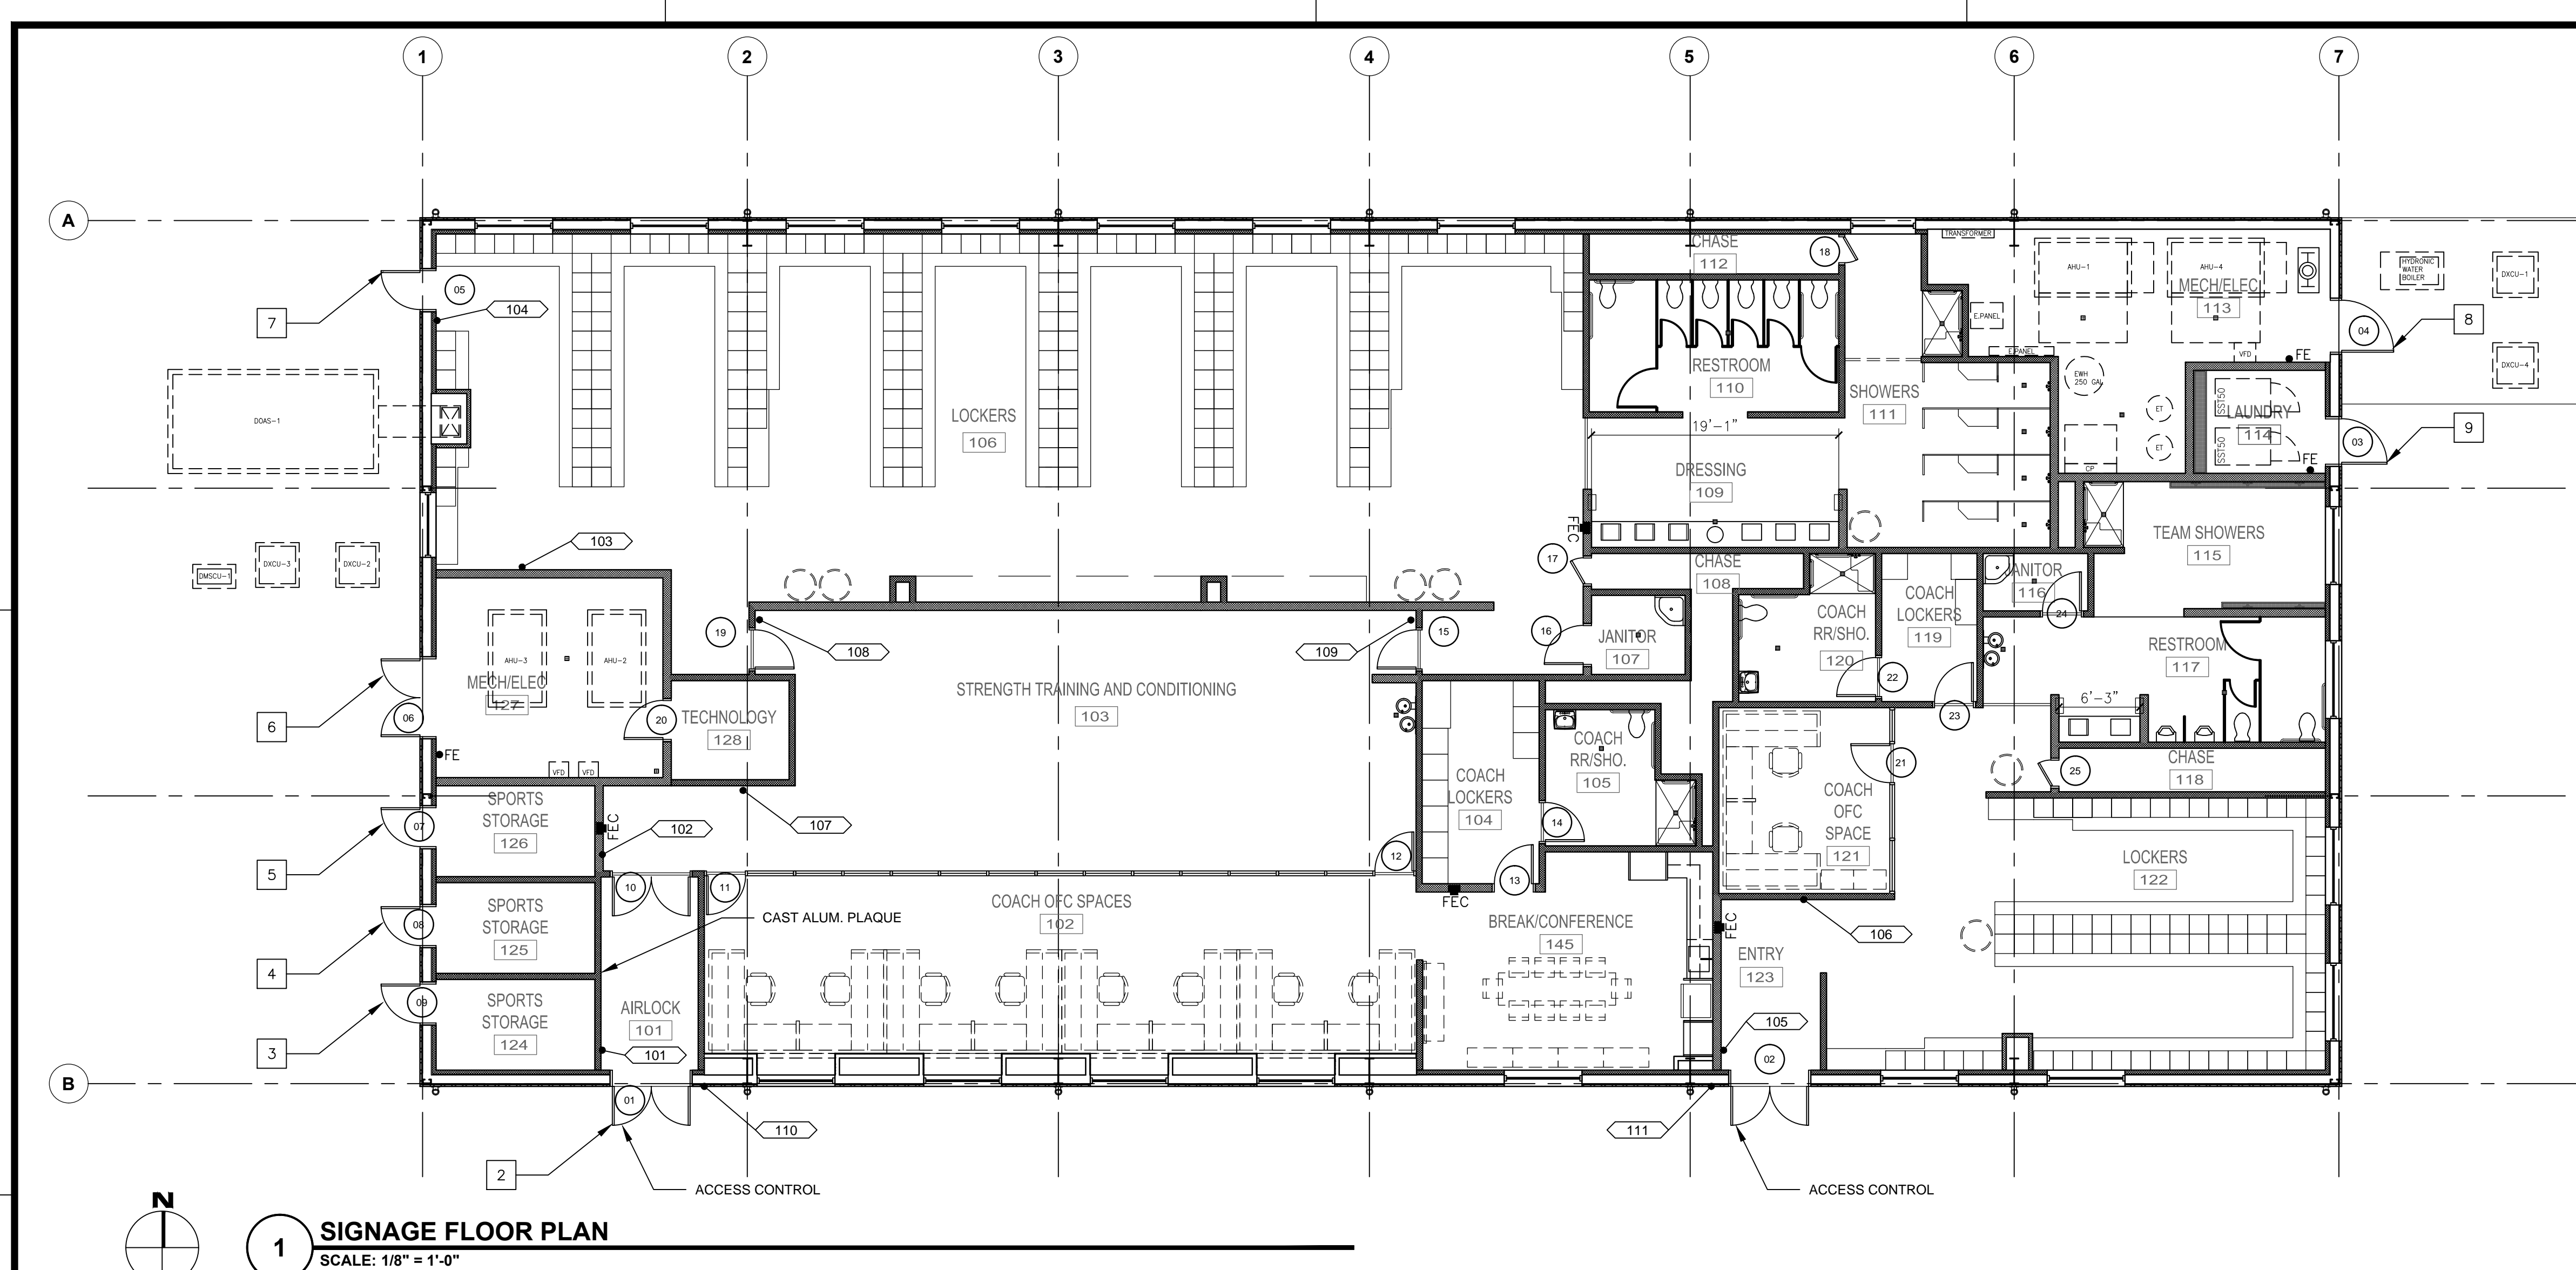

2 SIGNAGE DETAIL
SCALE: NTS

- SIGNAGE GENERAL NOTES**
1. VERIFY ALL SIGNAGE WITH OWNER/ARCHITECT.
 2. PROVIDE RAISED MICARTA SIGNAGE WITH 3/4" HIGH TEXT AND ADA COMPLIANT BRAILLE. VERIFY
 3. ALL ROOM SIGNAGE TO BE MOUNTED 4'-0" MIN TO BOTTOM OF TACTILE CHARACTERS ABOVE FINISH FLOOR TO ADA STANDARD AS DIRECTED BY ARCHITECT.
 4. ALL ROOM SIGNAGE TO BE MOUNTED WITH A CLEAR FLOOR SPACE OF 18" MIN X 18" MIN CENTERLINE OF TACTILE CHARACTERS, BEYOND THE ARC OF THE DOOR SWING TO ADA STANDARD AS DIRECTED BY ARCHITECT.
 5. ALL TEXT AND COLORS TO BE VERIFIED PRIOR TO PREPARATION OF SHOP DRAWINGS.
 6. PROVIDE SCALED LAYOUT OF ALL SIGNAGE.
 7. BRAILLE TEXT SHOWN FOR GRAPHIC REPRESENTATION PURPOSES ONLY, VERIFY CORRECT TEXT.

3 SIGNAGE NOTES
SCALE: NTS




- NOTE:**
1. FURNISH AND INSTALL NINE (9) 12" X 12" EMERGENCY EXIT IDENTIFICATION DOOR METAL SIGNAGE UNITS WITH NUMBERS 2 THROUGH 10 TO BE INSTALLED ON THE UPPER CENTER OF EACH SIDE (INSIDE/OUTSIDE FACE OF DESIGNATED PERIMETER EXIT DOORS AND MECHANICALLY AND GLUE FASTENED). IF PAIRS, INSTALL ON ONE OF THE DOORS. ADDITIONALLY, FURNISH AND INSTALL THE MANDATORY ENGRAVED MICARTA EXIT SIGN WITH BRAILLE TEXT INSTALLED AT STANDARD SIGN HEIGHT PER SIGNAGE DRAWING REQUIREMENTS AT EACH OF THESE 9 DOORS MOUNTED ONE SIDE OF THE HALLWAY (VERIFY WITH ARCHITECT PRIOR TO INSTALLATION). TEXT MINIMUM 6" HEIGHT AND 1" STROKE WIDTH.

4 TEA SCHOOL SECURITY GUIDELINE
SCALE: NTS

SIGNAGE SCHEDULE

| DOOR NO. | SIGN TYPE | SIGN NO. | SIGN TEXT (VERIFY TEXT WITH OWNER) | DOOR NO. | SIGN TYPE | SIGN NO. | SIGN TEXT (VERIFY TEXT WITH OWNER) |
|----------|-----------|----------|------------------------------------|----------|-----------|----------|------------------------------------|
| 01 | C | 101 | EXIT | | | | |
| 02 | C | 102 | EXIT | | | | |
| | C | 103 | EXIT | | | | |
| 05 | C | 104 | EXIT | | | | |
| 02 | C | 105 | EXIT | | | | |
| 02 | A | 106 | BOY'S LOCKERS | | | | |
| 11 | A | 107 | GIRL'S STRENGTH TRAINING | | | | |
| 19 | A | 108 | GIRL'S LOCKERS | | | | |
| 15 | A | 109 | GIRL'S LOCKERS | | | | |
| 01 | A | 110 | GIRL'S FIELD HOUSE | | | | |
| 02 | A | 111 | BOY'S FIELD HOUSE | | | | |

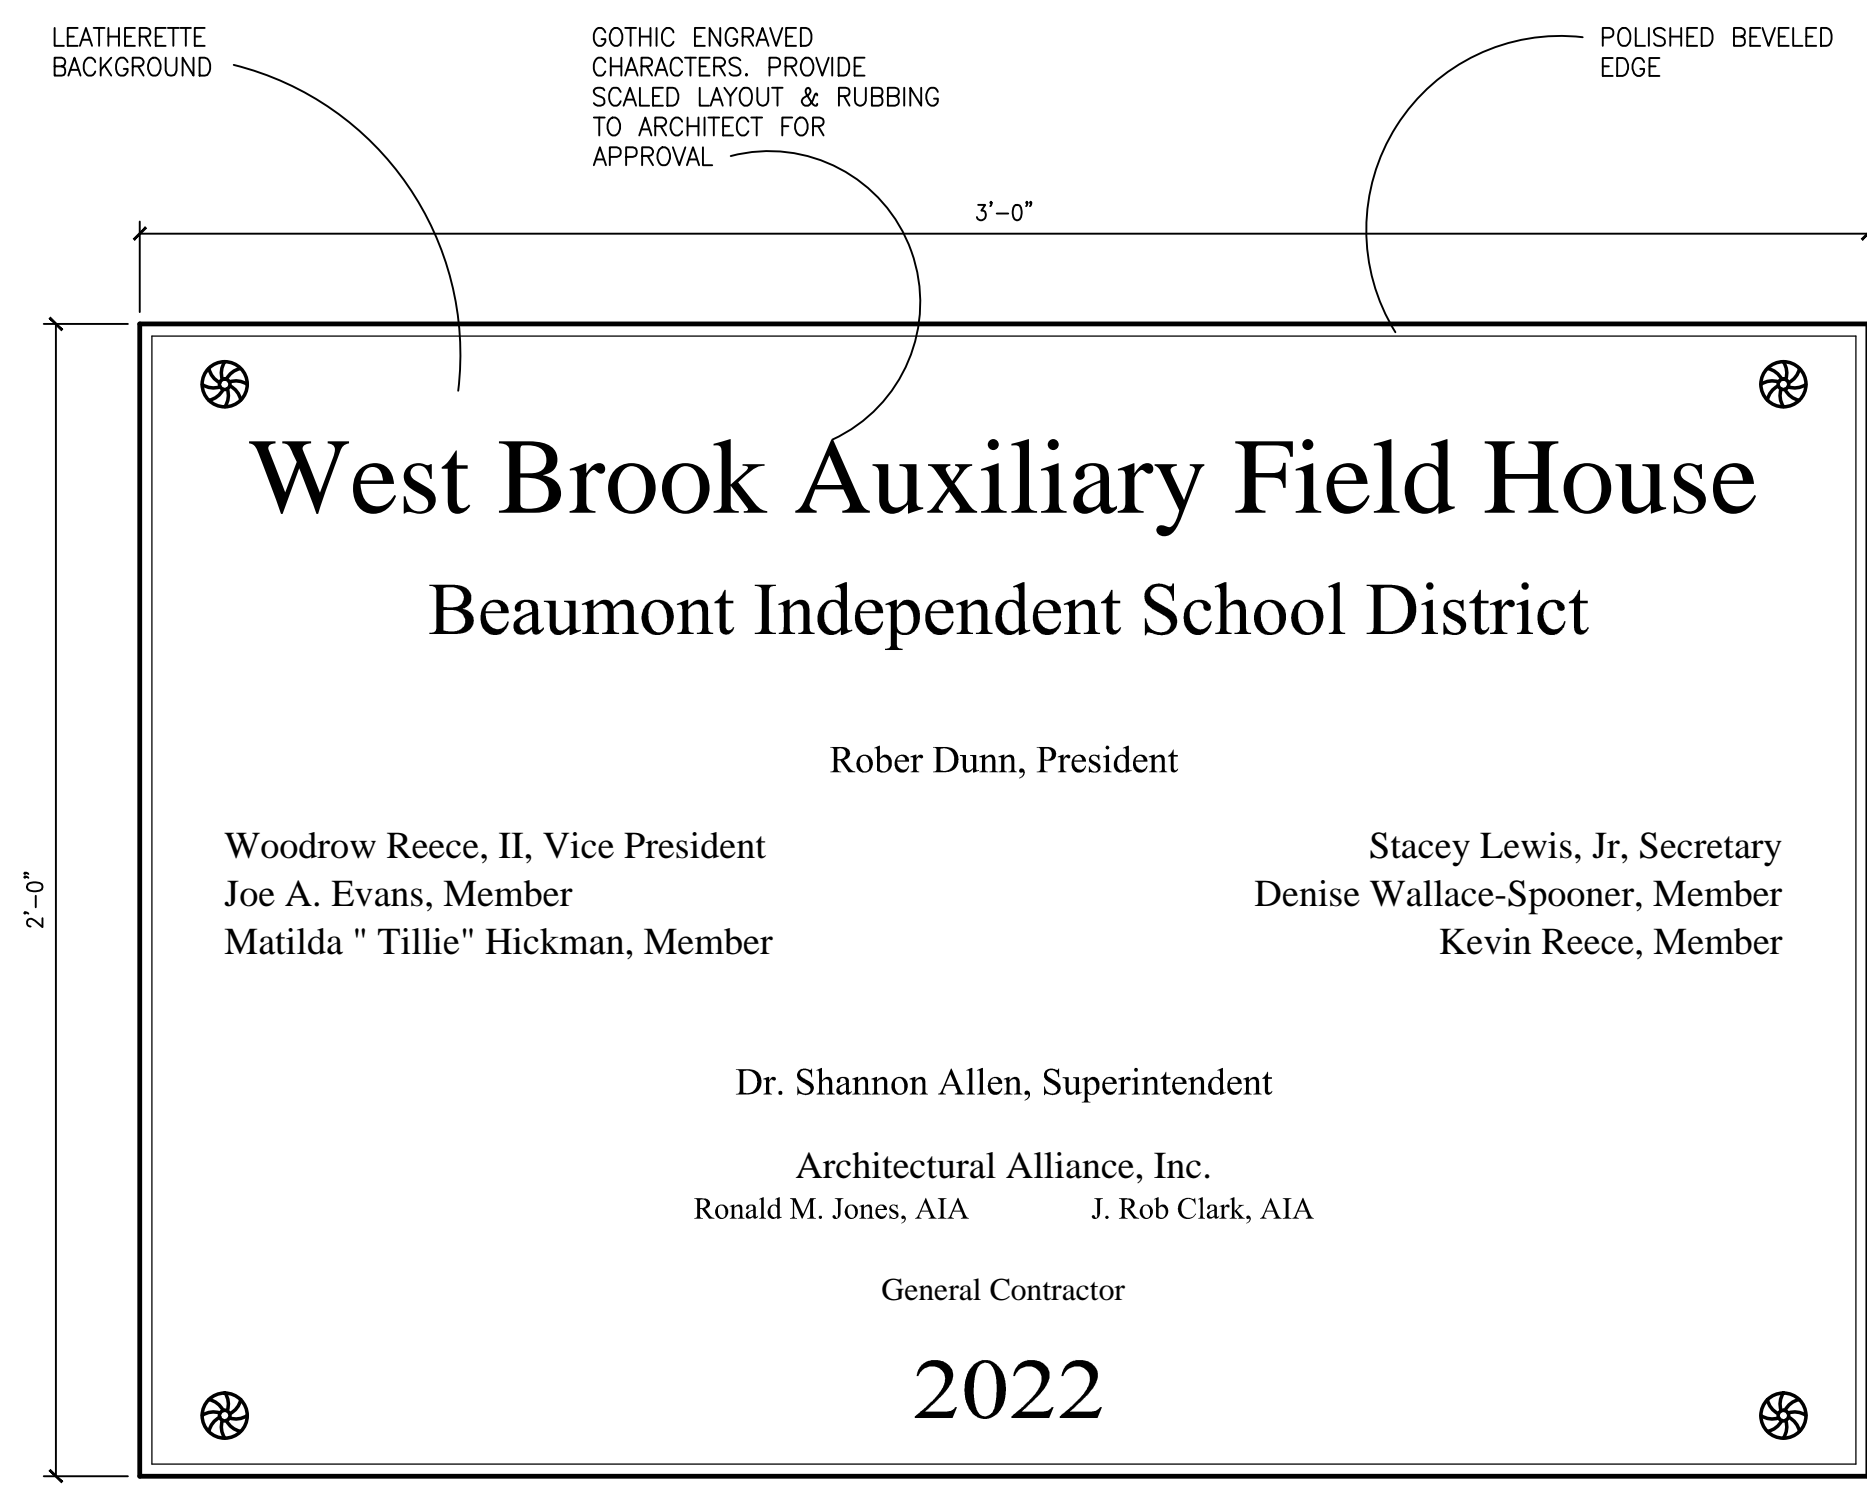

5 CAST ALUMINUM PLAQUE
SCALE: NTS

- NOTE:**
1. CONTRACTOR TO VERIFY ALL TEXT AND MUST BE SIGNED AND APPROVED BY SCHOOL BOARD.
 2. INSTALL IN LOCATION AS DIRECTED BY ARCHITECT.

Architectural Alliance Incorporated
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ISSUED FOR SCHEMATIC DESIGN DATE: 1/26/2021
DESIGN DEVELOPMENT DATE: ----
BIDS & CONSTRUCTION DATE: 4/18/2022

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REVISION: DATE: _____
REVISION: DATE: _____

DRAWINGS SHEET TITLE
SIGNAGE FLOOR PLAN

SHEET NUMBER
SN101

21021
PROJECT NUMBER

SAVED: MICHAEL M
PLOT: MICHAEL MGTAN
PLOT DATE: 4/19/2022 10:55 AM
SHEET SIZE: ARCH (expand D) 08.00 x 24.00 (inches)