

DEFINE

MECHANICAL ABBREVIATIONS

AD	ACCESS DOOR	HWS	HEATING HOT WATER SUPPLY
ADA	AMERICANS WITH DISABILITIES ACT	HWR	HEATING HOT WATER RETURN
AFF	ABOVE FINISHED FLOOR	KH	KITCHEN HOOD
AHU	AIR HANDLING UNIT	KW	KILOWATT
APD	AIR PRESSURE DROP	LAT	LEAVING AIR TEMPERATURE
BOD	BOTTOM OF DUCT	LWT	LEAVING WATER TEMPERATURE
BOP	BOTTOM OF PIPE	MBH	1000 BRITISH THERMAL UNITS PER HOUR
BTUH	BRITISH THERMAL UNITS PER HOUR	MVD	MANUAL VOLUME DAMPER
C	CONDENSATE	N.O.	NORMALLY OPEN
CFM	CUBIC FEET PER MINUTE	N.C.	NORMALLY CLOSED
CT	CHILLER	NTS	NOT TO SCALE
CHS	CHILLED WATER SUPPLY	NC	NOISE CRITERIA
CHR	CHILLED WATER RETURN	OA	OUTSIDE AIR
COP	COEFFICIENT OF PERFORMANCE	OBD	OPPOSED BLADE DAMPER
CT	COOLING TOWER	PD	PRESSURE DROP
CU	CONDENSING UNIT	PHWR	PLANT HEATING HOT WATER RETURN
CV	CONSTANT VOLUME	PHWS	PLANT HEATING HOT WATER SUPPLY
CS	CONDENSER WATER SUPPLY	PRV	PRESSURE REDUCING VALVE
CR	CONDENSER WATER RETURN	PSIG	POUNDS PER SQUARE INCH GAGE
DB	DRY BULB	RA	RETURN AIR
DOAS	DEDICATED 100% OUTSIDE AIR UNIT	RH	RELATIVE HUMIDITY
EA	EXHAUST AIR	RHC	REHEAT COIL
EAT	ENTERING AIR TEMPERATURE	RPM	REVOLUTIONS PER MINUTE
ECO	EXTERIOR CLEANOUT	RTU	ROOFTOP A/C UNIT
EDH	ELECTRIC DUCT HEATER	SA	SUPPLY AIR
EER	ENERGY EFFICIENCY RATIO	SD	STORM DRAIN
EF	EXHAUST FAN	SEER	SEASONAL ENERGY EFFICIENCY RATIO
EMS	ENERGY MANAGEMENT SYSTEM	SF	SUPPLY FAN
ESP	EXTERNAL STATIC PRESSURE	SP	STATIC PRESSURE
EUH	ELECTRIC UNIT HEATER	SWR	SIDE WALL REGISTER
EWC	ELECTRIC WATER COOLER	TSP	TOTAL STATIC PRESSURE
EWH	ELECTRIC WATER HEATER	TYP	TYPICAL
EWT	ENTERING WATER TEMPERATURE	UNO	UNLESS NOTED OTHERWISE
F	FAHRENHEIT	VAV	VARIABLE AIR VOLUME
FCO	FLOOR CLEANOUT	VFD	VARIABLE FREQUENCY DRIVE
FD	FLOOR DRAIN	VRF	VARIABLE REFRIGERANT FLOW
FLA	FULL LOAD AMPS	WB	WET BULB
FFE	FINISHED FLOOR ELEVATION	WG	WATER GAGE
FPI	FINS PER INCH	WPD	WATER PRESSURE DROP
HP	HORSEPOWER		

DESIGN

MECHANICAL LEGEND

GRILLES, REGISTERS, DIFFUSERS, AND LOUVERS				EQUIPMENT			
EXISTING	DEMO	NEW	DESCRIPTION	EXISTING	DEMO	NEW	DESCRIPTION
		A100	GRILLE DESIGNATION AND CFM				MECHANICAL EQUIPMENT. REFER TO SCHEDULES.
			SURFACE MOUNT				IONIZATION UNIT
							SMOKE DETECTOR
							MANUAL PULL STATION
			LAY-IN SUPPLY CEILING DIFFUSER	CONTROLS			
			SUPPLY WALL DIFFUSER				THERMOSTAT
			LINEAR SLOT DIFFUSER				HUMIDISTAT
			RETURN/EXHAUST CEILING GRILLE				SENSOR
			RETURN/EXHAUST WALL GRILLE				STATIC PRESSURE SENSOR
			EXHAUST LOUVER				REMOTE TEMPERATURE SENSOR
			EXHAUST WALL CAP				WALL SWITCH
			GRAVITY RELIEF HOOD				CONTROL WIRING
			INTAKE LOUVER				
			INTAKE WALL CAP				
			GRAVITY INTAKE HOOD				
DUCTWORK							
EXISTING	DEMO	NEW	DESCRIPTION				
			RECTANGULAR DUCTWORK. REFER TO PLANS FOR SIZE.				
			ROUND DUCTWORK. REFER TO PLANS FOR SIZE.				
			ROUND DUCTWORK DROP/RISE.				
			DUCT DROP/RISE				
PIPING							
EXISTING	DEMO	NEW	DESCRIPTION				
			CHILLED WATER SUPPLY PIPING				
			CHILLED WATER RETURN PIPING				
			HOT WATER SUPPLY PIPING				
			HOT WATER RETURN PIPING				
			CONDENSER WATER SUPPLY PIPING				
			CONDENSER WATER RETURN PIPING				
DAMPERS							
EXISTING	DEMO	NEW	DESCRIPTION				
			BALANCING DAMPER				
			MOTORIZED DAMPER				
			FIRE DAMPER				
			SMOKE DAMPER				
			FIRE & SMOKE DAMPER				


- NOTES: 1. EXISTING ITEMS ON DEMO PLANS ARE "EXISTING TO REMAIN" UNLESS NOTED "EXISTING TO BE RELOCATED."
 2. ITEMS ON NEW CONSTRUCTION PLANS ARE NEW UNLESS NOTED "RELOCATED FROM PREVIOUS LOCATION."
 3. REFER TO SCHEDULES FOR GRILLE, REGISTER, DIFFUSER, AND LOUVER SIZES.
 4. REFER TO DRAWINGS FOR DIRECTION OF AIRFLOW FOR DIFFUSERS. IF DIRECTIONAL ARROWS ARE NOT INCLUDED, AIRFLOW IS IN FOUR DIRECTIONS. (4-WAY GRILLES)
 5. WALL MOUNTED CONTROL DEVICES SHALL BE MOUNTED AT 48" A.F.F.
 6. NOT ALL ITEMS SHOWN ON THIS LIST MAY BE APPLICABLE TO THIS PROJECT.

DELIVER

MECHANICAL GENERAL NOTES

- CONTRACTOR SHALL VISIT THE SITE AND DETERMINE THE EXTENT OF DEMOLITION WORK AND NEW WORK NEEDED FOR THIS PROJECT, PRIOR TO SUBMITTING BID.
- CONTRACTOR SHALL BECOME FAMILIAR WITH THE PROJECT SCOPE, CONSTRAINTS, UTILITY CONNECTIONS, AND BUILDING SERVICES, PRIOR TO SUBMITTING BID.
- CONTRACTOR SHALL GIVE FIRST RIGHT TO REFUSAL OF SALVAGE TO THE OWNER. IF THE OWNER ELECTS TO NOT KEEP SALVAGE, CONTRACTOR SHALL REMOVE SALVAGE BY LAWFUL MEANS.
- DRAWINGS ARE SCHEMATIC AND DIAGRAMMATIC IN NATURE. DRAWINGS SHALL NOT BE SCALED. COORDINATE ROUTING OF SERVICES WITH SITE CONDITIONS AND WITH WORK OF OTHER TRADES.
- FIELD VERIFY DIMENSIONS PRIOR TO ORDERING, FABRICATING, AND ERECTION OF MATERIAL AND/OR EQUIPMENT. NOTIFY THE ENGINEER OF DISCREPANCIES IN A TIMELY MANNER.
- VERIFY CLEARANCE REQUIREMENTS AND ROUTING OF DUCTWORK AND PIPING PRIOR TO FABRICATION. AS MINOR MODIFICATIONS SUCH AS DUCT AND/OR PIPING RISES AND DROP MAY BE REQUIRED DUE TO FIELD CONDITIONS, MAKE MINOR MODIFICATIONS TO THE BUILDING, PIPING, SPRINKLER, DUCTWORK, ELECTRICAL, ETC. AS SHOWN ON THE DRAWINGS OR REQUIRED TO COMPLETE THE INSTALLATION OF A COMPLETED WORKABLE SYSTEM.
- MAINTAIN WEATHER-TIGHT BARRIERS TO PREVENT DAMAGE FROM THE ELEMENTS DURING DEMOLITION AND NEW CONSTRUCTION PERIOD.
- SEAL PENETRATIONS THROUGH THE BUILDING ENVELOPE.
- PENETRATIONS THROUGH RATED WALLS, FLOORS, PARTITIONS AND ASSEMBLIES SHALL BE INSTALLED AND FIRESAFED TO MEET UL FIRE RESISTANCE LISTING AND NFPA REQUIREMENTS FOR THE PENETRATION.
- COORDINATE DEVICES REQUIRING ACCESS PANELS WITH THE ARCHITECT AND OTHER TRADES.
- MAINTAIN MINIMUM CLEARANCE 10'-0" BETWEEN OUTSIDE INTAKES AND EXHAUST OUTLETS AND PLUMBING VENTS.
- COORDINATE FINAL LOCATIONS AND ELEVATIONS WITH THE ARCHITECT PRIOR TO INSTALLATION.
- COORDINATE FINAL FINISH COLORS OF MATERIALS, DEVICES, DIFFUSER, GRILLES, LOUVERS, AND/OR EQUIPMENT WITH THE ARCHITECT PRIOR TO ORDERING, FABRICATION AND INSTALLATION.
- SCHEDULE UTILITY SERVICES SHUTDOWNS WITH OWNER AND ARCHITECT. MINIMIZE DISRUPTIONS AND DOWNTIME TO THE OWNER.
- INSTALL DEVICES AND EQUIPMENT TO MEET ADA REQUIREMENTS.
- ROUTE DUCT AND PIPING CONCEALED IN INTERSTITIAL SPACE UNLESS NOTED OTHERWISE.
- DOCUMENT LOCATIONS OF DEVICES, DUCT, PIPING, AND EQUIPMENT ON "AS-BUILT" RECORD DRAWINGS AS PER THE SPECIFICATIONS.
- PAY FOR SERVICE, DEPOSITS, INSPECTION, AND CONNECTION FEES REQUIRED FOR A COMPLETE INSTALLATION. COORDINATE WITH THE UTILITY SERVICE PROVIDER FOR THE REQUIREMENTS NEEDED FOR THIS PROJECT.
- HVAC SYSTEMS SHALL BE CONSTRUCTED IN ACCORDANCE WITH NFPA 90A AND NFPA 101.
- WORK SHOWN IN THE DRAWINGS SHALL COMPLY WITH APPLICABLE NATIONAL, STATE, AND LOCAL ORDINANCES AND CODES.

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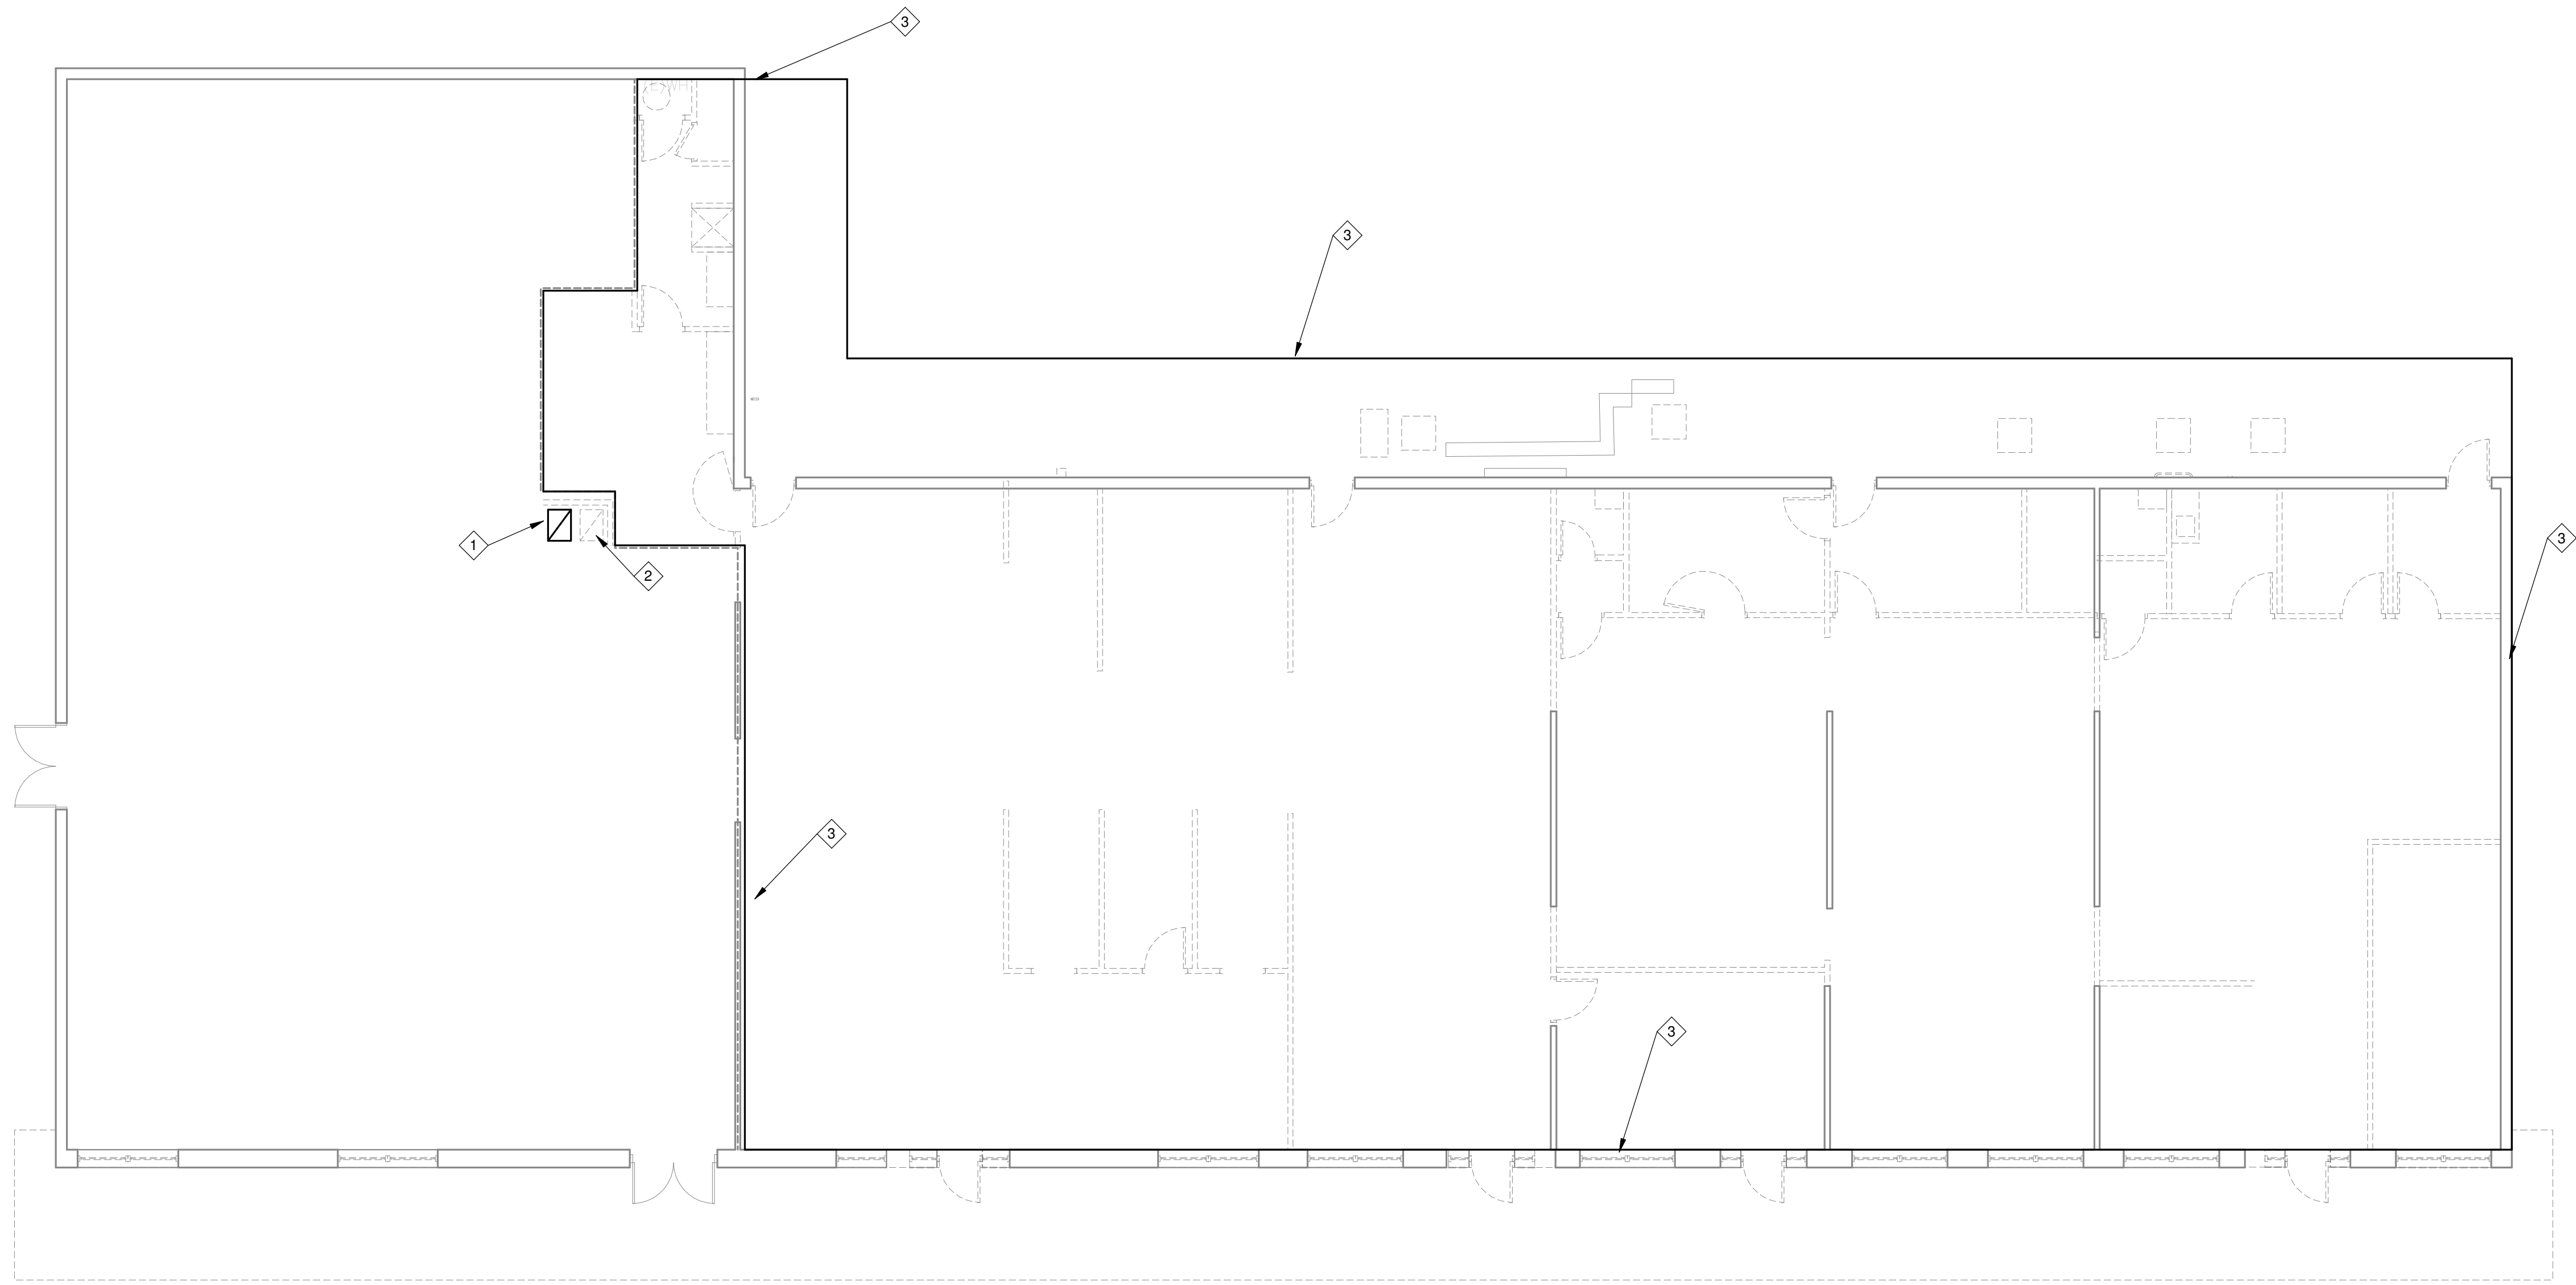
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 DATE: _____
 DESIGN DEVELOPMENT
 DATE: _____
 BIDS & CONSTRUCTION
 DATE: 02/28/2022
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 REVISION: _____
 DATE: _____

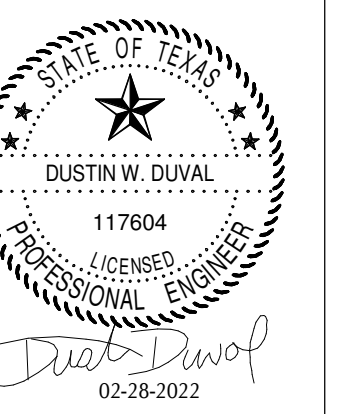DRAWINGS SHEET TITLE
MECHANICAL LEGEND & GENERAL NOTES

SHEET NUMBER
M000
 21061
 PROJECT NUMBER

1304 BERTRAND DRIVE SUITE F7
 LAFAYETTE, LOUISIANA 70506
 (337) 234-7474 * FAX (337) 234-7774
 Mechanical Contact: Dustin Duval, P.E.
 dustin@meconsulting.com
 Electrical Contact: David Carroll, P.E.
 david@meconsulting.com
 PROJECT No.: 21167.00

- MECHANICAL KEYNOTES**
- 1 AIR HANDLING UNIT TO REMAIN.
 - 2 REMOVE AIR HANDLING UNIT, ASSOCIATED DUCT WORK, ACCESSORIES, AND OUTDOOR UNIT.
 - 3 REMOVE ALL AIR HANDLING UNITS, ASSOCIATED OUTDOOR UNIT, DUCT WORK, ACCESSORIES, EXHAUST FANS, ETC. IN BOXED AREA. PATCH AND REPAIR ANY ROOF OR WALL PENETRATIONS TO MATCH ADJACENT SURFACES AS REQUIRED.



1 Mechanical Plan - Demolition
 1/8" = 1'-0" Refer to Architectural Drawings for All Dimensions

1304 BERTRAND DRIVE SUITE F7
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 PROJECT No.: 21167.00

222 Durbin Dr
 Silsbee, TX 77666
SPINDLETOP SILSBEE
 Spindletop MHR

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DRAWINGS SHEET TITLE
MECHANICAL DEMOLITION PLAN


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 PROJECT NUMBER

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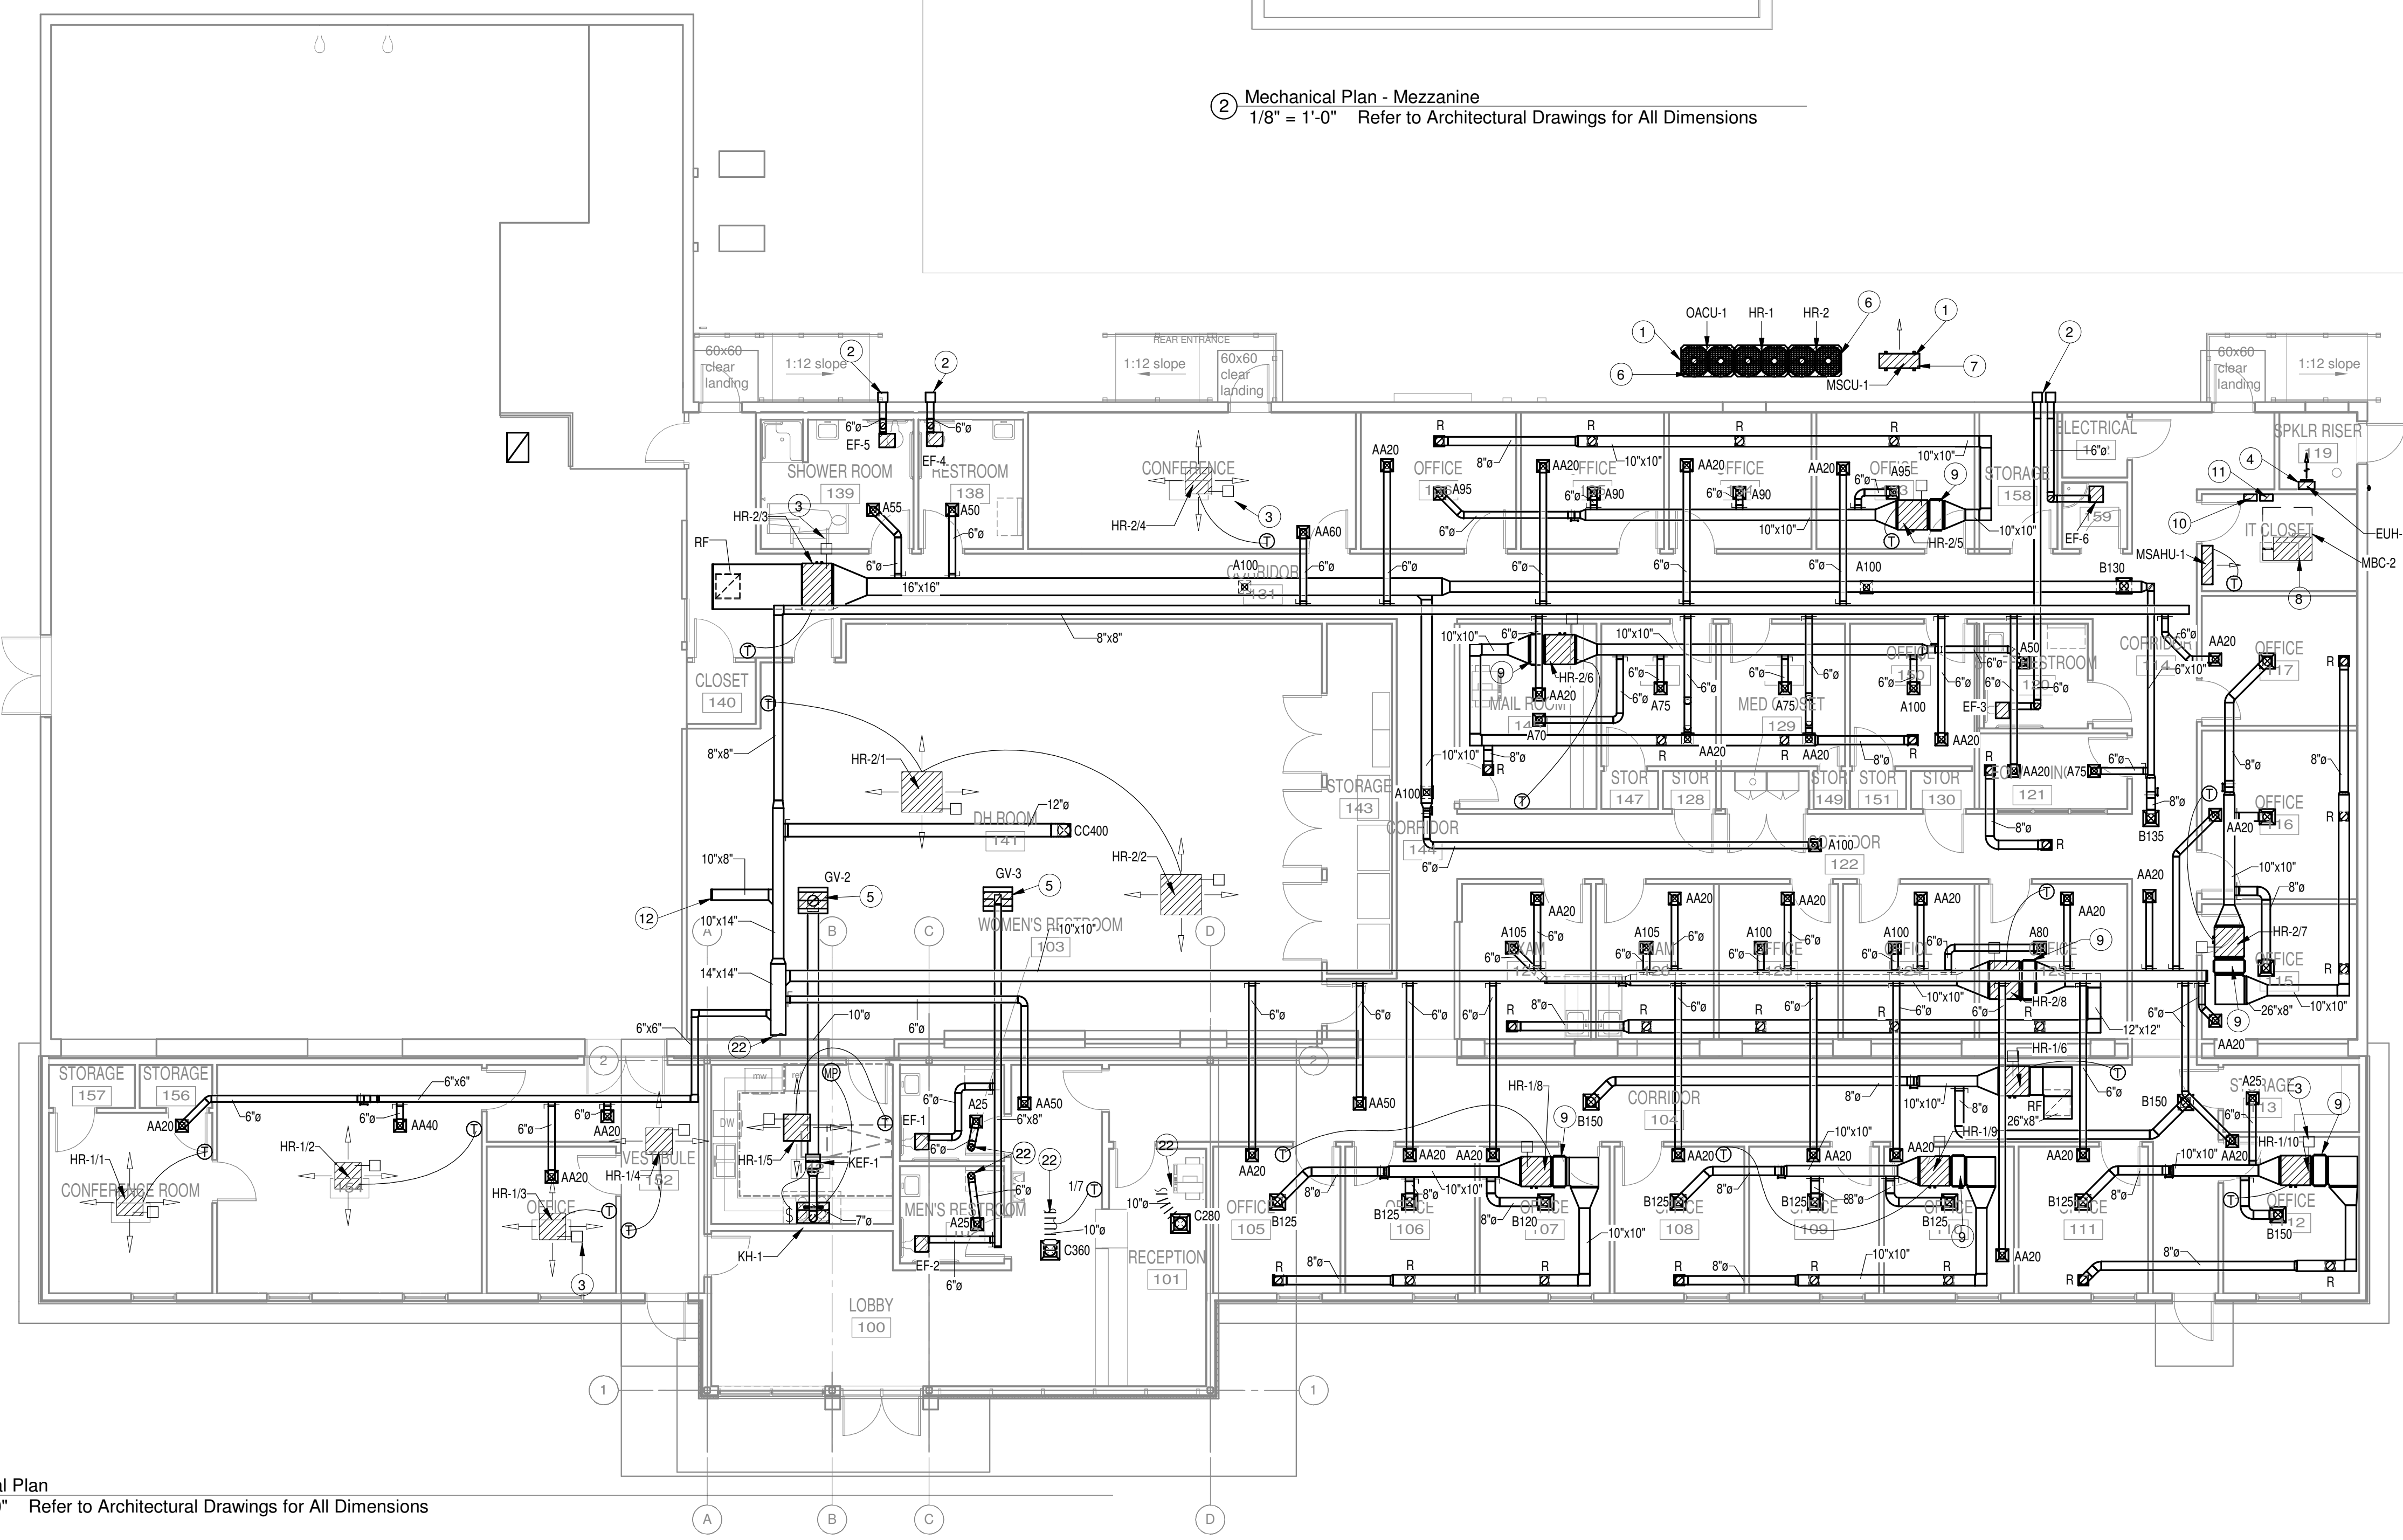
DRAWINGS SHEET TITLE
MECHANICAL PLAN

SHEET NUMBER
M200
 21061
 PROJECT NUMBER

- MECHANICAL NOTES**
- ANCHOR UNITS TO 4" THICK REINFORCED CONCRETE HOUSE KEEPING PAD.
 - TERMINATE AT EXHAUST WALL CAP ABOVE CEILING HEIGHT IN THIS VICINITY.
 - PROVIDE AN AIR IONIZATION DEVICE IN UNIT AND MOUNT AS PER MANUFACTURER'S RECOMMENDATIONS (TYPICAL).
 - MOUNT UNIT HEATER WITH BOTTOM AT 1'-6" AFF.
 - EXTEND DUCT TO RELIEF HOOD ON ROOF. MAINTAIN 10'-0" DISTANCE FROM HIGH ROOF OF ADDITION.
 - PROVIDE A WALL MOUNTED OUTLET FOR REFRIGERANT PIPING THROUGH THE EXTERIOR WALL. REFER TO DETAIL FOR ADDITIONAL INFORMATION. EXTEND REFRIGERANT PIPING TO RESPECTIVE BRANCH CONTROLLER.
 - PROVIDE A WALL MOUNTED OUTLET FOR REFRIGERANT PIPING THROUGH THE EXTERIOR WALL. REFER TO DETAIL FOR ADDITIONAL INFORMATION. EXTEND REFRIGERANT PIPING TO RESPECTIVE AIR HANDLING UNIT.
 - EXTEND REFRIGERANT PIPING FROM BRANCH CONTROLLER TO RESPECTIVE AIR HANDLING UNIT.
 - MANUFACTURER PROVIDED UNIT MOUNTED FILTER BOX (FEM SERIES OR EQUAL). INSTALL WHITE PLASTIC LABEL WITH 3/4" BLACK LETTERS STATING "FILTER ACCESS POINT" ON T-BAR AT TILE THAT IS REMOVED TO ACCESS AND REPLACE FILTERS.
 - VRF TOUCHSCREEN CENTRAL CONTROLLER SHALL BE MITSUBISHI MODEL AE-200A AND MOUNTED 48" AFF.
 - INTEGRATED CLOUD BASED BUILDING CONTROL SYSTEM MITSUBISHI MODEL BCP-90 TO BE INSTALLED AND SET UP BY MANUFACTURER FOR BUILDING CONNECT CONTROLS SYSTEM.
 - CAP AND SEAL DUCT AT THIS VICINITY FOR PHASE II TIE IN (365 CFM AVAILABLE).
 - EXTEND DUCT TO INTAKE HOOD ON ROOF.
 - DUCT MOUNTED FILTER RACK CAPABLE OF HOLDING 2 - 24"X24" PLEATED FILTERS. REFER TO OUTSIDE AIR HANDLING UNIT DETAIL FOR ADDITIONAL INFORMATION.
 - SUSPEND BRANCH CONTROLLER ABOVE AIR HANDLING UNIT FROM STRUCTURE ABOVE. REFER TO DETAIL FOR ADDITIONAL INFORMATION. EXTEND REFRIGERANT PIPING FROM BRANCH CONTROLLER TO RESPECTIVE AIR HANDLING UNIT.
 - VRF OUTSIDE AIR HANDLING UNIT ON STAND. REFER TO DETAIL FOR ADDITIONAL INFORMATION.
 - O.A. MOTORIZED DAMPER SHALL BE INTERLOCKED WITH RESPECTIVE UNIT TO OPEN WHEN THE A/C UNITS COMPRESSOR OR HEATING STRIP IS ENERGIZED(ON), AND SHALL CLOSE WHEN THE UNITS COMPRESSOR AND HEATING STRIP IS DE-ENERGIZED(OFF). PROVIDE ALL NECESSARY RELAYS, SWITCHES, TRANSFORMERS, ETC. AS REQUIRED.
 - GRILLE SHALL HAVE A FLANGELESS, CONTINUOUS LINEAR SLOT APPEARANCE. GRILLE SHALL BE TAPED AND FLOATED TO CONCEAL FLANGES (TYPICAL).
 - SUSPEND UNIT FROM STRUCTURE ABOVE. BOTTOM OF UNIT SHALL BE AT 6'-0" ABOVE MEZZANINE FINISHED FLOOR.
 - MOUNT GRILLE WITH CENTER LINE AT 6'-0" ABOVE MEZZANINE FINISHED FLOOR (TYPICAL).
 - REFER TO VIEW 1 ON THIS SHEET FOR CONTINUATION
 - REFER TO VIEW 2 ON THIS SHEET FOR CONTINUATION

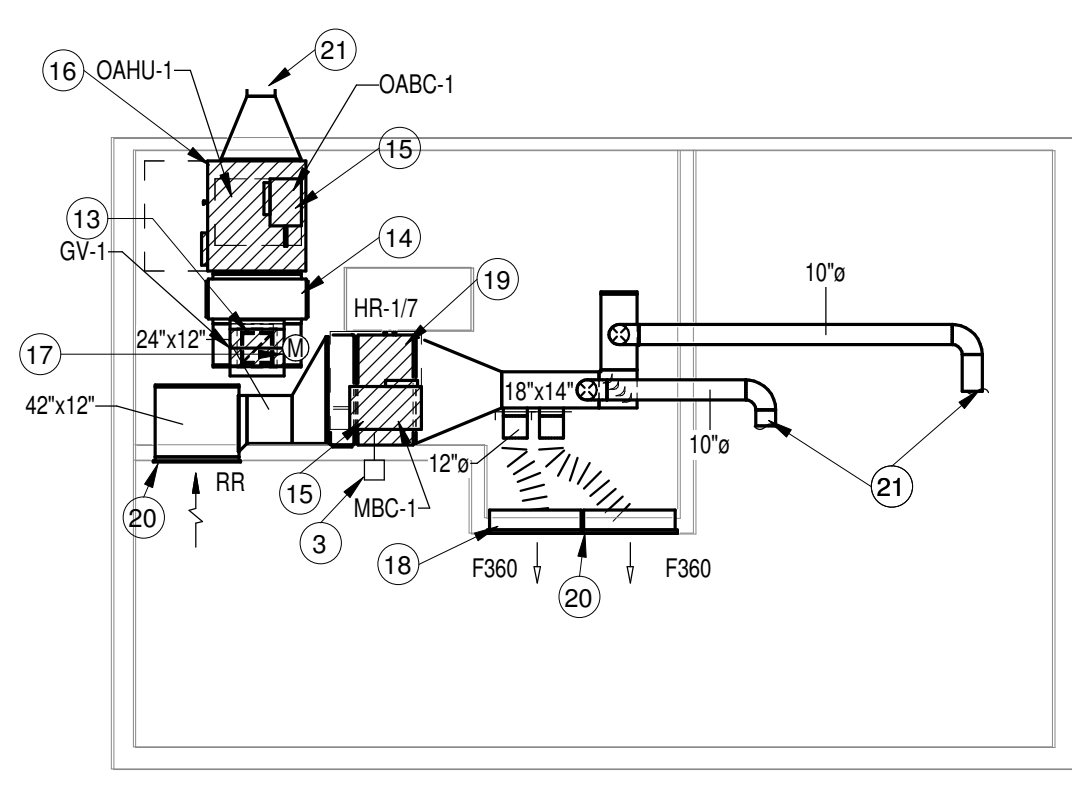


2 Mechanical Plan - Mezzanine
 1/8" = 1'-0" Refer to Architectural Drawings for All Dimensions




1 Mechanical Plan
 1/8" = 1'-0" Refer to Architectural Drawings for All Dimensions


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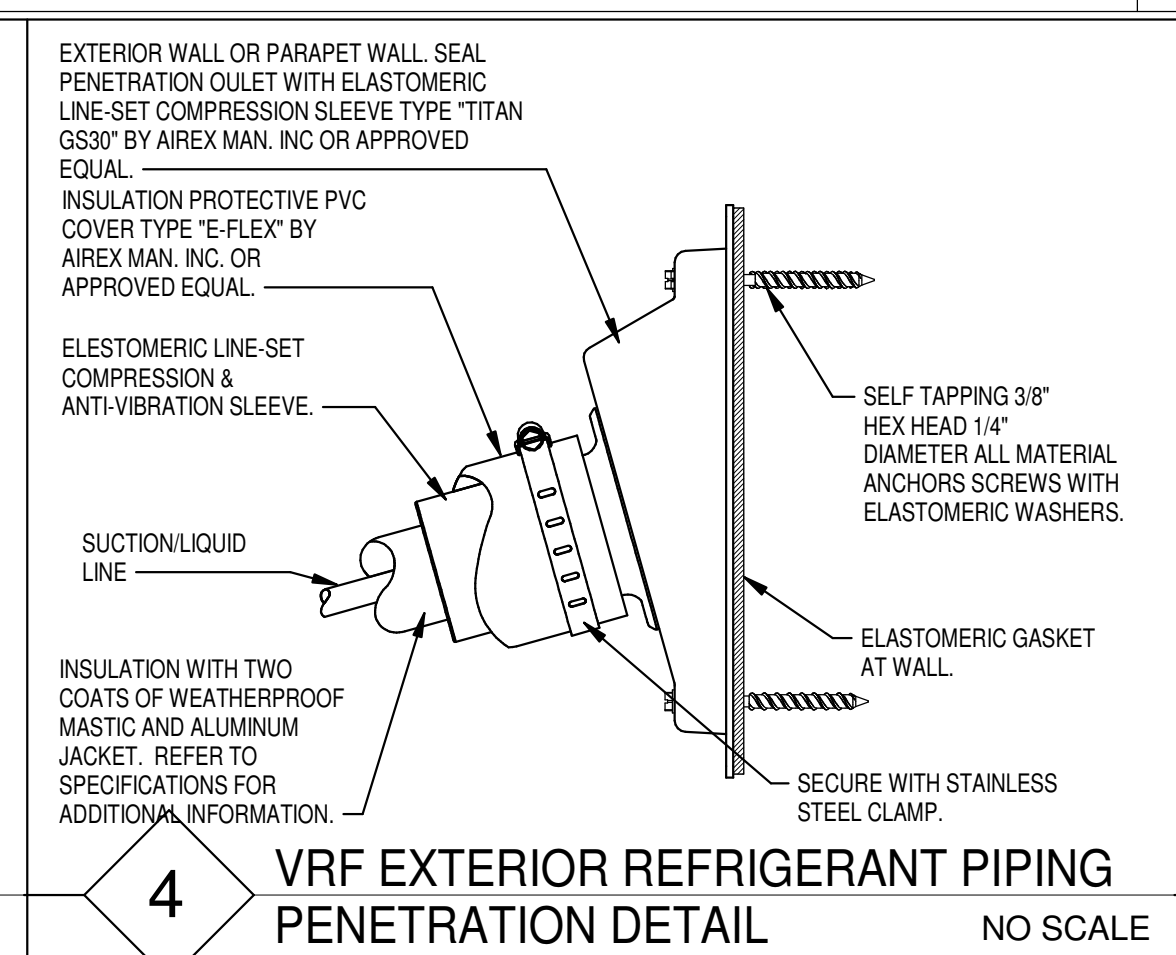
1 VRF CONDENSING UNIT DETAIL
NO SCALE

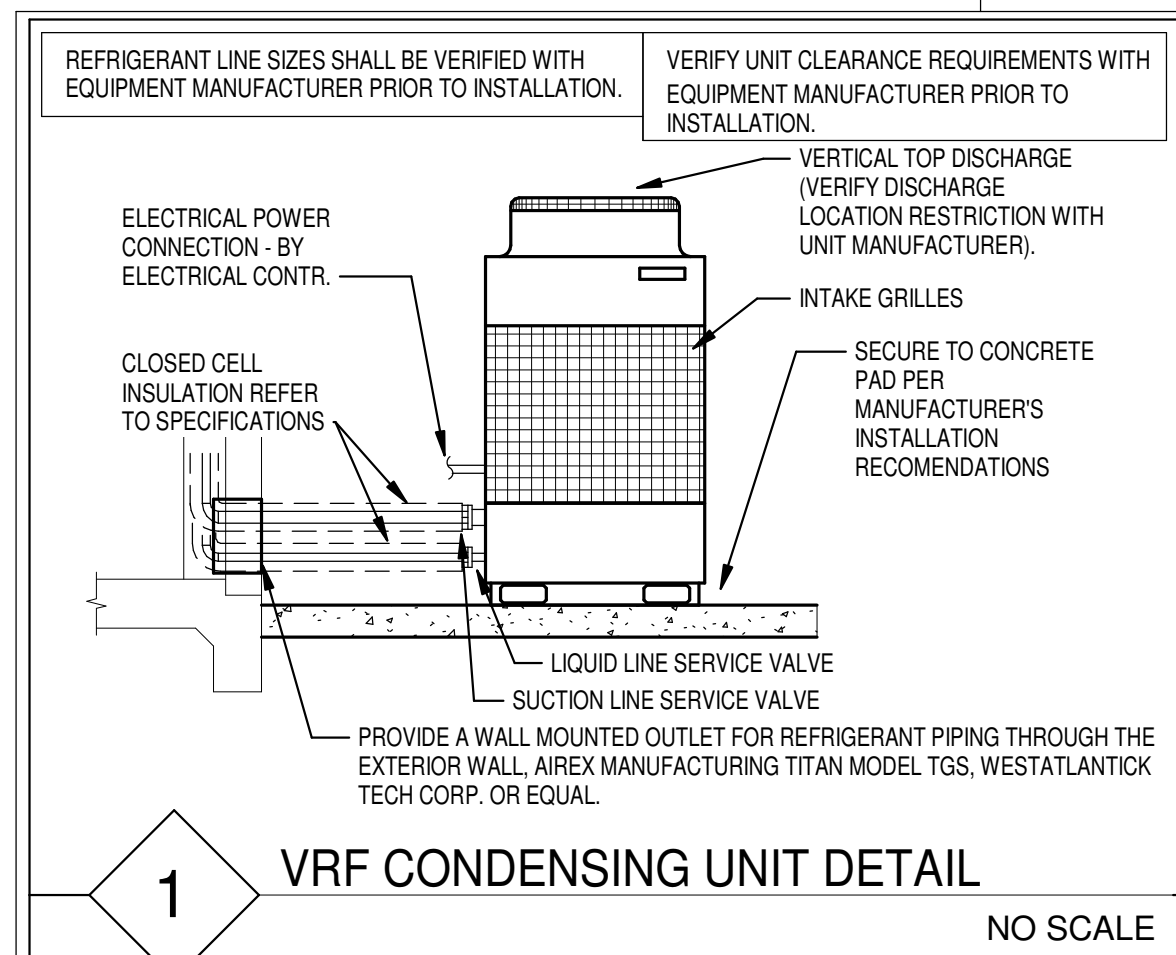


2 CONDENSING UNIT DETAIL (MINI-SPLIT)
NO SCALE

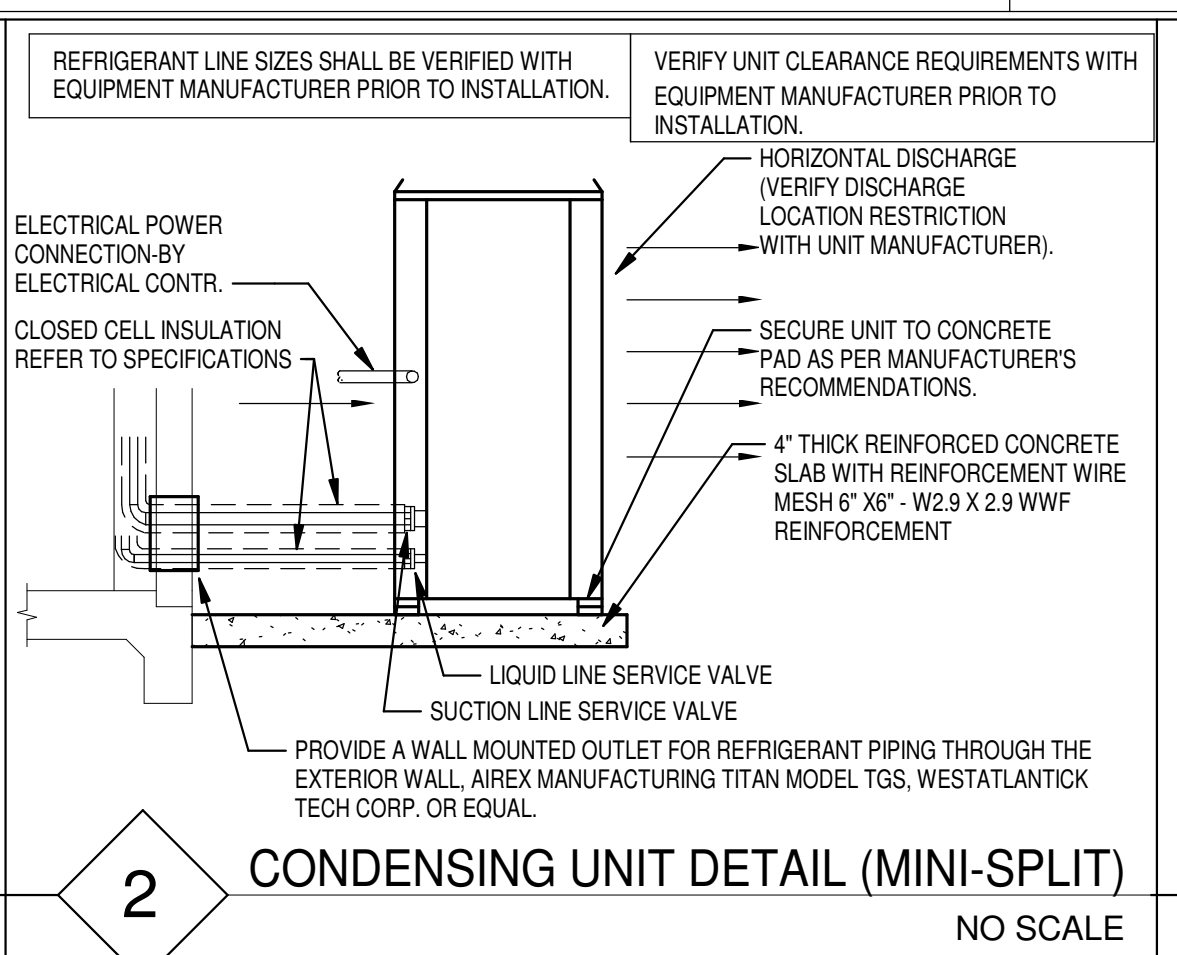


3 REFRIGERANT PIPE DETAIL AT CONCRETE PAD
NO SCALE

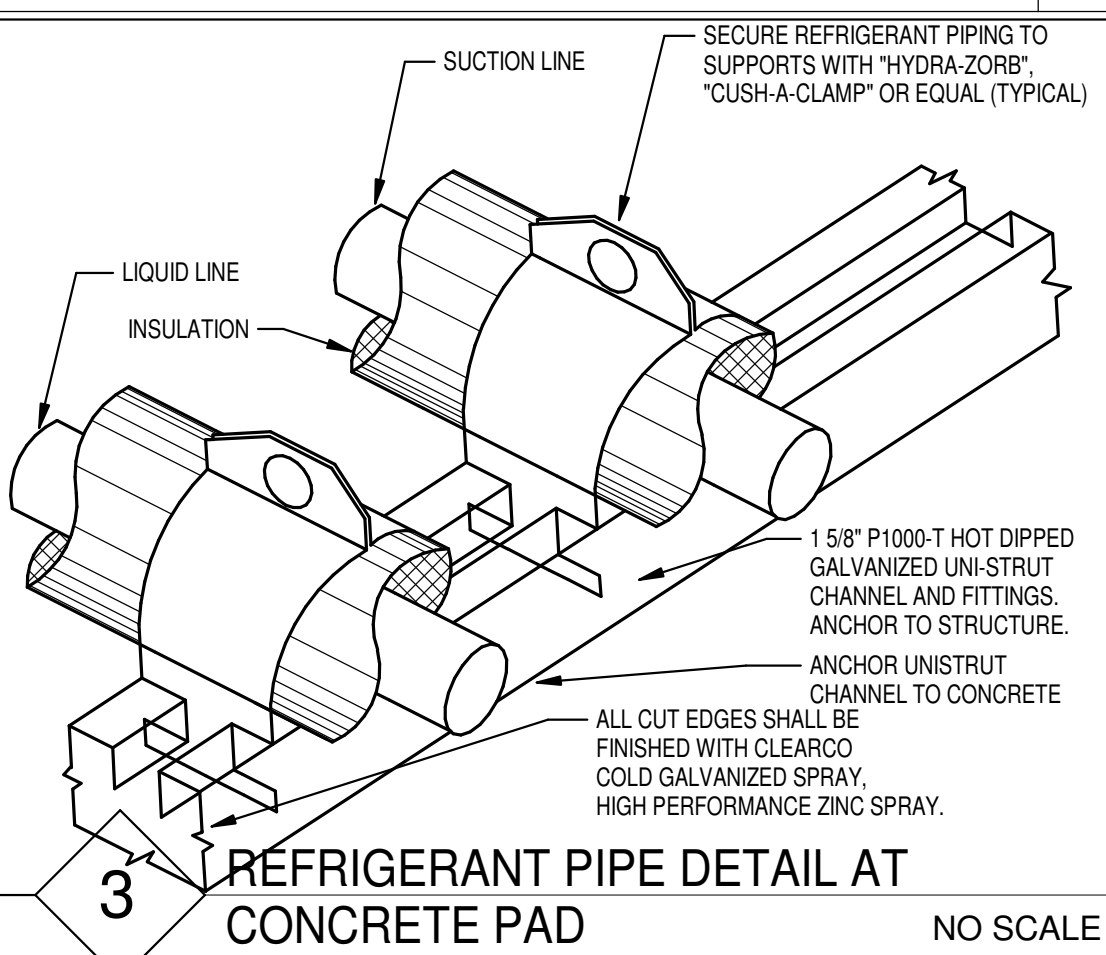


4 VRF EXTERIOR REFRIGERANT PIPING PENETRATION DETAIL
NO SCALE

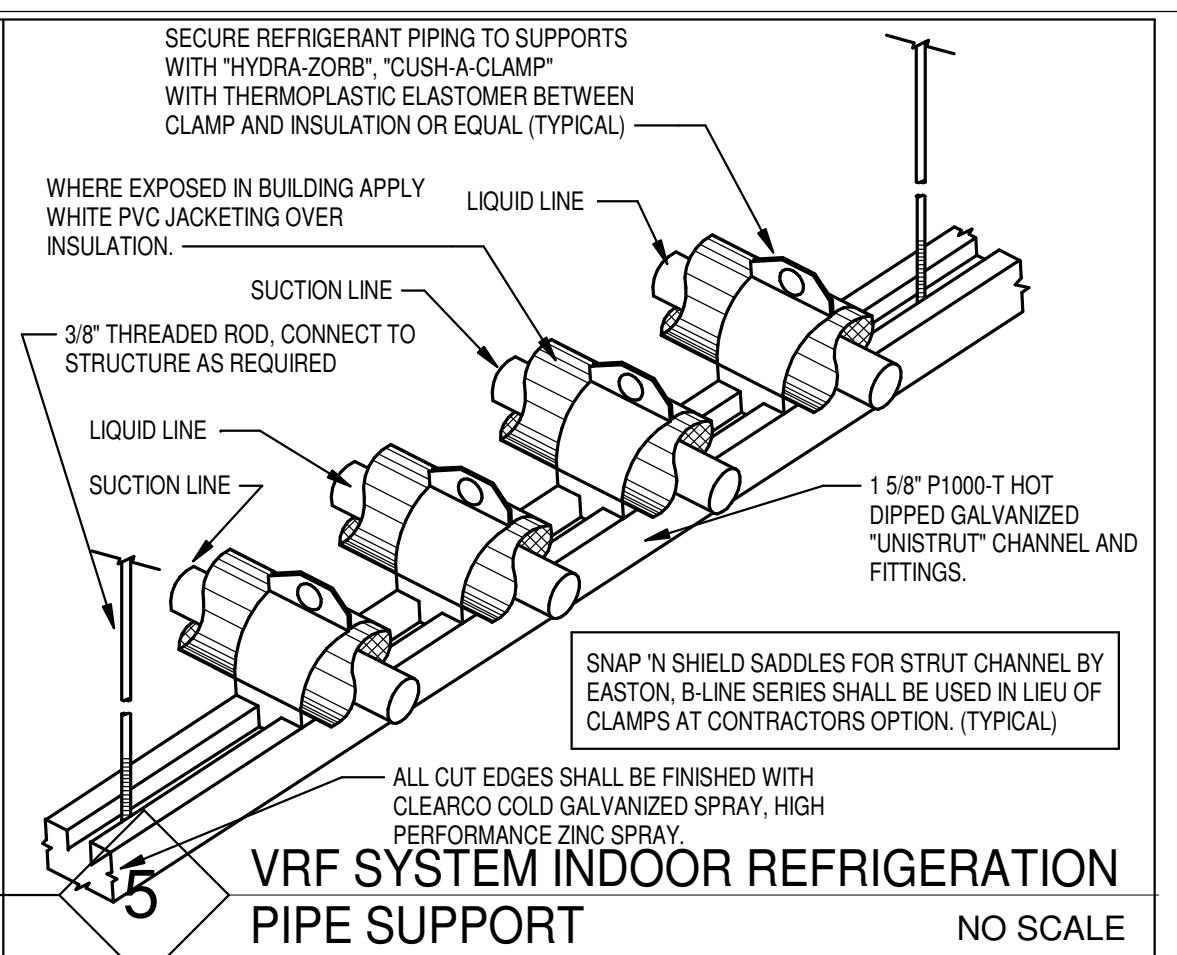


5 VRF SYSTEM INDOOR REFRIGERATION PIPE SUPPORT
NO SCALE

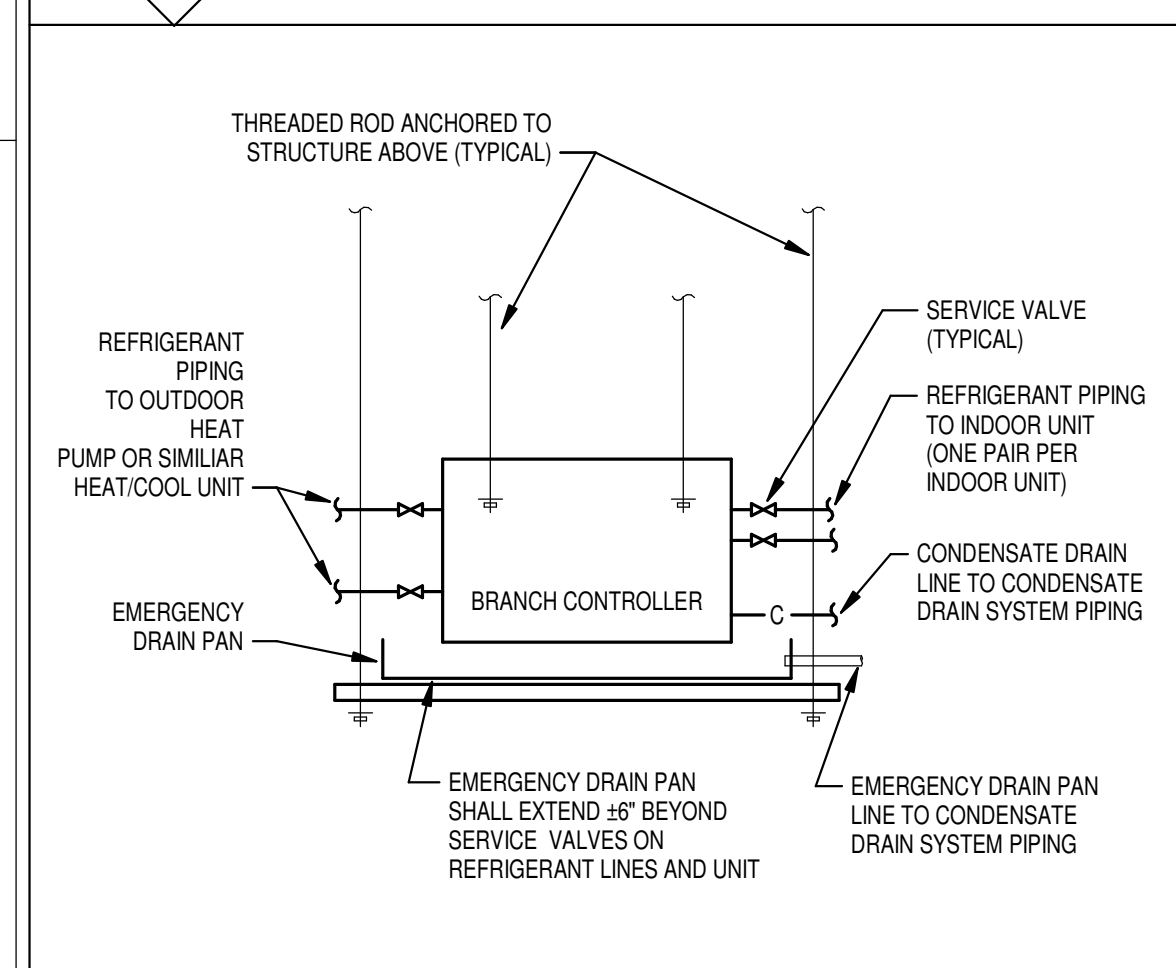


6 VRF - BRANCH CONTROLLER DETAIL
NO SCALE

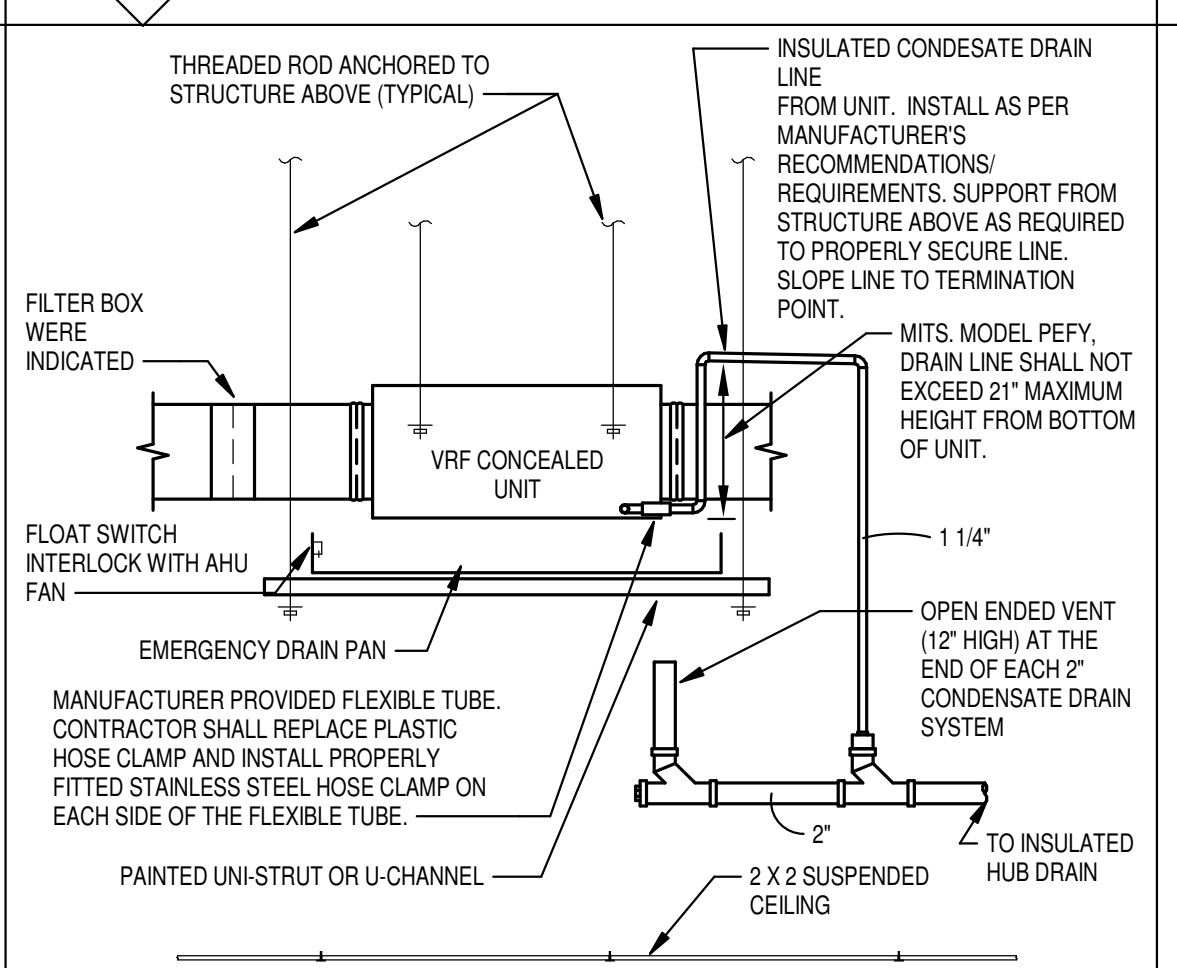


7 VRF - DUCTED CONCEALED UNIT
NO SCALE

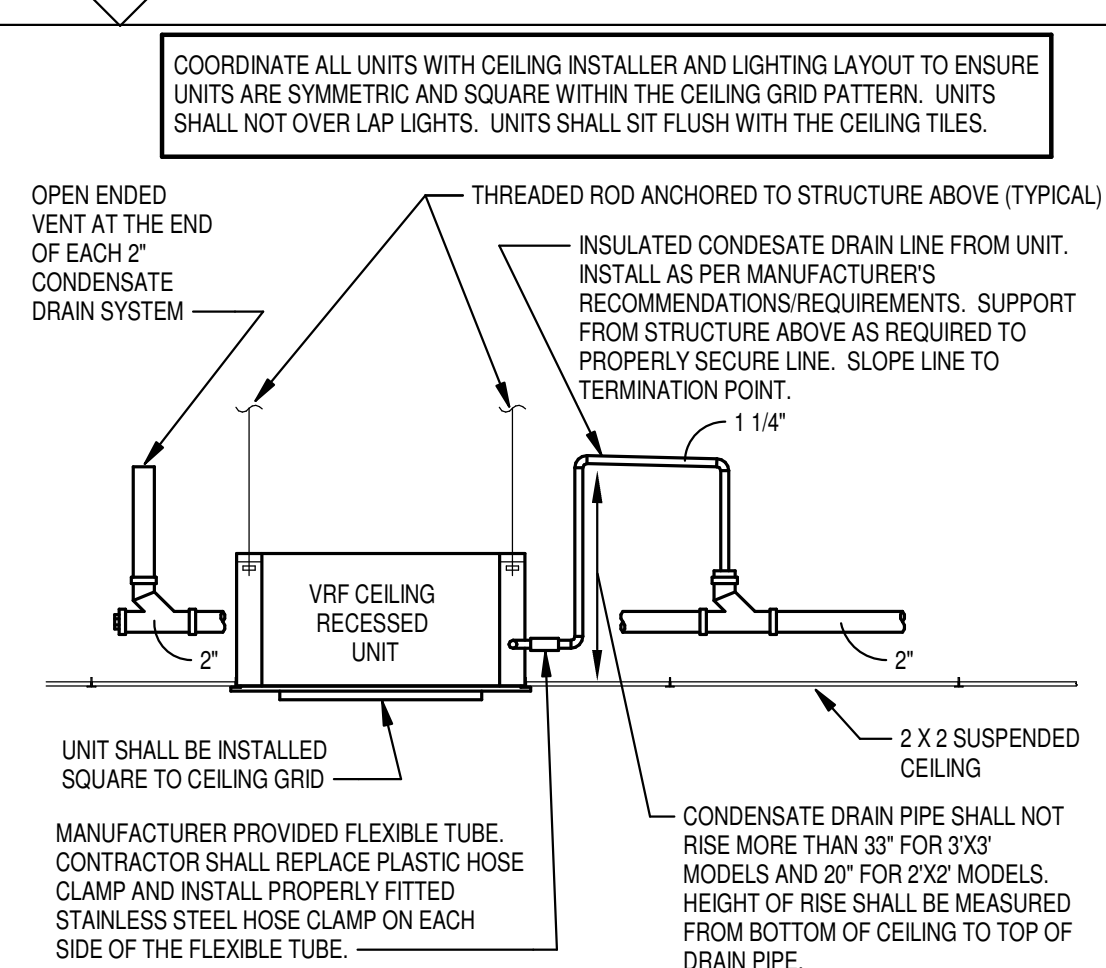


8 VRF - CEILING RECESSED UNIT
NO SCALE

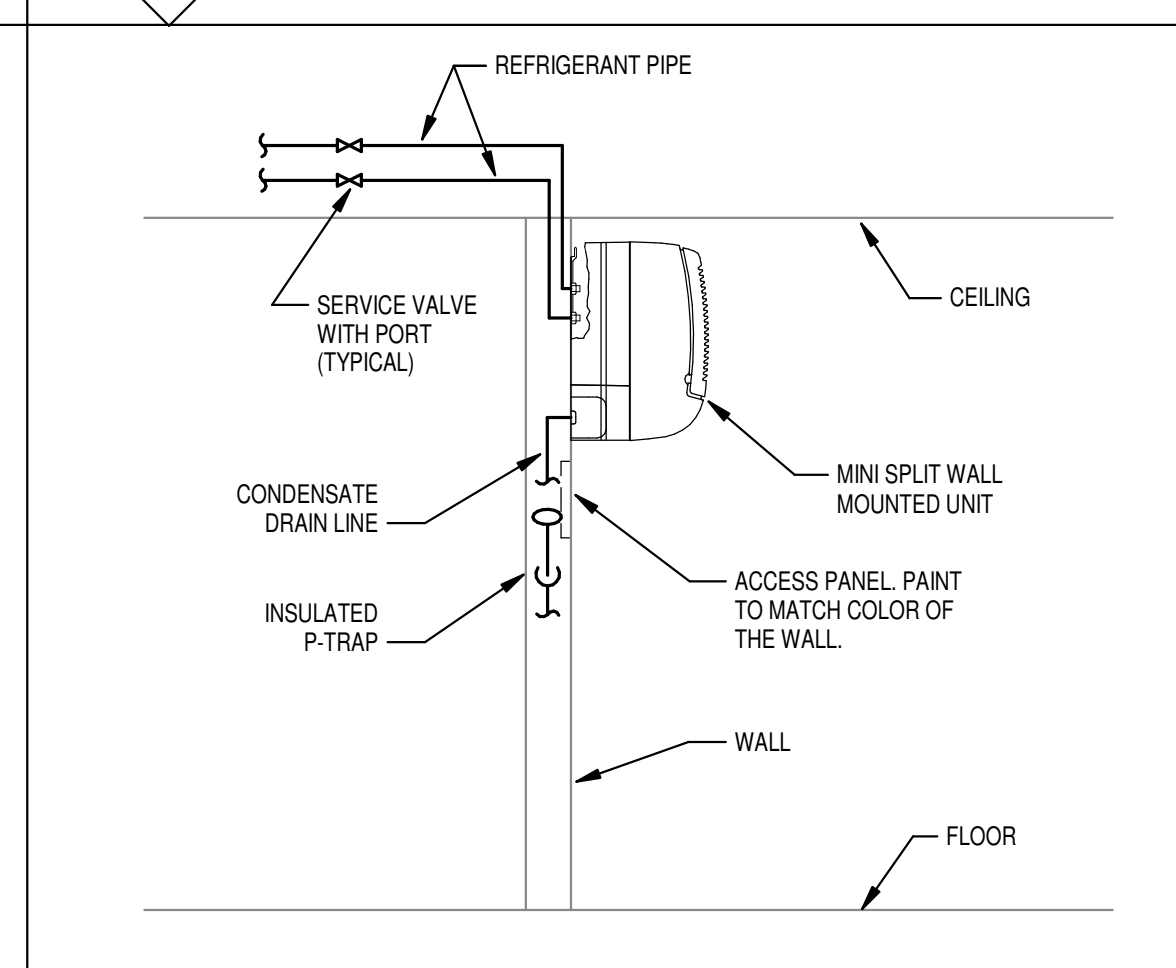


9 MSAHU - 1 - WALL MOUNTED UNIT DETAIL
NO SCALE

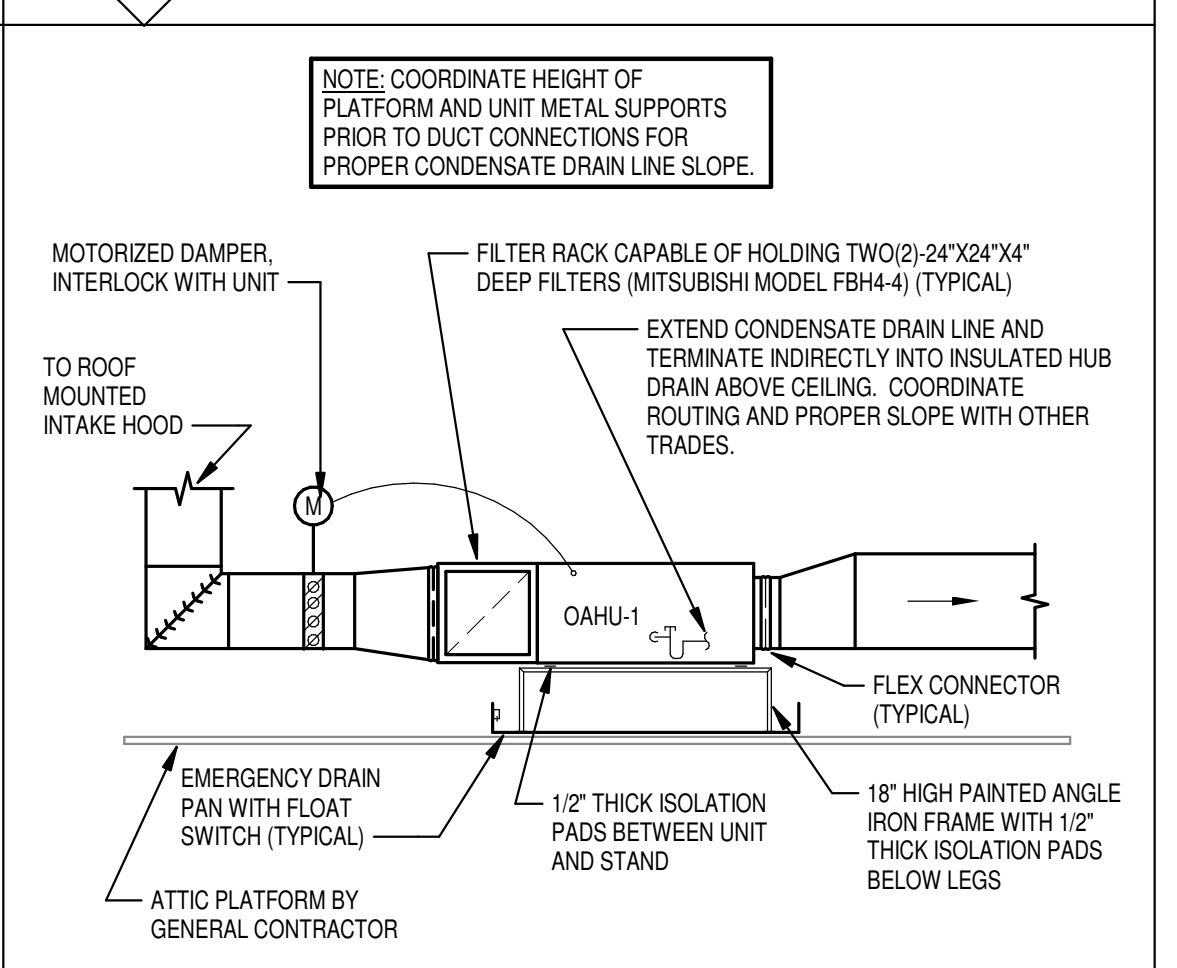


10 DEDICATED OAU (MITSUBISHI)
NO SCALE

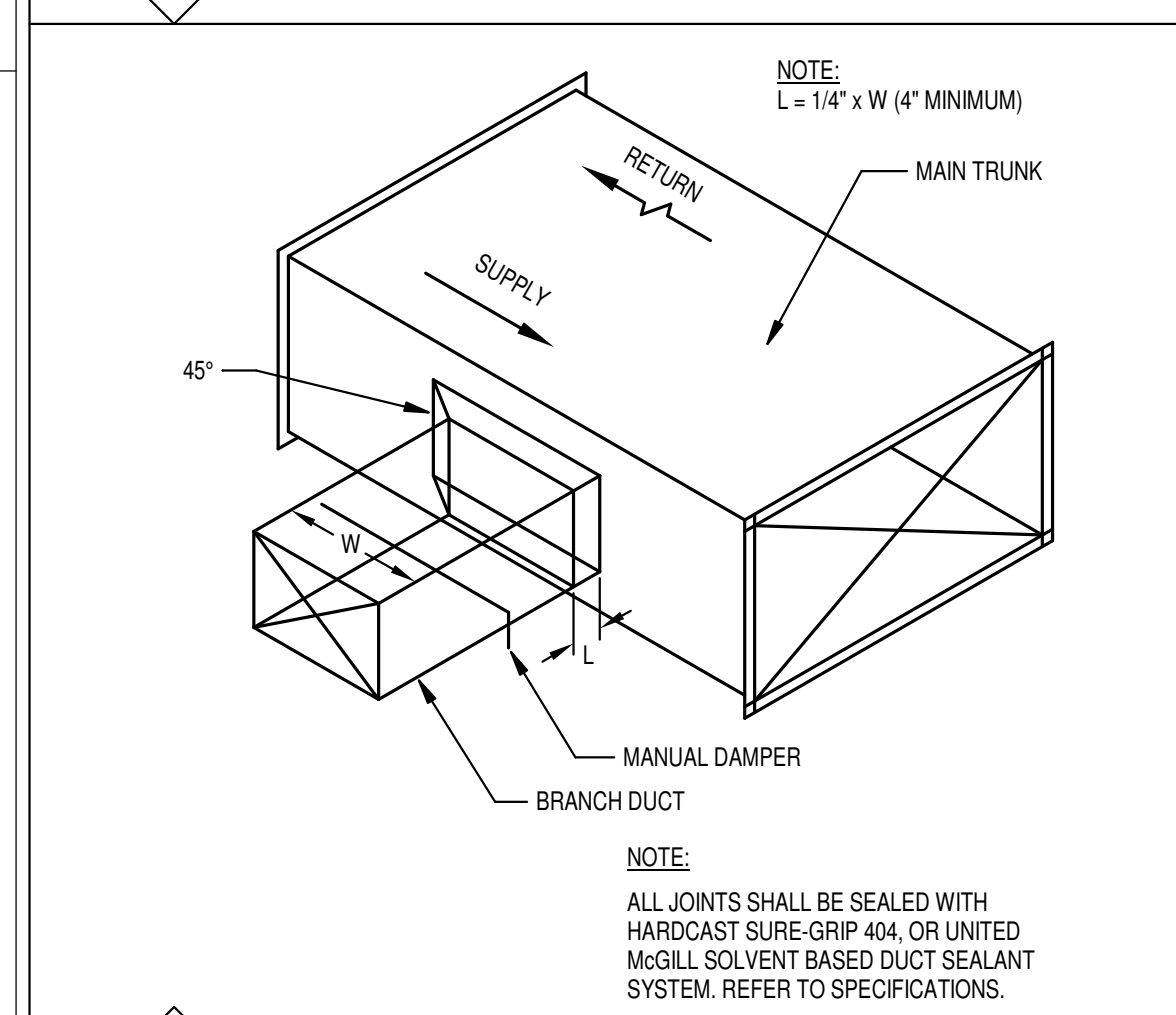


11 BRANCH DUCT (SUPPLY OR RETURN) DETAIL
NO SCALE

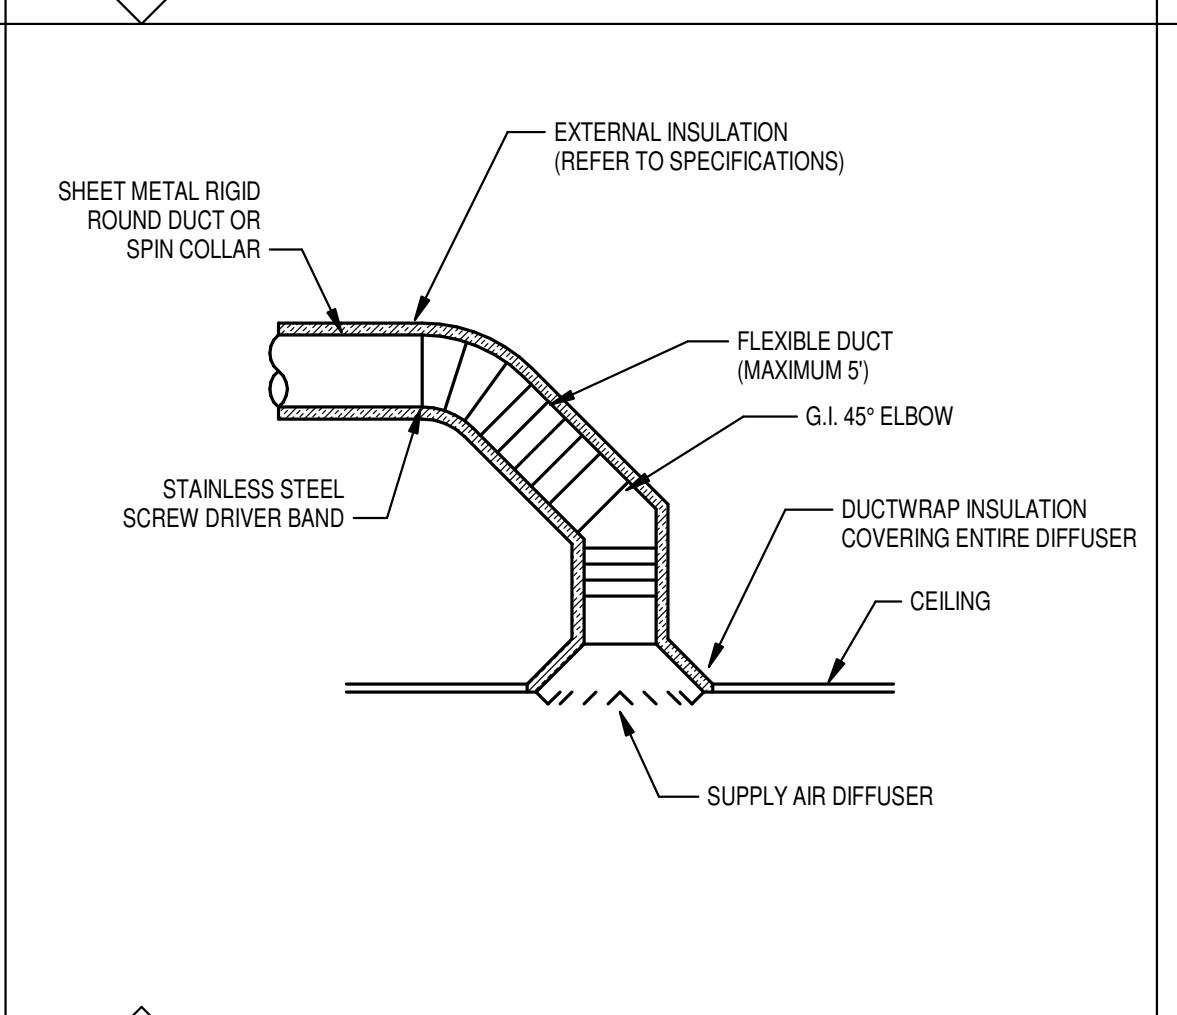


12 CEILING DIFFUSER DETAIL
NO SCALE

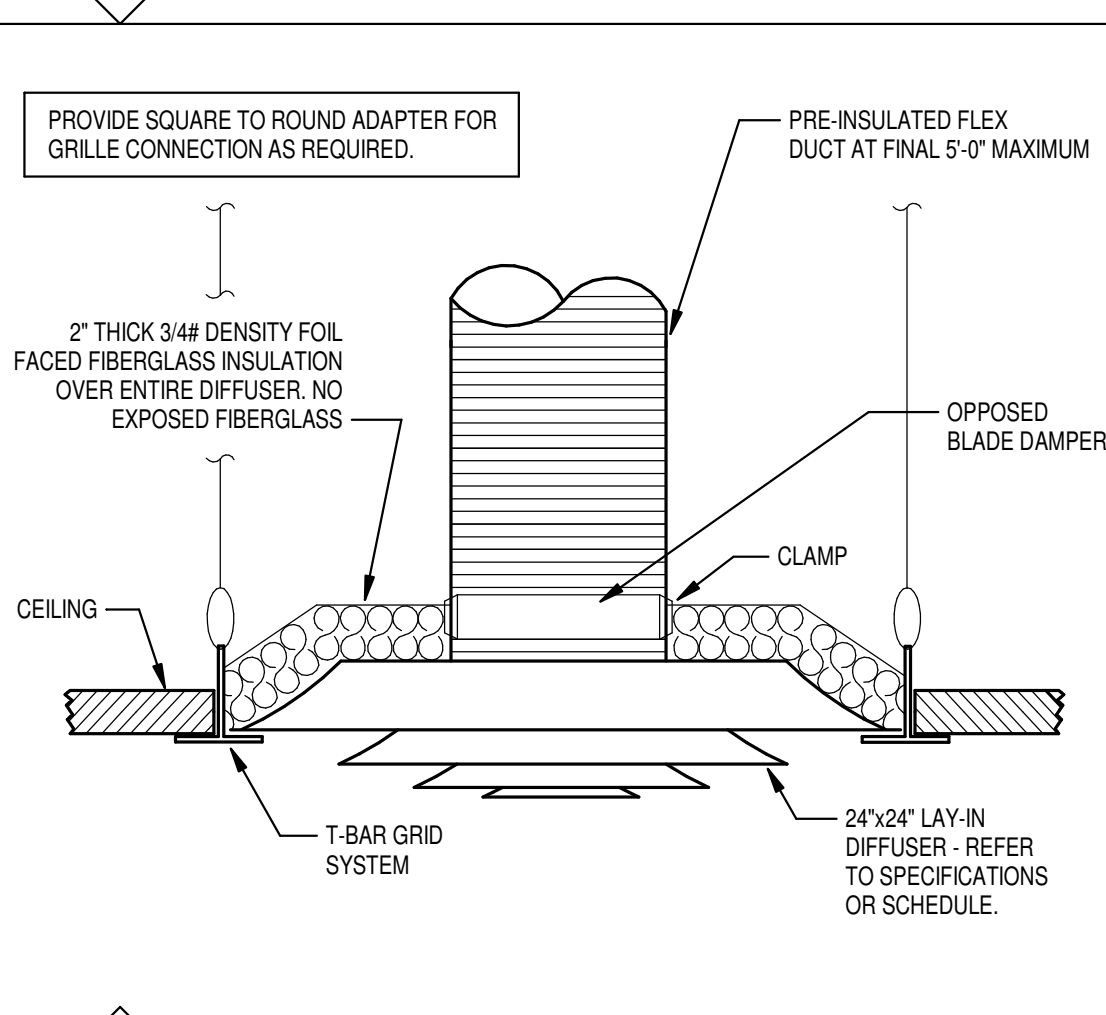


13 LAY-IN DIFFUSER DETAIL
NO SCALE

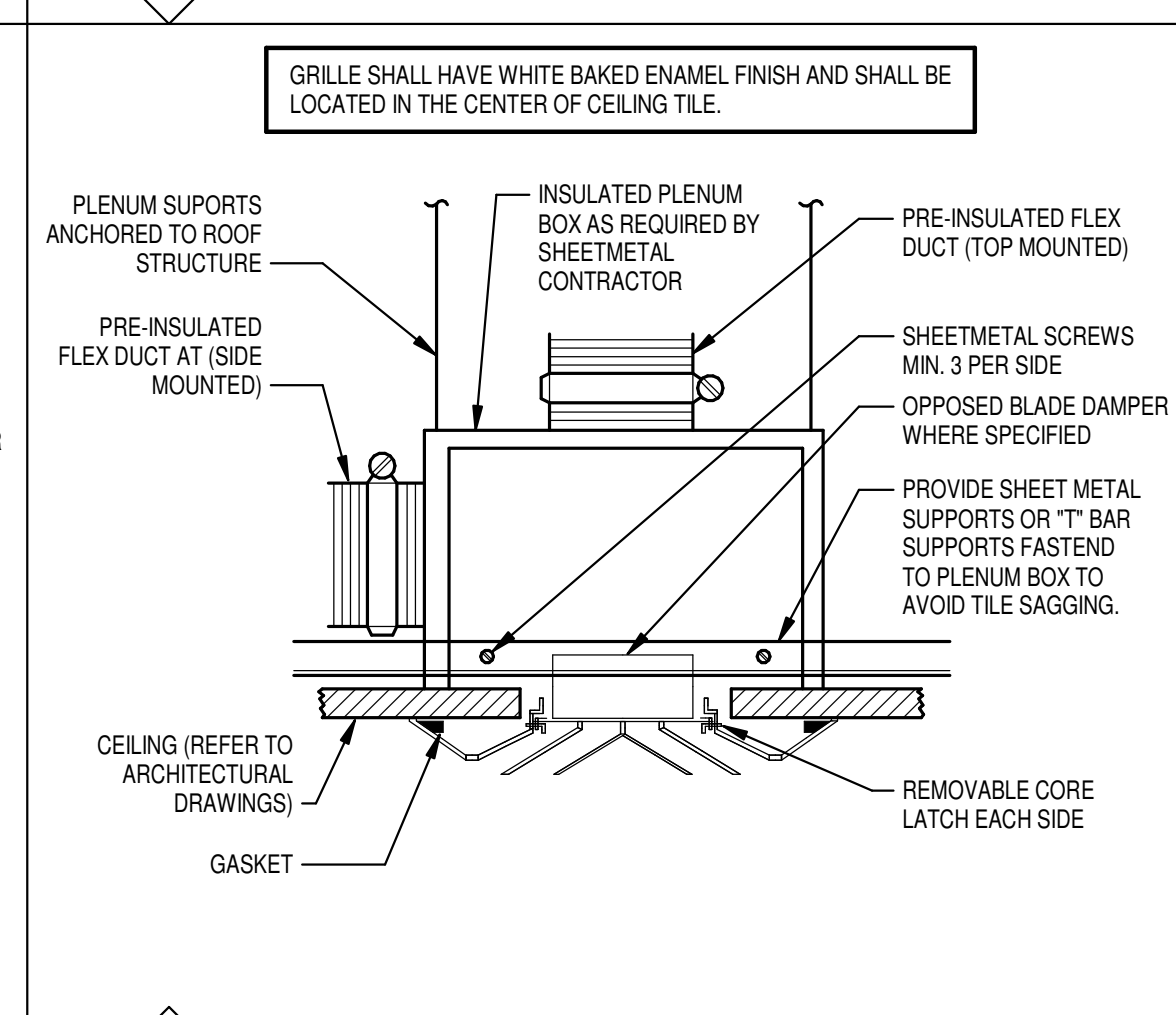


14 SUPPLY DIFFUSER SURFACE MOUNTED DETAIL
NO SCALE

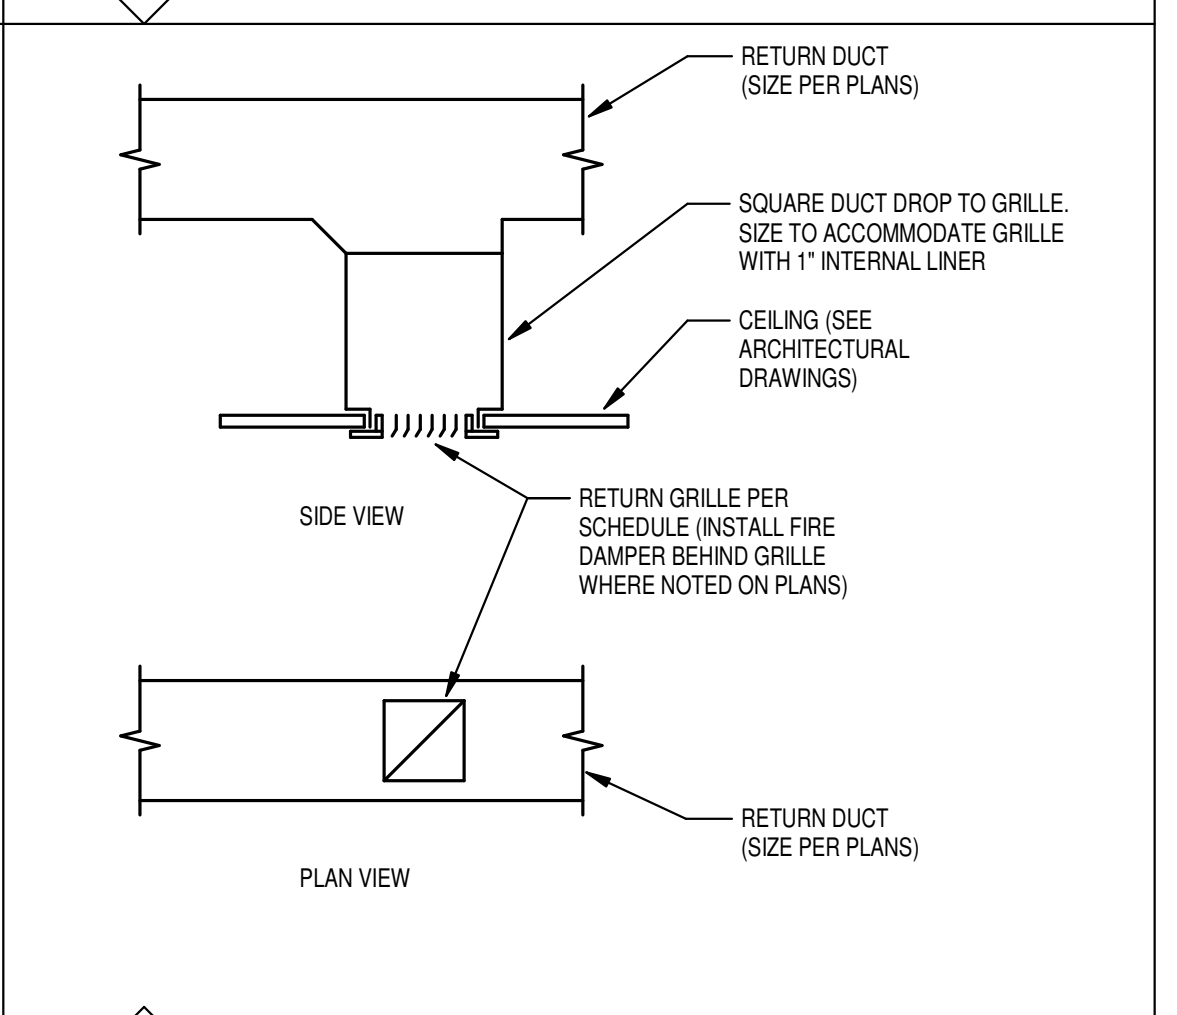

15 RETURN GRILLE DIAGRAM
NO SCALE

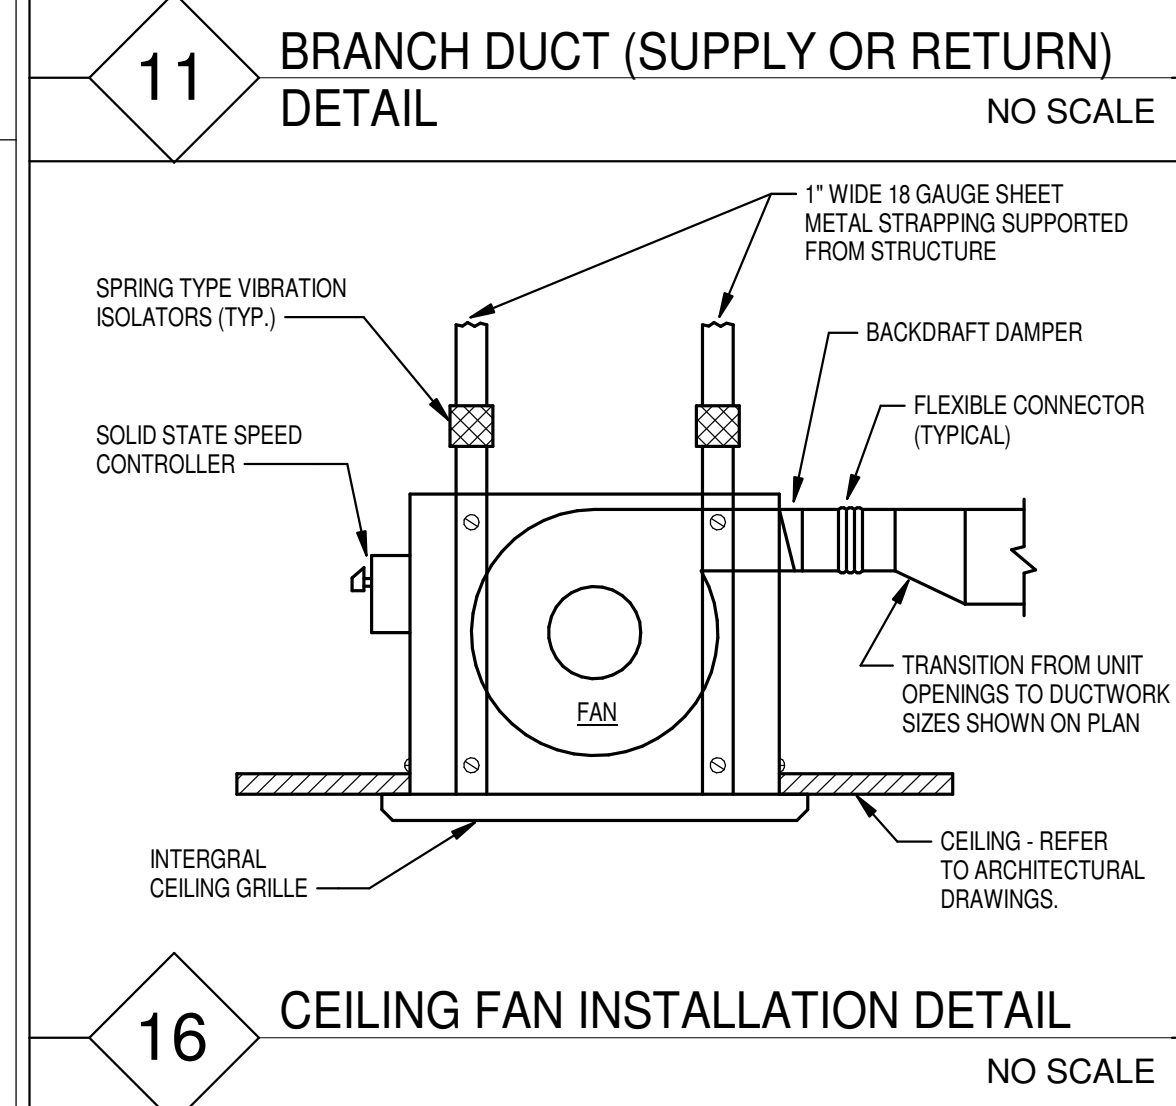

16 CEILING FAN INSTALLATION DETAIL
NO SCALE

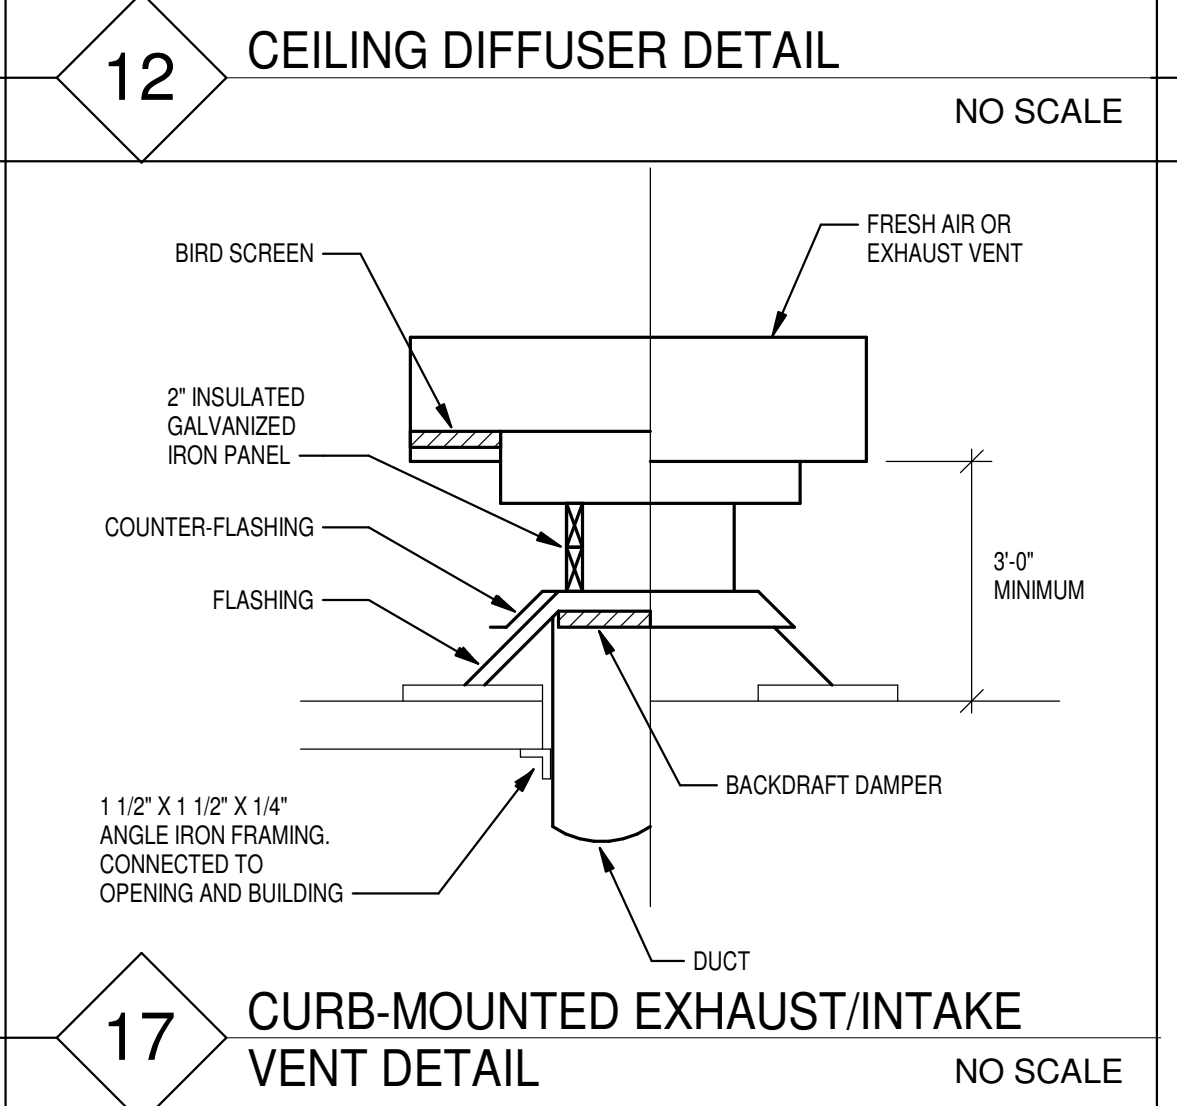

17 CURB-MOUNTED EXHAUST/INTAKE VENT DETAIL
NO SCALE

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SPINDLETOP SILSBEE
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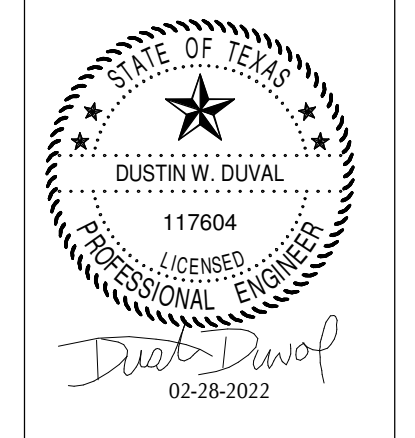
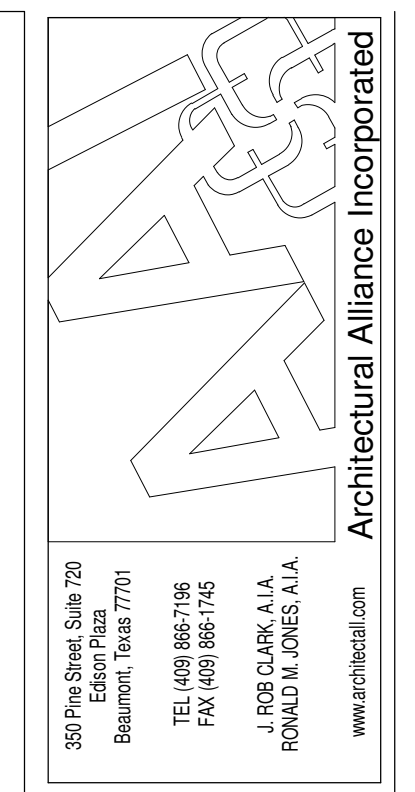
222 Durbin Dr.

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DESIGN DEVELOPMENT
DATE: _____
BIDS & CONSTRUCTION
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DRAWINGS SHEET TITLE
MECHANICAL DETAILS

SHEET NUMBER
M300
21061
PROJECT NUMBER

1304 BERTRAND DRIVE SUITE F7
LAFAYETTE, LOUISIANA 70506
(337) 234-7474 * FAX (337) 234-7774
Mechanical Contact: Dustin Duval, P.E.
dustin@meconsulting.com
Electrical Contact: David Carroll, P.E.
david@meconsulting.com
CONSULTING PROJECT No.: 21167.00



ISSUED FOR SCHEMATIC DESIGN... BIDS & CONSTRUCTION DATE: 02/28/2022

DRAWINGS SHEET TITLE MECHANICAL SCHEDULE

SHEET NUMBER M400 21061 PROJECT NUMBER

CONSULTING logo with contact information and QR code

DIFFUSER/GRILLE SCHEDULE

Table with columns: SYMBOL, SIZE, SERVICE, LOCATION, FINISH, O.B.D., BASIS OF DESIGN. Includes items A through RR.

NOTES: 1. COORDINATE FINAL FINISHES AND COLOR WITH ARCHITECT... 4. ALL DIFFUSERS SHALL HAVE ALUMINUM CONSTRUCTION.

VARIABLE REFRIGERANT FLOW (VRF) - 100% OUTSIDE AIR - OUTDOOR UNIT SCHEDULE

Table with columns: UNIT NO., SERVICE, COOLING, HEATING, ELECTRICAL, REFRIGERANT TYPE, SOUND LEVEL, BASIS OF DESIGN. Includes row OACU-1.

NOTES: 1. INSULATE SUCTION, LIQUID AND RECOVERY REFRIGERANT LINES... 5. ANCHOR UNITS TO CONCRETE PAD.

VARIABLE REFRIGERANT FLOW (VRF) - 100% OUTSIDE AIR - INDOOR UNIT SCHEDULE

Table with columns: UNIT NO., SERVICE, BRANCH CONTROLLER, FAN, COOLING, HEATING, REHEAT, ELECTRICAL, SOUND LEVEL, BASIS OF DESIGN. Includes row OAHU-1.

NOTES: 1. ALL UNITS SHALL BE COMPLETE WITH STOP VALVE WITH SERVICE PORT ON LIQUID, GAS, AND RECOVERY LINES... 3. UNITS LAT SHALL BE NEUTRAL (+72°F ADJUSTABLE).

ELECTRIC UNIT HEATER SCHEDULE

Table with columns: UNIT NO., SERVICE, MIN BTU/H OUTPUT, KW, ELECTRICAL SERVICE, NO. STAGES, MOUNTING HEIGHT, BASIS OF DESIGN. Includes row EUH-1.

NOTES: 1. PROVIDE UNITS WITH HEAVY DUTY 16 GAUGE STEEL GRILLE... 3. UNITS SHALL BE PROVIDED WITH INTEGRAL THERMOSTAT.

RELIEF / INTAKE VENTILATOR SCHEDULE

Table with columns: MARK, QTY., LOCATION, SERVICE, CFM, THROAT SIZE, EXT. S.P. (IN WC), MANUFACTURER, MODEL. Includes rows GV-1, GV-2, GV-3.

NOTES: 1. VENTILATOR SHALL BE PROVIDED WITH GALVANIZED BIRD SCREEN... 3. VENTILATOR HOOD SHALL HAVE ALUMINUM CONSTRUCTION.

BRANCH CONTROLLER SCHEDULE

Table with columns: UNIT NO., SERVICE, PORTS, VOLTAGE, PHASE, F.L.A., M.C.A., BASIS OF DESIGN. Includes rows MBC-1, MBC-2, OABC-1.

NOTES: 1. UNUSED PORTS SHALL HAVE INSULATED, CAPPED VENTS FOR FUTURE USE.

DUCTLESS DX MINI-SPLIT - INDOOR UNIT SCHEDULE

Table with columns: UNIT NO., SERVICE, FAN, COOLING, HEATING, BASIS OF DESIGN. Includes row MSAHU-1.

NOTES: 1. UNIT SHALL BE PROVIDED WITH HARD WIRED REMOTE CONTROLLERS... 7. INDOOR UNIT RECEIVES POWER FROM THE OUTDOOR UNIT.

DUCTLESS DX MINI-SPLIT - OUTDOOR UNIT SCHEDULE

Table with columns: UNIT NO., SERVICE, MIN. BTU/H OUTPUT, AMB. TEMP., VOLTAGE, PHASE, MCA, S.E.E.R., BASIS OF DESIGN. Includes row MSCU-1.

NOTES: 1. OUTDOOR UNIT PROVIDES POWER TO THE INDOOR UNIT... 3. PROVIDE A WALL MOUNTED OUTLET FOR EACH REFRIGERANT PIPING SET.

FAN SCHEDULE

Table with columns: UNIT NO., SERVICE, MIN. CFM, EXT. S.P., RPM, SONES, FAN H.P., TYPE, DRIVE, ELECTRICAL SERVICE, CONTROL, BASIS OF DESIGN. Includes rows EF-1 through KEF-1.

NOTES: 1. EF-1,2: PROVIDE FAN WITH INTEGRAL BACK-DRAFT DAMPER... 3. KEF-1: EF-1,2: PROVIDE FAN WITH INTEGRAL BACK-DRAFT DAMPER.

INLINE EXHAUST KITCHEN HOOD W/ FIRE SUPPRESSION SCHEDULE

Table with columns: HOOD NO., SERVICE, ELECTRICAL SERVICE, DIM. (EXH. CAPTURE AREA), MIN CFM, FAN POWER (W), BASIS OF DESIGN. Includes row KH-1.

NOTES: 1. HOOD SHALL BE WALL MOUNTED AT 24" TO 30" ABOVE THE RANGE... 7. PROVIDE HOOD WITH STAINLESS STEEL CLOSURE PANEL UP THROUGH CEILING.

VARIABLE REFRIGERANT FLOW (VRF) - HEAT RECOVERY - INDOOR UNIT SCHEDULE

Large table with columns: UNIT NO., SERVICE, UNIT TYPE, BC/BS CONTROLLER, FAN CFM, COOLING, HEATING, ELECTRICAL, SOUND LEVEL, CONTROL, BASIS OF DESIGN. Includes rows HR-1/1 through HR-2/8.

NOTES: 1. ALL UNITS SHALL BE COMPLETE WITH STOP VALVE WITH SERVICE PORT ON LIQUID, GAS, AND RECOVERY LINES... 9. CASSETTE UNITS SHALL CYCLE FAN ON/OFF WITH CALL FOR COOLING/HEATING.

VARIABLE REFRIGERANT FLOW (VRF) - HEAT RECOVERY - OUTDOOR UNIT SCHEDULE

Table with columns: GROUP NO., SERVICE, COOLING, HEATING, ELECTRICAL, REFRIGERANT TYPE, SOUND LEVEL, BASIS OF DESIGN. Includes rows HR-1, HR-2.

NOTES: 1. MAXIMUM DISTANCE BETWEEN COMBINED UNITS ON ONE REFRIGERANT SYSTEM - 32 FEET... 9. ANCHOR UNITS TO CONCRETE PAD.

DEFINE

ELECTRICAL ABBREVIATIONS

CT	DENOTES COUNTER-TOP-HEIGHT MOUNTED. CONTRACTOR TO VERIFY COUNTER TOP HEIGHT AND HEIGHT OF BACK SPLASH.
E	DENOTES EMERGENCY DEVICE
G	DENOTES GROUND FAULT INTERRUPTER PROTECTED
WP	DENOTES WEATHERPROOF
AFB	DENOTES ABOVE FINISHED FLOOR
C	DENOTES CONDUIT
A	DENOTES AMP
EWC	ELECTRICAL WATER COOLER
W	WALL MOUNTED 48" ABOVE FINISHED FLOOR OR AS NOTED
CB	CODE BLUE
IG	DENOTES ISOLATED GROUND
FDS	FUSED DISCONNECT SWITCH
BOF	BOTTOM OF FIXTURE
MRR	MANUFACTURER'S RECOMMENDED RATING
WR	WEATHER RESISTANT
VOJ	VERIFY ON JOB
VR	VANDAL RESISTANT
SPD	SURGE PROTECTION DEVICE - REFER TO SPECIFICATIONS.

ELECTRICAL LINE TYPE LEGEND

	SCREENED LINES/SYMBOLS INDICATE EXISTING DEVICES TO REMAIN.
	DASHED LINES/SYMBOLS INDICATE EXISTING DEVICES TO BE REMOVED OR RELOCATED.
	BOLD LINES/SYMBOLS INDICATE NEW OR RELOCATED DEVICES.

DESIGN

ELECTRICAL LEGEND

LIGHTING DESCRIPTION		SPECIAL SYSTEMS DESCRIPTION	
	LIGHTING FIXTURE-REFER TO LIGHTING FIXTURE SCHEDULE		COMMUNICATIONS OUTLET - DEEP 4" SQUARE BOX WITH SINGLE GANG PLASTER RING WITH PULLSTRING IN 1" CONDUIT TO ACCESSIBLE CEILING (18" A.F.F. OR AS NOTED) - PROVIDE A BLANK PLATE OR XX DENOTES CABLE TYPE AND QUANTITY; P=PHONE, D=DATA, C=COAX REFER TO SPECIFICATIONS
	LIGHTING FIXTURE-REFER TO LIGHTING FIXTURE SCHEDULE		TELEVISION OUTLET-DEEP 4" SQUARE BOX WITH SINGLE GANG PLASTER RING WITH PULLSTRING IN 1" C. TO ACCESSIBLE CEILING (VERIFY MOUNTING HEIGHT AND LOCATION WITH ARCHITECT) - PROVIDE BLANK PLATE OR XX DENOTES CABLE TYPE AND QUANTITY; P=PHONE, D=DATA, C=COAX REFER TO SPECIFICATIONS
	LIGHTING FIXTURE-REFER TO LIGHTING FIXTURE SCHEDULE		DATA JACK ABOVE CEILING W/ 30' OF SLACK (FUTURE WIRELESS ACCESS POINT) XX- DENOTES CABLE QUANTITY
	CEILING MOUNTED EXIT LIGHT - REFER TO LIGHTING FIXTURE SCHEDULE - ARROWS DEFINE DIRECTION		AUDIO & VISUAL - DEEP 4" SQUARE DEEP DOUBLE GANG BOX WITH DOUBLE GANG PLASTER RING (MOUNT 18" A.F.F. V.O.J.) WITH 1 1/4" CONDUIT WITH CABLE/PULLSTRING TO A MINIMUM OF 6" ABOVE CEILING.
	WALL MOUNTED EXIT LIGHT - COORDINATE FINAL MOUNTING HEIGHT WITH THE ARCHITECT - REFER TO LIGHTING FIXTURE SCHEDULE - ARROWS DEFINE DIRECTION		OVERHEAD PROJECTOR - DEEP 4" SQUARE BOX INSTALLED ABOVE CEILING ADJACENT TO OVERHEAD PROJECTOR (SEE DETAIL)
	EMERGENCY LIGHT (8'-0" A.F.F. OR AS NOTED) - REFER TO LIGHTING FIXTURE SCHEDULE		AUDIO & VISUAL - RECESSED FLOOR BOX - WIREMOLD RFB9 OR EQUAL (SEE DETAIL)
	CEILING MOUNTED EGRESS LIGHT - REFER TO LIGHTING FIXTURE SCHEDULE		SMART BOARD J-BOX - 4" SQUARE DEEP BOX WITH SINGLE GANG PLASTER RING WITH CABLE/PULLSTRING IN 3/4" CONDUIT TO ACCESSIBLE CEILING. (SEE DETAIL)
	PHOTOCELL		CONTROL STATION - 4" SQUARE DEEP BOX WITH SINGLE GANG PLASTER RING WITH CABLE/PULLSTRING IN 3/4" CONDUIT TO ACCESSIBLE CEILING. (SEE DETAIL)
	SINGLE POLE TOGGLE SWITCH (48" A.F.F. TO CENTER OF DEVICE OR AS NOTED)	FIRE ALARM DESCRIPTION	
	THREE-WAY TOGGLE SWITCH (48" A.F.F. TO CENTER OF DEVICE OR AS NOTED)		FIRE ALARM PULL STATION - DEEP 4" SQUARE BOX WITH SINGLE GANG PLASTER RING WITH CABLE IN 3/4" CONDUIT TO ACCESSIBLE CEILING (48" A.F.F. TO CENTER OF DEVICE)
	WALL MOUNTED DIMMER SWITCH WITH ON/OFF AND 0-10V OUTPUT DIMMING. DIMMER MUST BE COMPATIBLE WITH BALLAST OR LED. REFER TO SPECIFICATIONS. PROVIDE ALL NECESSARY CONDUCTORS FOR COMPLETE OPERATING SYSTEM. (48" A.F.F. TO CENTER OF DEVICE OR AS NOTED)		FIRE ALARM VALVE SUPERVISORY SWITCH- PROVIDE MONITORING MODULE FOR ALL VALVE SUPERVISORY SWITCHES, COORDINATE REQUIREMENTS, QUANTITIES, AND LOCATIONS WITH THE SPRINKLER CONTRACTOR
	MOTOR RATED SWITCH (48" A.F.F. TO CENTER OF DEVICE OR AS NOTED), CONTRACTOR TO PROVIDE SWITCH TO DE-ENERGIZE EACH CURRENT CARRYING CONDUCTOR. LOCATE ADJACENT TO EQUIPMENT BEING SERVED IN A READILY ACCESSIBLE LOCATION.		FIRE ALARM FLOW DETECTOR/SWITCH - PROVIDE MONITORING MODULE FOR ALL FLOW DETECTORS/SWITCHES, COORDINATE REQUIREMENTS, QUANTITIES, AND LOCATIONS WITH THE SPRINKLER CONTRACTOR
	SINGLE POLE KEYED SWITCH (48" A.F.F. TO CENTER OF DEVICE OR AS NOTED)		MAGNETIC DOOR HOLDER - CONTRACTOR TO CONNECT TO 120V CIRCUIT. DOOR HOLDERS SHALL RELEASE UPON ACTIVATION OF THE FIRE ALARM SYSTEM
	SWITCH (48" A.F.F. TO CENTER OF DEVICE OR AS NOTED); COORDINATE TYPE AND INSTALLATION REQUIREMENTS WITH MANUFACTURE. COORDINATE LOCATION WITH OWNER.		FIRE ALARM CONTROL PANEL
	SINGLE POLE SWITCH. MOUNT IN DOOR SWING. LEE ELECTRIC: 210DN		FIRE ALARM ANNUNCIATOR PANEL - BACK BOX WITH 1" CONDUIT MINIMUM TO ACCESSIBLE CEILING
	INBOARD AND OUTBOARD SWITCHING UNLESS NOTED OTHERWISE (48" A.F.F. TO CENTER OF DEVICE OR AS NOTED)		SMOKE DETECTOR - DEEP 4" SQUARE BOX WITH SINGLE GANG PLASTER RING WITH CABLE IN 3/4" CONDUIT TO ACCESSIBLE CEILING.
	SINGLE POLE DIGITAL PRESET COUNT DOWN TYPE TIMER SWITCH (48" A.F.F. TO CENTER OF DEVICE OR AS NOTED) SENSORSWITCH PTS 60 OR EQUAL		SINGLE STATION SMOKE DETECTOR 120 VOLT WITH BATTERY BACKUP AND INTERCONNECTED TO ALL SMOKE DETECTORS IN UNIT.
	WALL MOUNTED OCCUPANCY SENSOR (48" AFF TO CENTER OF DEVICE OR AS NOTED) - REFER TO SPECIFICATIONS.		FIRE ALARM DUCT DETECTOR
	WALL MOUNTED DOUBLE SWITCH OCCUPANCY SENSOR (48" AFF TO CENTER OF DEVICE OR AS NOTED) - REFER TO SPECIFICATIONS.		HEAT DETECTOR - DEEP 4" SQUARE BOX WITH SINGLE GANG PLASTER RING WITH CABLE IN 3/4" CONDUIT TO ACCESSIBLE CEILING.
	CORNER MOUNTED OCCUPANCY SENSOR - MOUNTING HEIGHT TO BE DETERMINED PER MANUFACTURER'S RECOMMENDATIONS FOR OPTIMAL COVERAGE - MYTECH, WATT STOPPER		ADDRESSABLE INPUT/OUTPUT MODULE
POWER DESCRIPTION			FIRE ALARM WALL MOUNTED STROBE UNIT - DEEP 4" SQUARE BOX WITH SINGLE GANG PLASTER RING WITH CABLE IN 3/4" CONDUIT TO ACCESSIBLE CEILING (MOUNTING HEIGHT AS PER NFPA 72, ALL DEVICES SHALL BE AT SAME HEIGHT) XX DENOTES CANDELA RATING
	DUPLEX CONVENIENCE OUTLET (18" A.F.F. FOR GENERAL AREAS, 36" A.F.F. FOR GARAGES, HANGARS AND THE LIKE OR AS NOTED)		FIRE ALARM CEILING MOUNTED STROBE - XX DENOTES CANDELA RATING
	TELEVISION OUTLET (VERIFY MOUNTING HEIGHT AND LOCATION WITH ARCHITECT)		FIRE ALARM WALL MOUNTED HORN/STROBE UNIT - DEEP 4" SQUARE BOX WITH SINGLE GANG PLASTER RING WITH CABLE IN 3/4" CONDUIT TO ACCESSIBLE CEILING (MOUNTING HEIGHT AS PER NFPA) XX DENOTES CANDELA RATING
	ELECTRICAL WATER COOLER; COORDINATE ELECTRICAL DEVICE/OUTLET TYPE AND LOCATION WITH PLUMBING CONTRACTOR (CONCEAL OUTLET/DEVICE BEHIND COOLER) OUTLET TO BE GROUND FAULT INTERRUPTER PROTECTED.		FIRE ALARM CEILING MOUNTED HORN/STROBE - XX DENOTES CANDELA RATING
	MICROWAVE OUTLET - RECESSED 20 AMP DUPLEX OUTLET. HUBBELL OR EQUAL. VERIFY EXACT MOUNTING LOCATION WITH OWNER/ARCHITECT PRIOR TO ROUGH IN.		FIRE ALARM WALL MOUNTED SPEAKER - DEEP 4" SQUARE BOX WITH SINGLE GANG PLASTER RING WITH CABLE IN 3/4" CONDUIT TO ACCESSIBLE CEILING (MOUNTING HEIGHT AS PER NFPA 72, ALL DEVICES SHALL BE AT THE SAME HEIGHT)
	WATER HEATER; COORDINATE ELECTRICAL OUTLET/DISCONNECT TYPE AND LOCATION WITH PLUMBING CONTRACTOR		FIRE ALARM CEILING MOUNTED SPEAKER
	SMART BOARD OUTLET - SB DENOTES HEIGHT OF OUTLET PER OWNER		FIRE ALARM WALL MOUNTED SPEAKER/STROBE UNIT - DEEP 4" SQUARE BOX WITH SINGLE GANG PLASTER RING WITH CABLE IN 3/4" CONDUIT TO ACCESSIBLE CEILING (MOUNTING HEIGHT AS PER NFPA 72, ALL DEVICES SHALL BE AT THE SAME HEIGHT) XX DENOTES CANDELA RATING
	DUPLEX CONVENIENCE OUTLET (18" A.F.F. OR AS NOTED) TR DENOTES TAMPER RESISTANT - HUBBELL: RR205TR, GFTR20 OR EQUAL		FIRE ALARM CEILING MOUNTED SPEAKER STROBE - XX DENOTES CANDELA RATING
	COMBINATION RECEPTACLE/OUTLET AND DUAL USB CHARGER - LEVITON T5832 OR EQUAL. (18" A.F.F. OR AS NOTED)	SECURITY SYSTEM DESCRIPTION	
	DOUBLE DUPLEX CONVENIENCE OUTLET (18" A.F.F. OR AS NOTED)		SURVEILLANCE CAMERA - DEEP 4" SQUARE BOX WITH SINGLE GANG PLASTER RING WITH CABLE/PULLSTRING IN 3/4" CONDUIT TO ACCESSIBLE CEILING. VERIFY HEIGHT WITH ENGINEER.
	SPECIAL OUTLET (VERIFY TYPE AND MOUNTING HEIGHT WITH EQUIPMENT MANUFACTURE)		CARD READER - DEEP 4" SQUARE BOX WITH SINGLE GANG PLASTER RING WITH PULLSTRING IN 3/4" CONDUIT TO ACCESSIBLE CEILING (48" A.F.F. TO CENTER OF DEVICE OR AS NOTED)
	COUNTER TOP DUPLEX OUTLET (CLEAR BACK SPLASH)		SECURITY SYSTEM MOTION DETECTOR - LONG RANGE - COORDINATE ROUGH-IN REQUIREMENTS WITH SECURITY SYSTEM PROVIDER.
	CEILING MOUNTED OUTLET		SECURITY SYSTEM MOTION DETECTOR - WIDE RANGE - COORDINATE ROUGH-IN REQUIREMENTS WITH SECURITY SYSTEM PROVIDER.
	MOTOR STARTER - PROVIDED BY MECHANICAL CONTRACTOR, INSTALLED BY ELECTRICAL CONTRACTOR.		SECURITY SYSTEM KEY PAD - DEEP 4" SQUARE BOX WITH SINGLE GANG PLASTER RING WITH CABLE/PULLSTRING IN 3/4" CONDUIT TO ACCESSIBLE CEILING
	FLOOR BOX, POWER (COORDINATE FINAL LOCATION WITH OWNER/ARCHITECT PRIOR TO INSTALLATION) MINIMUM 2-3/4" CONDUITS TO ACCESSIBLE CEILING.		ACCESS CONTROL - ELECTRIC DOOR STRIKE (BY OTHERS) - 3/4" CONDUIT TO ACCESSIBLE CEILING. COORDINATE ROUGH-IN REQUIREMENTS WITH SECURITY SYSTEM PROVIDER.
	FLOOR BOX, COMBINATION POWER/COMMUNICATIONS (COORDINATE FINAL LOCATION WITH OWNER/ARCHITECT PRIOR TO INSTALLATION. 2-1" CONDUITS IN SLAB TO 6" ABOVE ACCESSIBLE CEILING - PROVIDE BLANK PLATE OR XX DENOTES CABLE TYPE AND QUANTITY; P=PHONE, D=DATA, C=COAX REFER TO SPECIFICATIONS)		SECURITY SYSTEM HORN - DEEP 4" SQUARE BOX WITH SINGLE GANG PLASTER RING WITH CABLE/PULLSTRING IN 3/4" CONDUIT TO ACCESSIBLE CEILING.
	JUNCTION BOX		
	CONTROL POWER FOR ENERGY MANAGEMENT SYSTEM - PROVIDE OUTLET OR JUNCTION BOX AT LOCATION PER EMS CONTRACTOR		
	HAND DRYER - COORDINATE OUTLET/DEVICE TYPE WITH SUPPLIER. COORDINATE LOCATION WITH THE OWNER/ARCHITECT PRIOR TO ROUGH-IN.		
	ELECTRICAL MOTOR (COORDINATE TERMINATION WITH SUPPLIER)		
	FUSED DISCONNECT SWITCH - FUSE AT MANUFACTURE RECOMMENDED RATING UNLESS NOTED OTHERWISE. XX DENOTES DISCONNECT SIZE, Y DENOTES PHASE, ZZ DENOTES FUSE SIZE.		
	ELECTRICAL PANEL SURFACE MOUNTED		
	ELECTRICAL PANEL FLUSH MOUNTED		
	TELEPHONE/POWER POLE: COORDINATE EXACT MOUNTING LOCATION WITH FURNITURE MANUFACTURE. MAKE FINAL CONNECTIONS. REFER TO DETAIL. WIRE MOLD: 30TP-4V		
	CONDUIT RUN CONCEALED IN WALL OR ABOVE CEILING		
	CONDUIT RUN CONCEALED UNDER FLOOR OR BELOW GRADE		
	HOMERUN TO ELECTRIC PANEL BOARD (INDICATED NUMBER OF CIRCUIT BY NUMBER OF ARROWS)		
	THREE (3) CONDUCTORS RUN IN CONDUIT. EVERY CIRCUIT TO HAVE A GROUND. SHARED NEUTRAL IS NOT ALLOWED.		
	FOUR (4) CONDUCTORS RUN IN CONDUIT. EVERY CIRCUIT TO HAVE A GROUND. SHARED NEUTRAL IS NOT ALLOWED.		
	FIVE (5) CONDUCTORS RUN IN CONDUIT. EVERY CIRCUIT TO HAVE A GROUND. SHARED NEUTRAL IS NOT ALLOWED.		
	FOUR (4) CONDUCTORS RUN IN CONDUIT, ONE CONDUCTOR DESIGNATED FOR ISOLATED GROUND		
	MOTORIZED DAMPER - PROVIDE BY OTHERS. ELECTRICALLY POWERED BY ELECTRICAL CONTRACTOR WHEN NOTED.		
	START - STOP STATION - COORDINATE WITH EQUIPMENT PROVIDER.		
	VARIABLE FREQUENCY DRIVE PROVIDED BY MECHANICAL AND INSTALLED BY ELECTRICAL. MAINTAIN CLEARANCES PER NFPA 70		
INTERCOM DESCRIPTION			
	CLOCK, D=DENOTES DOUBLE FACE, S=DENOTES SINGLE FACE - DEEP 4" SQUARE BOX WITH SINGLE GANG PLASTER RING WITH CABLE/PULLSTRING IN 3/4" CONDUIT TO ACCESSIBLE CEILING		
	ADMINISTRATIVE PHONE - PHONE FOR SPACE PER SPECIFICATIONS		
	NON-ADMINISTRATIVE PHONE - PHONE FOR SPACE PER SPECIFICATIONS		
	CLASSROOM PHONE - PROVIDE PHONE FOR SPACE PER SPECIFICATIONS		
	CEILING MOUNTED SPEAKER - PROVIDE SPEAKER BACK BOX AND CABLING		
	INTERCOM CONTROL STATION - DEEP 4" SQUARE BOX WITH SINGLE GANG PLASTER RING WITH CABLE/PULLSTRING IN 3/4" CONDUIT TO ACCESSIBLE CEILING.		
	TRUMPET SPEAKER - DEEP 4" SQUARE BOX WITH SINGLE GANG PLASTER RING WITH CABLE/PULLSTRING IN 3/4" CONDUIT TO ACCESSIBLE CEILING. VERIFY HEIGHT WITH ENGINEER.		

NOTES:

- ITEMS ON THIS SCHEDULE ARE NOT NECESSARILY SHOWN ON PLANS.

DELIVER



ELECTRICAL GENERAL NOTES

- ELECTRICAL INSTALLATION SHALL BE IN ACCORDANCE WITH THE CURRENT EDITION OF THE NATIONAL ELECTRICAL CODE (NEC) AS WELL AS ANY LOCAL CODES AND ORDINANCES.
- MAINTAIN PROPER WORKING SPACE CLEARANCES ABOUT ELECTRICAL EQUIPMENT PER NEC ARTICLE 110.26.
- FULLY COORDINATE ALL ELECTRICAL REQUIREMENTS OF EQUIPMENT BEING FURNISHED BY ALL DIVISIONS UNDER THIS CONSTRUCTION CONTRACT. EACH SYSTEM SHALL BE COMPLETE AND FULLY FUNCTIONAL. THIS INCLUDES MECHANICAL, PLUMBING, OWNER PROVIDED AND CONTRACTOR PROVIDED EQUIPMENT. CONTRACTOR TO REFER TO EQUIPMENT INSTALLATION DOCUMENTS AND SHOP DRAWINGS PRIOR TO ANY ROUGH-IN.
- CONTRACTOR SHALL COORDINATE CIRCUIT BREAKER AND FUSE SIZES FOR MECHANICAL EQUIPMENT PER SUBMITTED EQUIPMENT MANUFACTURER'S RECOMMENDED NAMEPLATE RATINGS PRIOR TO SHOP DRAWING PHASE OF PROJECT.
- INTERRUPTION OF SERVICE, BEFORE ANY EQUIPMENT IS SHUT DOWN FOR DISCONNECTING OR TIE-INS, ARRANGEMENTS SHALL BE MADE WITH THE ARCHITECT AND THIS WORK SHALL BE DONE AT THE TIME BEST SUITED TO THE OWNER. OUTAGES MUST BE SCHEDULED THROUGH THE ARCHITECT. THE ARCHITECT SHALL REVIEW EXTENT, LENGTH, AND TIMING OF OUTAGES. SERVICES SHALL BE RESTORED THE SAME DAY. PROVIDE TEMPORARY POWER OR OTHER SERVICES AS REQUIRED DURING OUTAGES. ALL OVERTIME OR PREMIUM COSTS ASSOCIATED WITH THIS WORK SHALL BE INCLUDED IN THE BASE BID.
- COORDINATE LOCATION OF ELECTRICAL EQUIPMENT WITH PIPES AND DUCT WORK BEING SUPPLIED BY OTHER DIVISIONS. THE EQUIPMENT SPACE INCLUDED ALL REFERENCED NEC CLEARANCES SHALL BE MAINTAINED. IF ANY PIPES OR DUCT WORK VIOLATE ANY ELECTRICAL CLEARANCE REQUIREMENTS, IT SHALL BE REMOVED AND RELOCATED AT THE CONTRACTOR'S EXPENSE. DRIP PANS ARE NOT PERMITTED UNLESS SPECIFICALLY CALLED FOR IN THE CONSTRUCTION DOCUMENTS.
- IT SHALL BE THE CONTRACTOR'S RESPONSIBILITY TO SEE THAT ALL EQUIPMENT THAT MAY REQUIRE MAINTENANCE AND OPERATION ARE READILY ACCESSIBLE. REGARDLESS OF THE DIAGRAMMATIC LOCATION SHOWN ON THE DRAWINGS, ALL CONNECTIONS TO FIXTURES AND EQUIPMENT SHOWN ON THE DRAWINGS SHALL BE CONSIDERED DIAGRAMMATIC UNLESS OTHERWISE INDICATED BY A SPECIFIC DETAIL ON THE DRAWINGS. THE ACTUAL CONNECTIONS SHALL BE MADE TO FULLY SUIT THE REQUIREMENTS OF EACH CASE AND ADEQUATELY PROVIDE FOR SERVICING.
- CONTRACTOR SHALL TAMP AND BACKFILL ALL TRENCHES. TRENCHES SHALL BE LEVEL WITH FINISH GRADE.
- CONTRACTOR SHALL VISIT THE SITE AND DETERMINE THE EXTENT OF DEMOLITION WORK AND NEW WORK NEEDED FOR THIS PROJECT.
- CONTRACTOR SHALL BECOME FAMILIAR WITH THE PROJECT SCOPE, CONSTRAINTS, UTILITY CONNECTIONS, AND BUILDING SERVICES.
- CONTRACTOR SHALL GIVE FIRST RIGHT TO REFUSAL OF SALVAGE TO THE OWNER. IF THE OWNER ELECTS TO NOT KEEP SALVAGE, CONTRACTOR SHALL REMOVE SALVAGE BY LAWFUL MEANS.
- DRAWINGS ARE SCHEMATIC AND DIAGRAMMATIC IN NATURE. DRAWINGS SHALL NOT BE SCALED. COORDINATE ROUTING OF SERVICES WITH SITE CONDITIONS AND WITH WORK OF OTHER TRADES.
- FIELD VERIFY DIMENSIONS PRIOR TO ORDERING, FABRICATING, AND ERECTION OF MATERIAL AND/OR EQUIPMENT. NOTIFY THE ENGINEER OF DISCREPANCIES IN A TIMELY MANNER.
- SEAL PENETRATIONS THROUGH THE BUILDING ENVELOPE.
- PENETRATIONS THROUGH RATED WALLS, FLOORS, PARTITIONS AND ASSEMBLIES SHALL BE INSTALLED AND FIRESAFED TO MEET UL FIRE RESISTANCE LISTING AND NFPA REQUIREMENTS FOR THE PENETRATION.
- COORDINATE DEVICES REQUIRING ACCESS PANELS WITH THE ARCHITECT AND OTHER TRADES.
- DEVICE SYMBOLS ALONG WITH DRAWINGS, DRAWING NOTES, AND SPECIFICATIONS ARE INTENDED TO PROVIDE A COMPLETE SYSTEM. CONTRACTOR TO COORDINATE WITH ALL TRADES TO PROVIDE A COMPLETE SYSTEM.

1304 BERTRAND DRIVE SUITE F7
LAFAYETTE, LOUISIANA 70506
(337) 234-7474 * FAX (337) 234-7774

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Electrical Contact: David Carroll, P.E.
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PROJECT No.: 21167.00

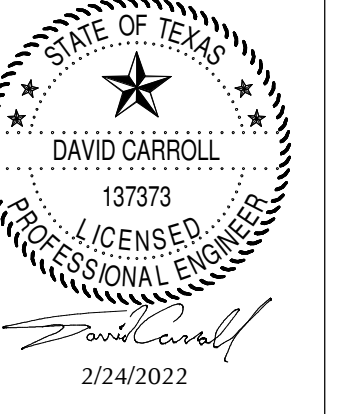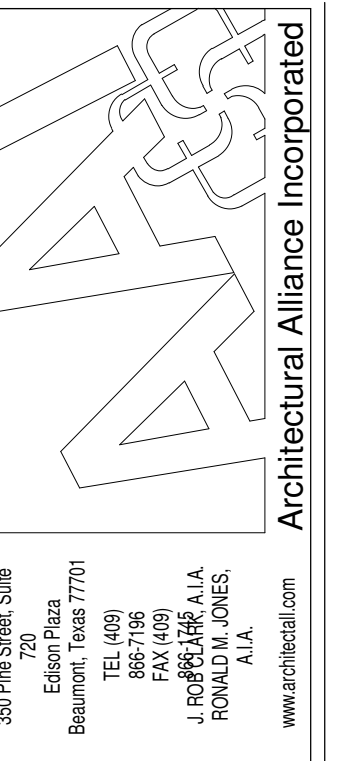

SPINDLETOP SILSBEE

Spindletop MHR

222 Durbin Dr.
Silsbee, TX 77656

ISSUED FOR SCHEMATIC DESIGN

DESIGN DEVELOPMENT DATE: _____

BIDS & CONSTRUCTION DATE: 02/28/2022

REVISION: DATE: _____

REVISION: DATE: _____


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DRAWINGS SHEET TITLE
ELECTRICAL LEGEND & NOTES

SHEET NUMBER
E000

21061
PROJECT NUMBER

ELECTRICAL NOTES

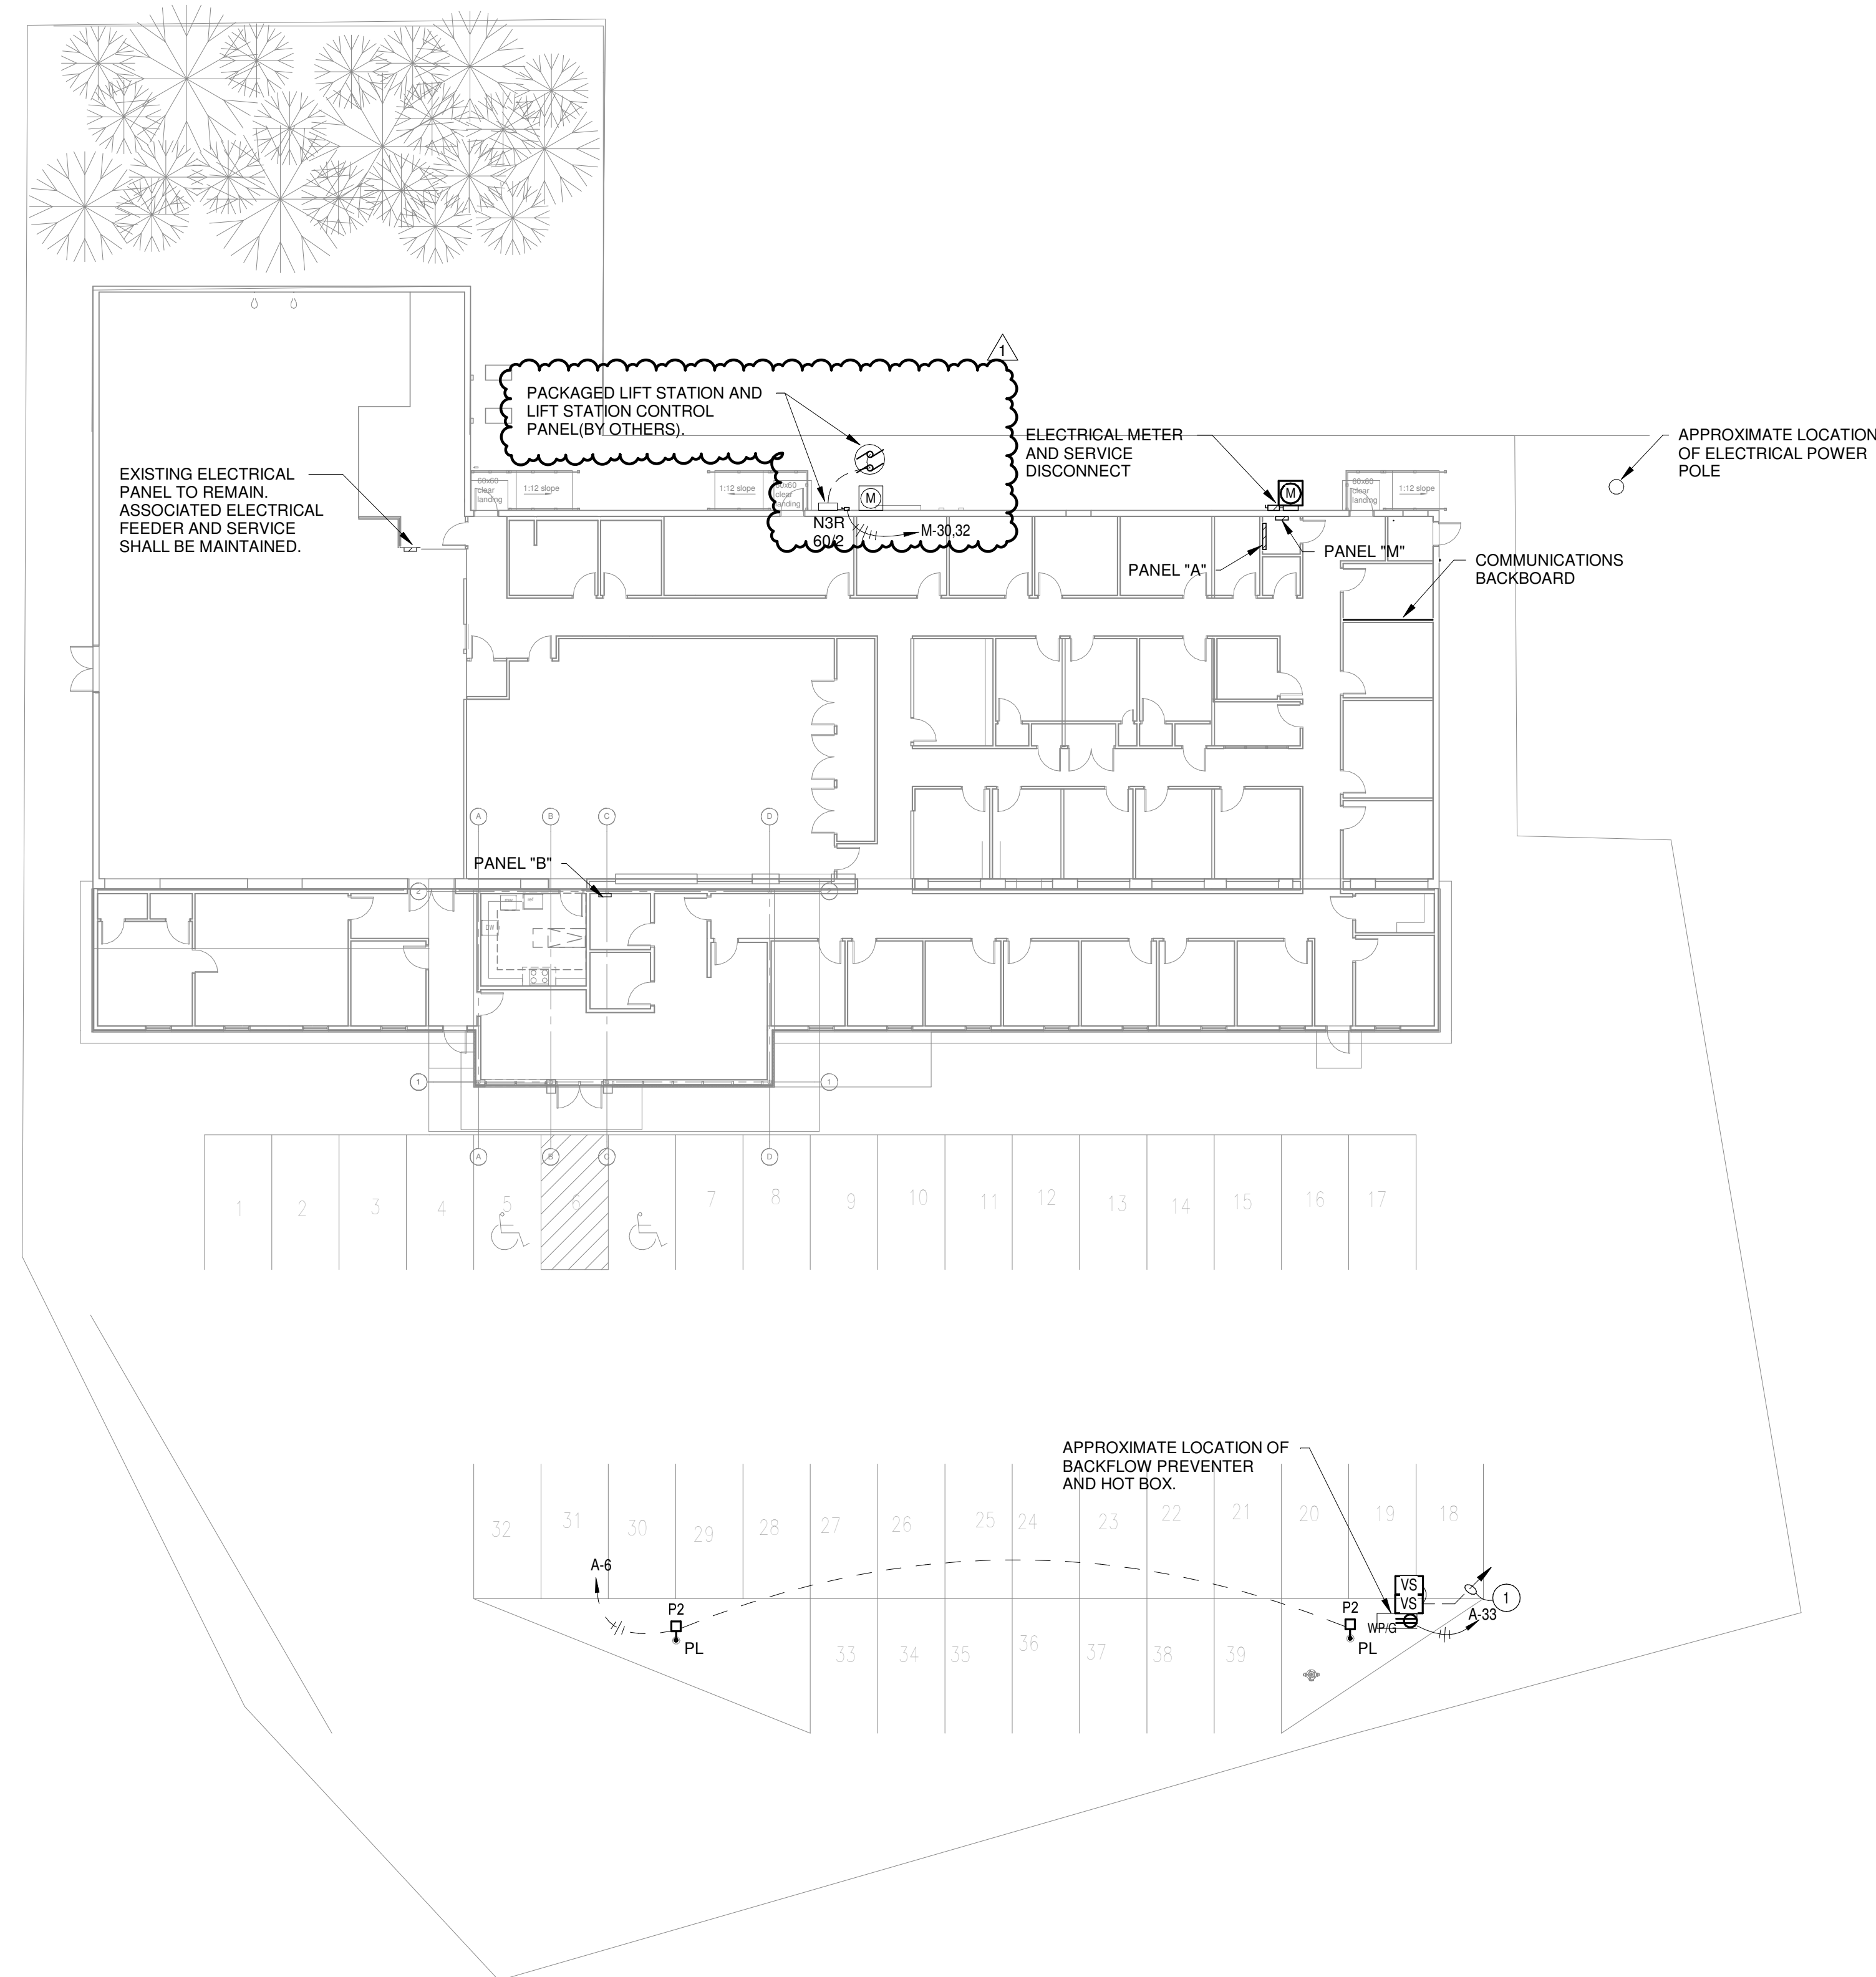

1 Electrical Site Plan
1/16" = 1'-0" Refer to Architectural Drawings for All Dimensions

1304 BERTRAND DRIVE SUITE F7
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STATE OF TEXAS
DAVID CARROLL
137373
LICENSED PROFESSIONAL ENGINEER
03/07/2022

SPINDLETOP SILSBEE
Spindletop MHMR

222 Durbin Dr
Silsbee, TX 77656

ISSUED FOR SCHEMATIC DESIGN
DATE: _____

DESIGN DEVELOPMENT
DATE: _____

BIDS & CONSTRUCTION
DATE: 02/28/2022

REVISION: Revision 1
DATE: 03/07/2022

REVISION: _____
DATE: _____

REVISION: _____
DATE: _____



DRAWINGS SHEET TITLE
ELECTRICAL SITE PLAN

SHEET NUMBER
E100R1

21061
PROJECT NUMBER

GENERAL ELECTRICAL DEMOLITION NOTES:

1. REMOVE EXISTING LIGHT FIXTURES, DISCONNECTS, OUTLETS, BOXES, WIRING, CONDUIT, ETC. AND OFFER TO OWNER. IF OWNER REFUSES, ELECTRICAL CONTRACTOR SHALL REMOVE FROM SITE AND PROPERLY AND LEGALLY DISPOSE.
2. REMOVE PANELS, ASSOCIATED CIRCUITS, AND FEEDER.
3. REMOVE EXISTING DEVICES FROM WALLS BEING DEMOLISHED. IF THEY OCCUR IN THE MIDDLE OF A CIRCUIT, MAKE THE REMAINDER OF THE CIRCUIT CONTINUOUS.
4. RELOCATE EXISTING DEVICE AND EXTEND EXISTING CIRCUITRY.
5. MAINTAIN ALL REMAINING EXISTING CIRCUITS WHERE INTERRUPTED BY DEMOLITION WORK. PROVIDE WIRING AND CONDUIT TO RESTORE CONTINUOUS CIRCUIT INTEGRITY.
6. PROTECT EXISTING ELECTRICAL EQUIPMENT AND INSTALLATIONS INDICATED TO REMAIN. IF DAMAGED OR DISTURBED IN THE COURSE OF THE WORK, REMOVE DAMAGED PORTIONS AND INSTALL NEW PRODUCTS OF EQUAL CAPACITY, QUALITY, AND FUNCTIONALITY.
7. EXISTING ROUTING OF CIRCUITS/FEEDERS ARE INDICATED ON DRAWINGS FOR REFERENCE ONLY. CONTRACTOR IS RESPONSIBLE FOR VERIFYING EXACT LOCATIONS OF FEEDERS/CIRCUITS PRIOR TO ANY EXCAVATION. CONTRACTOR SHALL BARE ALL COST OF RESTORING EXISTING ELECTRICAL FUNCTIONALITY SHOULD ANY EXISTING UNDERGROUND ELECTRICAL UTILITIES BE DAMAGED DURING THE COURSE OF CONSTRUCTION.

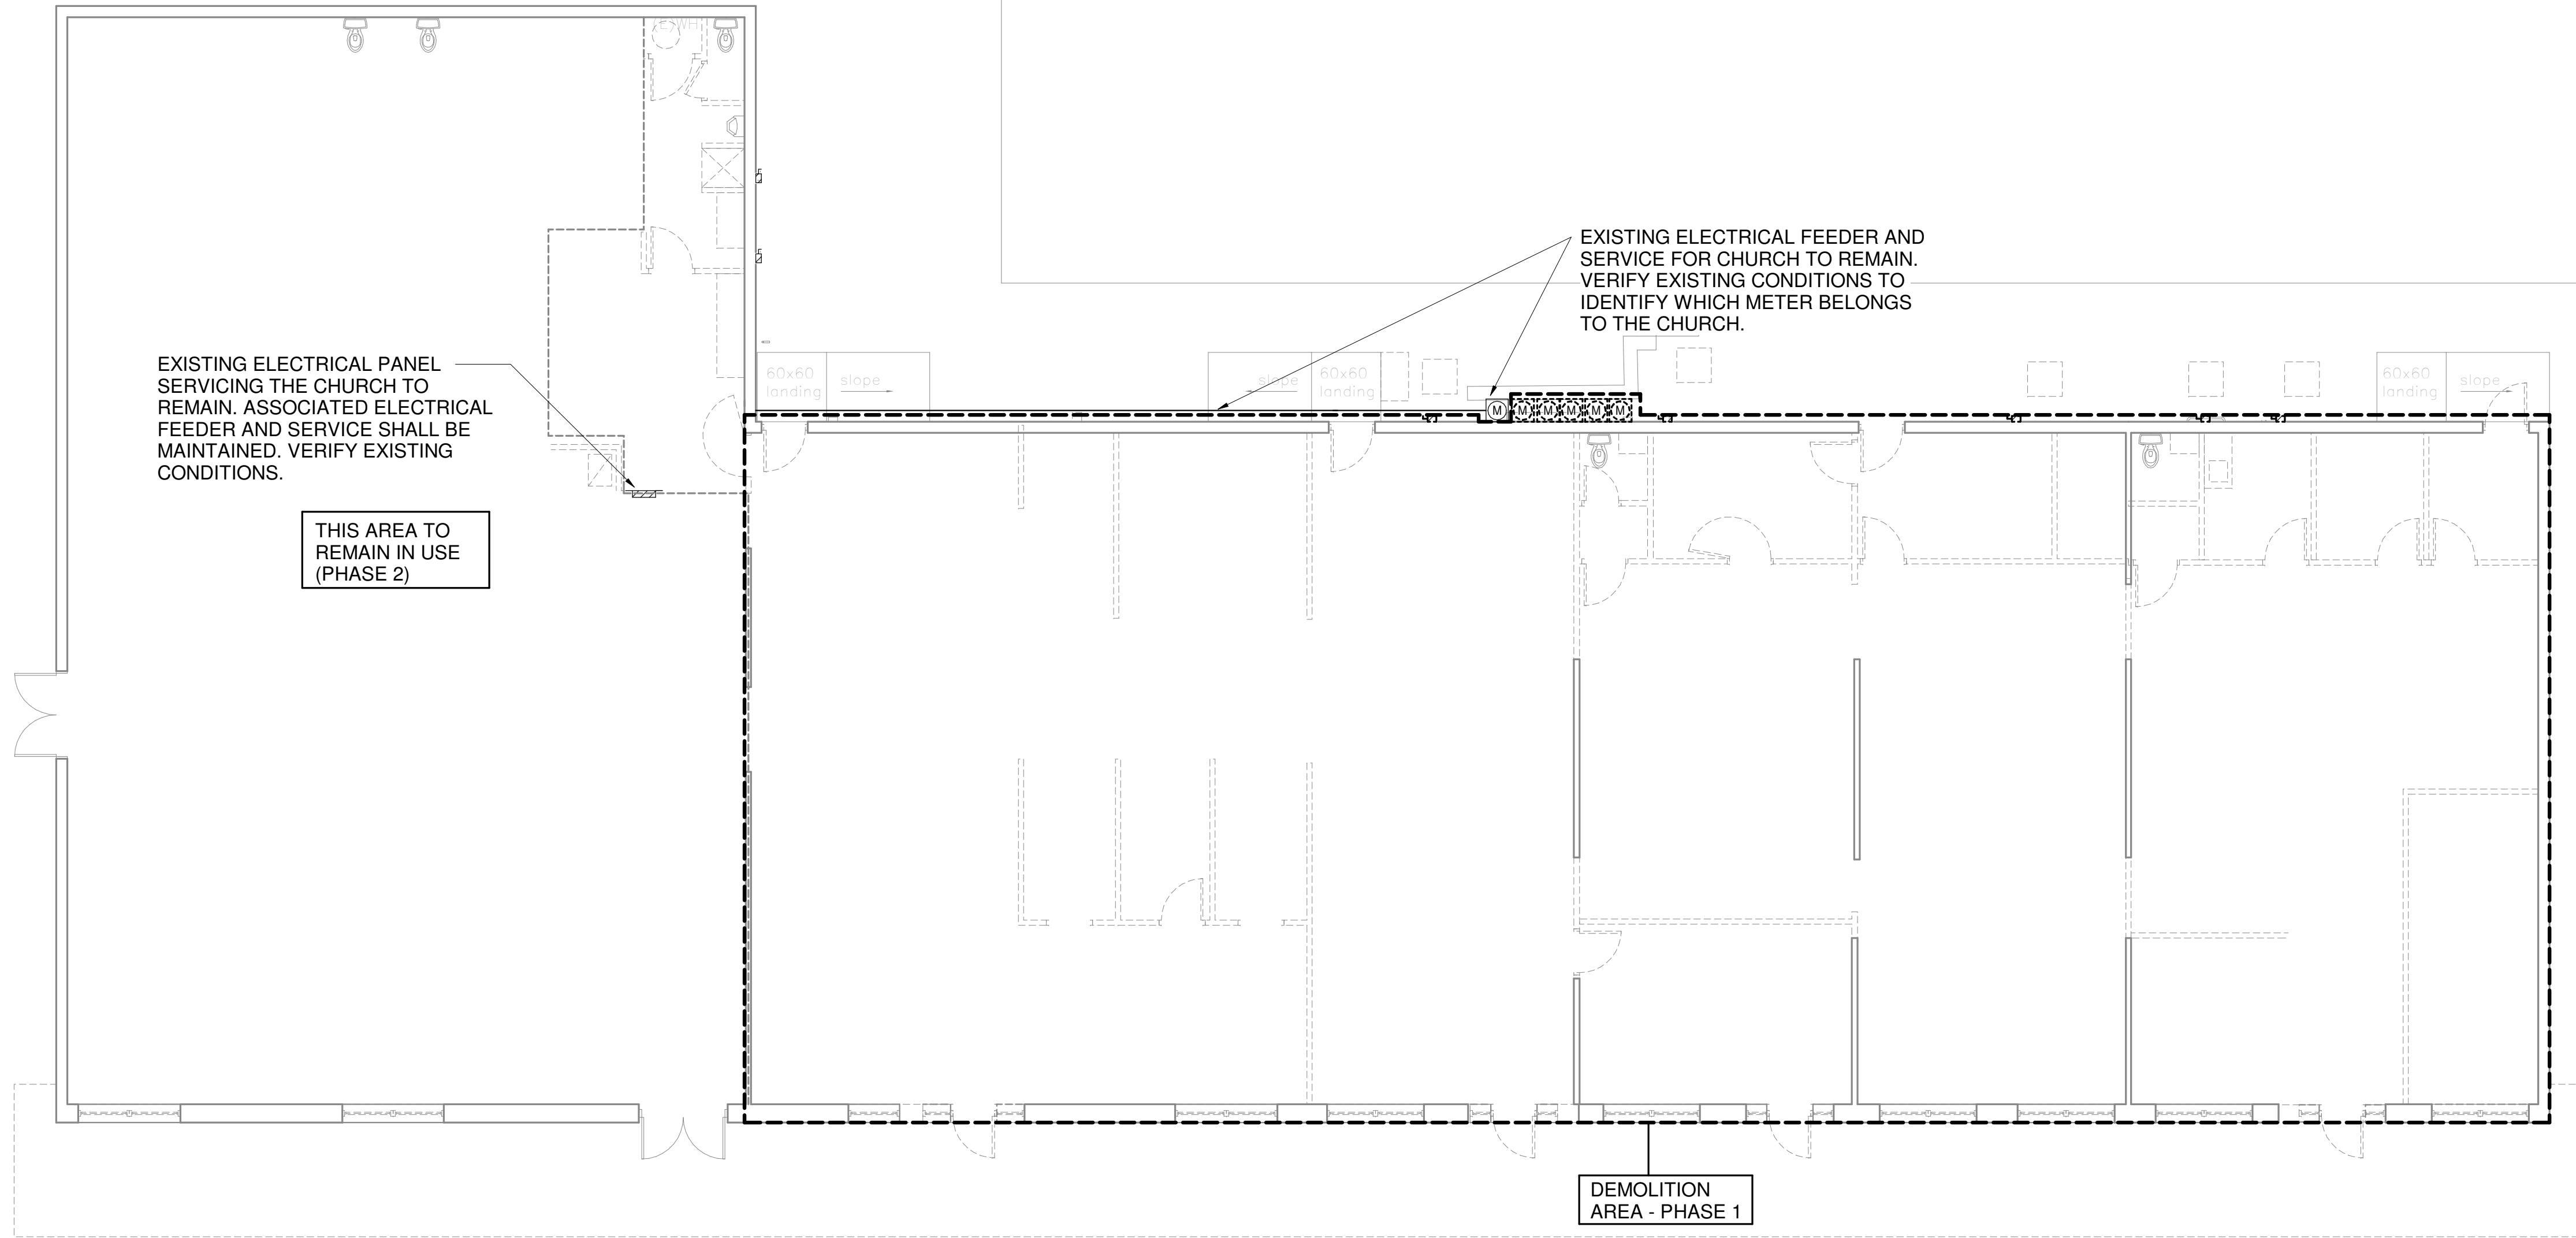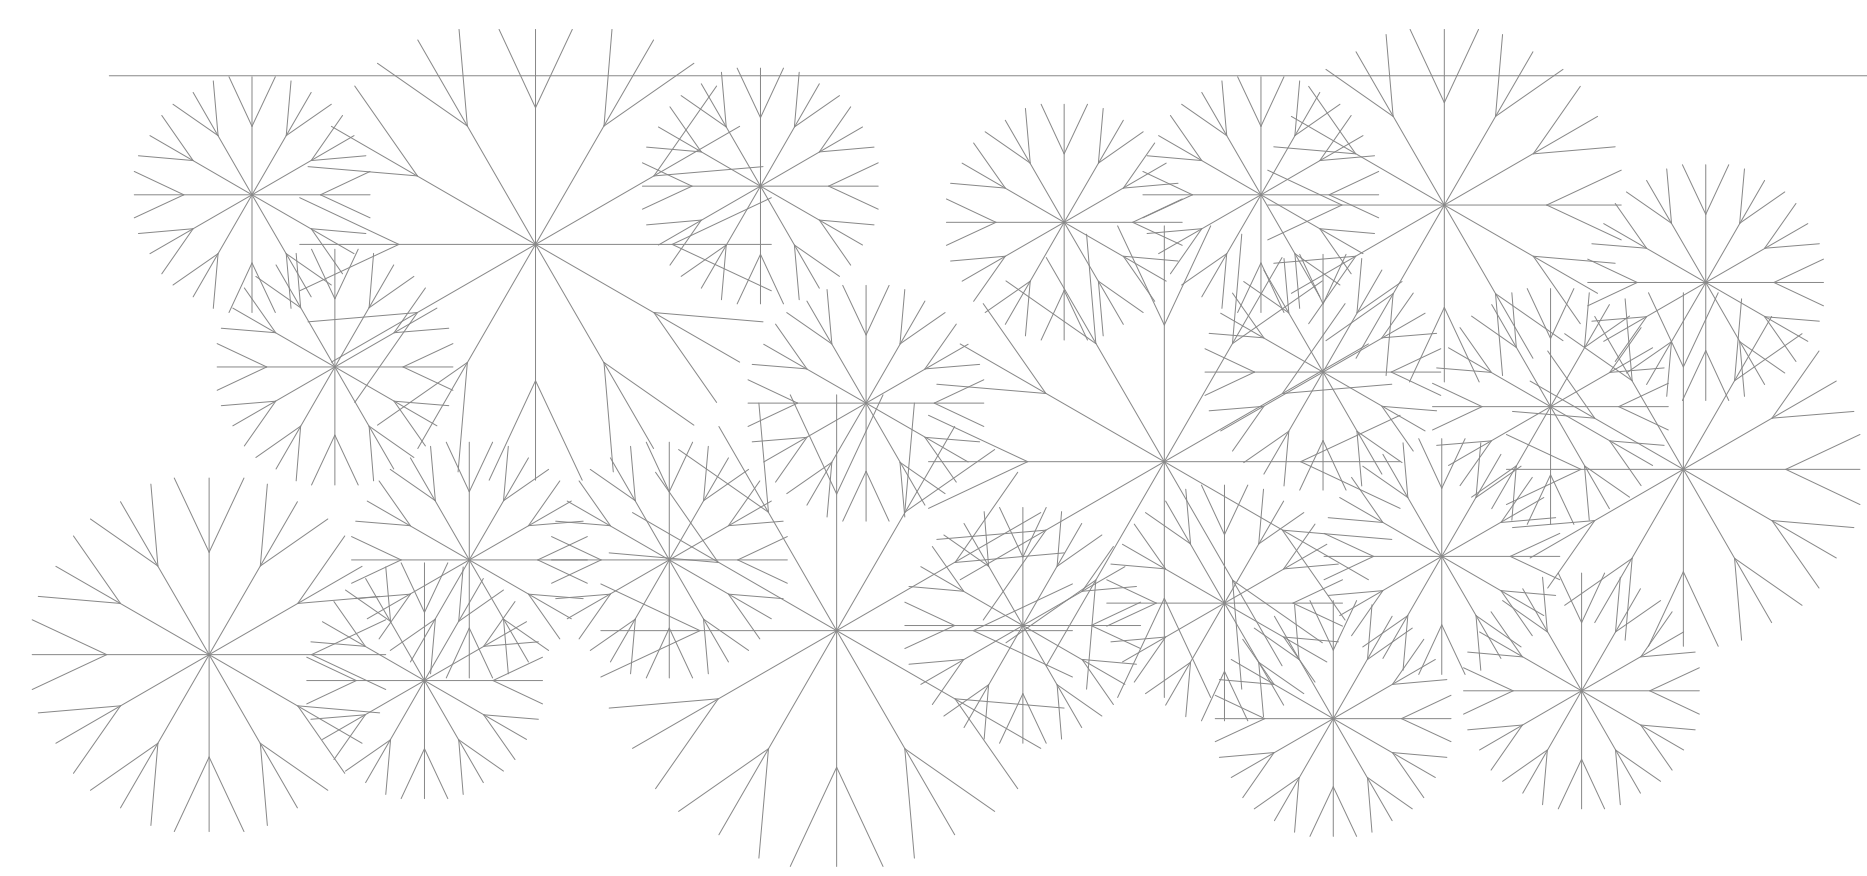

1 Electrical Demolition Plan
 1/8" = 1'-0" Refer to Architectural Drawings for All Dimensions



SPINDLETOP SILSBEE
 Spindletop MHMR
 222 Durbin Dr.
 Silsbee, TX 77666

ISSUED FOR SCHEMATIC DESIGN	<input type="checkbox"/>
DATE:	
DESIGN DEVELOPMENT	<input type="checkbox"/>
DATE:	
BIDS & CONSTRUCTION	<input checked="" type="checkbox"/>
DATE:	02/28/2022
REVISION:	
DATE:	
REVISION:	
DATE:	
REVISION:	
DATE:	

DRAWINGS SHEET TITLE
ELECTRICAL DEMOLITION PLAN

SHEET NUMBER
E200
 21061
 PROJECT NUMBER

1304 BERTRAND DRIVE SUITE F7
 LAFAYETTE, LOUISIANA 70506
 (337) 234-7474 * FAX (337) 234-7774
 Mechanical Contact: Dustin Duval, P.E.
 dustin@meconsulting.com
 Electrical Contact: David Carroll, P.E.
 david@meconsulting.com
 PROJECT No.: 21167.00

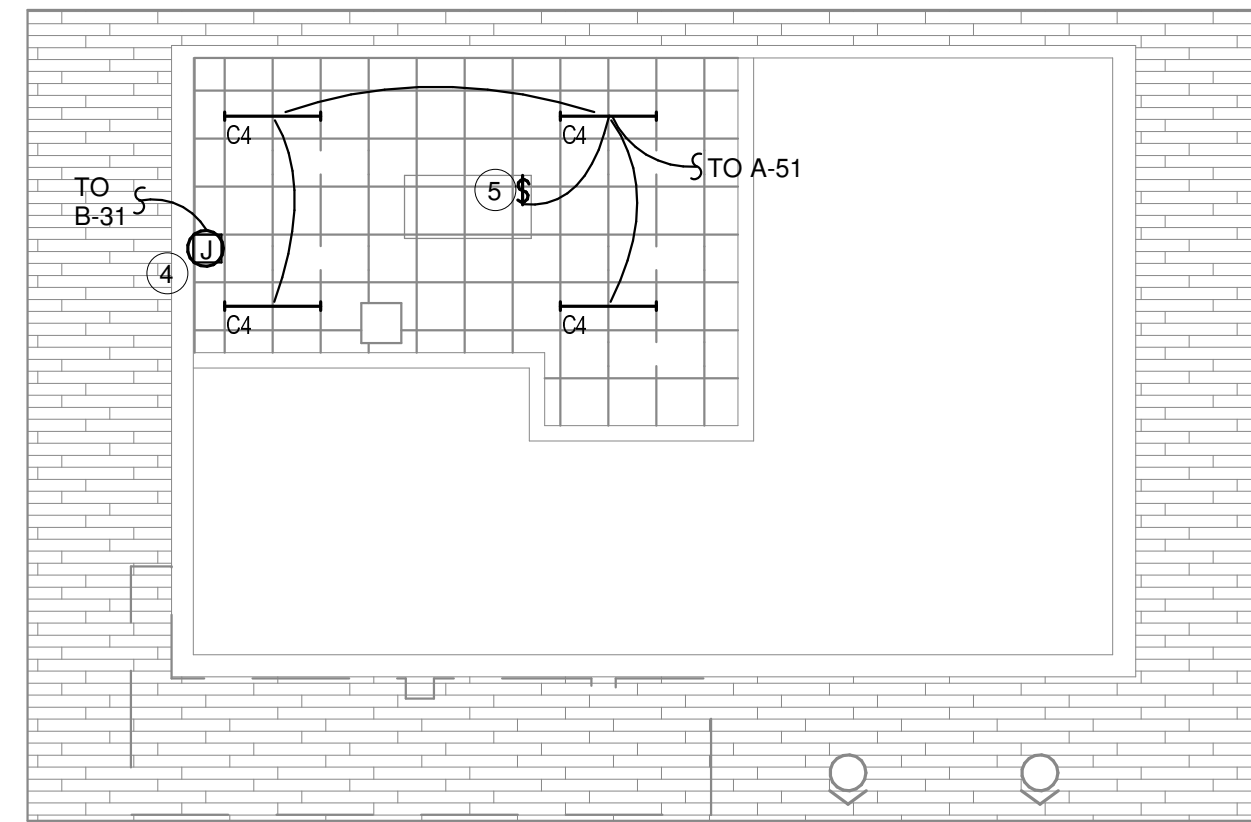
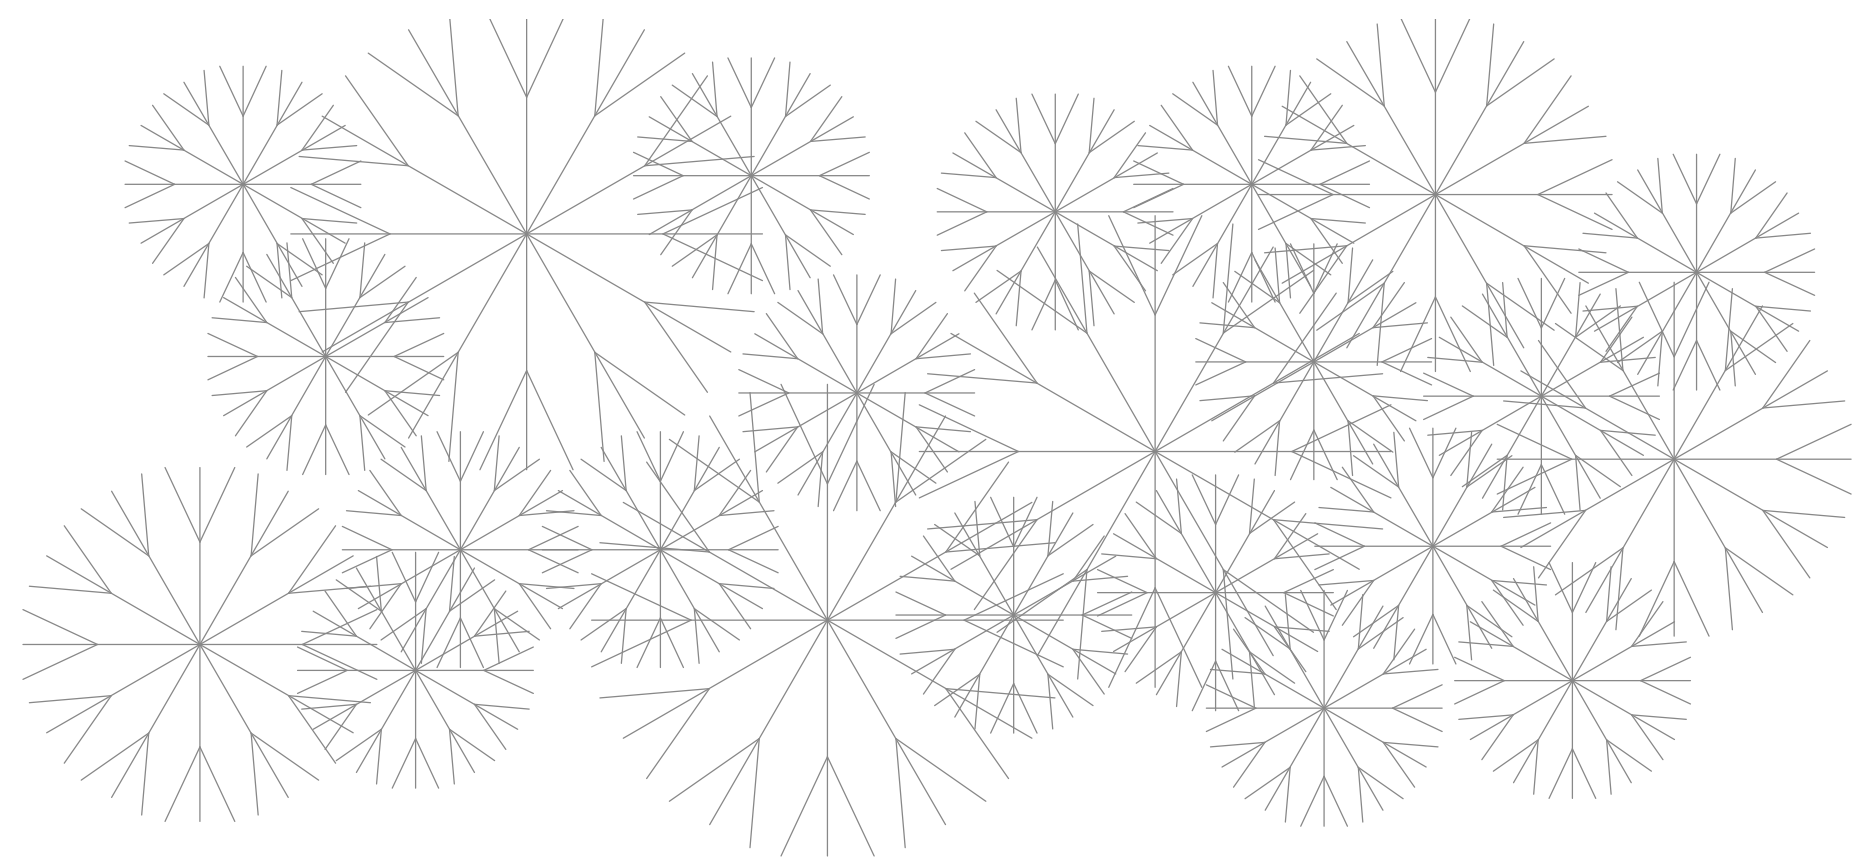


② Lighting Plan - Mezzanine
1/8" = 1'-0" Refer to Architectural Drawings for All Dimensions



① Lighting Plan
1/8" = 1'-0" Refer to Architectural Drawings for All Dimensions

LIGHTING NOTES	
1	THIS SPACE TO BE CONTROLLED BY CEILING MOUNTED OCCUPANCY SENSOR. PLACEMENT, QUANTITY AND TYPE TO BE DETERMINED BY MANUFACTURER. REFER TO ELECTRICAL SPECIFICATION 26 09 23.
2	THIS SPACE IS CLASSIFIED AS A PATIENT CARE AREA PER THE NEC. BRANCH CIRCUITS SHALL BE INSTALLED PER NEC 517.13 ALL BRANCH CIRCUITS IN THIS SPACE SHALL BE INSTALLED IN EMT, RIGID METAL OR IMC WITH AN ADDITIONAL GROUND. THE CONDUIT SHALL ITSELF SERVE AS AN EQUIPMENT GROUNDING RETURN PATH.
3	CONTRACTOR TO VERIFY QUANTITY AND LOCATION AND PROVIDE CONDUIT STUBS FROM SIGN TRANSFORMER TO EACH LETTER FOR SIGN. LOCATE SIGN TRANSFORMER IN MEZZANINE. COORDINATE WITH SIGN VENDOR.
4	APPROXIMATE LOCATION OF SIGN TRANSFORMER. PROVIDE CONDUIT TO EXTERIOR SIGN. COORDINATE WITH SIGN VENDOR.
5	LIGHT SWITCH TO BE MOUNTED ON GUARDRAIL.
6	PENDANT FIXTURE CLUSTER SUSPENSION LENGTHS SHALL BE VERIFIED WITH ARCHITECT.

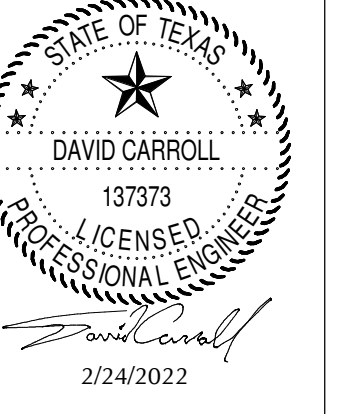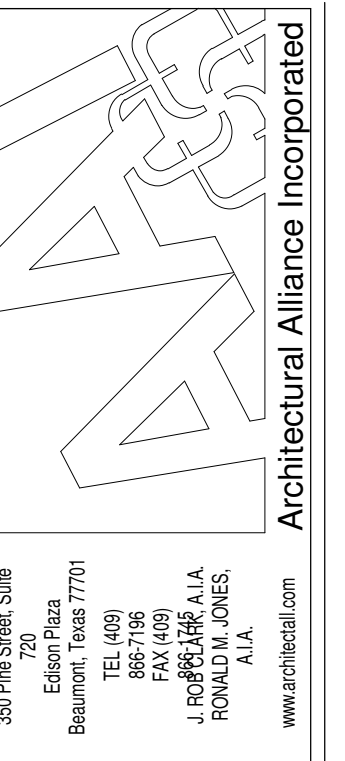



SPINDLETOP SILSBEE
Spindletop MHMR
222 Durbin Dr.
Silsbee, TX 77656

ISSUED FOR SCHEMATIC DESIGN	<input type="checkbox"/>
DATE:	
DESIGN DEVELOPMENT	<input type="checkbox"/>
DATE:	
BIDS & CONSTRUCTION	<input checked="" type="checkbox"/>
DATE:	02/28/2022
REVISION:	
DATE:	
REVISION:	
DATE:	
REVISION:	
DATE:	


DRAWINGS SHEET TITLE
LIGHTING PLAN

SHEET NUMBER
E300
21061
PROJECT NUMBER

1304 BERTRAND DRIVE SUITE F7
LAFAYETTE, LOUISIANA 70506
(337) 234-7474 * FAX (337) 234-7774
Mechanical Contact: Dustin Duval, P.E.
dustin@meconsulting.com
Electrical Contact: David Carroll, P.E.
david@meconsulting.com
PROJECT No.: 21167.00

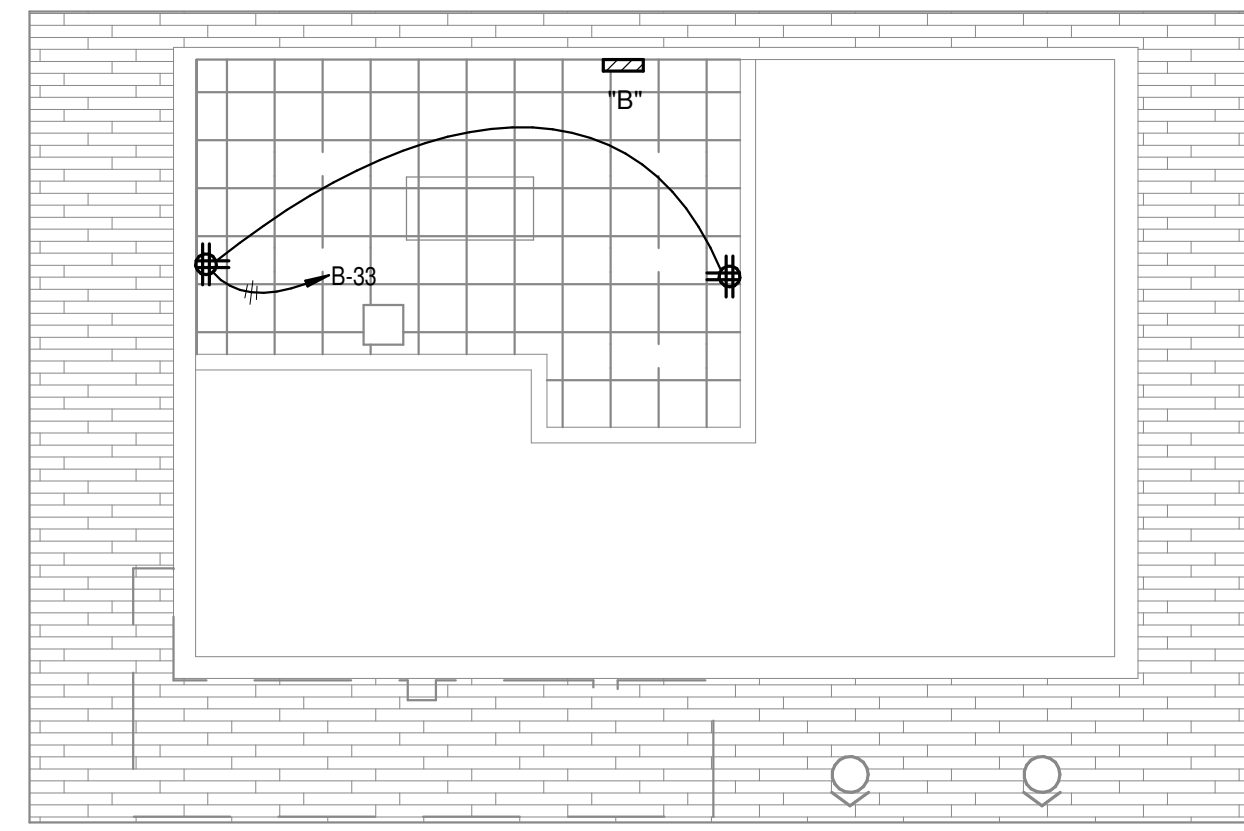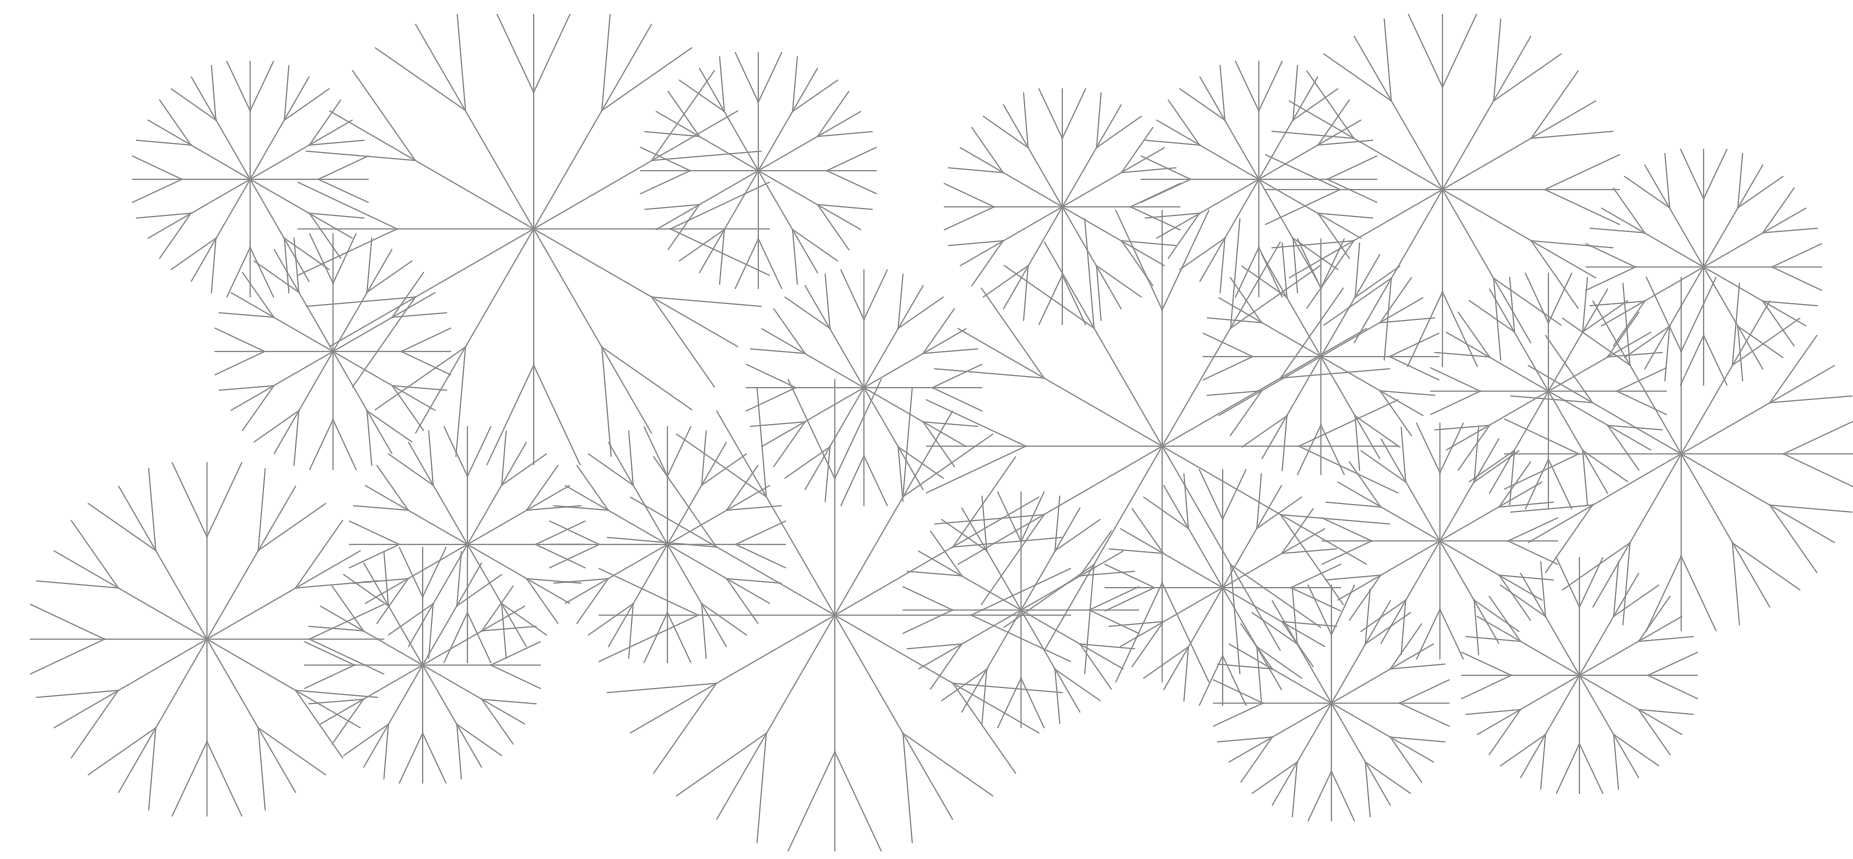



② Power Plan - Mezzanine
1/8" = 1'-0" Refer to Architectural Drawings for All Dimensions

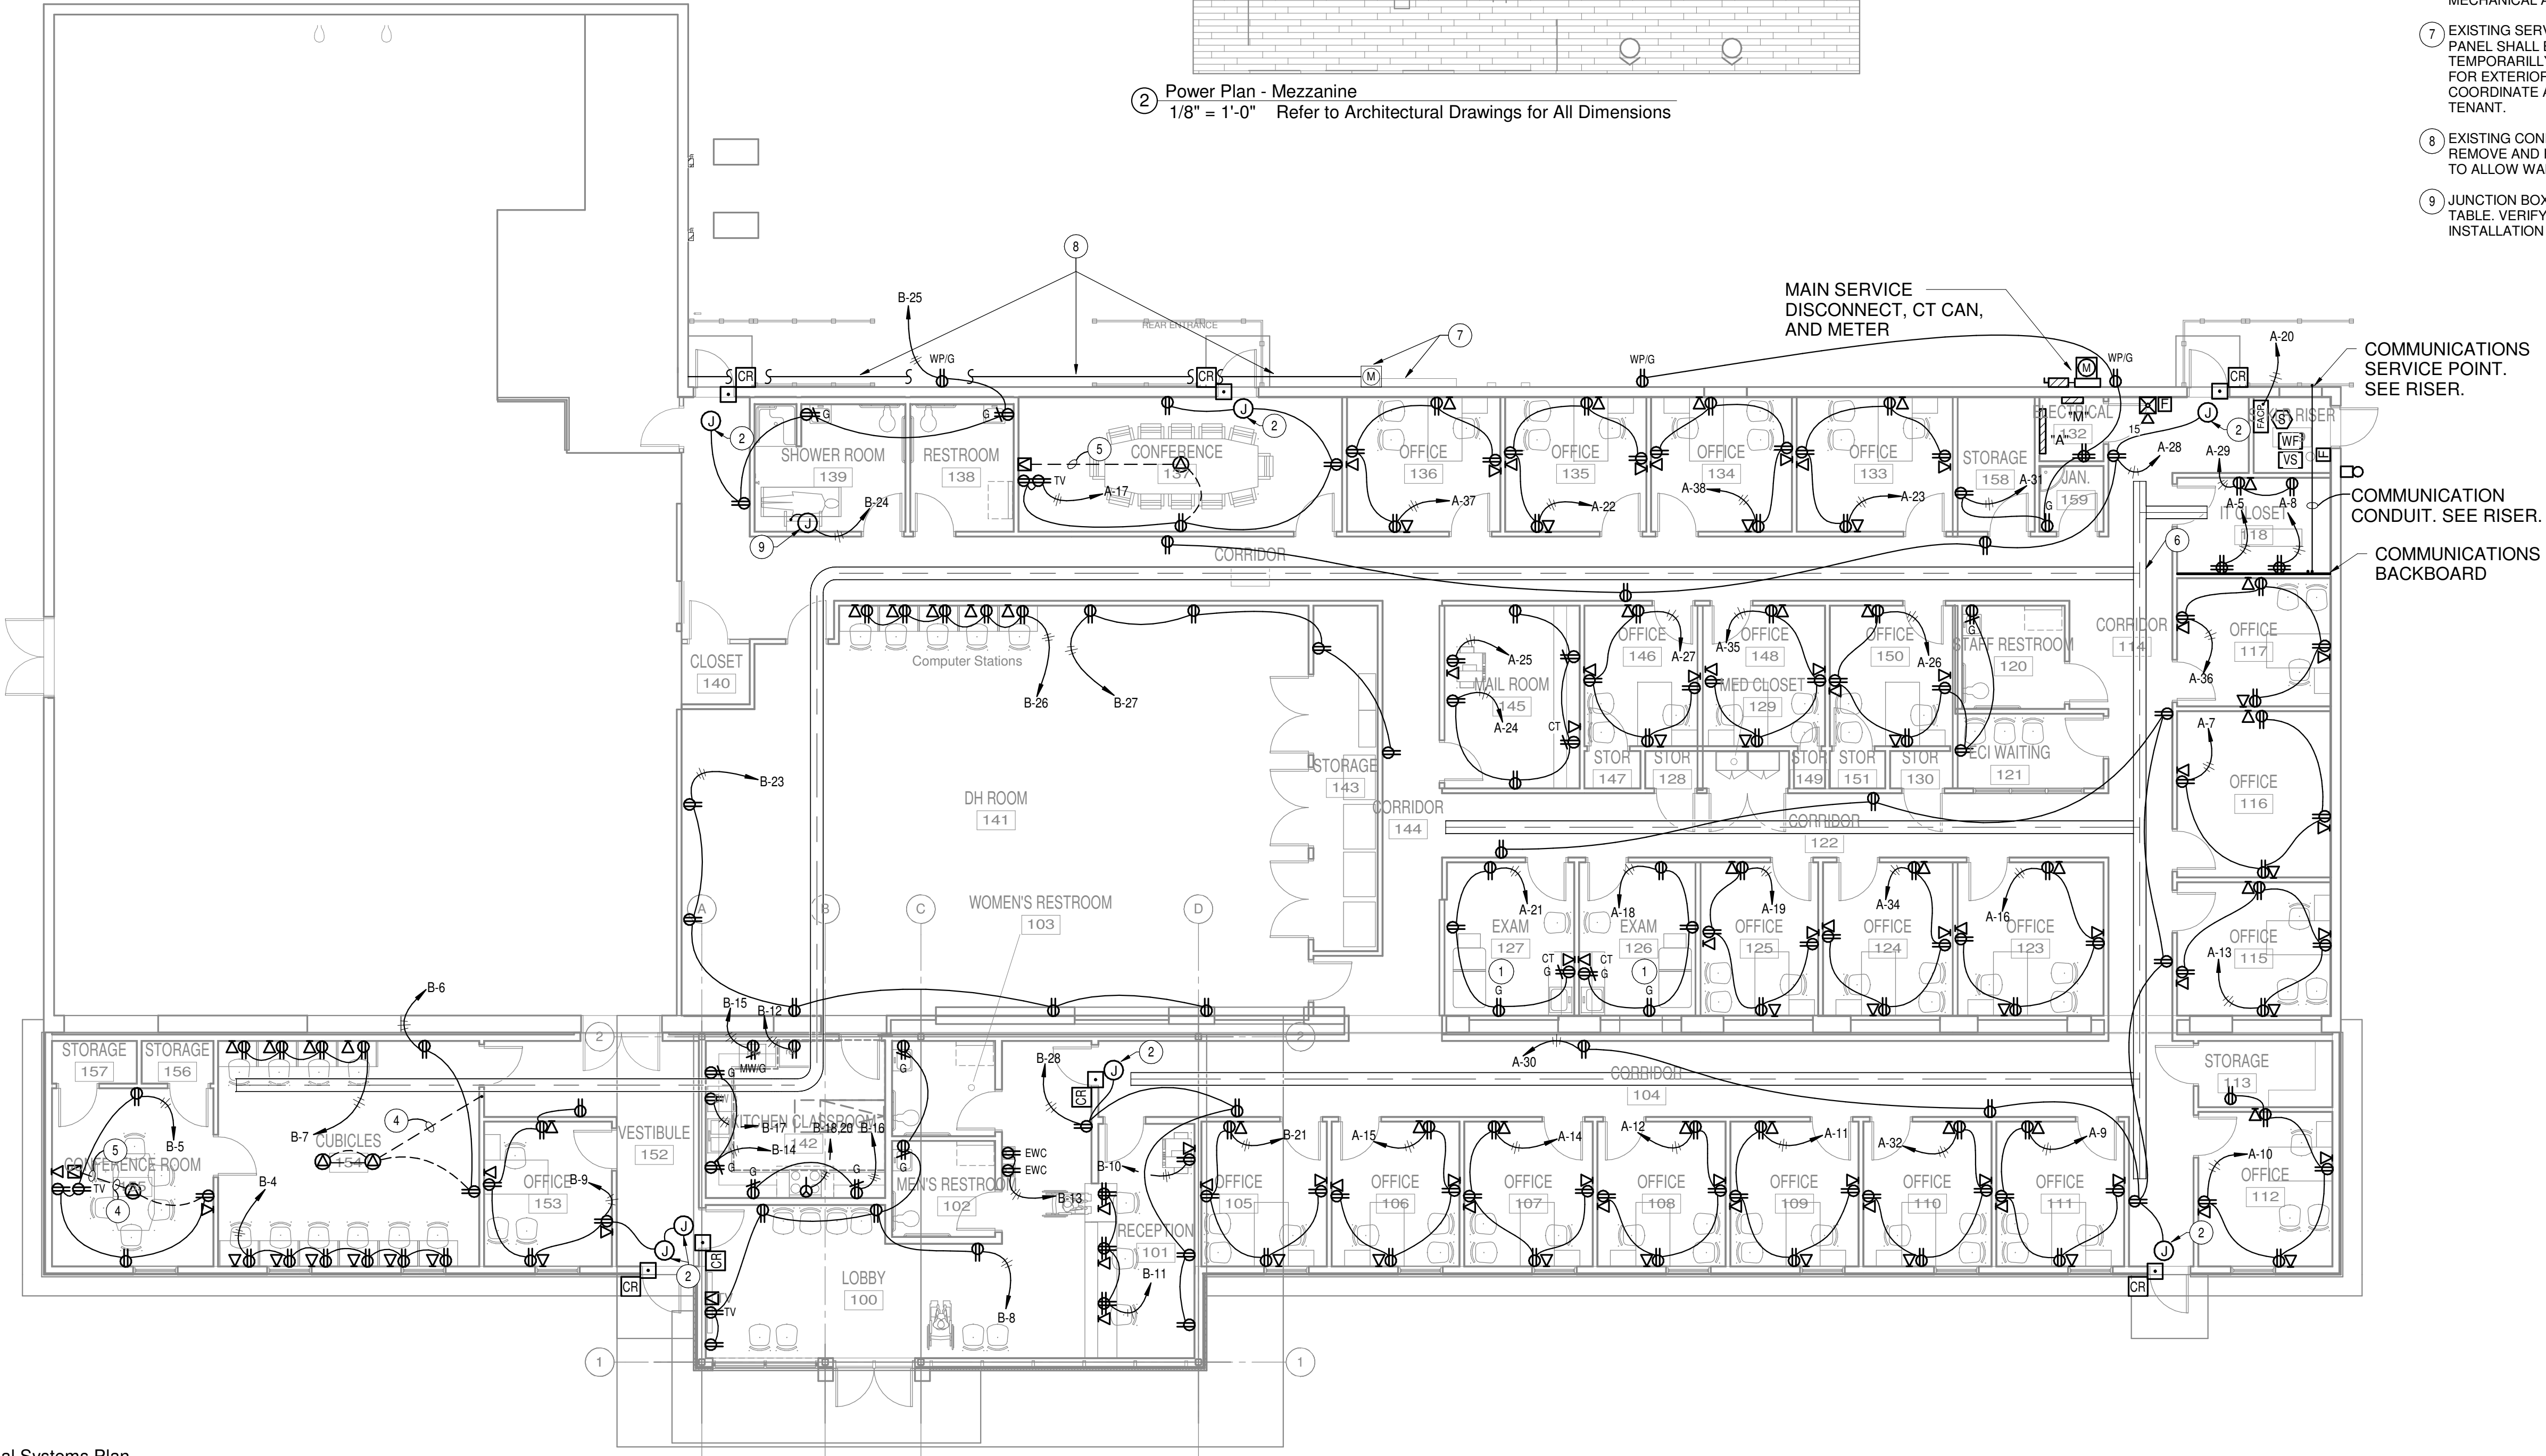

① Power & Special Systems Plan
1/8" = 1'-0" Refer to Architectural Drawings for All Dimensions

GENERAL ELECTRICAL NOTES:
1. VERIFY FINAL LOCATIONS OF FLOORBOXES WITH ARCHITECT.

- ELECTRICAL NOTES:**
- THIS SPACE IS CLASSIFIED AS A PATIENT CARE AREA PER THE NEC. BRANCH CIRCUITS SHALL BE INSTALLED PER NEC 517.13 ALL BRANCH CIRCUITS IN THIS SPACE SHALL BE INSTALLED IN EMT, RIGID METAL OR IMC WITH AN ADDITIONAL GROUND. THE CONDUIT SHALL ITSELF SERVE AS AN EQUIPMENT GROUNDING RETURN PATH. PROVIDE HOSPITAL GRADE RECEPTACLES IN THIS SPACE.
 - POWER SUPPLY FOR DOOR HARDWARE TO BE LOCATED IN CEILING IN THIS AREA. VERIFY FINAL LOCATION IN THE FIELD.
 - 1/2" CONDUIT WITH #12 TO NEAREST AVAILABLE 120V POWER CIRCUIT.
 - (2) 1" CONDUITS WITH PULLSTRING TO ACCESSIBLE CEILING.
 - 1 1/4" CONDUIT WITH PULLSTRING TO TV BOX.
 - 12" W X 6" DEEP WIRE MESH CABLE TRAY ABOVE CEILING. REFER TO SPECIFICATIONS. PROPOSED CABLE TRAY ROUTING SHOWN. COORDINATE ROUTING OF CABLE TRAY IN FIELD TO AVOID MECHANICAL AND ELECTRICAL EQUIPMENT.
 - EXISTING SERVICE WIREWAY AND METER SERVING THE CHURCH PANEL SHALL BE MAINTAINED BUT WILL BE REQUIRED TO BE TEMPORARILY REMOVED AND SUPPORTED BY UNISTRUT TRACK FOR EXTERIOR WALL MATERIAL REPLACEMENT TO OCCUR. COORDINATE ANY NECESSARY OUTAGES WITH OWNER AND TENANT.
 - EXISTING CONDUIT SERVING CHURCH PANEL SHALL REMAIN. REMOVE AND REPLACE EXISTING CONDUIT SUPPORTS IN PHASES TO ALLOW WALL MATERIAL REPLACEMENT TO OCCUR.
 - JUNCTION BOX FOR HARDWIRE CONNECTION TO ADULT CHANGING TABLE. VERIFY EXACT LOCATION OF BOX PER MANUFACTURER'S INSTALLATION INSTRUCTIONS.

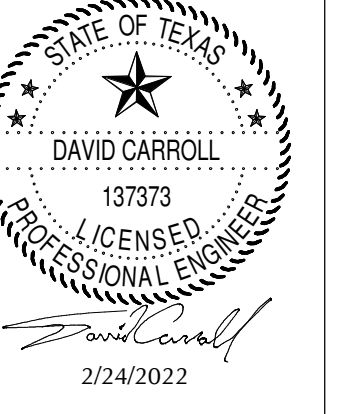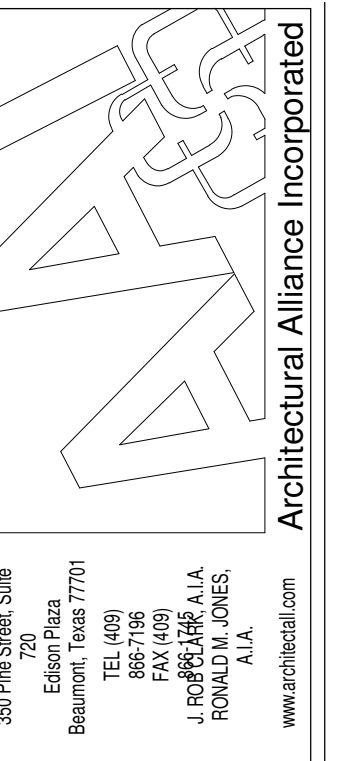

ISSUED FOR SCHEMATIC DESIGN
 DATE: _____
 DESIGN DEVELOPMENT
 DATE: _____
 BIDS & CONSTRUCTION
 DATE: 02/28/2022
 REVISION: _____
 DATE: _____
 REVISION: _____
 DATE: _____
 REVISION: _____
 DATE: _____



DRAWINGS SHEET TITLE
POWER & SPECIAL SYSTEMS PLAN

SHEET NUMBER
E400
 21061
 PROJECT NUMBER


1304 BERTRAND DRIVE SUITE F7
 LAFAYETTE, LOUISIANA 70506
 (337) 234-7474 * FAX (337) 234-7774
 Mechanical Contact: Dustin Duval, P.E.
 dustin@meconsulting.com
 Electrical Contact: David Carroll, P.E.
 david@meconsulting.com
 PROJECT No.: 21167.00

ELECTRICAL NOTES

- 1 CIRCUIT AND SWITCH WITH LIGHTS IN THIS SPACE.
- 2 3/4" CONDUIT WITH CABLE PER MANUFACTURER
- 3 CIRCUIT WITH LIGHTS IN THIS SPACE. COORDINATE SWITCHING WITH MECHANICAL.

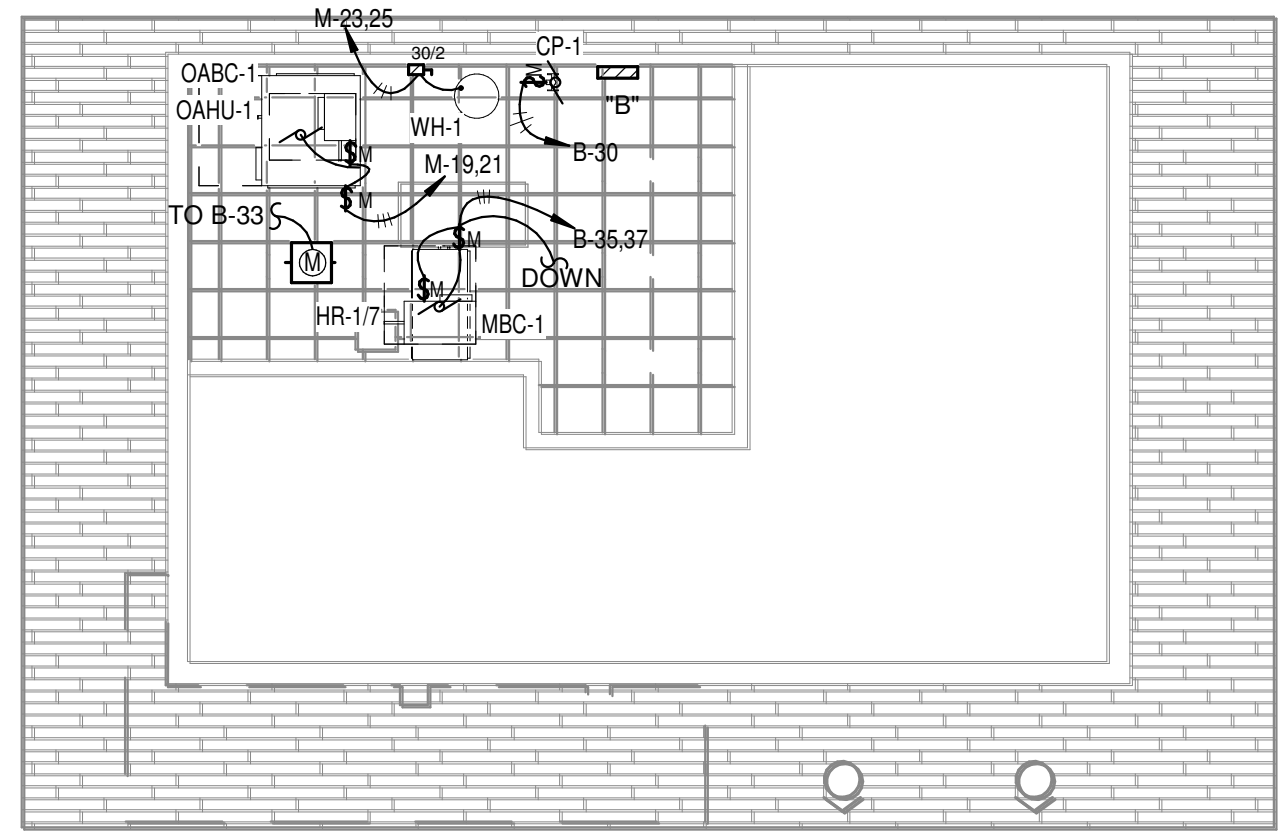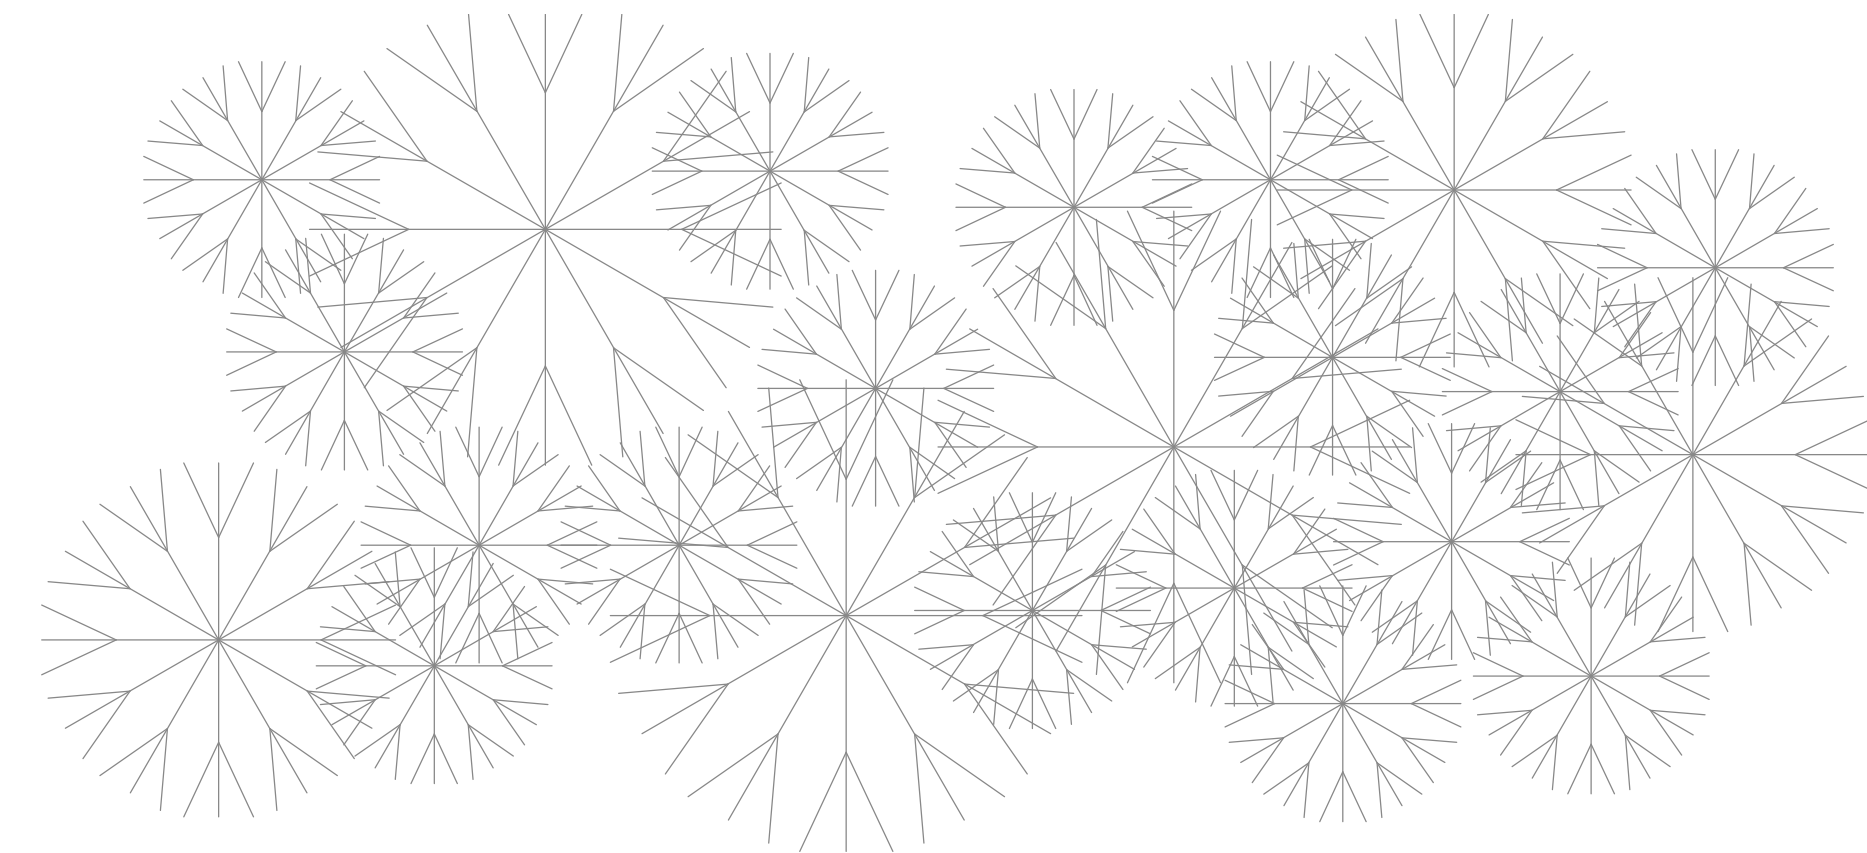

② Mechanical Power Plan - Mezzanine
 1/8" = 1'-0" Refer to Architectural Drawings for All Dimensions

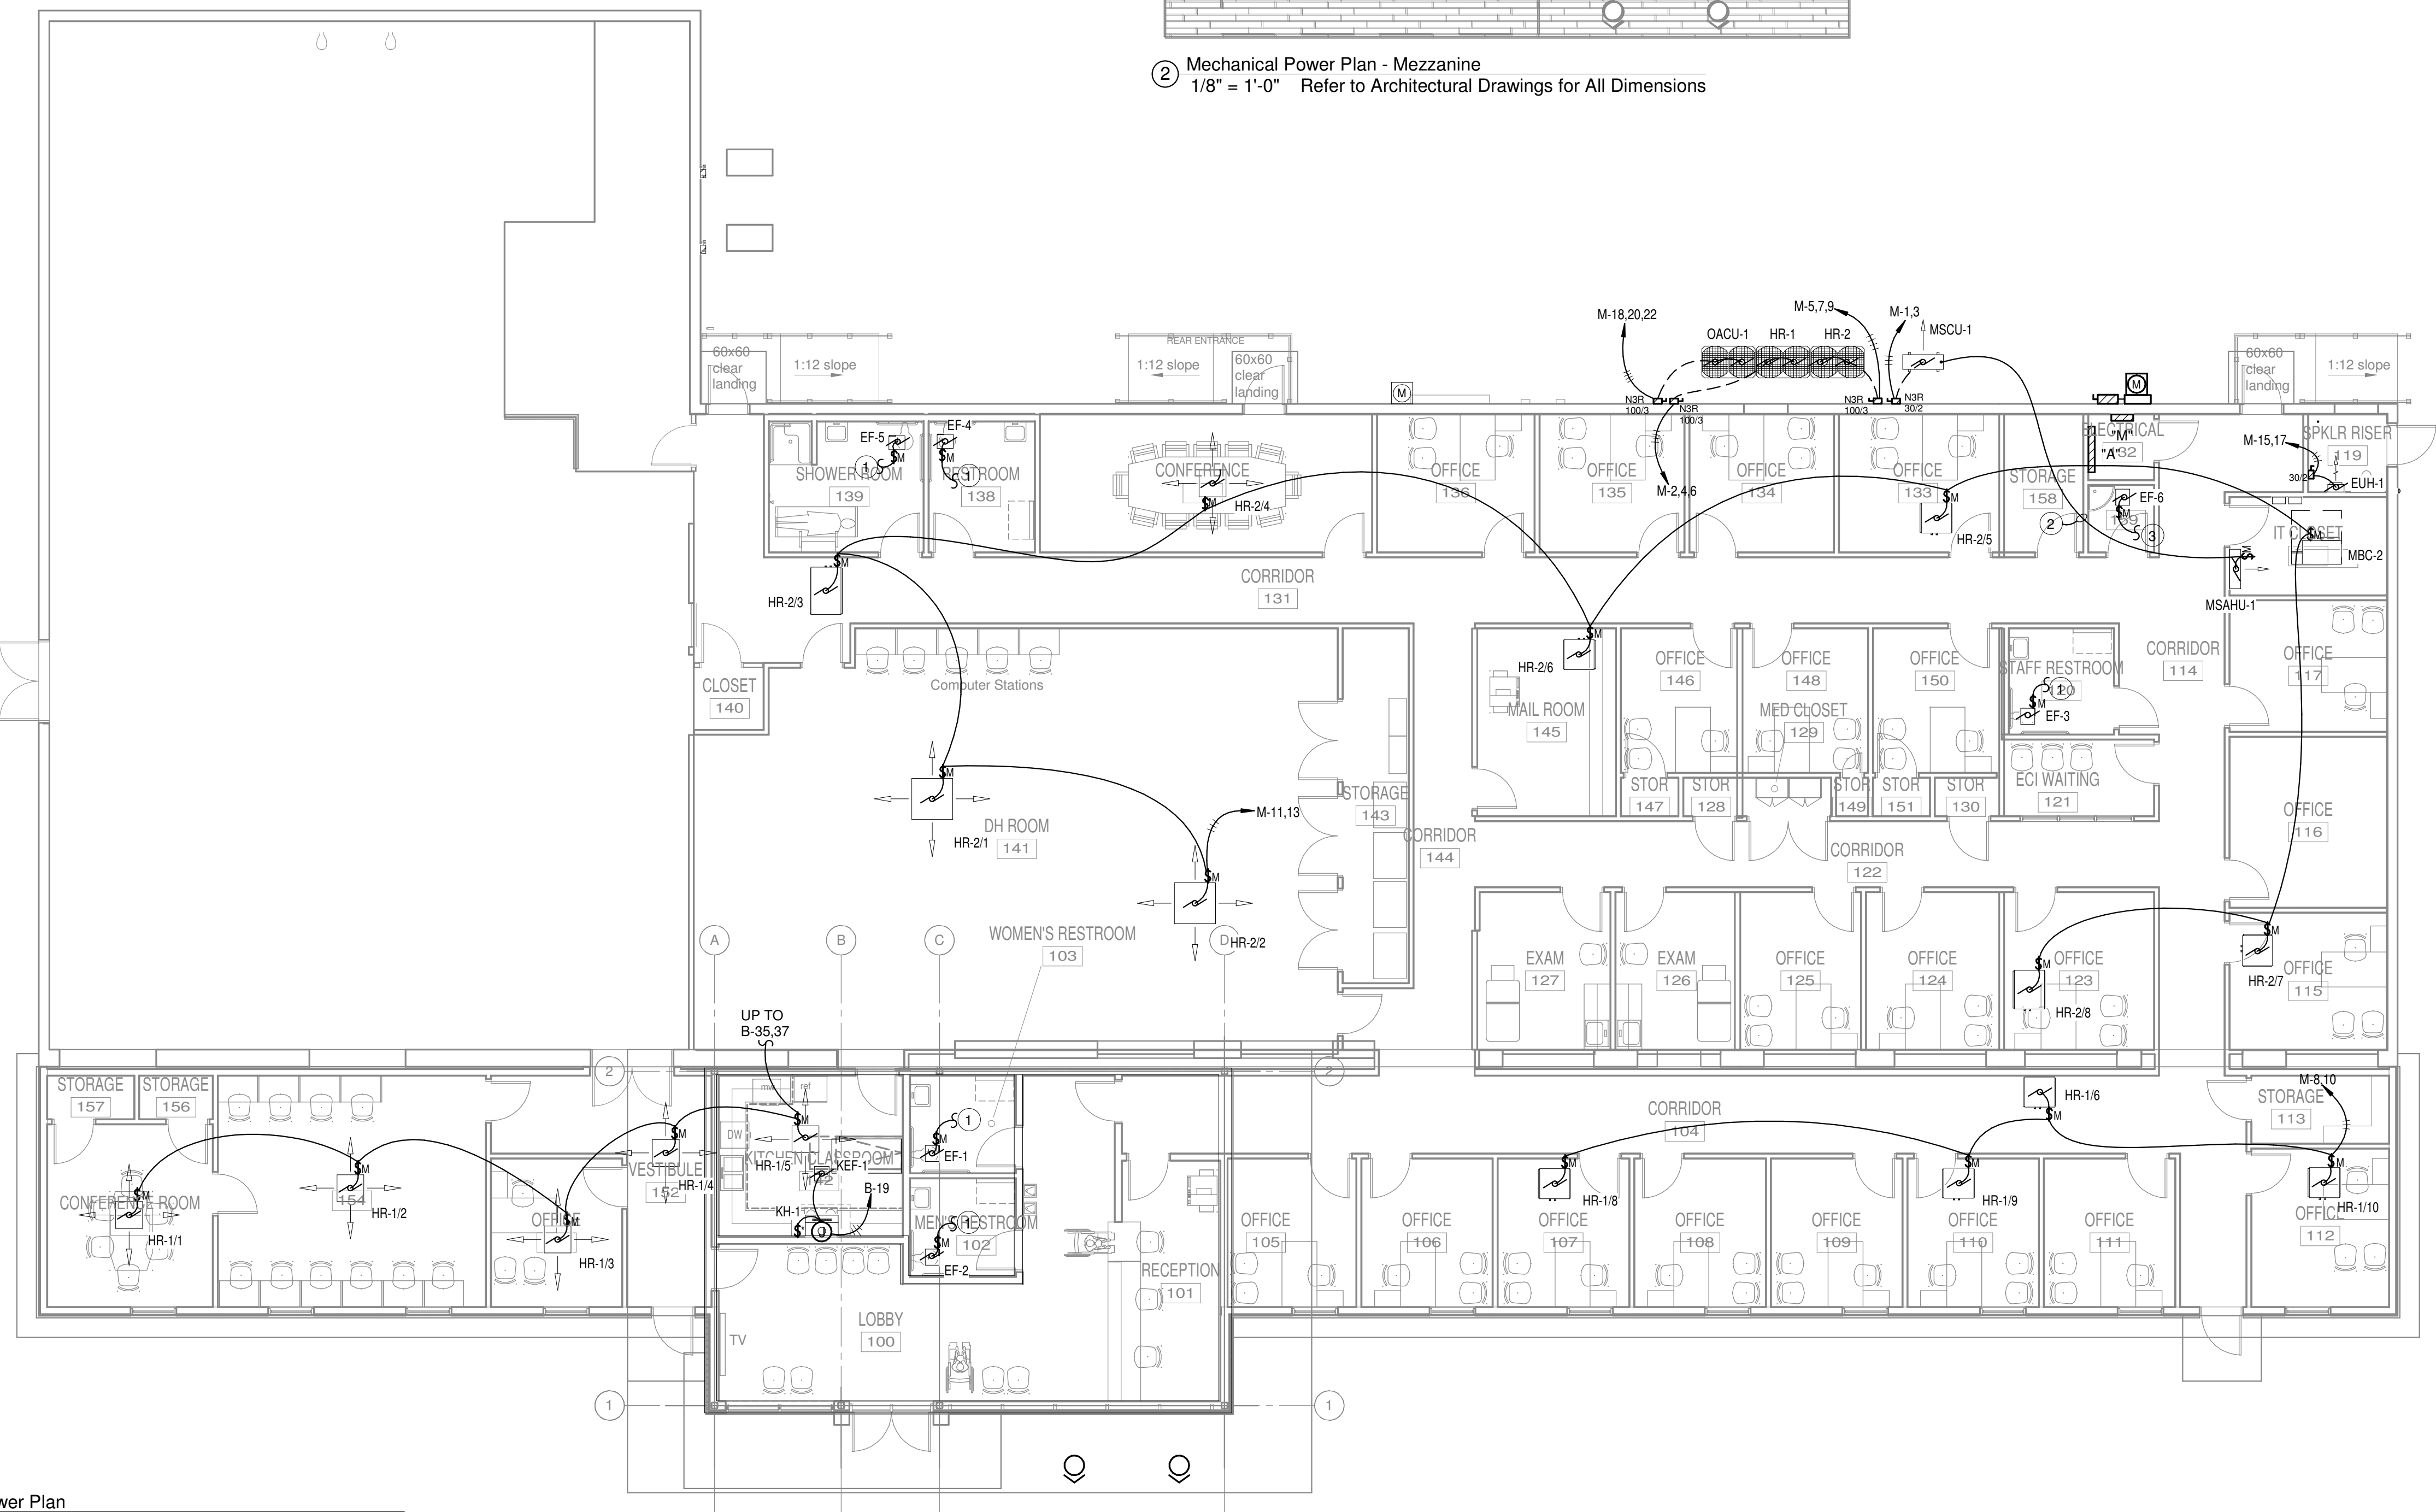

① Mechanical Power Plan
 1/8" = 1'-0" Refer to Architectural Drawings for All Dimensions

SPINDLETOP SILSBEE
 Spindletop MHMR
 222 Durbin Dr.
 Silsbee, TX 77666

ISSUED FOR SCHEMATIC DESIGN
 DATE: _____
 DESIGN DEVELOPMENT
 DATE: _____
 BIDS & CONSTRUCTION
 DATE: 02/28/2022
 REVISION: _____
 DATE: _____
 REVISION: _____
 DATE: _____
 REVISION: _____
 DATE: _____



DRAWINGS SHEET TITLE
MECHANICAL POWER PLAN

1304 BERTRAND DRIVE SUITE F7
 LAFAYETTE, LOUISIANA 70506
 (337) 234-7474 * FAX (337) 234-7774
 Mechanical Contact: Dustin Duval, P.E.
 dustin@meconsulting.com
 Electrical Contact: David Carroll, P.E.
 david@meconsulting.com
 PROJECT No.: 21167.00

SHEET NUMBER
E500
 21061
 PROJECT NUMBER

TYPE MARK	DESCRIPTION	LAMP		VOLTS	MANUFACTURER	MODEL	COMMENTS
		No.	TYPE				
A2	2'x4' LED LAY-IN TROFFER	-	LED	120	METALUX	24CZ2-40HE-S-UNV-L835-CD1-U	
A2E	2'x4' LED LAY-IN TROFFER W/ BATTERY BACKUP	-	LED	120	METALUX	24CZ2-40HE-S-UNV-EL7W-L835-CD1-U	
A3	2'x4' LED LAY-IN TROFFER	-	LED	120	METALUX	24CZ2-50HE-S-UNV-L835-CD1-U	
A3E	2'x4' LED LAY-IN TROFFER W/ BATTERY BACKUP	-	LED	120	METALUX	24CZ2-50HE-S-UNV-EL7W-L835-CD1-U	
A4	2'x4' LED LAY-IN TROFFER	-	LED	120	METALUX	24CZ2-60HE-S-UNV-L835-CD1-U	
A5	2'x4' LED LAY-IN TROFFER	-	LED	120	METALUX	24CZ2-75HE-S-UNV-L835-CD1-U	
A22	2'x2' LED LAY-IN TROFFER	-	LED	120	METALUX	22CZ2-34HE-S-UNV-L835-CD1-U	
C2	2' LED STRIP LIGHT	-	LED	120	METALUX	25NLED-LD5-26SL-LW-UNV-L835-CD1-U	
C4	4' LED STRIP LIGHT	-	LED	120	METALUX	45NLED-LD5-46SL-LW-UNV-L835-CD1-U	
D1	LED DOWN LIGHT	-	LED	120	HALO COMMERCIAL	HC410D010-HM412840-41MDH-FINISH	FLANGE FINISH TO BE SELECTED BY ARCHITECT
D1E	LED DOWN LIGHT W/ BATTERY BACKUP	-	LED	120	HALO COMMERCIAL	HC410D010REM7-HM412840-41MDH-FINISH	FLANGE FINISH TO BE SELECTED BY ARCHITECT
D2	LED DOWN LIGHT	-	LED	120	HALO COMMERCIAL	HC615D010-HM612835-61MDH-FINISH	FLANGE FINISH TO BE SELECTED BY ARCHITECT
D3	LED DOWN LIGHT	-	LED	120	HALO COMMERCIAL	HC630D010-HM612835-61MDH-FINISH	FLANGE FINISH TO BE SELECTED BY ARCHITECT
D3E	LED DOWN LIGHT W/ BATTERY BACKUP	-	LED	120	HALO COMMERCIAL	HC630D010REM7-HM612835-61MDH-FINISH	FLANGE FINISH TO BE SELECTED BY ARCHITECT
DS	LED SHOWER DOWN LIGHT	-	LED	120	HALO COMMERCIAL	HC410D010REM7-HM412835-41MDH-FINISH	FLANGE FINISH TO BE SELECTED BY ARCHITECT
F	LED DECORATIVE PENDANT	-	LED	120	BROWNLEE LIGHTING	2890-24-FINISH-05-FINISH-GLW-35K	FIXTURE FINISH AND COORD COLOR TO BE SELECTED BY ARCHITECT
GE	EXTERIOR LED LIGHT W/ BATTERY BACKUP	-	LED	120	FAIL-SAFE	HVSL4-4-LD4-1-STD-40K-UNV-O-EL7W-FINISH	FINISH TO BE SELECTED BY ARCHITECT
P2	LED POLE LIGHT-SINGLE-HEAD	-	LED	120	MCGRAW-EDISON	GLEON-SA3C-740-U-T4FT-FINISH	FINISH TO BE SELECTED BY ARCHITECT; POLE TO MEET MINIMUM WIND LOAD CRITERIA
PL	25' ROUND, STRAIGHT, STEEL LIGHT POLE	-	-	-	HAPCO	RSS25B5-4-FINISH	FINISH TO BE SELECTED BY ARCHITECT; POLE TO MEET MINIMUM WIND LOAD CRITERIA
X1	SINGLE FACE EXIT LIGHT	-	LED	120	SURE-LITES	CX-7-1-R	

LIGHTING FIXTURE SCHEDULE NOTES:
 ① MINIMUM WIND LOAD CRITERIA:
 1.) 130MPH - RISK CATEGORY II

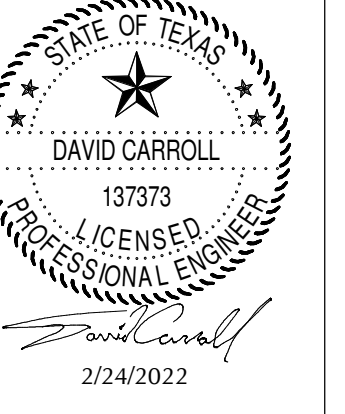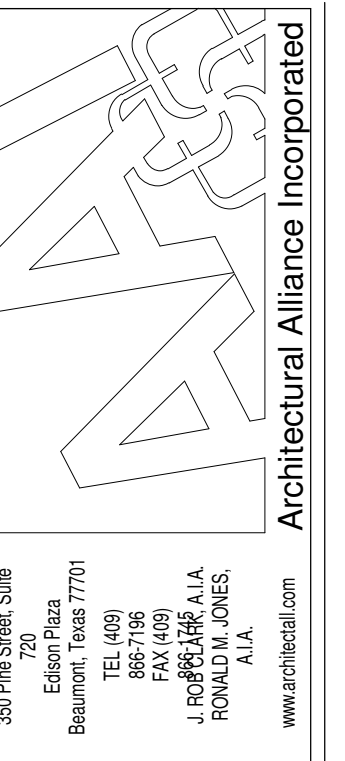

① "PANEL NAME" FED FROM "PANEL NAME & CIRCUIT #"

② "EQUIPMENT NAME" FED FROM "PANEL NAME & CIRCUIT #"

STAINLESS STEEL SCREWS (TYP.)

1 PANEL & EQUIPMENT SIGNAGE DETAIL
NO SCALE

MAINTAIN PROPER CLEARANCE PER N.E.C.

SEALTITE (POWER)

SEALTITE (CONTROLS)

GRADE

NEMA-3R FUSED DISCONNECT SWITCH OR PANEL (SEE PLANS)

3/4" CONTROL CONDUIT TO AIR HANDLING UNIT

2 CONDENSING UNIT DETAIL
NO SCALE

ITEM	DESCRIPTION
①	GROUND BAR ERICO EG8A 14412 RRT OR EQUIVALENT
②	WALL MTG BRACKET
③	INSULATOR
④	5/8-11x1" HHCS
⑤	WASHER

3 TYPICAL COMMUNICATIONS GROUNDING BUSBAR DETAIL
NO SCALE

HARGER: GAW910 OR EQUAL - TEST WELL

NO. 305 - GROUND ROD CLAMP

COPPER LIGHTNING PROTECTION OR GROUNDING CONDUCTOR

COPPER CLAD GROUND ROD

4 GROUND ACCESS WELL DETAIL
NO SCALE

POLE MOUNTED FIXTURE (RE: LIGHTING SCHEDULE)

POLE (RE: LIGHTING SCHEDULE)

ANCHOR BOLTS PER MANUF. SPECS

PAINTED SMOOTH FINISH ABOVE GRADE (COLOR BY ARCH.)

#6 CU GND

CONDUIT

8" GROUND ROD, DRIVE IN UNDISTURBED EARTH

RE-INFORCED CONCRETE (3000 PSI)

6" CHAMFER

6" FINISH GRADE

6'-0" 6 #4 RE-BARS WITH TIES

24"

7 POLE FOUNDATION DETAIL
NO SCALE

RED

BLACK

WHITE

YELLOW

GRAY

PURPLE

CONTROLLER

0-10 LOW VOLTAGE CABLING

0-10V DIMMABLE POWER SUPPLY

LED LIGHTING

5 0-10 VOLT DIMMER DETAIL
NO SCALE

NOTES:

1.) ALL GROUNDS AND BONDING CONDUCTORS SHALL BE LABELED WITHIN 4" OF TERMINATION OF GROUNDING BAR.

2.) GROUNDS SHALL NOT SHARE THE SAME BUSBAR TERMINATION OR LUG.

3.) ALL MATERIALS, DEVICES, ETC. SHALL BE U.L. LISTED.

4.) PROVIDE A LABEL ON WALL ABOVE GROUNDING BUSBAR INDICATING "DO NOT DISCONNECT".

ITEM	DESCRIPTION
①	GROUND BAR ERICO EG8A 14412 RRT OR EQUIVALENT
②	WALL MTG BRACKET
③	INSULATOR
④	5/8-11x1" HHCS
⑤	WASHER

6 BUILDING ELECTRICAL SYSTEM GROUNDING BUSBAR DETAIL
NO SCALE

GROUNDING ELECTRODE CONDUCTOR, SIZED AS PER N.E.C. TABLE 250.66

BONDING JUMPER

GROUND ACCESS WELL WITH COVER (MOUNTED FLUSH WITH FINISHED GRADE) TYPE HARGER GAW910 OR EQUAL.

3/4"X10" MIN.

6'-0" MIN. APART

6'-0" MIN. APART

GROUND ROD

BOLTED, RIVETED, OR WELDED

SERVICE PANEL

BUILDING STEEL

BONDING JUMPER

#4CU MIN.

CONCRETE ENCASED ELECTRODE 20' OF #4 BARE Cu. CONDUCTOR OR 1/2" OR LARGER ELECTRICALLY CONDUCTIVE COATED STEEL REINFORCING BARS OR RODS

* WHEN BUILDING STEEL IS NOT AVAILABLE, CONTRACTOR TO UTILIZE ELECTRODES PERMITTED FOR GROUNDING AS PER NEC 250.52

8 GROUNDING ELECTRODE SYSTEM AND BUSBAR DETAIL
NO SCALE

Silsbee, TX 77656

222 Durbin Dr.

SPINDLETOP SILSBBE

Spindletop MHMR

ISSUED FOR SCHEMATIC DESIGN

DESIGN DEVELOPMENT

BIDS & CONSTRUCTION

REVISION: DATE: _____

REVISION: DATE: _____

REVISION: DATE: _____

DRAWINGS SHEET TITLE

ELECTRICAL SCHEDULE & DETAILS

SHEET NUMBER

E600

21061

PROJECT NUMBER

1304 BERTRAND DRIVE SUITE F7
 LAFAYETTE, LOUISIANA 70506
 (337) 234-7474 * FAX (337) 234-7774

Mechanical Contact: Dustin Duval, P.E.
 dustin@meconsulting.com

Electrical Contact: David Carroll, P.E.
 david@meconsulting.com

PROJECT No.: 21167.00

Branch Panel: A

Location: ELECTRICAL 132
Mounting: Surface
Enclosure: Type 1

Volts: 120/208 Wye
Phases: 3
Wires: 4

A.I.C. Rating: 22,000
Mains Type: MLO
Mains Rating: 125 A

General Schedule Notes:

Verify proper working clearances per N.E.C. prior to installation.

Notes	#	Circuit Description	Trip	Poles	Wire	Gnd.	C.	A	B	C	C.	Gnd.	Wire	Poles	Trip	Circuit Description	#	Notes						
①	1	Exterior Lighting	20	1	2	10	10	3/4"	236									2						
	3	Lighting	20	1	2	10	10	3/4"		1396	1381							4						
	5	Comm bkbd 118	20	1	2	12	12	1/2"					180	332	3/4"	10	10	2	1	20	Pole Lights	6	①	
	7	Rec(Off 116)	20	1	2	12	12	1/2"	720	180						1/2"	12	12	2	1	20	Comm bkbd 118	8	
	9	Rec(Off 111)	20	1	2	12	12	1/2"		720	900					1/2"	12	12	2	1	20	Rec(Off 112)	10	
	11	Rec(Off 109)	20	1	2	12	12	1/2"		720	720					1/2"	12	12	2	1	20	Rec(Off 108)	12	
	13	Rec(Off 115/Hall)	20	1	2	12	12	1/2"	720	720						1/2"	12	12	2	1	20	Rec(Off 107)	14	
	15	Rec(Off 106)	20	1	2	12	12	1/2"		720	720					1/2"	12	12	2	1	20	Rec(Off 123)	16	
	17	Rec(Conf. Rm. 137)	20	1	2	12	12	1/2"			1180	720				1/2"	12	12	2	1	20	Rec(Exam 126)	18	
	19	Rec(Exam 125)	20	1	2	12	12	1/2"	720	500						1/2"	12	12	2	1	20	FACP 119	20	
	21	Rec(Exam 127)	20	1	2	12	12	1/2"		720	720					1/2"	12	12	2	1	20	Rec(Off 135)	22	
	23	Rec(Off 133)	20	1	2	12	12	1/2"		720	900					1/2"	12	12	2	1	20	Rec(Mail Rm. 145)	24	
	25	Copier 145	20	1	2	12	12	1/2"	1000	1080						1/2"	12	12	2	1	20	Rec(Off...)	26	
	27	Rec(Off 146)	20	1	2	12	12	1/2"		720	720					1/2"	12	12	2	1	20	Rec(Corridor 131)	28	
	29	Rec(IT 118)	20	1	2	12	12	1/2"			360	1260				1/2"	12	12	2	1	20	Rec(Corridors)	30	
	31	Rec(Elec 132)	20	1	2	12	12	1/2"	900	720						1/2"	12	12	2	1	20	Rec(Off 110)	32	
	33	Hot Box	25	1	2	10	10	3/4"			1900	720				1/2"	12	12	2	1	20	Rec(Off 124)	34	
	35	Rec(Off 148)	20	1	2	12	12	1/2"		720	720					1/2"	12	12	2	1	20	Rec(Off 117)	36	
	37	Rec(Off 136)	20	1	2	12	12	1/2"	720	720						1/2"	12	12	2	1	20	Rec(Off 134)	38	
--	39	Space	--	1	--	--	--	--	--	0						--	--	--	3	60	SPD	40	--③	
--	41	Space	--	1	--	--	--	--	--	--						--	--	--	--	--	--	42	--	
--	43	Space	--	1	--	--	--	--	0							--	--	--	--	--	--	44	--	
--	45	Space	--	1	--	--	--	--	0							--	--	--	--	1	20	Spare	46	--
--	47	Space	--	1	--	--	--	--	--	0						--	--	--	--	1	20	Spare	48	--
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	61																						62	
	63																						64	
	65																						66	
	67																						68	
	69																						70	
	71																						72	
	73																						74	
	75																						76	
	77																						78	
	79																						80	
	81																						82	
	83																						84	

Total Load: 9 kVA 11 kVA 9 kVA
Total Amps: 75 A 94 A 71 A

Load Classification	Connected Load	Demand Factor	Estimated Demand	Panel Totals
HVAC	500 VA	100.00%	500 VA	Total Conn. Load: 29 kVA Total Est. Demand: 22 kVA Total Conn.: 80 A Total Est. Demand: 61 A
Lighting	3330 VA	125.00%	4163 VA	
Receptacles	24960 VA	70.03%	17480 VA	

Panel Schedule Notes: (Notes below do not necessarily appear in panel schedule)

- CIRCUIT VIA 4 POLE LIGHTING CONTACTOR, CONTROL WITH (2) CIRCUIT INTERMATIC OR EQUAL ASTRONOMICAL TIME CLOCK WITH BATTERY BACKUP AND PHOTOCELL, PHOTOCELL "ON" TIME CLOCK "OFF".
- PROVIDE GFCI PROTECTED CIRCUIT BREAKER.
- CONDUIT, WIRE, AND BREAKER SIZE PER MANUFACTURER'S REQUIREMENTS.

Branch Panel: M

Location: ELECTRICAL 132
Mounting: Surface
Enclosure: Type 1

Volts: 120/208 Wye
Phases: 3
Wires: 4

A.I.C. Rating: 22,000
Mains Type: MLO
Mains Rating: 400 A


General Schedule Notes:

Verify proper working clearances per N.E.C. prior to installation.

Notes	#	Circuit Description	Trip	Poles	Wire	Gnd.	C.	A	B	C	C.	Gnd.	Wire	Poles	Trip	Circuit Description	#	Notes						
①	1	MSCU-1.MSAHU-1	20	2	2	12	12	3/4"	1165	4128			1 1/4"	8	4	3	3	70	HR-1	2	①			
--	3	--	--	--	--	--	--	--	--	--	--	--	--	--	--	--	--	--	--	--	4	--		
①	5	HR-2	80	3	3	3	8	1 1/4"		4992	4128					1/2"	12	12	2	2	15	HR-1 UNITS	8	①
--	7	--	--	--	--	--	--	--	4992	439													10	--
--	9	--	--	--	--	--	--	--		4992	439												12	--
①	11	HR-2 UNITS	15	2	2	12	12	1/2"			1000	8924	2"	6	1	4	3	125	Panel "A"	12				
--	13	--	--	--	--	--	--	--	1000	112													14	--
①	15	EUH-1	20	2	2	12	12	1/2"		1500	8532												16	--
--	17	--	--	--	--	--	--	--					1500	4128	1 1/4"	8	4	3	3	70	OACU-1	18	①	
①	19	OAHU-1/OABC-1	20	2	2	12	12	1/2"	312	4128													20	--
--	21	--	--	--	--	--	--	--		312	4128												22	--
①	23	WH-1	30	2	2	10	10	3/4"			2250	0											24	--④
--	25	--	--	--	--	--	--	--	2250	0													26	--
--	27	Panel "B"	125	3	4	1	6	2"		139	0												28	--
--	29	--	--	--	--	--	--	--			704	2746	1"	10	8	3	2	40	Lift Station	30	①			
--	31	--	--	--	--	--	--	--	120	2746													32	--
--	33	Space	--	1	--	--	--	--	--	--	--	--	--	--	--	--	--	--	--	1	--	Space	34	--
--	35	Space	--	1	--	--	--	--	--	--	--	--	--	--	--	--	--	--	--	1	--	Space	36	--
--	37	Space	--	1	--	--	--	--	--	--	--	--	--	--	--	--	--	--	--	1	--	Space	38	--
--	39	Space	--	1	--	--	--	--	--	--	--	--	--	--	--	--	--	--	--	1	--	Space	40	--
--	41	Space	--	1	--	--	--	--	--	--	--	--	--	--	--	--	--	--	--	1	--	Space	42	--


Total Load: 44 kVA 39 kVA 37 kVA
Total Amps: 373 A 330 A 306 A

Load Classification	Connected Load	Demand Factor	Estimated Demand	Panel Totals
HVAC	33375 VA	100.00%	33375 VA	Total Conn. Load: 120 kVA Total Est. Demand: 102 kVA Total Conn.: 334 A Total Est. Demand: 283 A
Heating	3000 VA	100.00%	3000 VA	
Motor	5491 VA	100.00%		

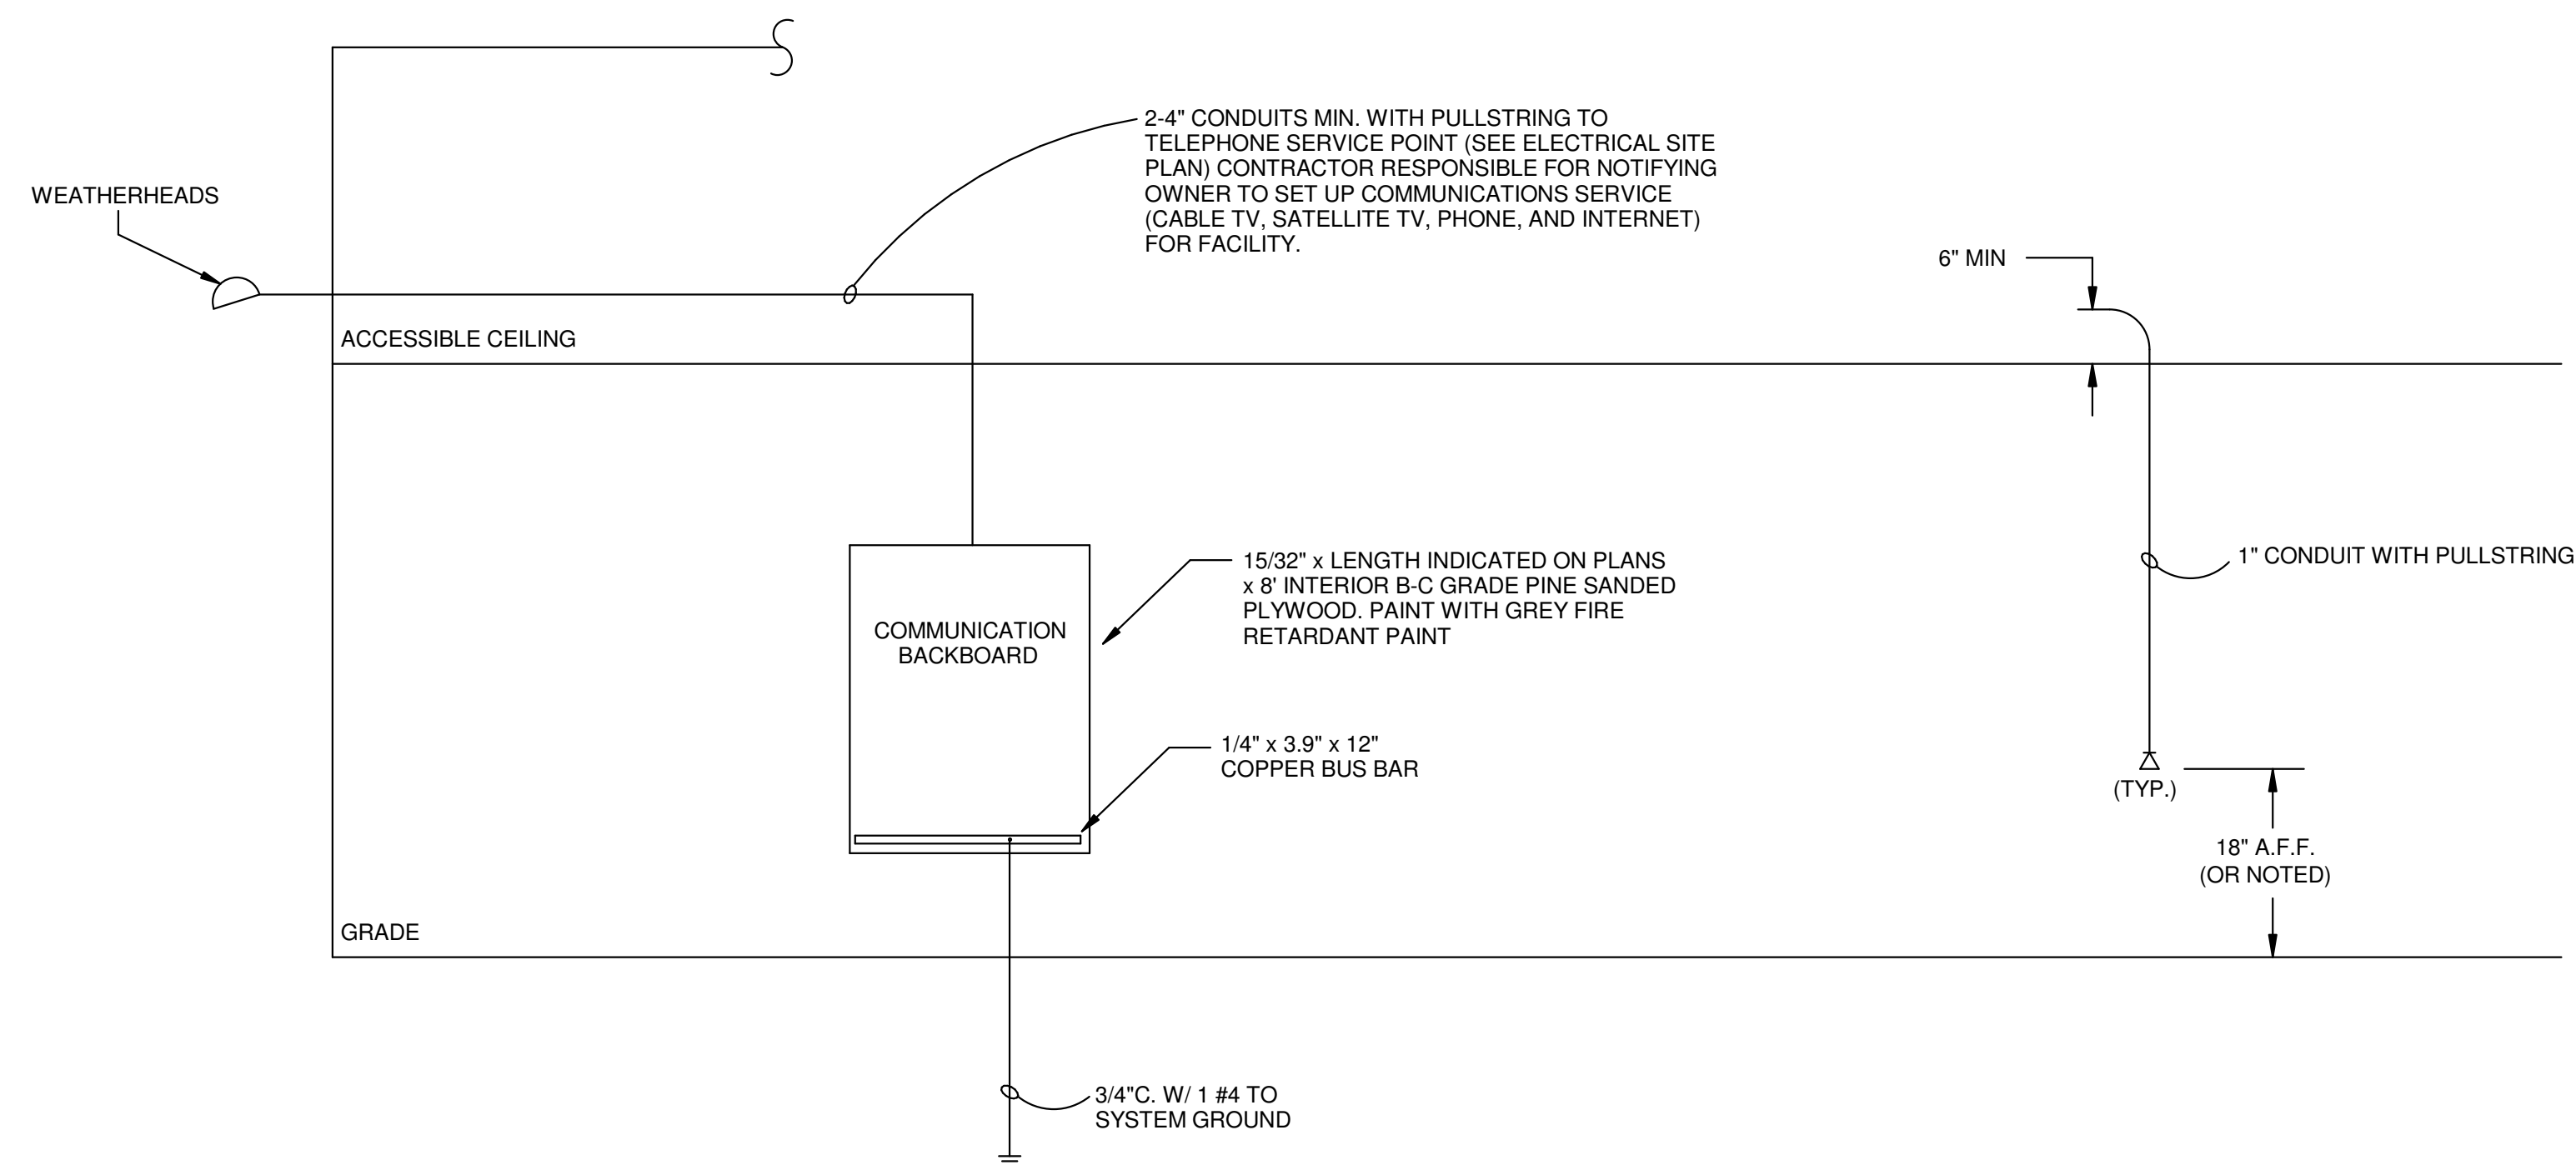



COMMUNICATIONS RISER
NO SCALE

LOAD SUMMARY			
120/208V - 3 PHASE - 4 WIRE			
SERVING	CONNECTED (KVA)	MULTIPLIER	DEMAND (KVA)
LIGHTING	8.5	1.25	10.7
OUTLETS	48.4	$[(X-10)/2]+10$	29.2
WATER HEATER	4.5	1.0	4.5
AIR HANDLING UNIT	33.4	1.0	33.4
CONDENSING UNITS	14.7	1.0	14.7
HEATING	3	1.0	3
TOTAL KVA =			95.5
TOTAL AMPS =			265.3

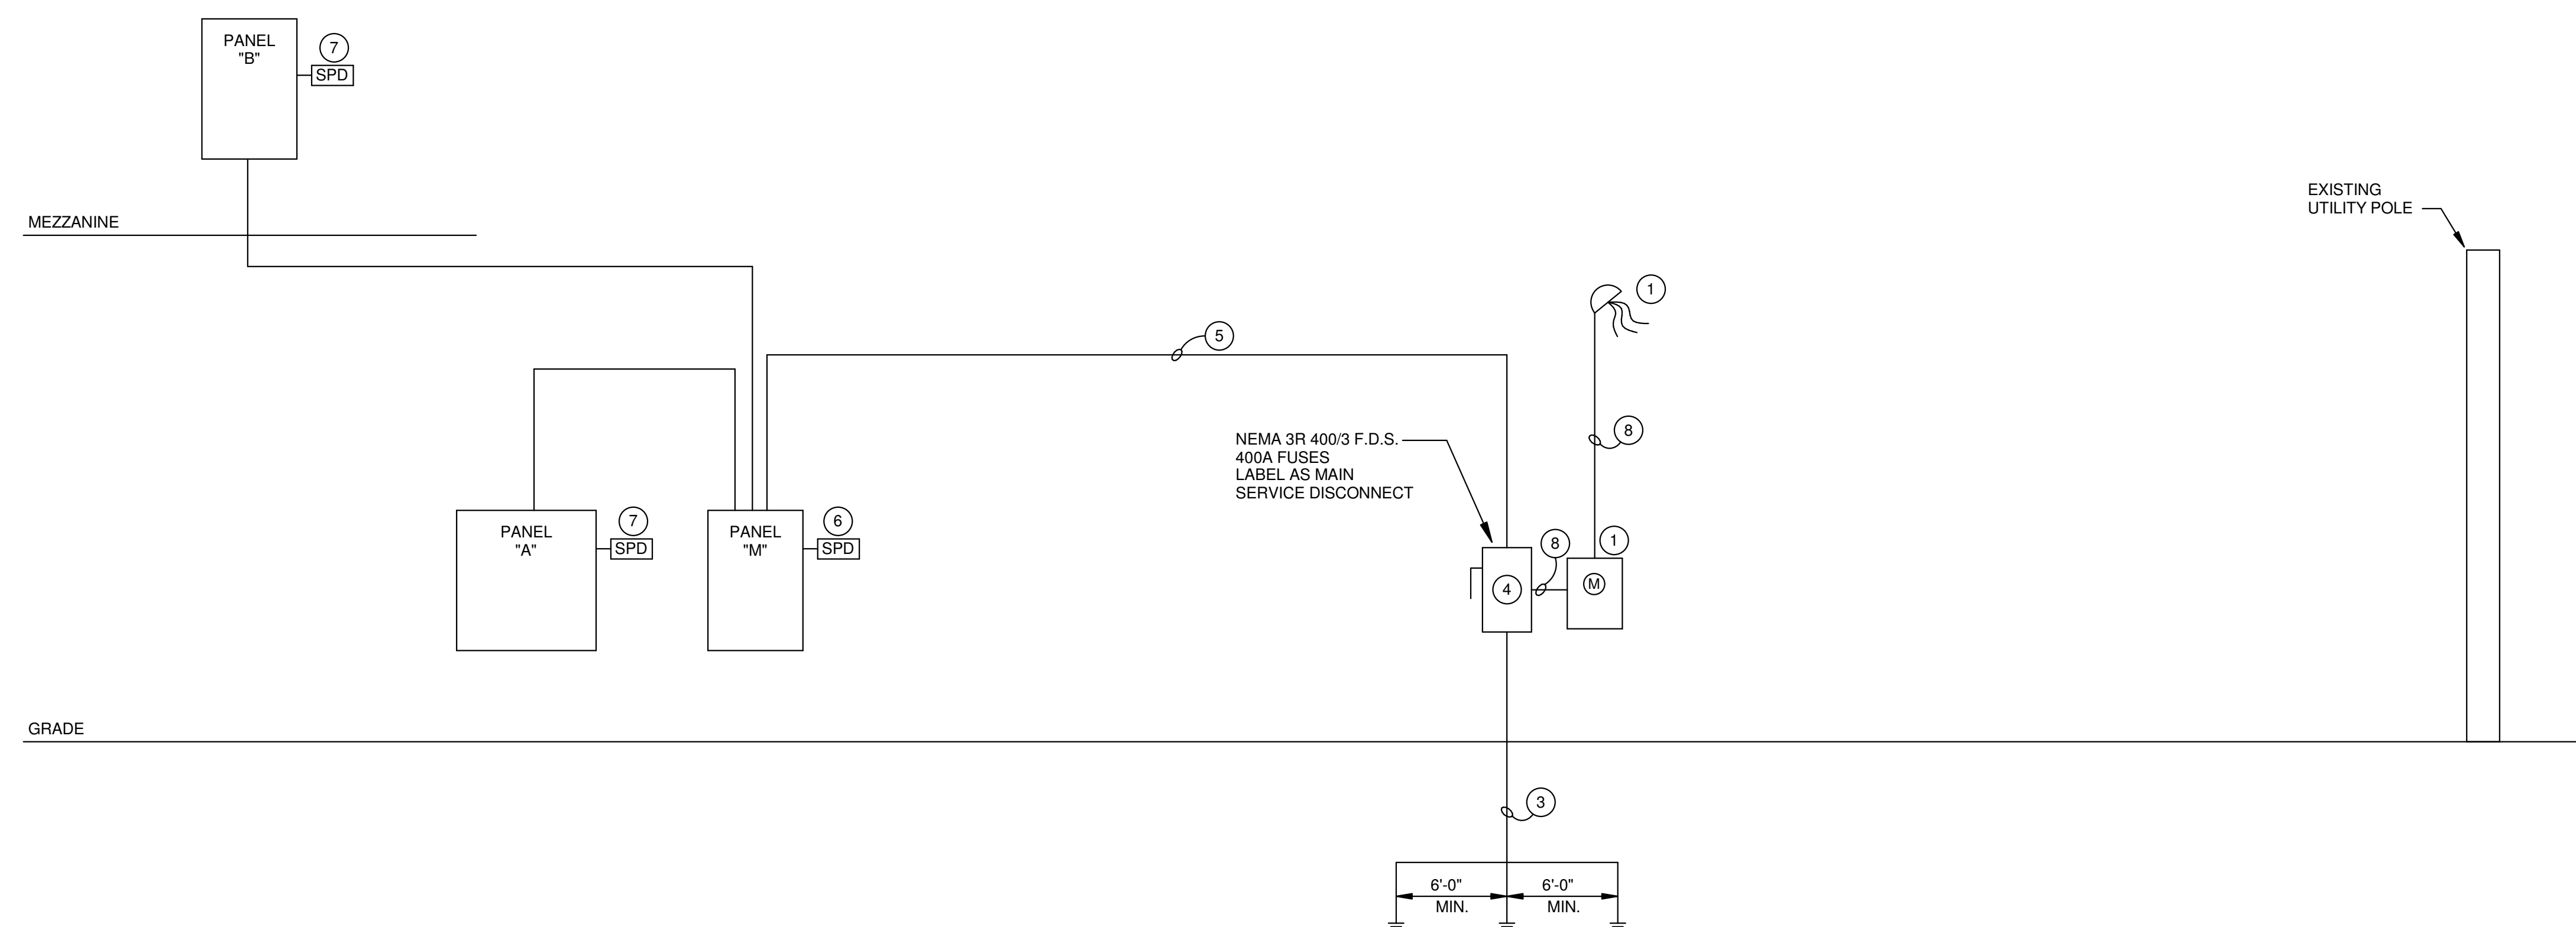

ELECTRICAL RISER
NO SCALE

- ELECTRICAL RISER NOTES:**
- COORDINATE ALL ASPECTS OF SERVICE AND METERING WITH POWER COMPANY. ELECTRICAL CONTRACTOR TO PROVIDE METERING C.T. CABINETS AND UNISTRUT RACK(S) IN CONCRETE FOOTINGS.
 - REFER TO PANEL SCHEDULES FOR FEEDER SIZES, INSTALL PROPERLY SIZED NEUTRALS AND GROUNDING CONDUCTORS WITH ALL FEEDERS.
 - 1/0 CU. GROUND IN 3/4" CONDUIT TO (3)3/4"x10" COPPER CLAD GROUND RODS, BUILDING STEEL, AND CONCRETE REINFORCEMENT RODS. (SEE DETAIL)
 - THE CONTRACTOR SHALL LABEL THE MAIN SERVICE DISCONNECTING MEANS WITH THE MAXIMUM AVAILABLE FAULT CURRENT, AND IT SHALL BE LISTED ON THE DEVICE TO MEET THE REQUIREMENTS OF NFPA 70-110.24. THE LABELING SHALL BE ENGRAVED PLASTIC. THE MAXIMUM AVAILABLE FAULT CURRENT SHALL BE OBTAINED FROM THE ELECTRICAL UTILITY COMPANY FOR THE SECONDARY SIDE OF THE UTILITY TRANSFORMER.
 - 4" CONDUIT WITH 4#500 KCMIL, 1#1/0 BONDING JUMPER.
 - SERVICE ENTRANCE TYPE SURGE PROTECTION DEVICE PER SPECIFICATIONS.
 - BRANCH PANEL TYPE SURGE PROTECTION DEVICE PER SPECIFICATIONS.
 - 4" CONDUIT WITH 4#500 KCMIL

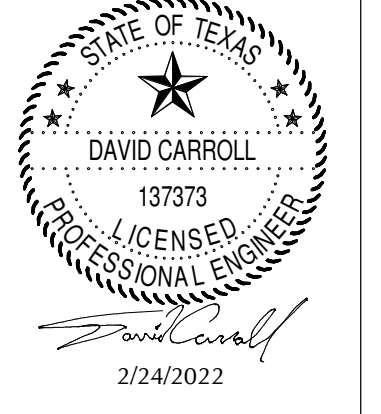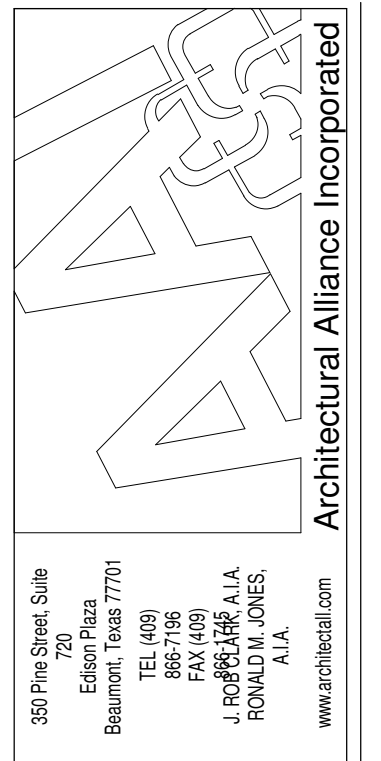

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Spindletop MHMR
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Silsbee, TX 77666


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REVISION: _____
DATE: _____

DRAWINGS SHEET TITLE
ELECTRICAL RISERS
SHEET NUMBER
E800
21061
PROJECT NUMBER


1304 BERTRAND DRIVE SUITE F7
LAFAYETTE, LOUISIANA 70506
(337) 234-7474 * FAX (337) 234-7774
Mechanical Contact: Dustin Duval, P.E.
dustin@meconsulting.com
Electrical Contact: David Carroll, P.E.
david@meconsulting.com
PROJECT No.: 21167.00

- GENERAL NOTES:**
1. WET SPRINKLER SYSTEM SHALL BE INSTALLED AS PER N.F.P.A. 13 REQUIREMENTS.
 2. COORDINATE SPRINKLER HEAD TYPE WITH ARCHITECTURAL REFLECTED CEILING PLAN. ALL HEADS WITHIN CEILING SHALL BE FULLY CONCEALED.
 3. ALL SPRINKLER HEADS IN GRID CEILING SHALL BE CENTERED IN TILE.
 4. ALL UPRIGHT TYPE HEADS SHALL HAVE A PROTECTED WIRE GUARD.
 5. ALL PENETRATIONS THRU FIRE RATED CEILING/WALL ASSEMBLIES SHALL BE PROPERLY SEALED WITH FIRE RATED SEALANT. REFER TO ARCHITECTURAL DRAWINGS FOR RATED LOCATIONS.
 6. PROVIDE SYSTEM DRAINING TO PREVENT TRAPING OF WATER IN SYSTEM AS REQUIRED. LOCATIONS SHALL BE APPROVED BY ARCHITECT.
 7. CONTRACTOR SHALL SUBMIT A PRELIMINARY HEAD LAYOUT AND PIPE ROUTING FOR REVIEW BY ARCHITECT AND ENGINEER PRIOR TO SUBMITTING STATE FIRE MARSHAL PACKAGE.
 8. COORDINATE LOCATION OF HEADS WITH LIGHTING FIXTURES, SPECIAL SYSTEMS, HVAC GRILLES, ETC.

- FIRE PROTECTION NOTES:**
1. WET PIPE FIRE PROTECTION SYSTEM TO BE PROVIDED FOR BUILDING AS PER N.F.P.A. 13 REQUIREMENTS.
 2. REFER TO ARCHITECTURAL SITE DRAWINGS FOR CONTINUATION.
 3. EXTEND TO FIRE DEPARTMENT CONNECTION. REFER TO ARCHITECTURAL SITE DRAWINGS FOR LOCATION.
 4. SPRINKLER ENTRY FOR WET PIPE SYSTEM.
 5. ELECTRIC BELL FOR SPRINKLER SYSTEM WATER ALARM MOUNTED ON THE EXTERIOR WALL INTERLOCKED WITH FIRE ALARM SYSTEM.
 6. WET PIPE FIRE PROTECTION SYSTEM WITHIN ATTIC SPACE. SYSTEM SHALL PROTECT ATTIC SPACE AND BUILDING AS PER N.F.P.A. 13 REQUIREMENTS.
 7. CONTRACTOR SHALL DESIGN THE SYSTEM BASED ON TEST RESULTS OF 62 PSI STATIC PRESSURE, 42 PSI RESIDUAL PRESSURE, 25 PITOT & 840 GPM THAT WAS PERFORMED ON 2-23-2022 AND ALLOW FOR A MINIMUM OF 5 PSI SAFETY FACTOR OR LOCAL AHJ REQUIRED SAFETY FACTOR IF GREATER.

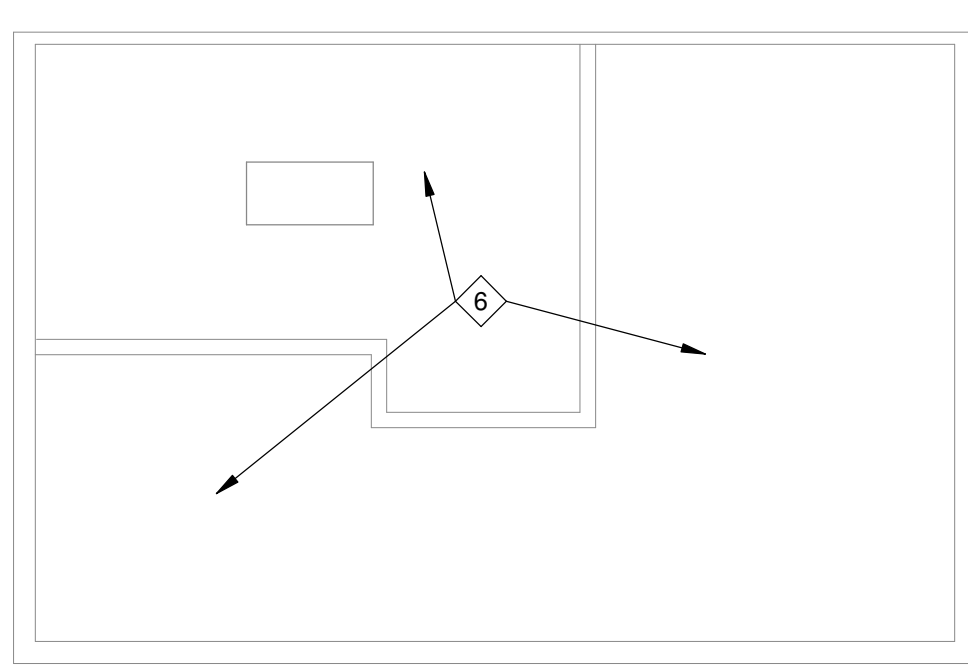

2 Fire Protection Plan - Mezzanine
 1/8" = 1'-0" Refer to Architectural Drawings for All Dimensions

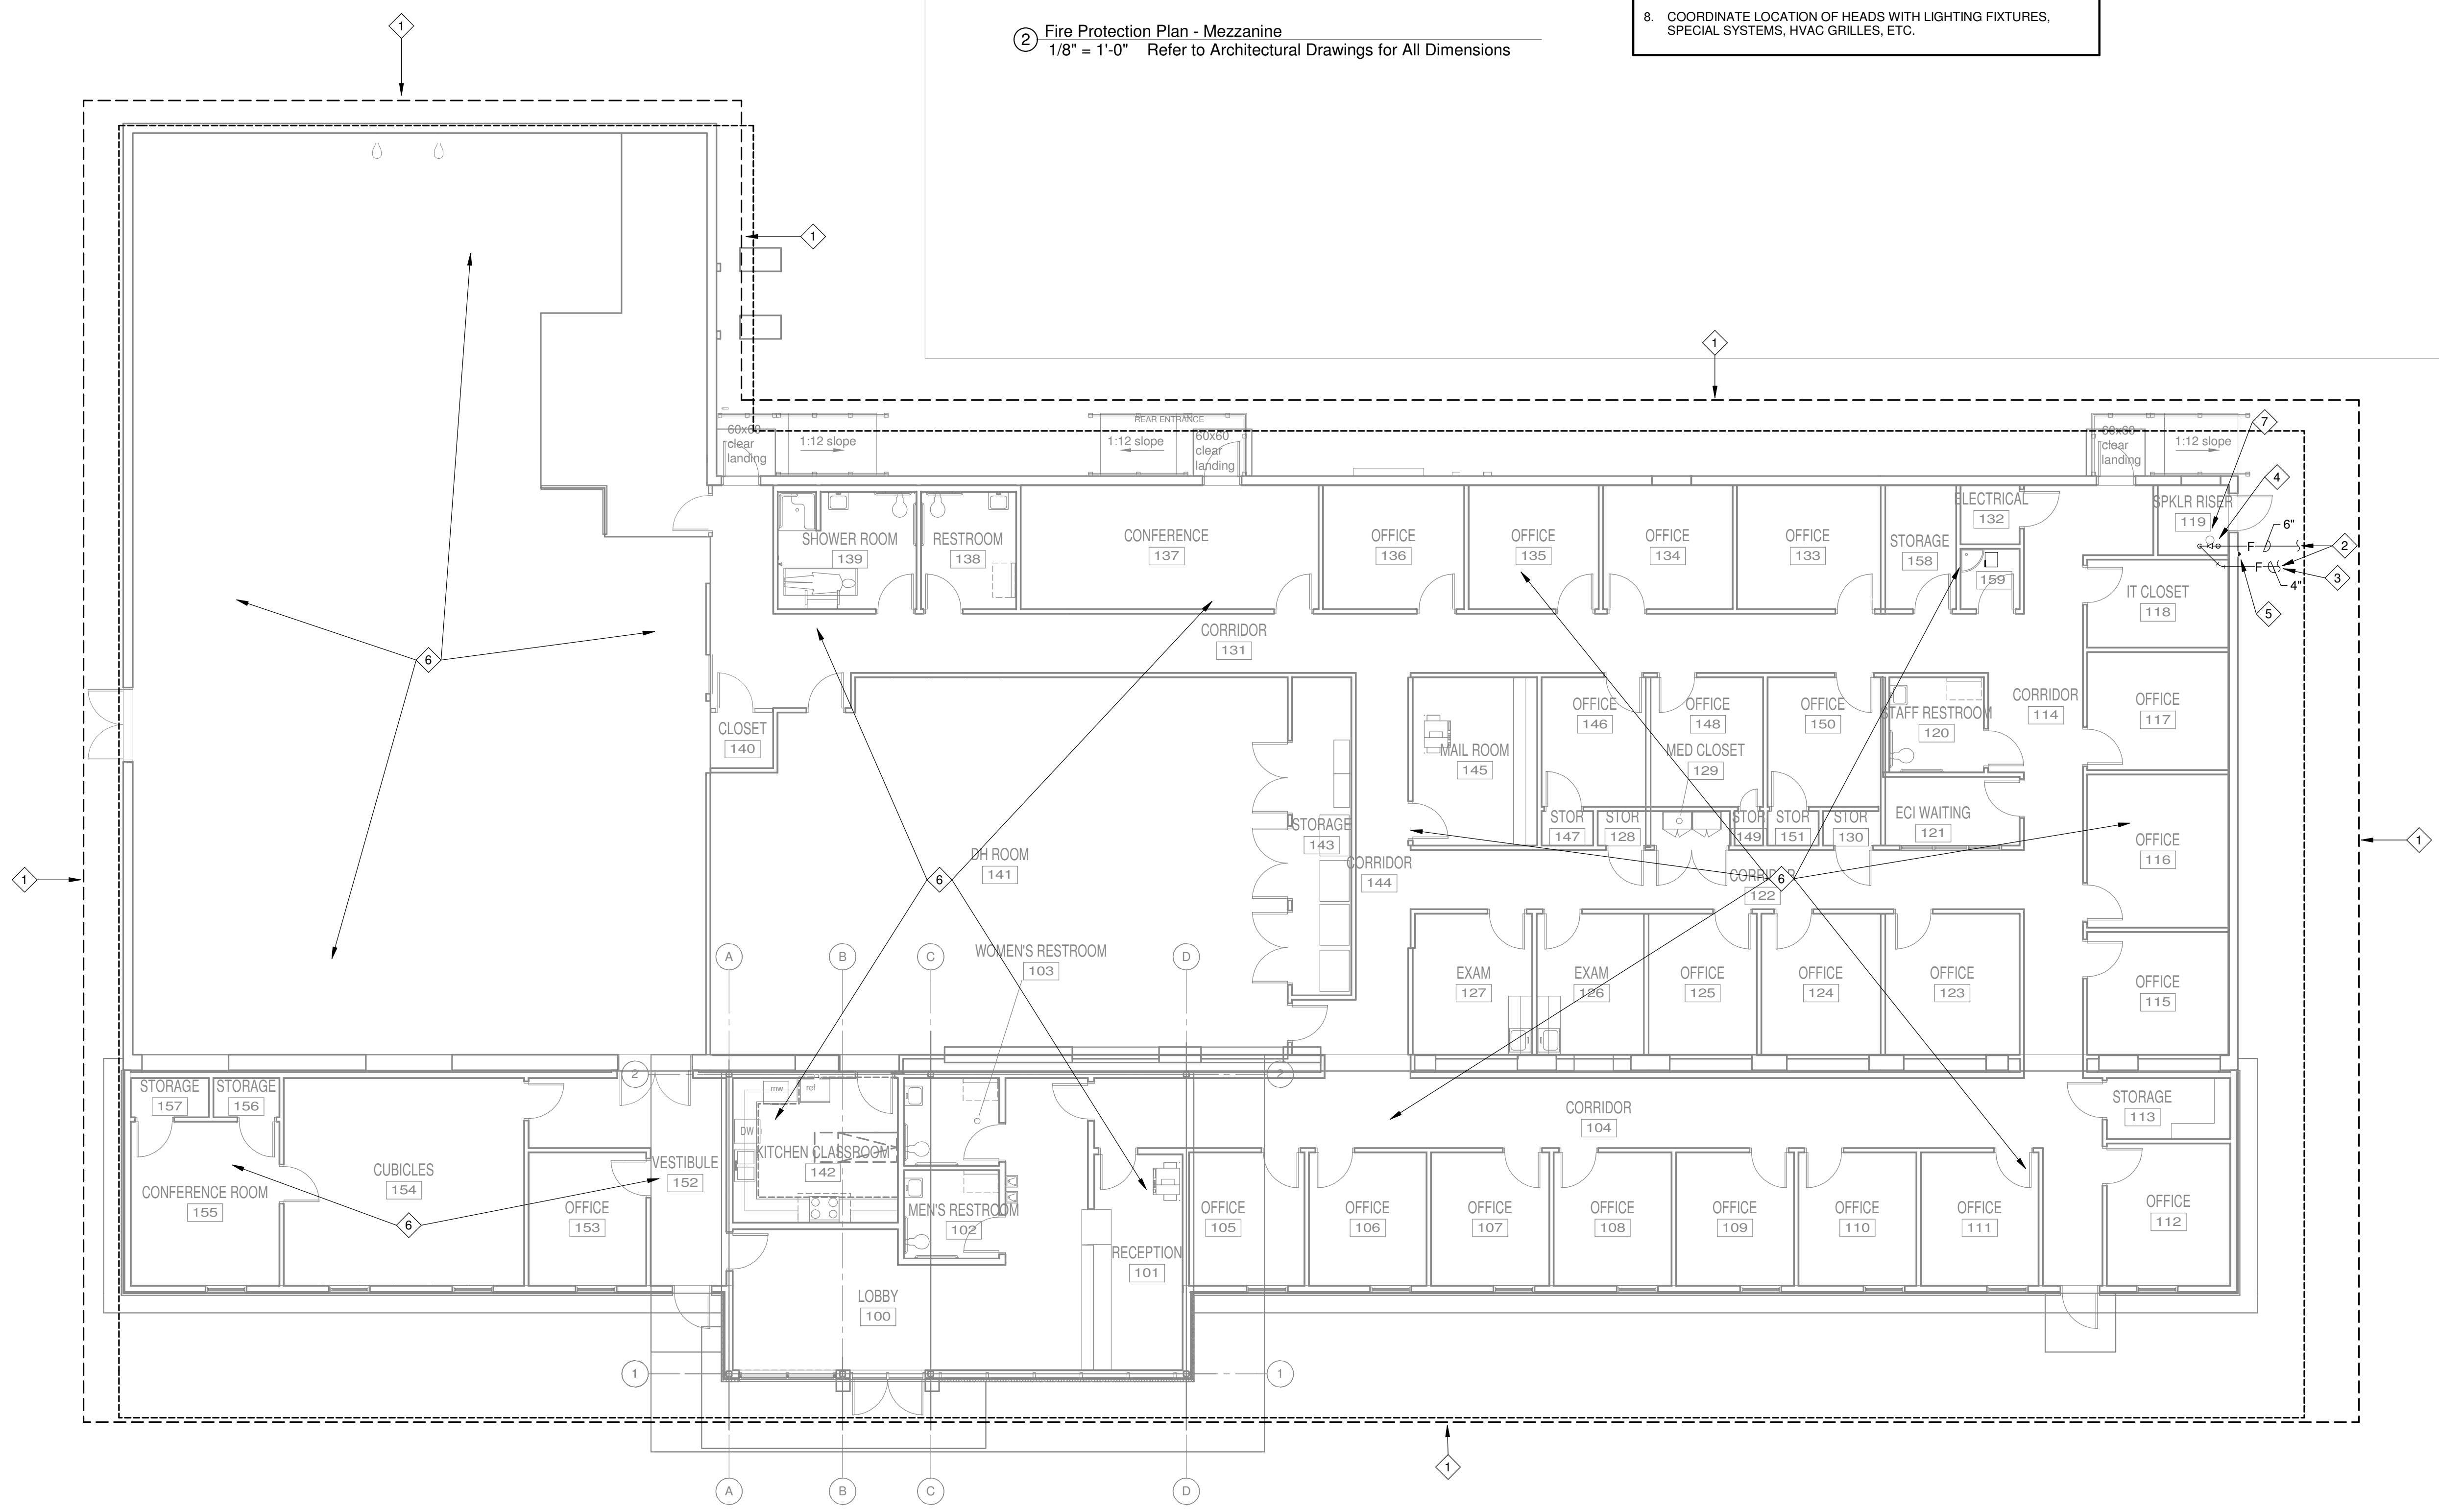

1 Fire Protection Plan
 1/8" = 1'-0" Refer to Architectural Drawings for All Dimensions

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DEFINE

PLUMBING & SPRINKLER ABBREVIATIONS

AD	ACCESS DOOR	HP	HORSE POWER
ADA	AMERICANS WITH DISABILITIES ACT	HS	HOSE STATION
AFF	ABOVE FINISHED FLOOR	HW	HAND WASH
AV	ACID VENT	ICE	ICE MACHINE WATER CONNECTION
AW	ACID WASTE	L	LAVATORY
BOP	BOTTOM OF PIPE	LS	LIFT STATION (SANITARY SEWER)
BP	BACKFLOW PREVENTER	MH	MANHOLE
BT	BATH TUB	MV	MIXING VALVE
BTUH	BRITISH THERMAL UNITS PER HOUR	N.O.	NORMALLY OPEN
C	CONDENSATE DRAIN LINE	N.C.	NORMALLY CLOSED
CA	COMPRESSED AIR LINE	NTS	NOT TO SCALE
CB	CATCH BASIN	P	PUMP
CFM	CUBIC FEET PER MINUTE	PIV	POST INDICATING VALVE
CI	CAST IRON	PRV	PRESSURE REDUCING VALVE
CO	CLEANOUT	PSIG	POUNDS PER SQUARE INCH GAGE
CSS	CLINIC SERVICE SINK	PT	PLASTER TRAP
CP	CIRCULATING WATER PUMP	REF	REFRIGERATOR WATER CONNECTION BOX
D	DRAIN LINE	RD	ROOF DRAIN
DF	DRINKING FOUNTAIN	RPM	REVOLUTIONS PER MINUTE
DCW	DOMESTIC COLD WATER LINE	SAN	SANITARY SEWER
DHR	DOMESTIC HOT WATER RETURN LINE	SD	STORM DRAIN
DHW	DOMESTIC HOT WATER LINE	SF	SQUARE FOOT
DS	DRENCH SHOWER	SH	SHOWER
DSEW	DRENCH SHOWER WITH EYE WASH	SK	SINK
DT	DILUTION TRAP	SMH	SEWER MANHOLE
DW	DISHWASHER	SS	SERVICE SINK
ET	EXPANSION TANK	STP	SEWER TREATMENT PLANT
EW	EYE WASH	TD	TRENCH DRAIN
EWC	ELECTRIC WATER COOLER	TP	TRAP PRIMER
EWH	ELECTRIC WATER HEATER	TYP	TYPICAL
FCO	FLOOR CLEANOUT	U	URINAL
FD	FLOOR DRAIN	UNO	UNLESS NOTED OTHERWISE
FDC	FIRE DEPARTMENT CONNECTION	V	VENT
FFE	FINISHED FLOOR ELEVATION	VAC	VACUUM
FH	FIRE HYDRANT	VB	VACUUM BREAKER
FS	FLOOR SINK	VTR	VENT THRU ROOF
GD	GARBAGE DISPOSAL	W	WASHER WATER/DRAIN CONNECTION LINE
GPH	GALLONS PER HOUR	WC	WATER CLOSET
GPM	GALLONS PER MINUTE	WCO	WALL CLEANOUT
GT	GREASE TRAP	WF	WASH FOUNTAIN
GWH	GAS FIRED WATER HEATER	WG	WATER GAGE
HB	HOSE BIB	WP	WHIRL POOL
HD	HUB DRAIN	ZVB	ZONE VALVE BOX (MEDICAL GAS)

DESIGN

PLUMBING & SPRINKLER LEGEND

PIPING				VALVES			
EXISTING	DEMO	NEW	DESCRIPTION	EXISTING	DEMO	NEW	DESCRIPTION
---	--DCW--	---	DOMESTIC COLD WATER LINE	---	--S--	---	BALL VALVE (SHUT-OFF)
---	--DHW--	---	DOMESTIC HOT WATER LINE (110°)	---	--S--	---	BALL VALVE (SHUT-OFF)
---	--DHR--	---	DOMESTIC HOT WATER RETURN LINE	---	--S--	---	SHUT-OFF VALVE IN CAST IRON VALVE BOX
--(X°F)--	--(X°F)--	--(X°F)--	DOMESTIC HOT WATER LINE (X=TEMP.)	---	--S--	---	CALIBRATED BALANCING VALVE
---	---	---	SANITARY SEWER LINE (SAN)	---	---	---	CHECK VALVE
---	--V--	---	SANITARY SEWER VENT LINE	---	---	---	OS&Y VALVE
---	--SD--	---	STORM DRAIN LINE (PRIMARY)	---	---	---	GAS COCK
--OSD--	--OSD--	--OSD--	OVERFLOW STORM DRAIN LINE (SECONDARY)	---	---	---	BUTTERFLY VALVE
---	--C--	---	CONDENSATE DRAIN LINE	---	---	---	VALVE IN RISE
--GW--	--GW--	--GW--	GREASE WASTE DRAIN LINE	---	---	---	2-WAY CONTROL VALVE
--AW--	--AW--	--AW--	ACID WASTE DRAIN LINE	---	---	---	3-WAY CONTROL VALVE
---	--F--	---	FIRE MAIN WATER LINE	EQUIPMENT			
---	--S--	---	SPRINKLER LINE	EXISTING	DEMO	NEW	DESCRIPTION
---	--G--	---	NATURAL GAS LINE	---	---	---	PLUMBING FIXTURES
---	--LP--	---	PROPANE GAS LINE	---	---	---	METER
---	--CA--	---	COMPRESSED AIR LINE	---	---	---	REGULATOR
---	--RO--	---	REVERSE OSMOSIS PURE WATER SUPPLY LINE	SYMBOL (MISC.)			
---	--ROR--	---	REVERSE OSMOSIS PURE WATER RETURN LINE	EXISTING	DEMO	NEW	DESCRIPTION
---	--DI--	---	DIONIZED PURE WATER SUPPLY LINE	---	---	---	CONNECT TO EXISTING SERVICES
---	--O--	---	OXYGEN LINE (MEDICAL)				
---	--VAC--	---	VACUUM LINE (MEDICAL)				
---	--N--	---	NITROGEN LINE (MEDICAL)				
---	--NO--	---	NITROUS OXIDE (MEDICAL)				
---	--MA--	---	AIR (MEDICAL)				
---	--WAGD--	---	WASTE ANESTHETIC GAS DISPOSAL				
PIPE FITTING							
EXISTING	DEMO	NEW	DESCRIPTION				
---	---	---	CAPPED PIPE				
---	---	---	PIPE RISE				
---	---	---	PIPE DROP				
---	---	---	UNION				
---	---	---	DIRECTION OF FLOW				
---	---	---	PIPE SUPPORT OR BRACING				
---	---	---	PIPE CONNECTION (TOP)				
---	---	---	PIPE CONNECTION (BOTTOM)				
---	---	---	PIPE CONNECTION (SIDE)				
---	---	---	CAPPED OUTLET TOP				
---	---	---	PIPE REDUCER AND/OR INCREASER				



NOTES: 1. EXISTING ITEMS ON DEMO PLANS ARE "EXISTING TO REMAIN" UNLESS NOTED "EXISTING TO BE RELOCATED."
 2. ITEMS ON NEW CONSTRUCTION PLANS ARE NEW UNLESS NOTED "RELOCATED FROM PREVIOUS LOCATION". REFER TO SCHEDULES AND SPECIFICATIONS FOR PLUMBING FIXTURES.
 3. NOT ALL ITEMS SHOWN ON THIS LIST MAY BE APPLICABLE TO THIS PROJECT.

DELIVER

PLUMBING & SPRINKLER GENERAL NOTES

- CONTRACTOR SHALL VISIT THE SITE AND DETERMINE THE EXTENT OF DEMOLITION WORK AND NEW WORK NEEDED FOR THIS PROJECT, PRIOR TO SUBMITTING BID.
- CONTRACTOR SHALL BECOME FAMILIAR WITH THE PROJECT SCOPE, CONSTRAINTS, UTILITY CONNECTIONS, AND BUILDING SERVICES, PRIOR TO SUBMITTING BID.
- CONTRACTOR SHALL GIVE FIRST RIGHT TO REFUSAL OF SALVAGE TO THE OWNER, IF THE OWNER ELECTS TO NOT KEEP SALVAGE, CONTRACTOR SHALL REMOVE SALVAGE BY LAWFUL MEANS.
- DRAWINGS ARE SCHEMATIC AND DIAGRAMMATIC IN NATURE. DRAWINGS SHALL NOT BE SCALED. COORDINATE ROUTING OF SERVICES WITH SITE CONDITIONS AND WITH WORK OF OTHER TRADES.
- FIELD VERIFY DIMENSIONS PRIOR TO ORDERING, FABRICATING, AND ERECTION OF MATERIAL AND/OR EQUIPMENT. NOTIFY THE ENGINEER OF DISCREPANCIES IN A TIMELY MANNER.
- VERIFY CLEARANCE REQUIREMENTS AND ROUTING OF PIPING PRIOR TO FABRICATION, AS MINOR MODIFICATIONS SUCH AS PIPING RISES AND DROP MAY BE REQUIRED DUE TO FIELD CONDITIONS. MAKE MINOR MODIFICATIONS TO THE BUILDING, PIPING, SPRINKLER, DUCTWORK, ELECTRICAL, ETC. AS SHOWN ON THE DRAWINGS OR REQUIRED TO COMPLETE THE INSTALLATION OF A COMPLETED WORKABLE SYSTEM.
- MAINTAIN WEATHER-TIGHT BARRIERS TO PREVENT DAMAGE FROM THE ELEMENTS DURING DEMOLITION AND NEW CONSTRUCTION PERIOD.
- SEAL PENETRATIONS THROUGH THE BUILDING ENVELOPE.
- PENETRATIONS THROUGH RATED WALLS, FLOORS, PARTITIONS AND ASSEMBLIES SHALL BE INSTALLED AND FIRESAFED TO MEET UL FIRE RESISTANCE LISTING AND NFPA REQUIREMENTS FOR THE PENETRATION.
- COORDINATE DEVICES REQUIRING ACCESS PANELS WITH THE ARCHITECT AND OTHER TRADES.
- MAINTAIN MINIMUM CLEARANCE 10'-0" BETWEEN OUTSIDE INTAKES AND EXHAUST OUTLETS AND PLUMBING VENTS.
- COORDINATE FINAL LOCATIONS AND ELEVATIONS WITH THE ARCHITECT PRIOR TO INSTALLATION.
- COORDINATE FINAL FINISH COLORS OF MATERIALS, DEVICES, AND/OR EQUIPMENT WITH THE ARCHITECT PRIOR TO ORDERING, FABRICATION AND INSTALLATION.
- SCHEDULE UTILITY SERVICES SHUTDOWNS WITH OWNER AND ARCHITECT. MINIMIZE DISRUPTIONS AND DOWNTIME TO THE OWNER.
- INSTALL DEVICES AND EQUIPMENT TO MEET ADA REQUIREMENTS.
- ROUTE PIPING CONCEALED IN INTERSTITIAL SPACE UNLESS NOTED OTHERWISE.
- DOCUMENT LOCATIONS OF DEVICES, PIPING, AND EQUIPMENT ON "AS-BUILT" RECORD DRAWINGS AS PER THE SPECIFICATIONS.
- PAY FOR SERVICE, DEPOSITS, INSPECTION, AND CONNECTION FEES REQUIRED FOR A COMPLETE INSTALLATION. COORDINATE WITH THE UTILITY SERVICE PROVIDER FOR THE REQUIREMENTS NEEDED FOR THIS PROJECT. COORDINATE WITH THE UTILITY SERVICE PROVIDER FOR THE REQUIREMENTS NEEDED FOR THIS PROJECT.
- WORK SHOWN IN THE DRAWINGS SHALL COMPLY WITH APPLICABLE NATIONAL, STATE, AND LOCAL ORDINANCES AND CODES.
- ALL EXPOSED DOMESTIC COLD AND HOT WATER PIPING WITHIN THE BUILDING SHALL HAVE FIELD INSTALL PVC JACKET.
- WATER HAMMER ARRESTER(S) SHALL BE INSTALLED ON PIPING SYSTEMS AND AT QUICK-CLOSING VALVES AS PER MANUFACTURER'S RECOMMENDATIONS.

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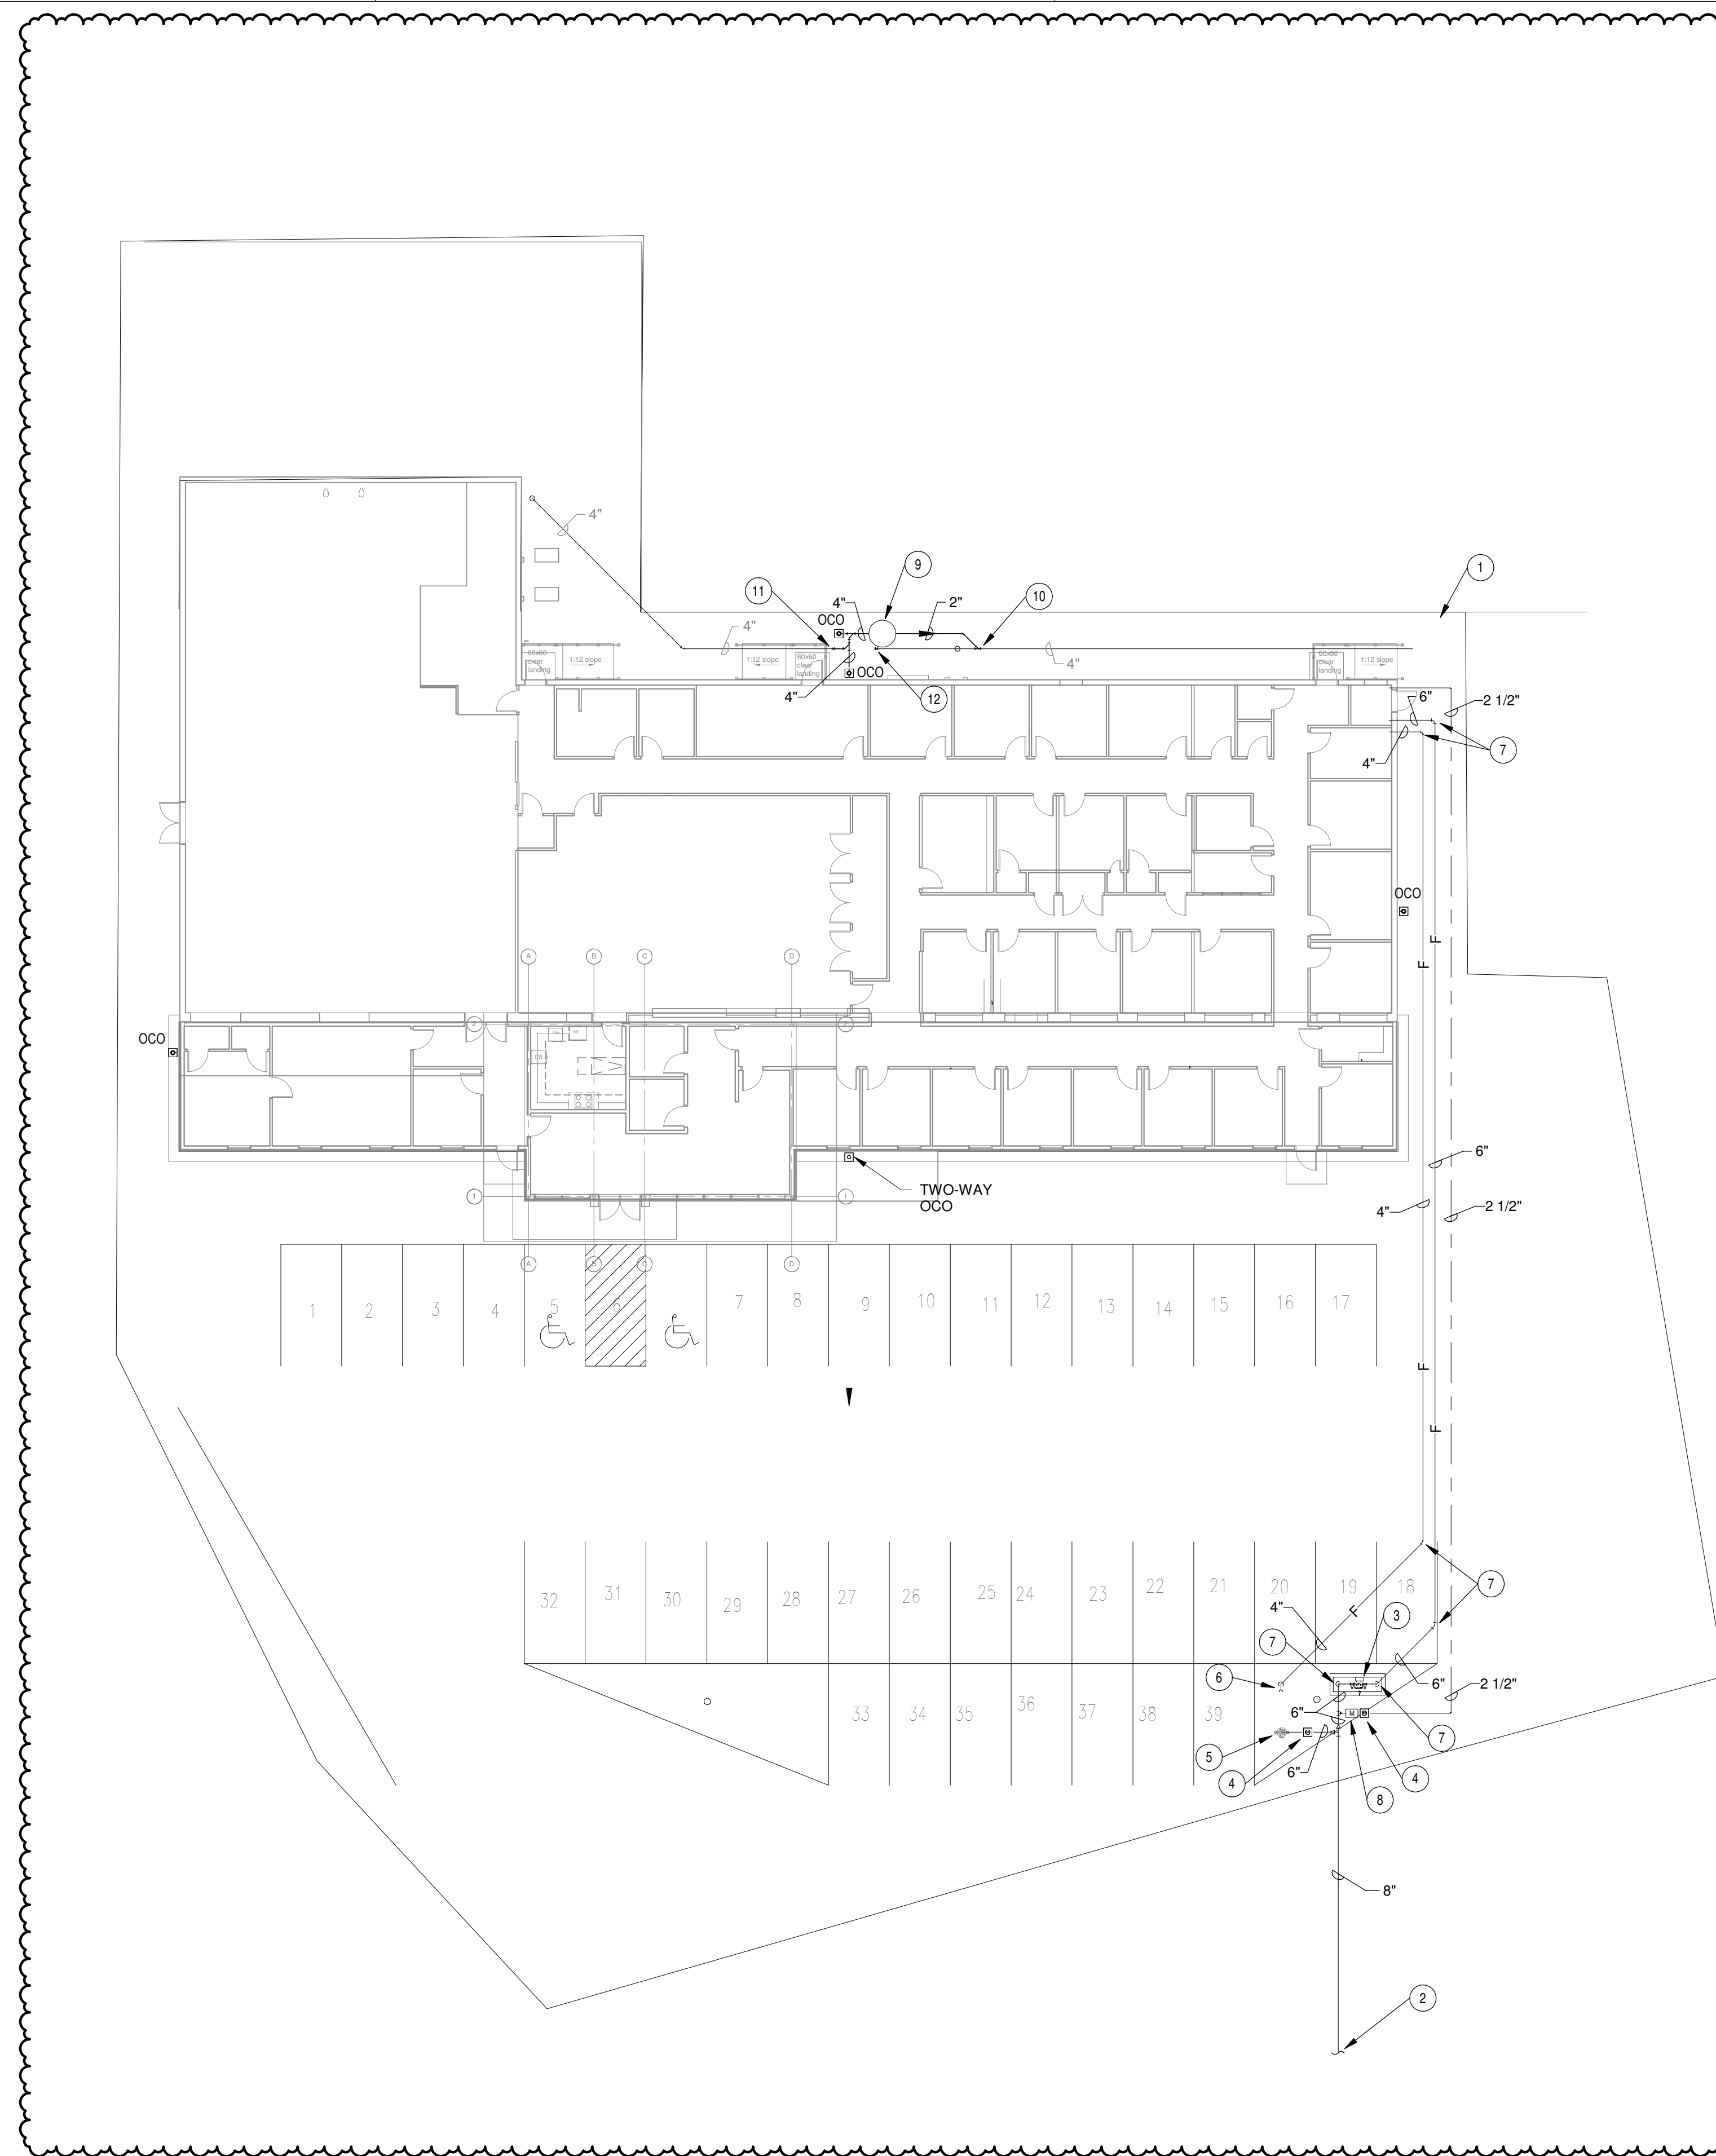
SPINDLETOP SILSBEE
 Spindletop MHR
 Silsbee, TX 77656
 222 Durbin Dr.
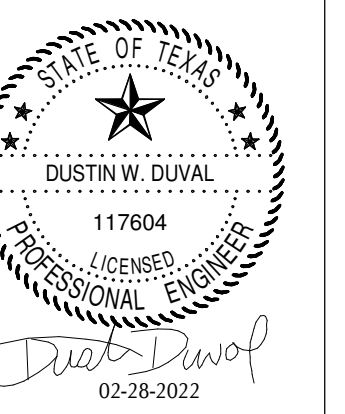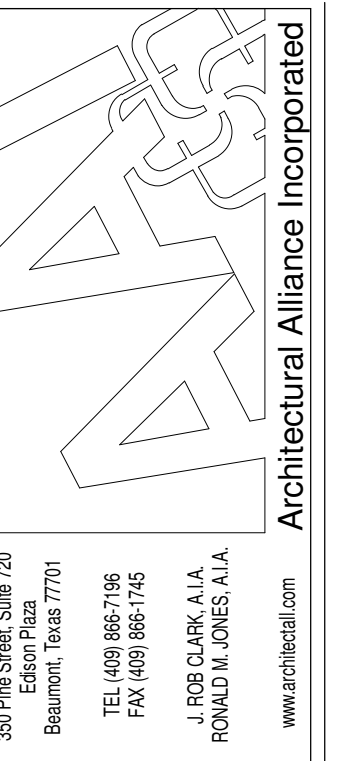
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 DATE: _____
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 DATE: 02/28/2022
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DRAWINGS SHEET TITLE
PLUMBING LEGEND & GENERAL NOTES

SHEET NUMBER
P000
 21061
 PROJECT NUMBER

1304 BERTRAND DRIVE SUITE F7
 LAFAYETTE, LOUISIANA 70506
 (337) 234-7474 * FAX (337) 234-7774
 Mechanical Contact: Dustin Duval, P.E.
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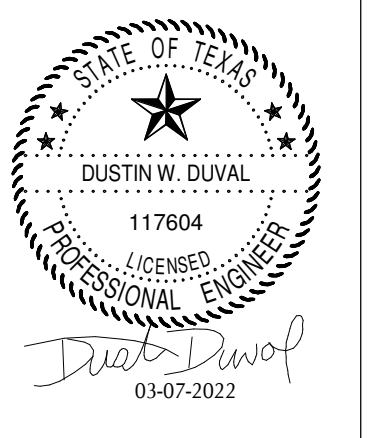


PLUMBING KEYNOTES:

- 1 TOTAL OF 4 EXISTING WATER METERS ARE CURRENTLY INSTALLED IN THIS LOCATION. CONTRACTOR SHALL REMOVE ALL FOUR (4) WATER METERS. CONTRACTOR SHALL REMOVE EXISTING BACKFLOW PREVENTER AND EXISTING DOMESTIC WATER LINES BELOW GRADE TO ACCOMMODATE FOR NEW WATER LINE. ALL EXISTING REMAINING LINES BELOW GRADE SHALL REMOVED OR BE CAPPED TO ACCOMMODATE INSTALLATION OF NEW LINES.
- 2 EXTEND AND CONNECT TO EXISTING 8" CITY WATER MAIN ON THE NORTH SIDE OF THE STREET WITH TAPPING SLEEVE AND VALVE. CONTRACTOR SHALL SAWCUT AND PATCH STREET OR JACK AND BORE AS REQUIRED. CONTRACTOR SHALL COORDINATE ALL REQUIREMENTS WITH LOCAL UTILITY COMPANY AND PAY FOR ALL CONNECTION FEES.
- 3 DOUBLE CHECK DETECTOR ASSEMBLY WITH BY-PASS WATER METER WITHIN ALUMINUM INSULATED ENCLOSURE WITH HEATER.
- 4 2 1/2" SHUT-OFF VALVE IN CAST IRON VALVE BOX MARKED "WATER" ON COVER.
- 5 NEW FIRE HYDRANT AND ISOLATION VALVE. FIRE HYDRANT SHALL HAVE THREADS APPROVED BY LOCAL FIRE DEPARTMENT.
- 6 FIRE DEPARTMENT CONNECTION. COORDINATE THREAD CONNECTIONS WITH LOCAL FIRE DEPARTMENT.
- 7 INSTALL THRUST BLOCK AT ALL BENDS IN WATER PIPING BELOW GRADE.
- 8 WATER METER BY LOCAL UTILITY COMPANY. CONTRACTOR SHALL PAY FOR ALL FEES AND CHARGES. TOTAL DEMAND = 70 GPM FOR PHASE 1 & PHASE 2.
- 9 PACKAGED LIFT STATION AND CONTROL PANEL MOUNTED ON UNISTRUT RACK.
- 10 FORCED MAIN SHALL CONNECT TO EXISTING 4" GRAVITY SEWER LINE IN THIS VICINITY.
- 11 CONNECT TO EXISTING SANITARY SEWER LINE IN THIS VICINITY.
- 12 CAP EXISTING SANITARY SEWER LINE IN THIS VICINITY.

1 Plumbing Site Plan
 1/16" = 1'-0" Refer to Architectural Drawings for All Dimensions

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SilSbee, TX 77656
 222 Durbin Dr.
 SPINDLETOP SILSBEE
 Spindletop MHR

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DESIGN DEVELOPMENT	<input type="checkbox"/>
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BIDS & CONSTRUCTION	<input checked="" type="checkbox"/>
DATE: 02/28/2022	
REVISION:	
DATE: 03/07/2022	
REVISION:	
DATE:	
REVISION:	
DATE:	

DRAWINGS SHEET TITLE
PLUMBING SITE PLAN

SHEET NUMBER
P100R1
 21061
 PROJECT NUMBER

1304 BERTRAND DRIVE SUITE F7
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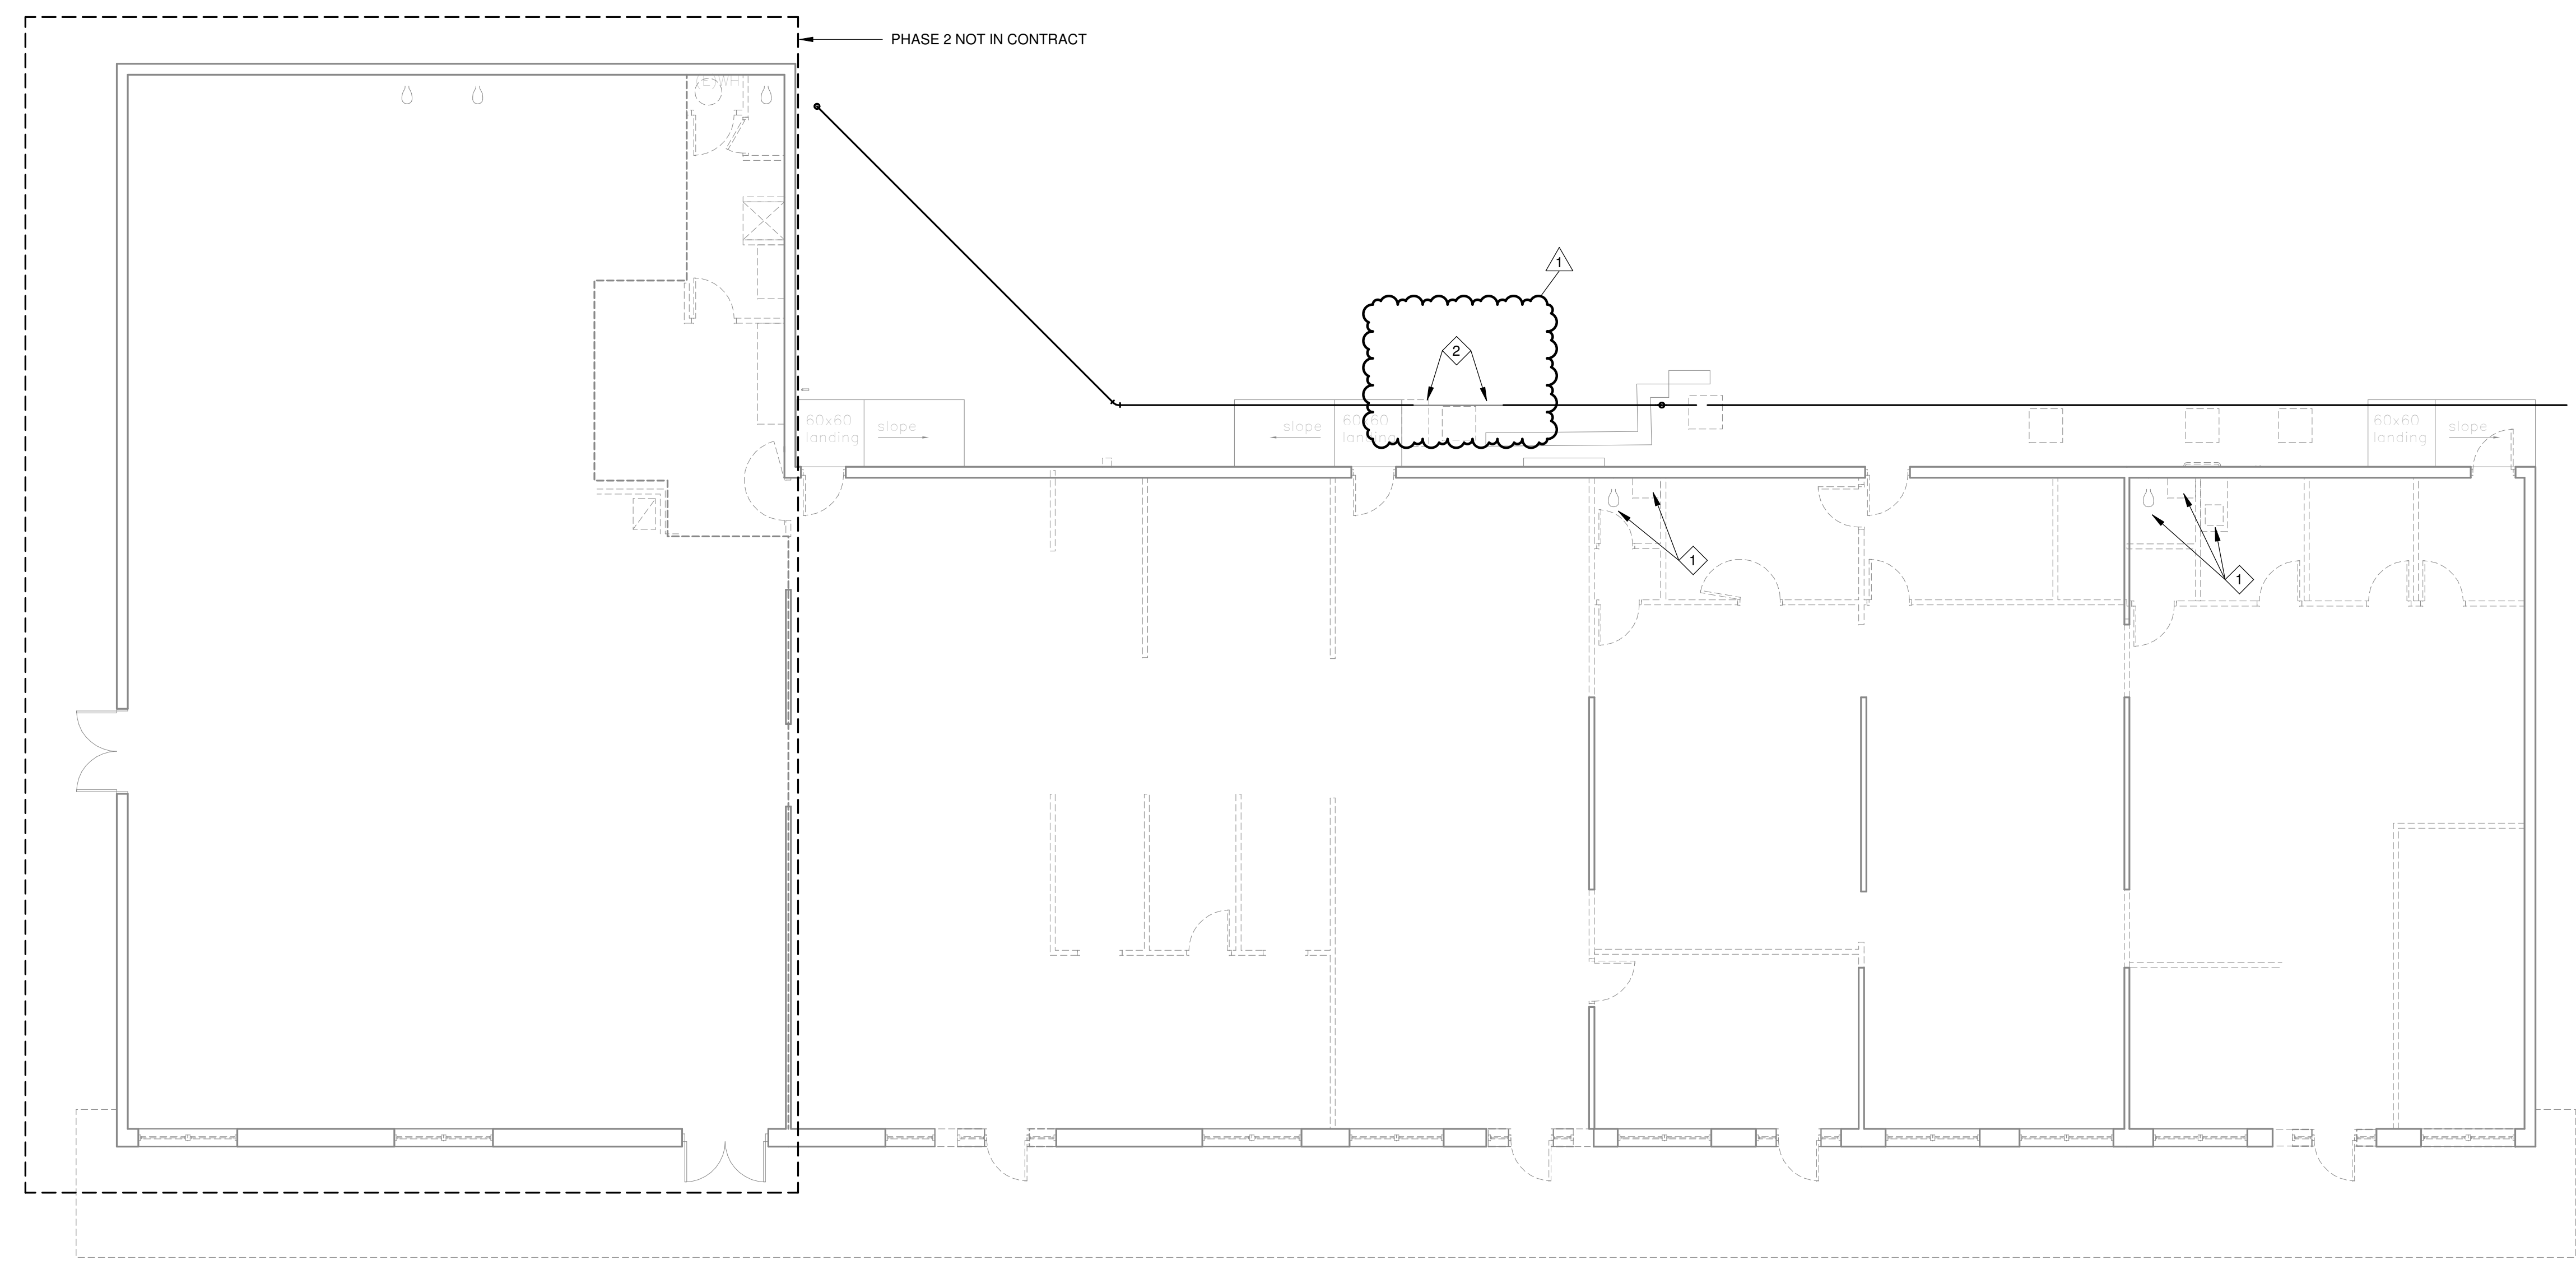
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BIDS & CONSTRUCTION	<input checked="" type="checkbox"/>
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REVISION:	
DATE: 03/07/2022	
REVISION:	
DATE:	
REVISION:	
DATE:	

DRAWINGS SHEET TITLE	PLUMBING DEMOLITION PLAN
SHEET NUMBER	P200R1
PROJECT NUMBER	21061

PLUMBING DEMOLITION KEYNOTES:

1 REMOVE PLUMBING FIXTURE IN THIS VICINITY. CAP AND SEAL PIPING BEHIND A FINISHED SURFACE.

2 REMOVE EXISTING SEWER LINE IN THIS VICINITY TO ACCOMMODATE FOR NEW SEWER LINE. REFER TO SHEET P300 PLUMBING PLAN FOR ADDITIONAL INFORMATION.



1 Plumbing Plan - Demolition
 1/8" = 1'-0" Refer to Architectural Drawings for All Dimensions


1304 BERTRAND DRIVE SUITE F7
 LAFAYETTE, LOUISIANA 70506
 (337) 234-7474 * FAX (337) 234-7774

Mechanical Contact: Dustin Duval, P.E.
 dustin@meconsulting.com


Electrical Contact: David Carroll, P.E.
 david@meconsulting.com

PROJECT No.: 21167.00

- PLUMBING KEYNOTES:**
- 1 REFER TO PLUMBING SITE PLAN FOR CONTINUATION.
 - 2 1/2" VALVE IN CAST IRON VALVE BOX MARKED "WATER" ON COVER.
 - 3 1/2" DOMESTIC WATER LINE UP FROM BELOW GRADE WITHIN THE SPRINKLER ENTRY ROOM WITH BALL TYPE SHUT-OFF VALVE INSTALLED AT 3'-0" A.F.F. RISE UP TO ABOVE THE CEILING AND ROUTE TO PLUMBING FIXTURES AS REQUIRED.
 - 4 HUB DRAIN AND INSULATED P-TRAP WITHIN WALL WITH METAL ACCESS PANEL IN WALL TO ACCESS INDIRECT TERMINATION OF A/C CONDENSATE DRAIN LINE AT THE HUB DRAIN. FIRE RATED ACCESS PANELS SHALL BE INSTALLED IN FIRE RATED WALLS.
 - 5 HUB DRAIN AND INSULATED P-TRAP WITHIN WALL WITH HUB DRAIN OPENING ABOVE THE SUSPENDED CEILING TO ACCESS INDIRECT TERMINATION OF A/C CONDENSATE DRAIN LINE AT THE HUB DRAIN.
 - 6 ELECTRIC WATER HEATER LOCATED ON THE MEZZANINE LEVEL FINISHED FLOOR WITHIN EMERGENCY DRAIN PAN. TERMINATE RELIEF LINE AND EMERGENCY DRAIN PAN LINE INTO RECESSED FLOOR DRAIN LOCATED ON THE MEZZANINE LEVEL. PROVIDE 2" AIR GAP FOR RELIEF LINE TERMINATE AT RECESSED FLOOR DRAIN. COORDINATE EXACT LOCATION WITH HVAC/ELECTRICAL EQUIPMENT PRIOR TO INSTALLATION.
 - 7 MIXING VALVE ON THE MEZZANINE LEVEL MOUNTED ADJACENT TO WATER HEATER.
 - 8 CIRCULATING PUMP ON THE MEZZANINE LEVEL MOUNTED ADJACENT TO WATER HEATER.
 - 9 DOMESTIC COLD WATER LINE UP TO MEZZANINE LEVEL.
 - 10 DOMESTIC HOT WATER LINE DOWN FROM MEZZANINE LEVEL.
 - 11 DOMESTIC HOT WATER RETURN LINE UP TO MEZZANINE LEVEL.
 - 12 SANITARY SEWER LINE DOWN FROM MEZZANINE LEVEL AND CONTINUE DOWN TO BELOW GRADE.
 - 13 DOMESTIC COLD WATER LINE UP FROM BELOW.
 - 14 DOMESTIC HOT WATER LINE DOWN TO BELOW.
 - 15 DOMESTIC HOT WATER RETURN LINE UP FROM BELOW.
 - 16 SANITARY SEWER LINE DOWN TO BELOW.
 - 17 SANITARY SEWER VENT LINE UP FROM BELOW AND CONTINUE TO 3" V.T.R.
 - 18 SANITARY SEWER LINE CAPPED BELOW GRADE FOR PHASE 2 WORK.
 - 19 DOMESTIC COLD WATER LINE WITH SHUT-OFF VALVE AND CAP ABOVE THE CEILING FOR FUTURE PHASE 2 WORK.
 - 20 DOMESTIC HOT WATER LINE WITH SHUT-OFF VALVE AND CAP ABOVE THE CEILING FOR FUTURE PHASE 2 WORK. ONCE PHASE 2 WORK IS COMPLETED SHUT-OFF VALVE SHALL BE NORMALLY OPEN.
 - 21 DOMESTIC HOT WATER LINE SHUT-OFF VALVE NORMALLY OPEN UNTIL PHASE 2 WORK IS COMPLETED. ONCE PHASE 2 WORK IS COMPLETED SHUT-OFF VALVE SHALL BE NORMALLY CLOSED.
 - 22 PACKAGED LIFT STATION AND CONTROL PANEL MOUNTED ON UNISTRUT RACK.
 - 23 EXTEND DOMESTIC COLD WATER LINE AND CONNECT TO EXISTING PLUMBING FIXTURE AS REQUIRED WITH EQUAL WATER LINE SIZE. FIELD VERIFY EXISTING WATER LINE SIZE.

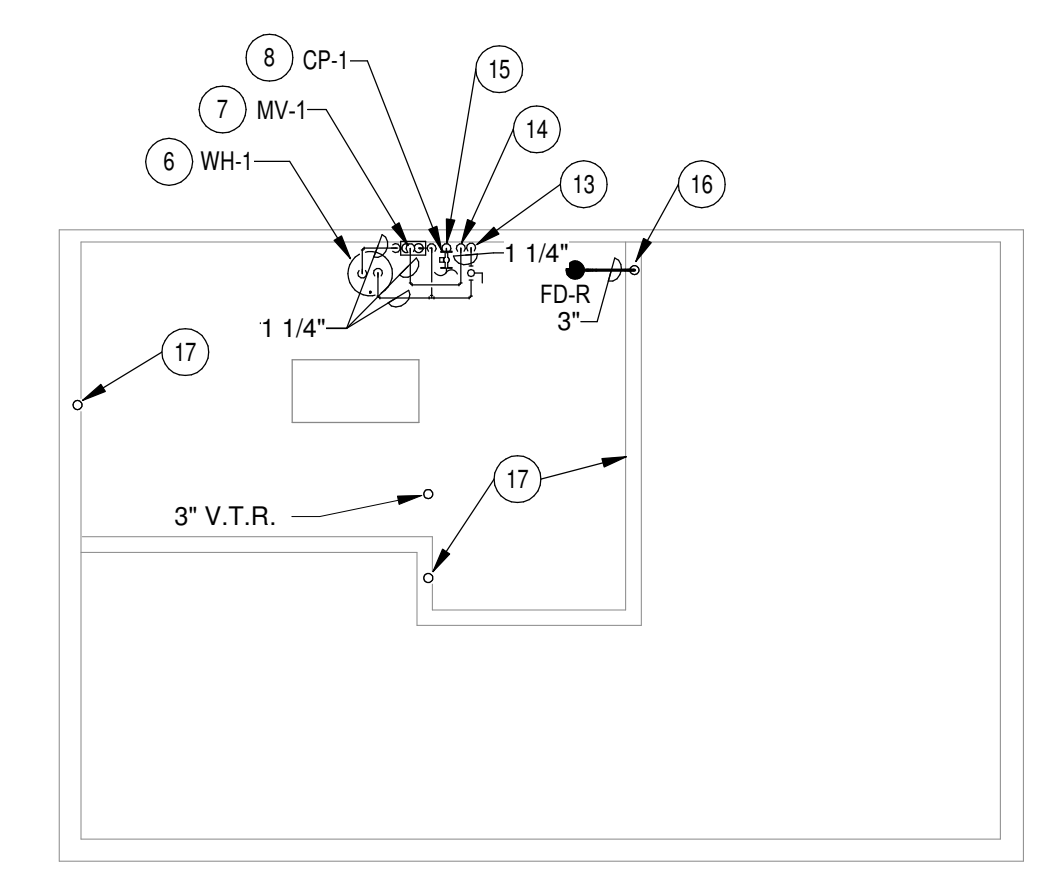


2 Plumbing Plan - Mezzanine
 1/8" = 1'-0" Refer to Architectural Drawings for All Dimensions

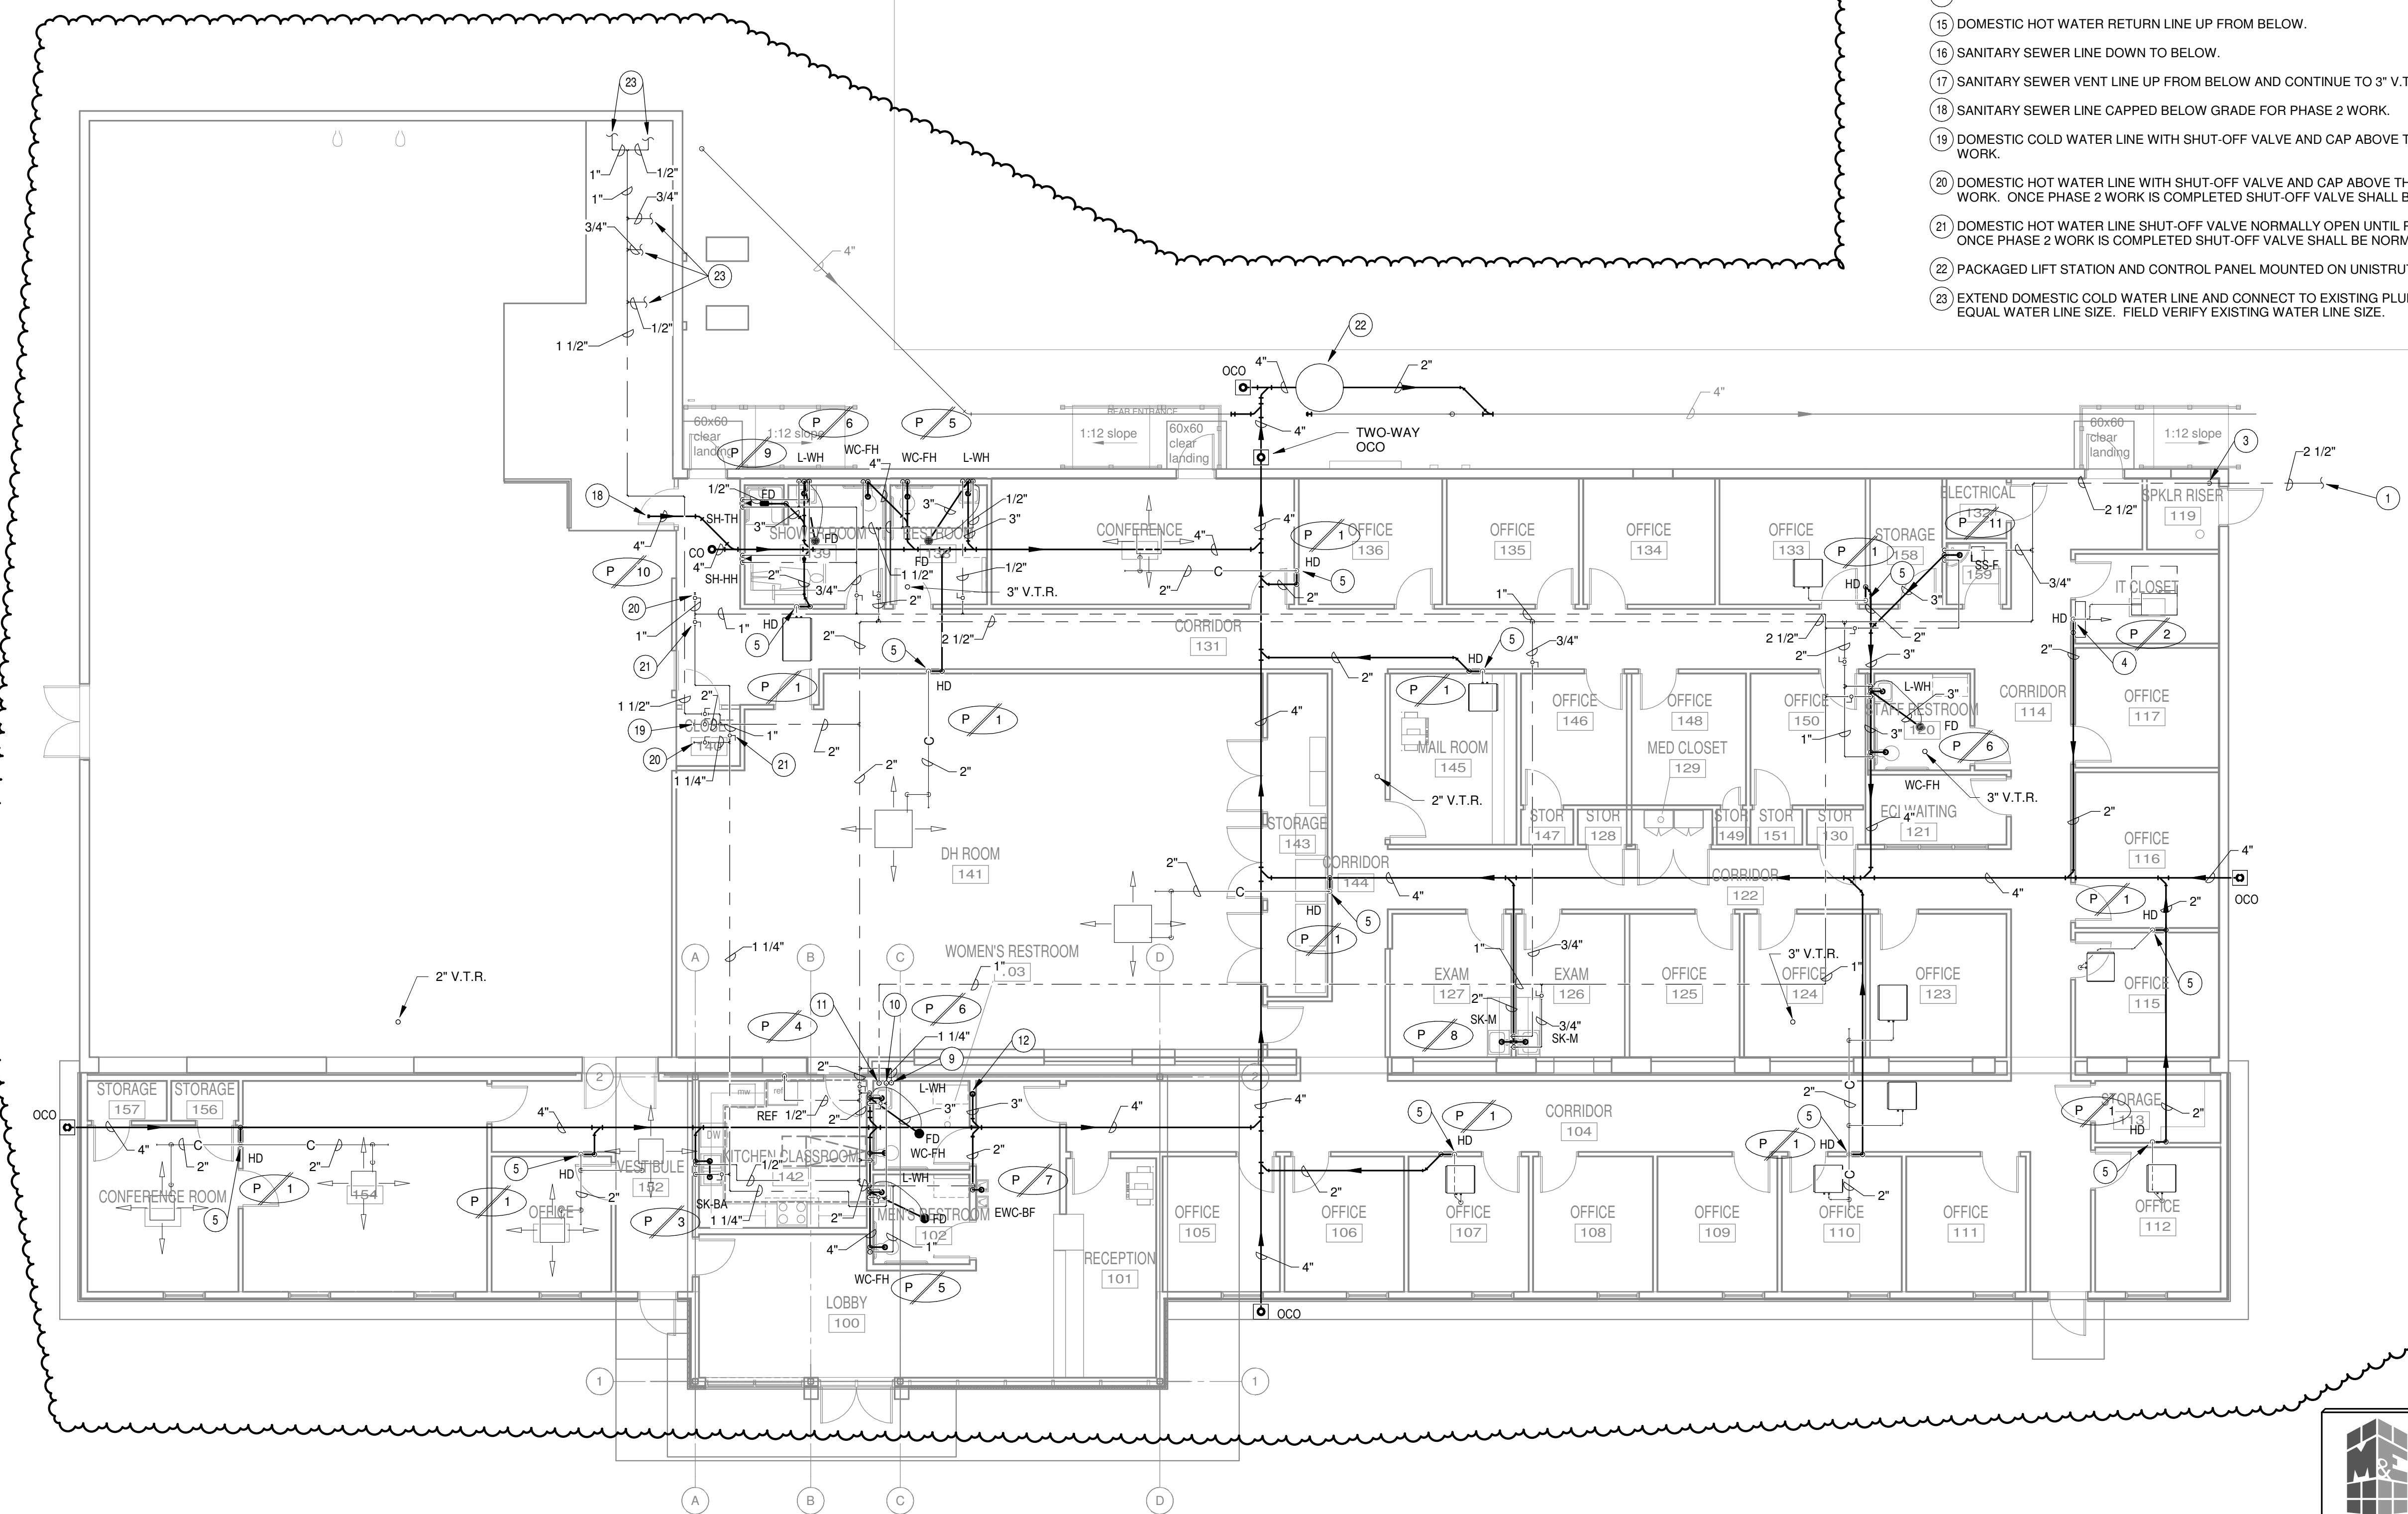

1 Plumbing Plan
 1/8" = 1'-0" Refer to Architectural Drawings for All Dimensions


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 PROJECT No.: 21167.00

NOTE: PROVIDE CAST IRON NO HUB PIPE AND FITTINGS WITH STAINLESS STEEL / NEOPRENE CLAMPS AT ALL RETURN AIR PLENUM LOCATIONS.

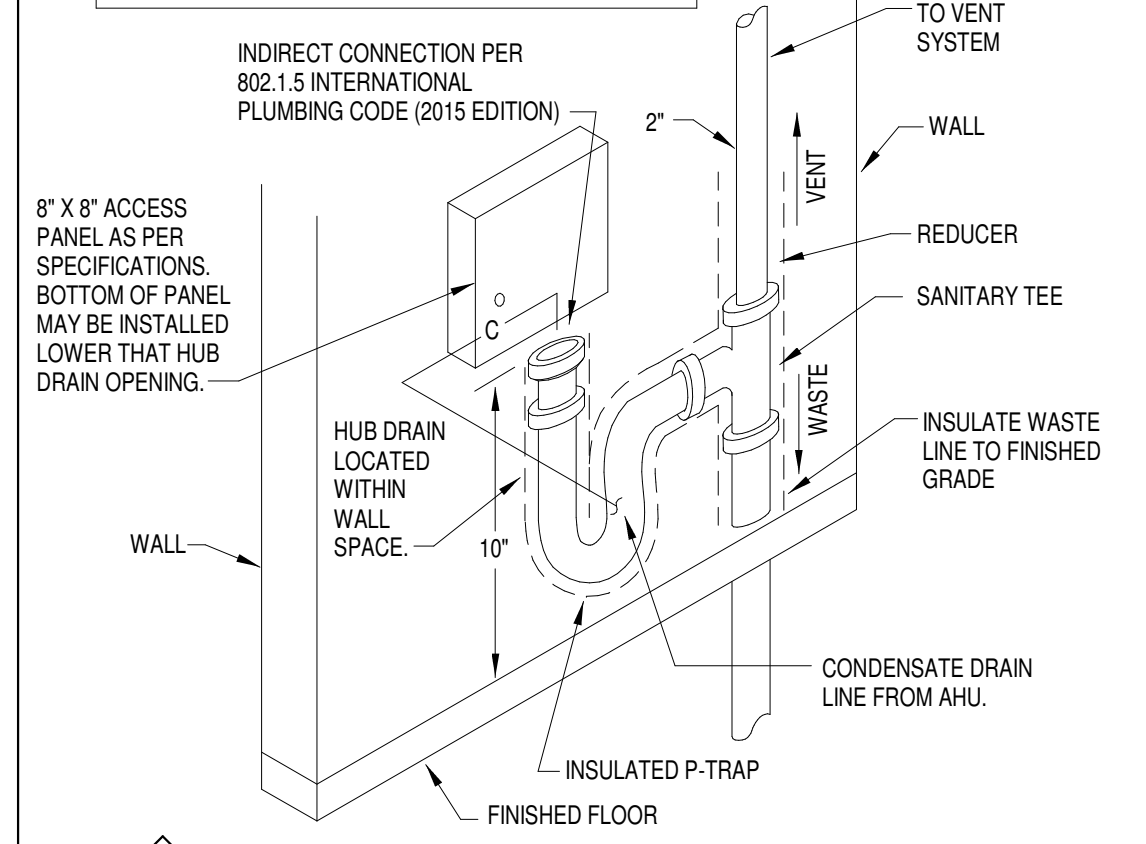


1 CONCEALED HUB DRAIN DETAIL
NO SCALE


NOTE: PROVIDE CAST IRON NO HUB PIPE AND FITTINGS WITH STAINLESS STEEL / NEOPRENE CLAMPS AT ALL RETURN AIR PLENUM LOCATIONS.

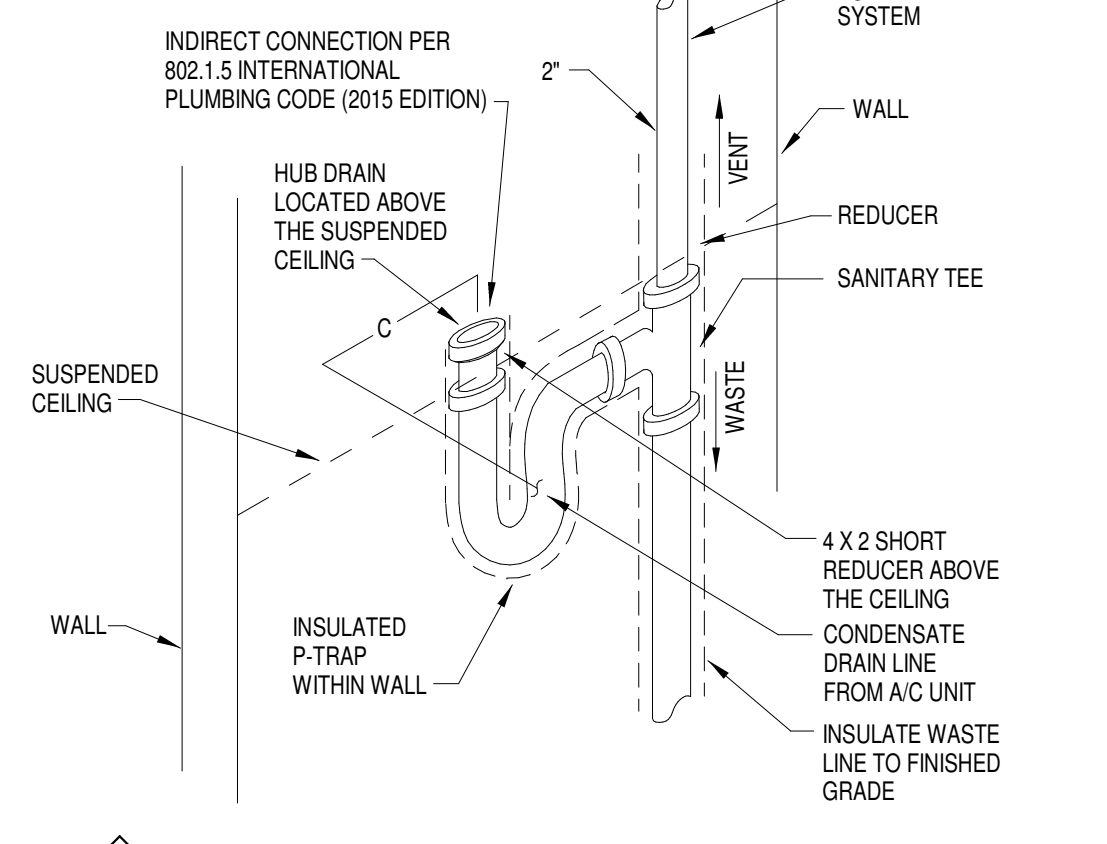


2 CONCEALED HUB DRAIN DETL.
NO SCALE

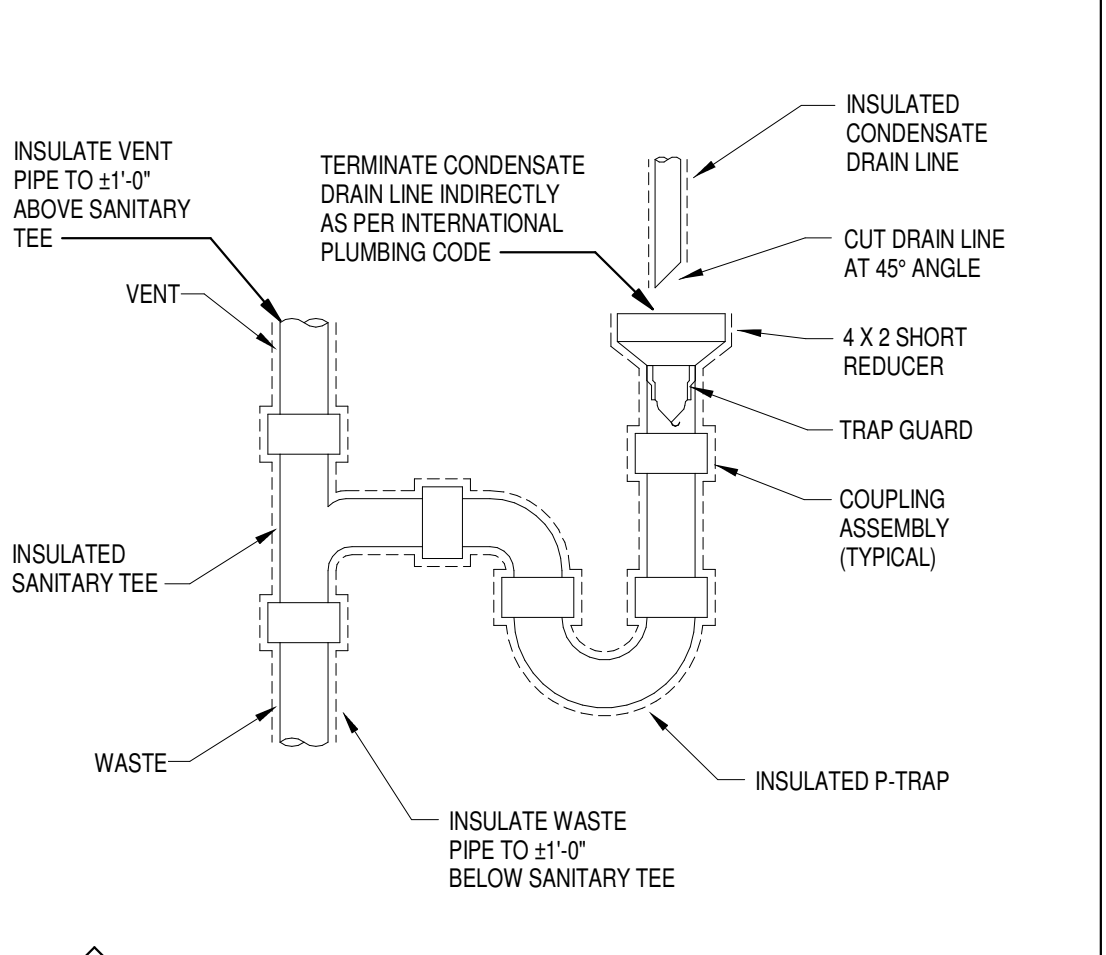


3 HUB DRAIN DETAIL
NO SCALE

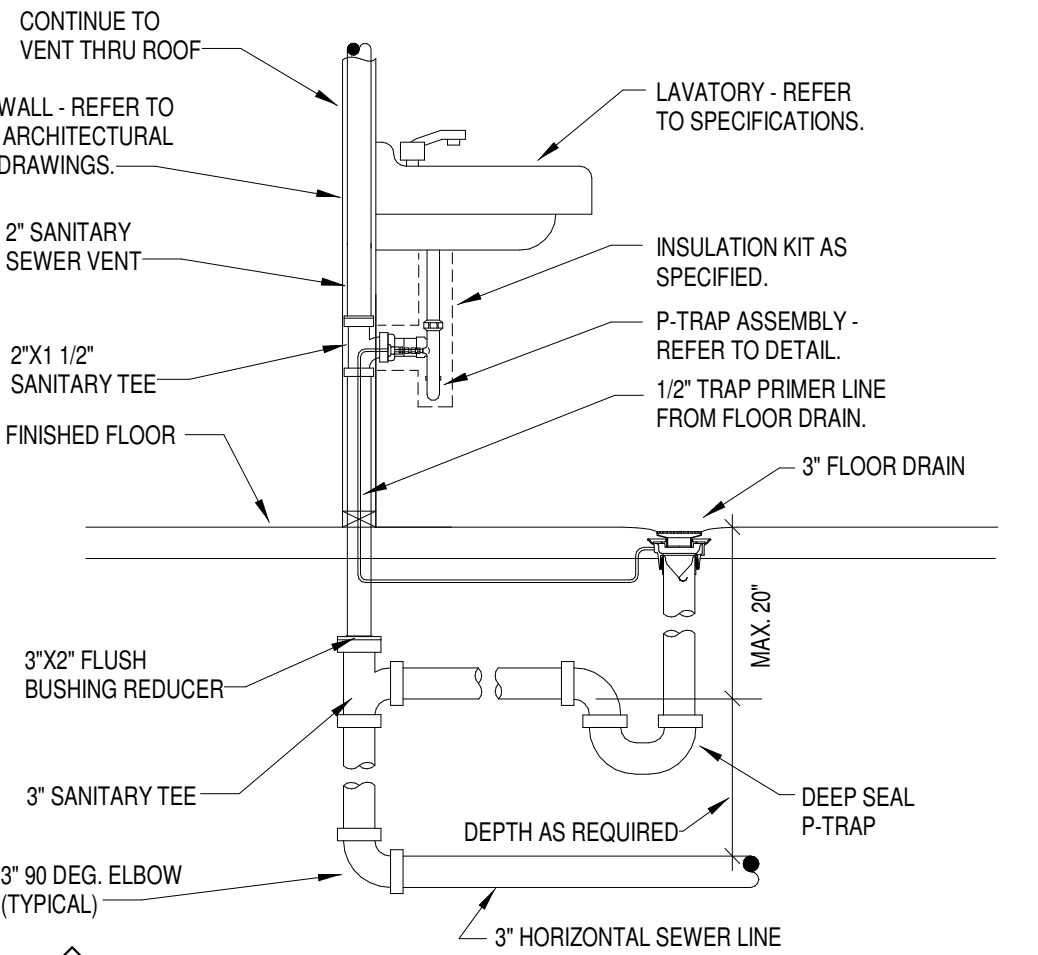


4 FLOOR DRAIN TRAP PRIMER DETAIL
NO SCALE

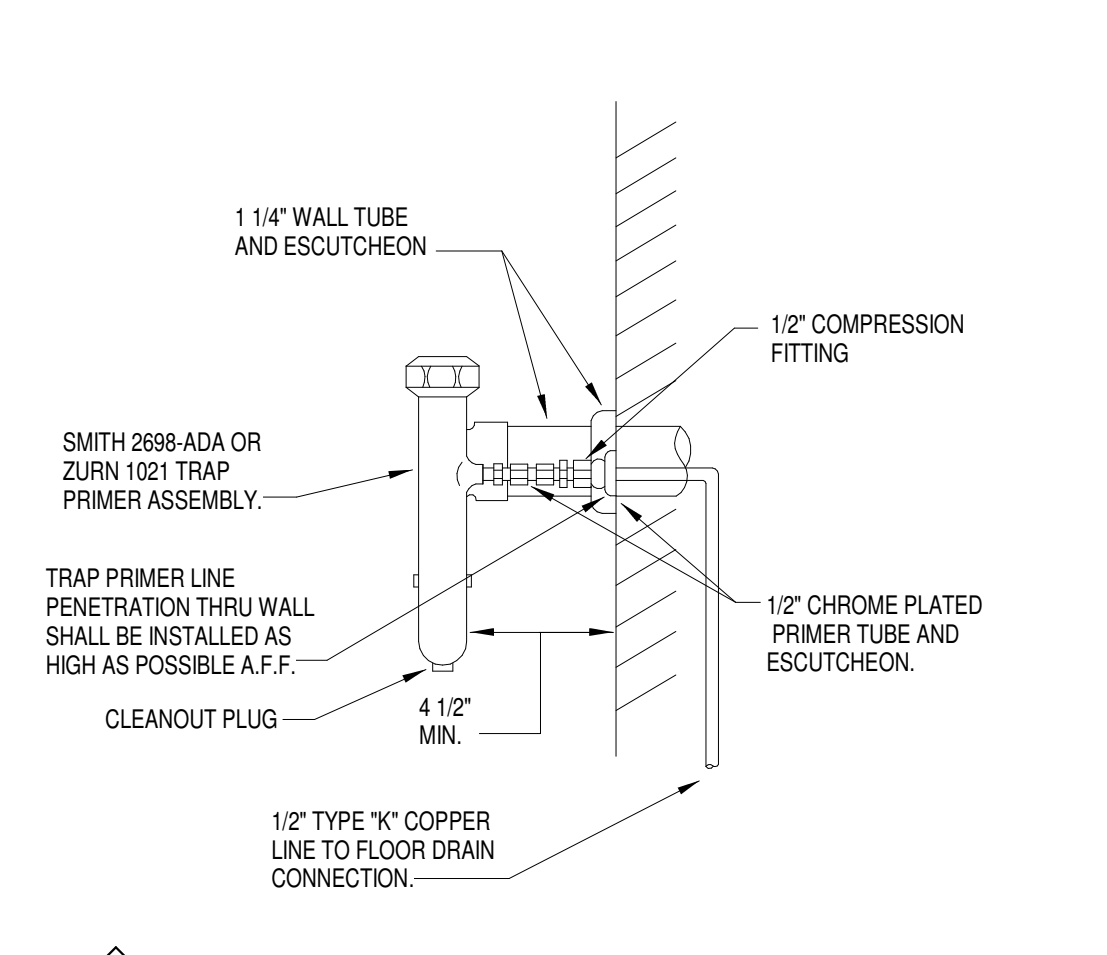


5 TRAP PRIMER DETAIL
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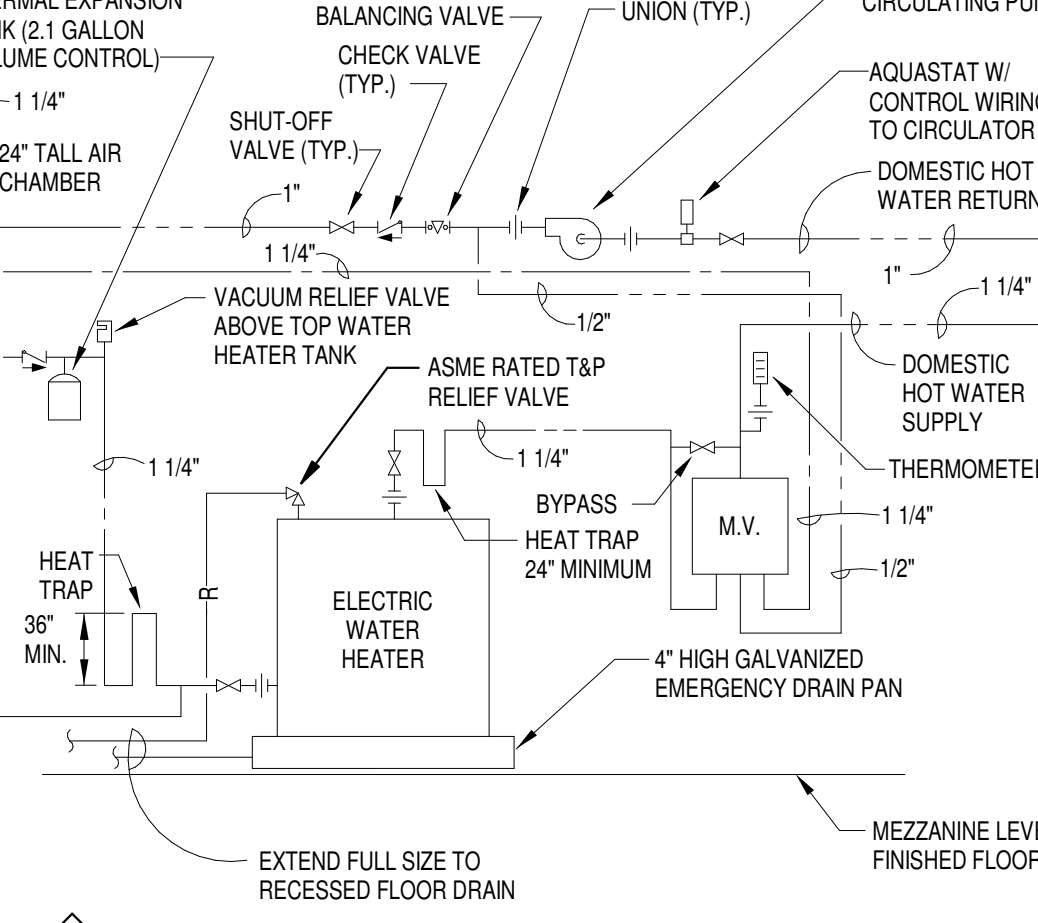
6 WATER VALVE BOX DETAIL
NO SCALE

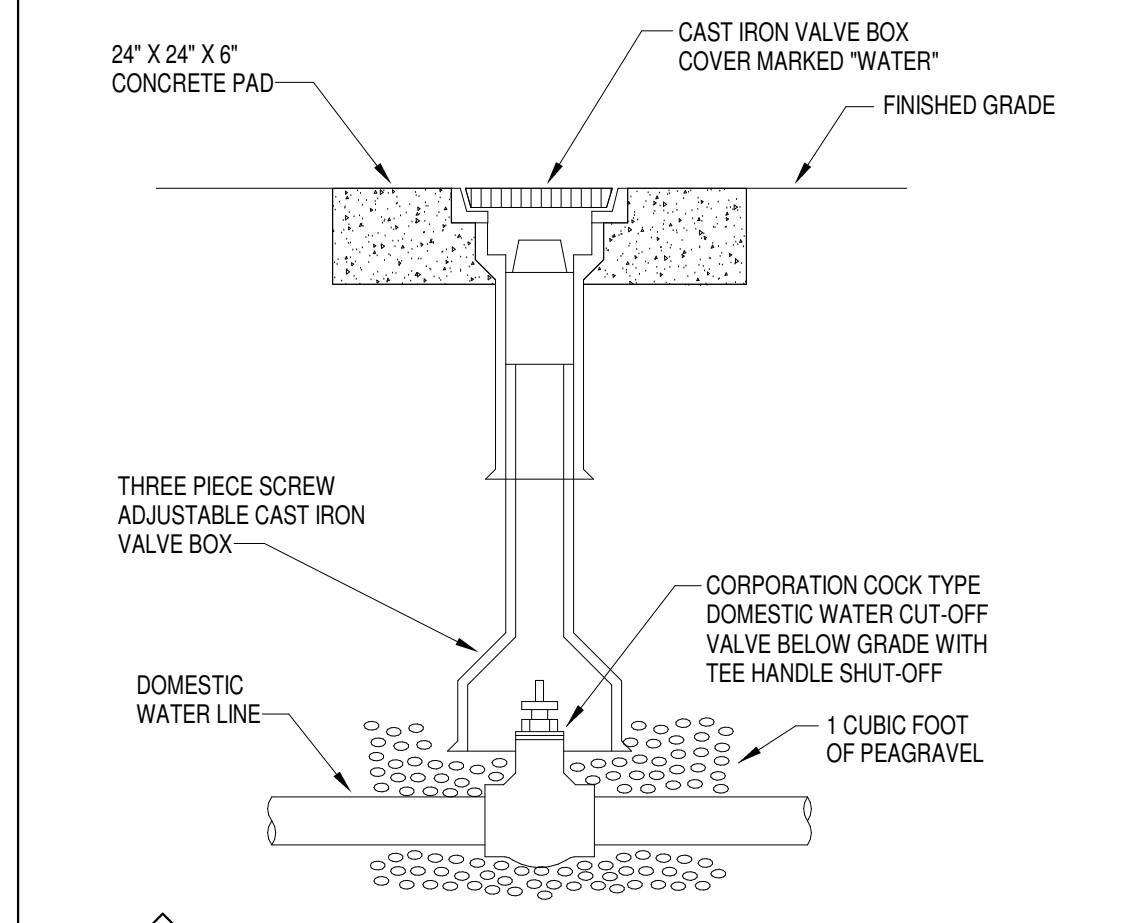


7 OUTSIDE CLEANOUT DETAIL
NO SCALE

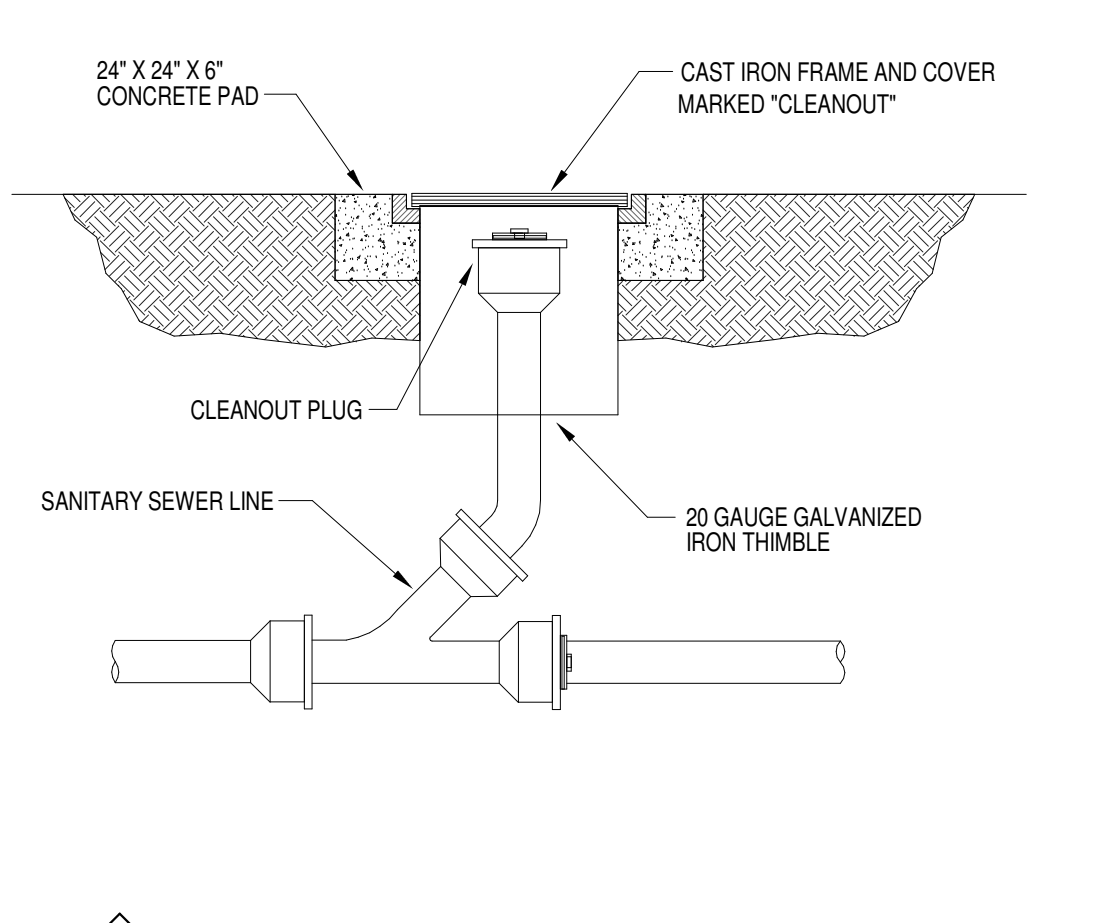

8 TWO-WAY OUTSIDE CLEANOUT DETAIL
NO SCALE

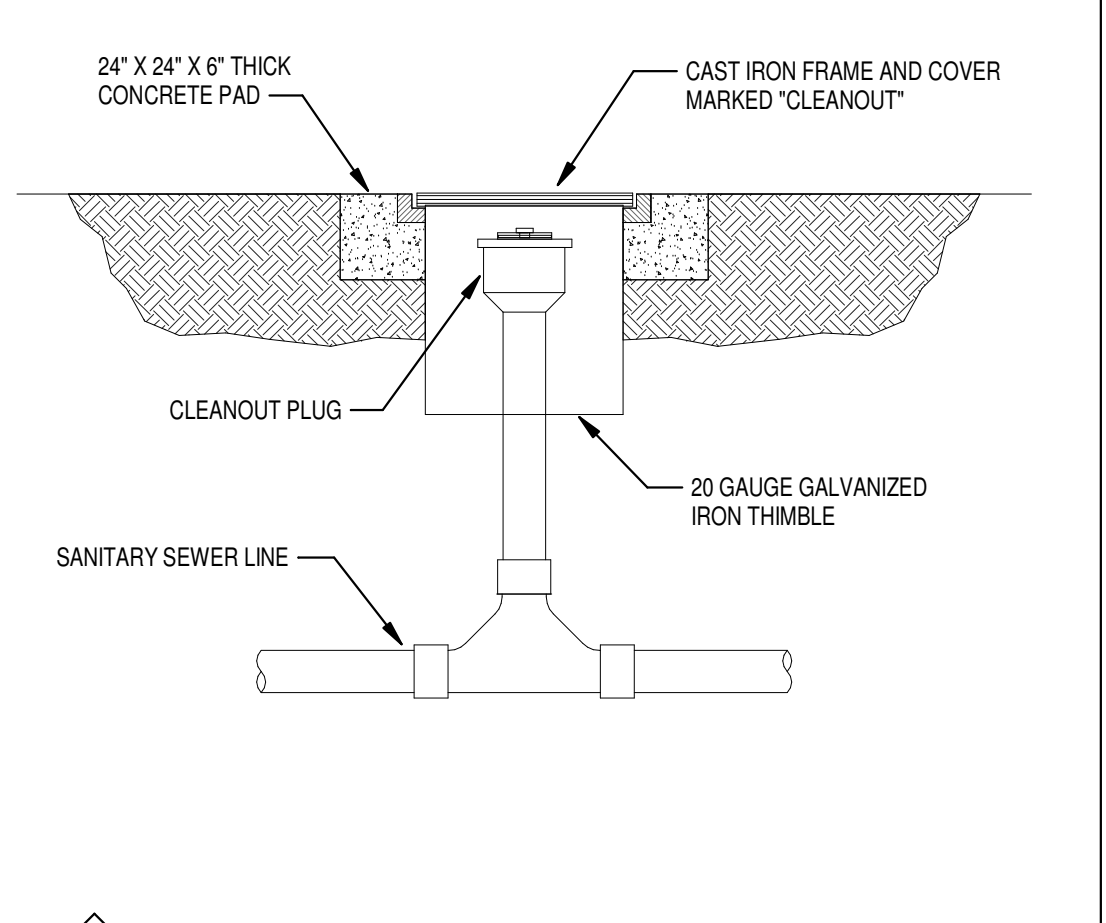


9 WATER HEATER PIPING DETAIL
NO SCALE

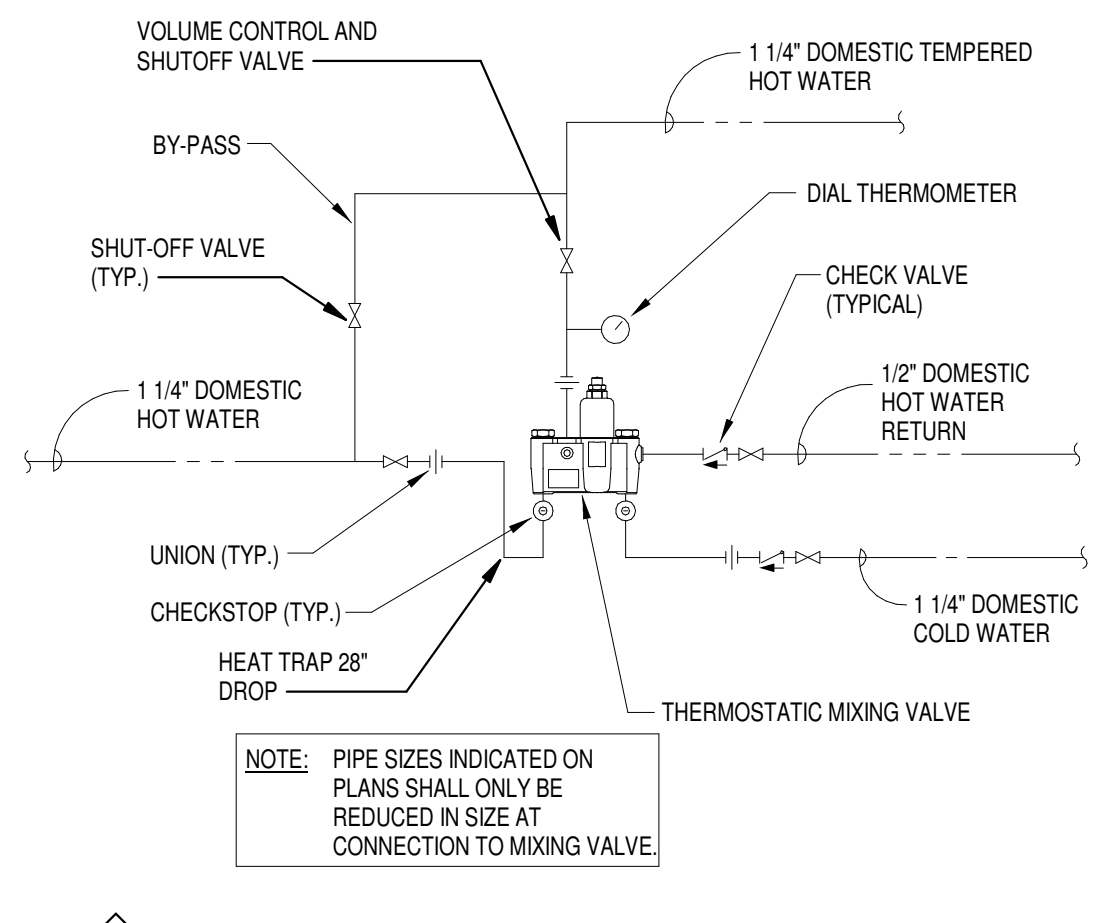


10 THERMOSTATIC MIXING VALVE DETAIL
NO SCALE


NOTE: MAXIMUM PIPE HANGER SPACING SHALL BE 10 FEET. SNAP 'N' SHIELD SADDLES FOR CLEVIS HANGERS BY EASTON. B-LINE SERIES SHALL BE USED IN LIEU OF SHEET METAL SADDLES AT CONTRACTORS OPTION.

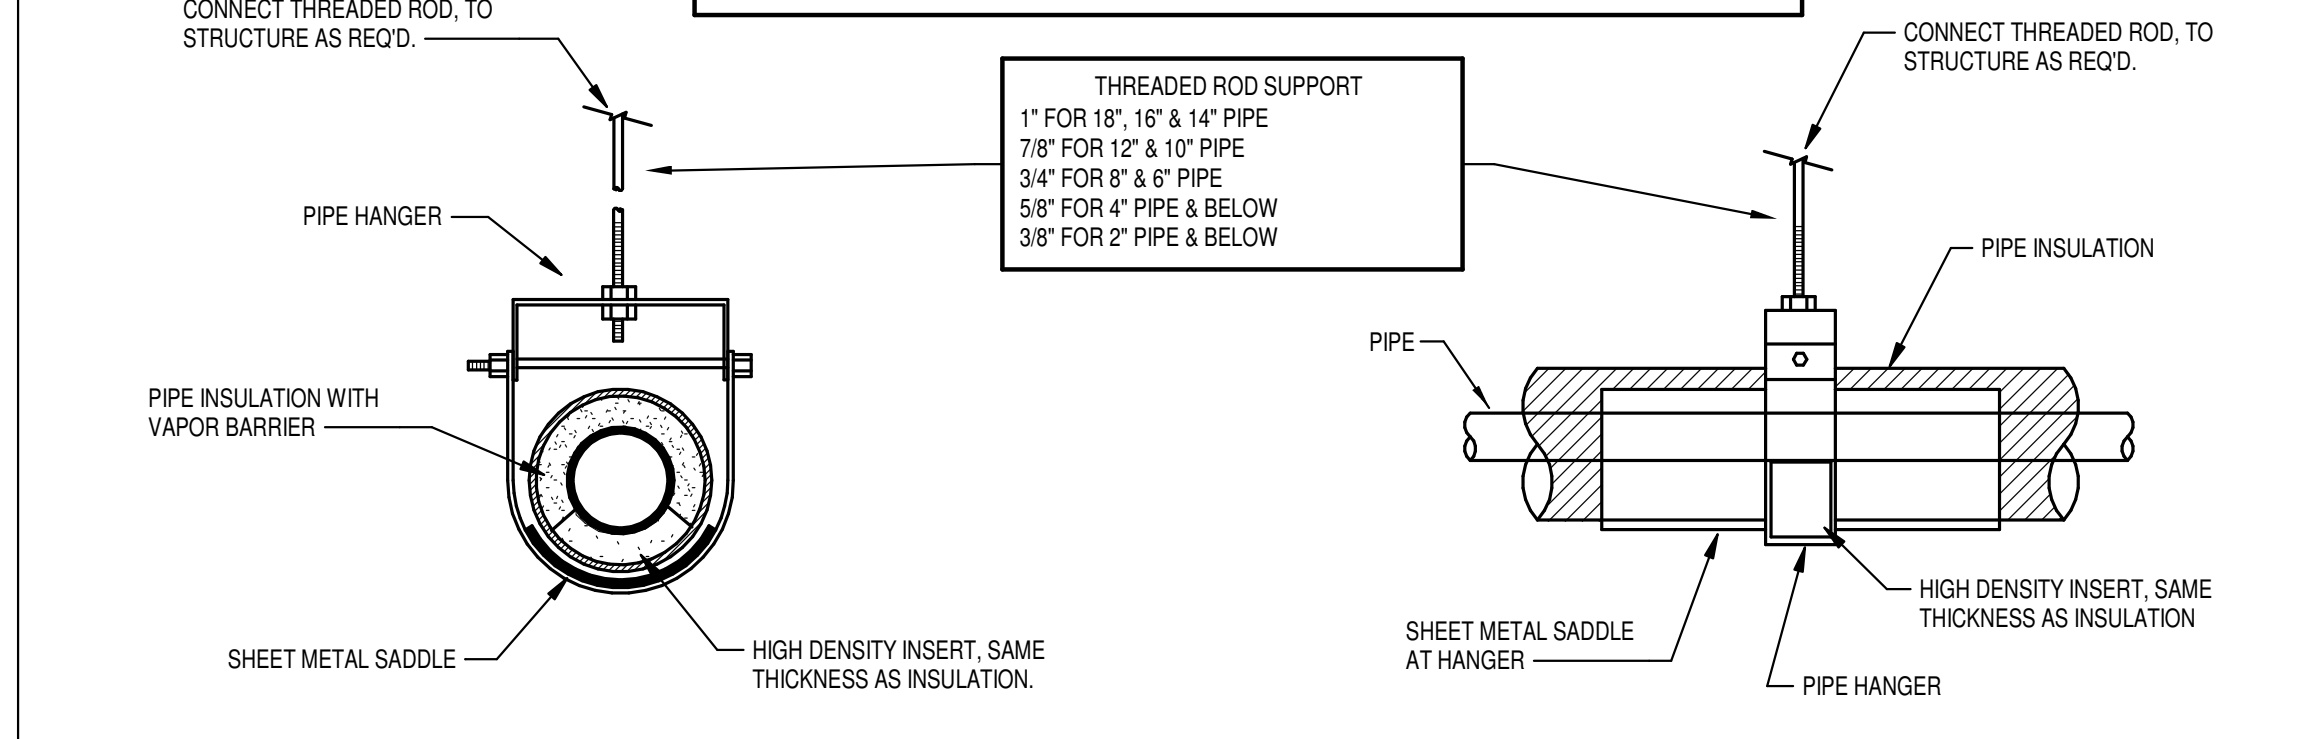


11 INSULATED PIPE HANGER DET.
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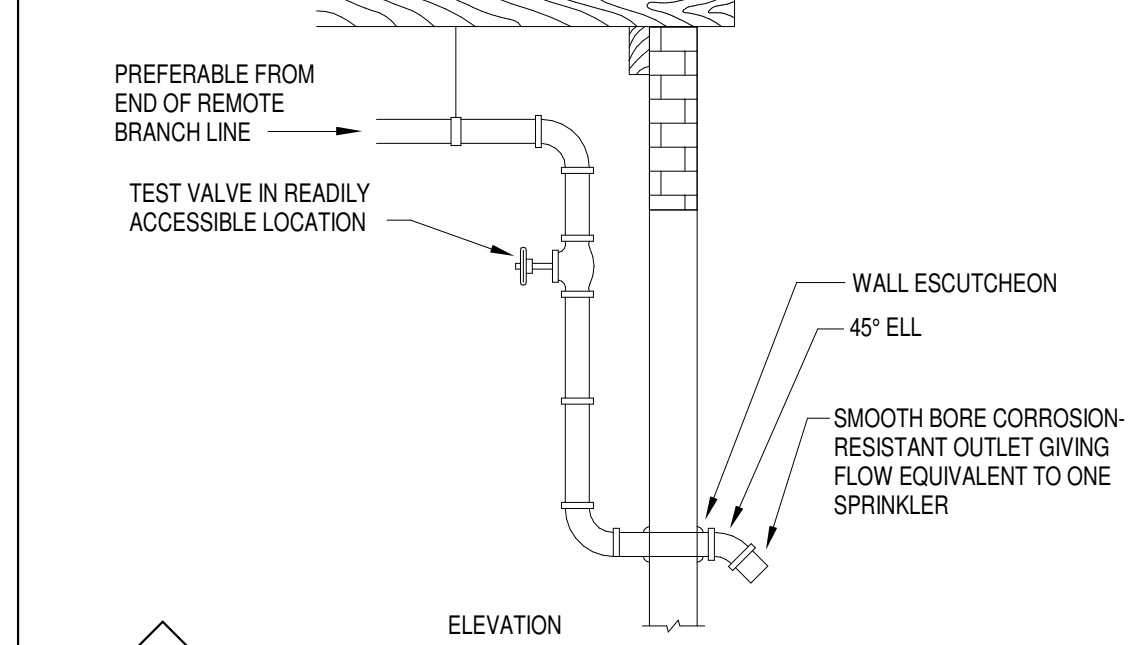
12 FLANGE AND SPIGOT ASSEMBLIES
NO SCALE

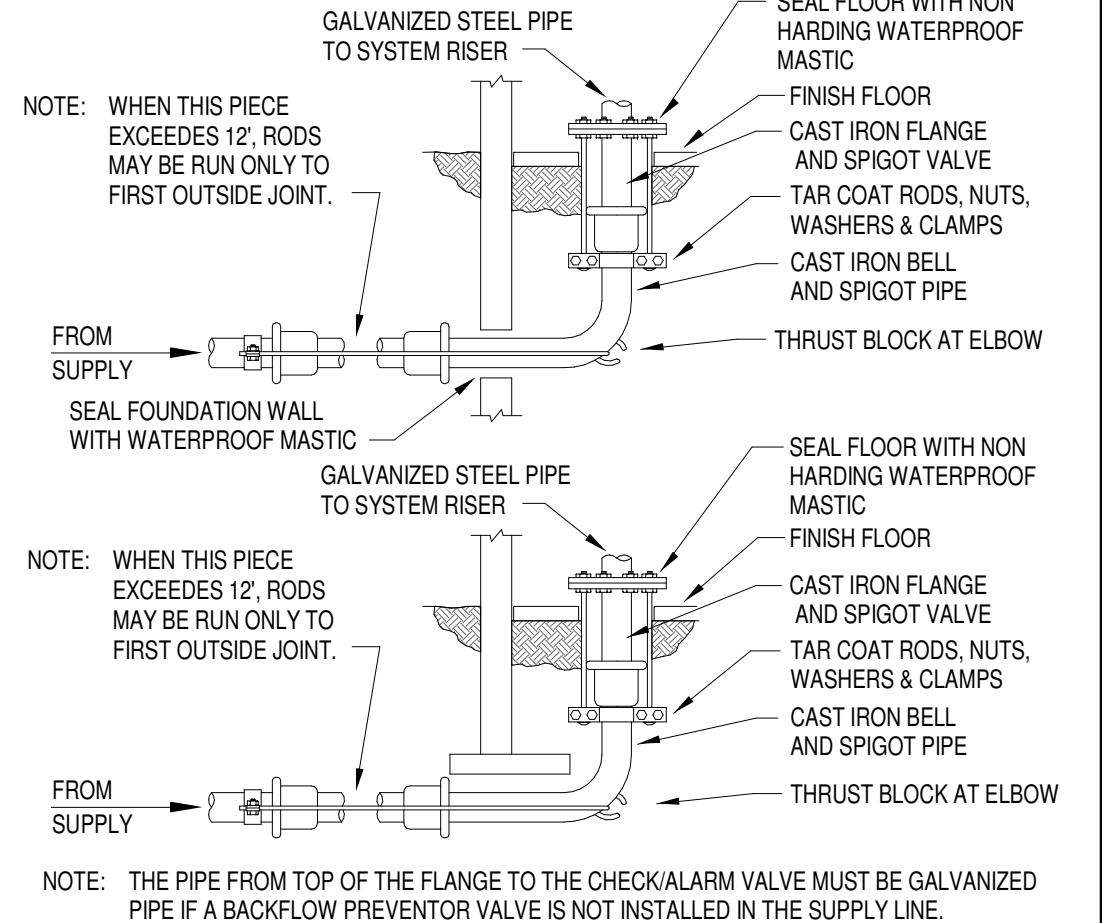


13 SPRINKLER ENTRY DETAIL
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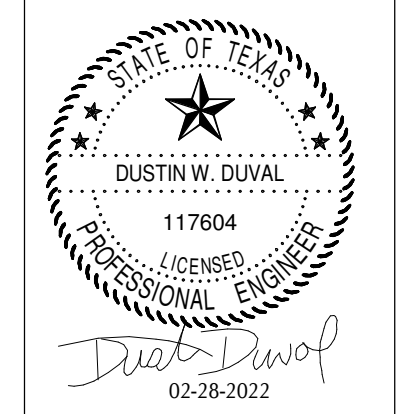
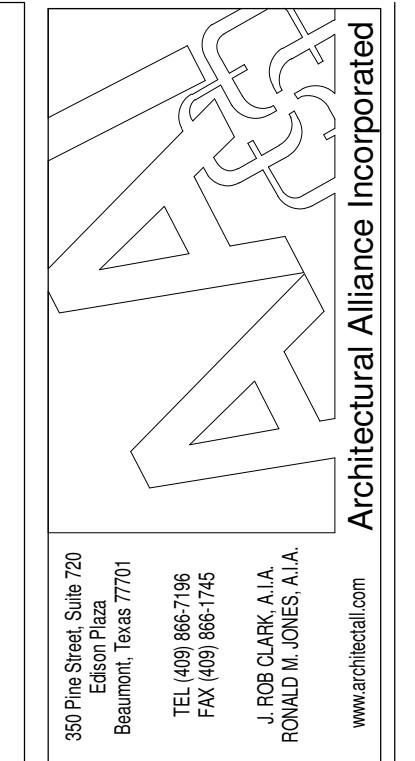
14 FREE STANDING FIRE DEPARTMENT CONNECTION
NO SCALE

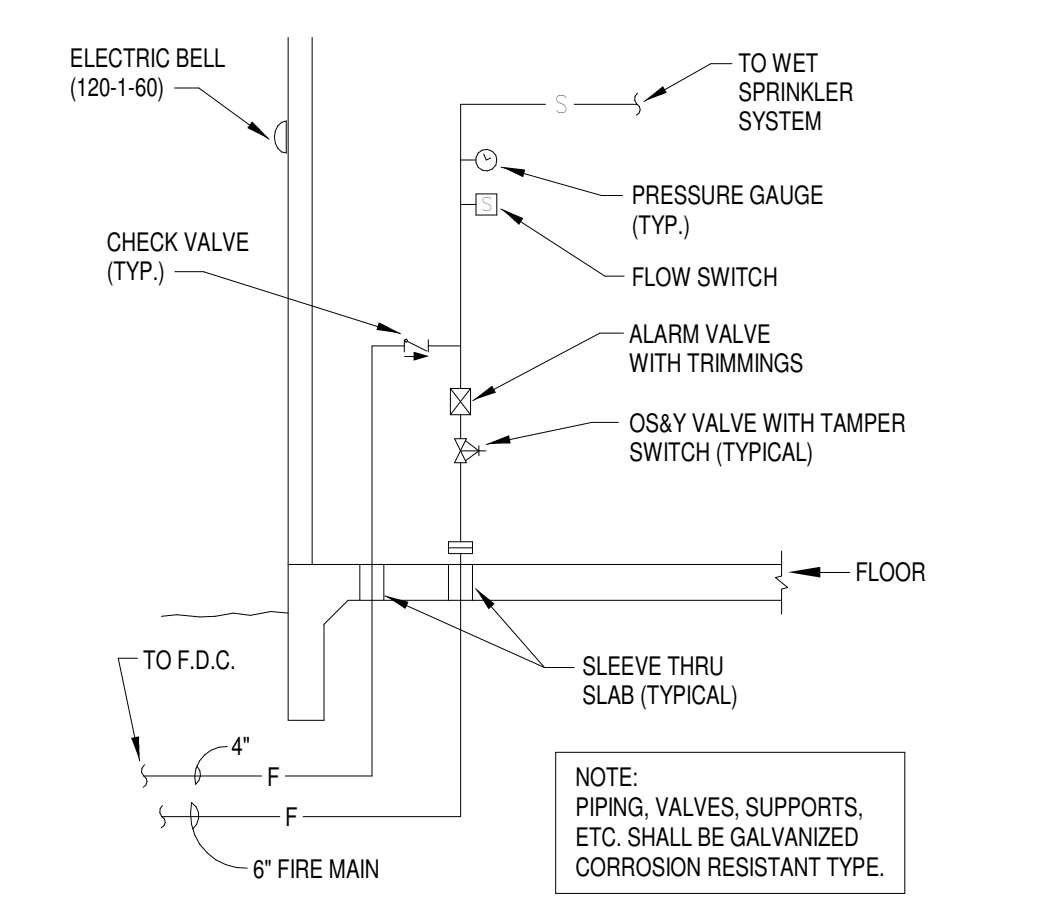

15 SYSTEM TEST CONNECTION ON WET PIPE SYSTEM
NO SCALE

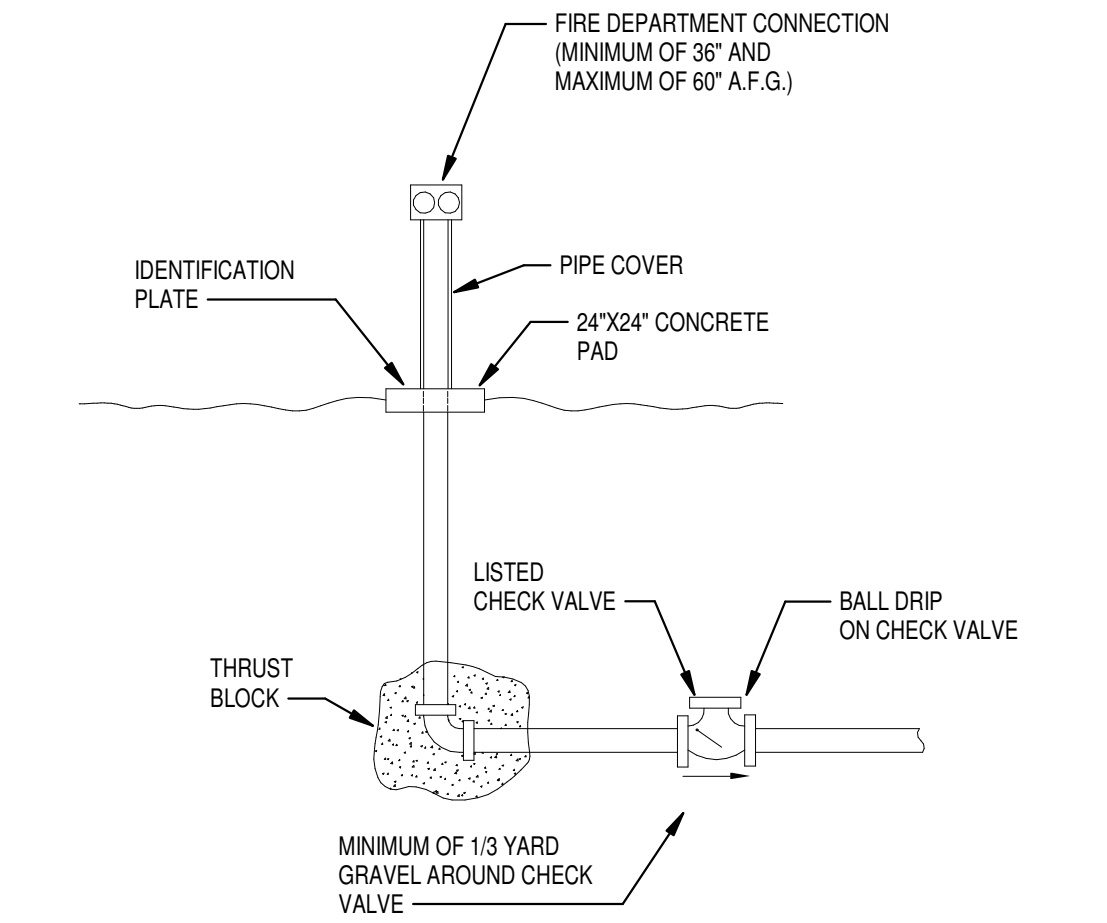

16 FIRE PENETRATION DETAIL
NO SCALE

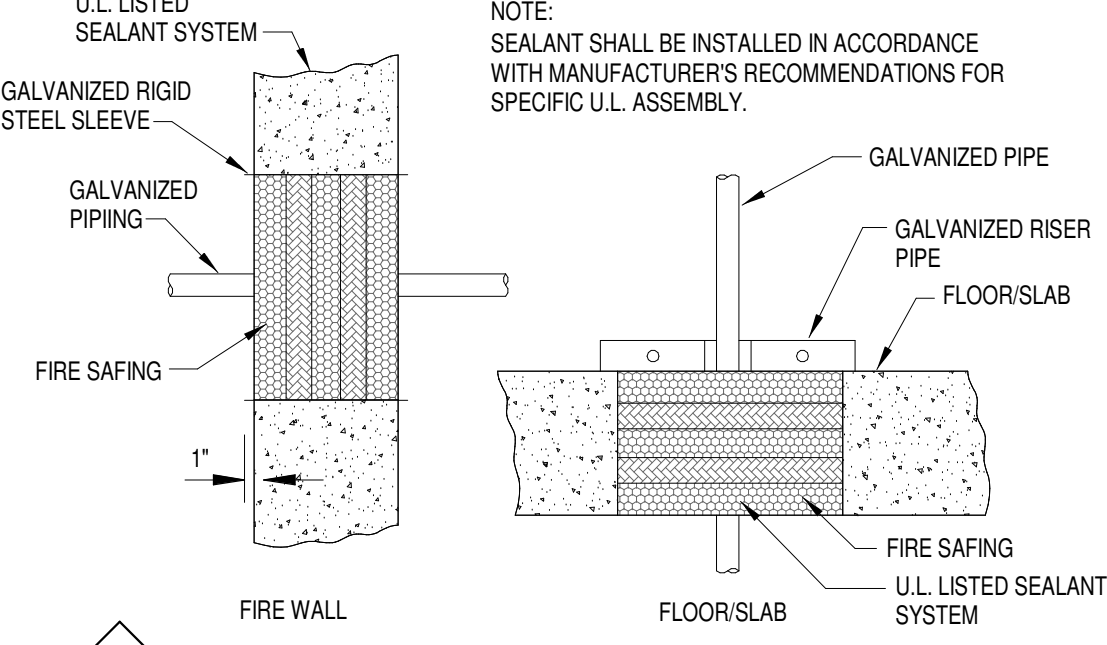

SPINDLETOP SILSBEE
Spindletop MHR
Silsbee, TX 77656
222 Durbin Dr.

ISSUED FOR SCHEMATIC DESIGN
DATE: _____
DESIGN DEVELOPMENT
DATE: _____
BIDS & CONSTRUCTION
DATE: 02/28/2022
REVISION: _____
DATE: _____
REVISION: _____
DATE: _____
REVISION: _____
DATE: _____

DRAWINGS SHEET TITLE
PLUMBING & FIRE PROTECTION DETAILS
SHEET NUMBER
P400
21061
PROJECT NUMBER



PLUMBING FIXTURE SCHEDULE

LABEL	FIXTURE TYPE	MANUFACTURER	PIPE CONNECTION				SPECIFICATION
			C.W.	H.W.	WASTE	VENT	
CO	FLOOR CLEANOUT	ZURN 1400, WADE W-6000, MIFAB C1100-R OR J.R. SMITH 4031 (NB) WITH ADJUSTABLE SCORIATED SECURED NICKEL BRONZE TOP.	-	-	4"	-	FLOOR CLEANOUTS SHALL BE AN ADJUSTABLE TYPE WITH ANCHOR FLANGE FOR CLAMP DEVICE, CLAMPING COLLAR AND NICKEL BRONZE COVER. CONTRACTOR SHALL INSTALL 2" LEAD FLASHING A MINIMUM OF 18" ALL AROUND CLEANOUT AND FLASH INTO FLANGE AND ANCHOR WITH CLAMPING COLLAR.
EWC-BF	ELECTRONIC WATER COOLER WITH BOTTLE FILLING STATION	ELKAY EZSTL8WSSK, OASIS PGF8BFSL	1/2"	-	2"	2"	TWO LEVEL WALL MOUNTED ELECTRIC WATER COOLER FOR ADULTS AND OR CHILD USE. BOTTLE FILLING UNIT SHALL INCLUDE AN ELECTRONIC SENSOR FOR NO-TOUCH ACTIVATION WITH AN AUTOMATIC 30 SECOND SHUT-OFF TIMER. COOLER UNIT SHALL HAVE PUSHBAR ACTIVATION AND WATER-EFFICIENT STREAM-SAVER BUBBLER AND WATER SENTRY PLUS FILTER WITH VISUAL MONITOR TO INDICATE WHEN REPLACEMENT IS NECESSARY. BOTTLE FILLING UNIT SHALL MEET ADA GUIDELINES FOR PARALLEL APPROACH. UNIT SHALL PROVIDE A CAPACITY OF 8.0 GPH OR 50°F WATER AT A ROOM TEMPERATURE OF 90°F AND INLET WATER TEMPERATURE OF 80°F; 3/8" ANGLE SUPPLIES WITH STOP AND 1-1/4" CAST BRASS P-TRAP WITH CLEANOUT PLUG. FINISH TO BE STAINLESS STEEL. UNIT SHALL BE COMPLETE WITH WADE 440-AM11 (MIFAB MC-33-2, JOSAM 17560-WCBL) UNIVERSAL HANGER PLATE CARRIER WITH THREE PIPE UPRIGHTS, TWO HANGER PLATES AND TWO BOTTOM BEARING PLATES, WELDED BASE FEET AND SUPPORT HARDWARE. REFER TO ARCHITECTURAL DRAWINGS FOR MOUNTING HEIGHT. INSTALL PER A.D.A. REQUIREMENTS. CAULK AROUND PERIMETER OF FIXTURE.
FD	FLOOR DRAIN	JOSAM SERIES 30000, WADE W-1100-A6-1, J. R. SMITH 2010A, MIFAB F1100-C, ZURN 415-BZ OR EQUIVALENT	-	-	3"	2"	BOTTOM OUTLET WITH DURA-COATED CAST IRON BODY. WITH CLAMPING COLLAR AND 6" DIAMETER NICKEL BRONZE STRAINER ADJUSTABLE VERTICALLY TO FLOOR LEVEL WITH SQUARE PERFORATIONS AND VANDAL-PROOF SCREWS. PROVIDE TRAP PRIMER CONNECTION WHERE SHOWN ON PLANS. PROVIDE SURESEAL MODEL SS3000V (MIFAB MI-GARD-3) FLOOR DRAIN TRAP SEALER FOR 3" DIAMETER DRAIN (ASSE 1072) WHERE TRAP PRIMER LINE IS NOT SHOWN CONNECTING TO THE FLOOR DRAIN ON THE PLANS. COORDINATE FINAL ROUGH-IN ELEVATION WITH FINISHED FLOOR. REFER TO ARCHITECTURAL DRAWINGS FOR ADDITIONAL INFORMATION.
FD-R	FLOOR DRAIN RECESSED GRATE	JOSAM SERIES 30000, WADE W-1100-ER7-1, J. R. SMITH 2010A, MIFAB F1100-C, ZURN 415-BZ OR EQUIVALENT	-	-	3"	2"	SHALL BE SAME AS "FD", EXCEPT SUPPLIED WITH 1" RECESSED GRATE. JOSAM TYPE "E-1", WADE W-1100-ER7, J. R. SMITH 2010-F37, MIFAB F1100-C-ER WITH TOP OF RIM SET PRIMER LINE IS NOT SHOWN CONNECTING TO THE FLOOR DRAIN ON THE PLANS.
HD	LAVATORY	KOHLER K-1721, AMERICAN STANDARD 0356.421	1/2"	1/2"	2"	2"	WALL HUNG, 20" X 18", WHITE, VITREOUS CHINA, WALL MOUNTED LAVATORY WITH SINGLE HOLE. CHICAGO 333-665PSHBCP (ZURN Z-86100-XL, A.S. 1340.105.002) CAST BRASS BODY, DECK MOUNTED SINGLE HOLE SINGLE SUPPLY PUSH BUTTON MANUAL METERING FAUCET, WITH MCGUIRE 155WC (KOHLER K-13885) OFFSET TAILPIECE WITH PERFORATED GRATE DRAIN, MCGUIRE 8872 (KOHLER K-8998) 1-1/4" CAST BRASS P-TRAP WITH CLEANOUT PLUG, 3/8" ANGLE SUPPLIES WITH STOPS, AND JOSAM, WADE 520 CONCEALED ARM FLOOR ANCHORED CARRIER. PROVIDE J.R. SMITH 2698-ADA PRIME-EZE, ZURN Z1021-ADA OR EQUAL WATER SAVER TRAP PRIMER WHERE INDICATED ON PLANS. TRUEBRO MODEL 103, (ZURN Z8946-3-NT) INSULATING KIT. INSTALL PER A.D.A. REQUIREMENTS. CAULK AROUND PERIMETER OF FIXTURE. PROVIDE LAWLER 570 (LEONARD 170-LF, WATTS LFUSG-B SERIES) THERMOSTATIC MIXING VALVE, 3/8" INLETS & OUTLET CONNECTIONS, TEMPERATURE CONTROL DEVICE THAT CONFORMS TO ASSE 1070.
L-WH	LAVATORY	KOHLER K-1729, AMERICAN STANDARD 0124.131	1/2"	1/2"	2"	2"	WALL HUNG, 20" X 18", WHITE, VITREOUS CHINA, WALL MOUNTED LAVATORY WITH 4" FAUCET CENTERS. DELTA 22C101 (ZURN Z-81000-CP4, A.S. 6114.111.002) CAST BRASS BODY, CERAMIC DISC CARTRIDGE, SINGLE HANDLE FAUCET WITH MCGUIRE 155WC (KOHLER K-13885) OFFSET TAILPIECE WITH PERFORATED GRATE DRAIN; MCGUIRE 8872 (KOHLER K-8998) 1-1/4" CAST BRASS P-TRAP WITH CLEANOUT PLUG, 3/8" ANGLE SUPPLIES WITH STOPS, AND JOSAM, WADE 520 CONCEALED ARM FLOOR ANCHORED CARRIER. PROVIDE J.R. SMITH 2698-ADA PRIME-EZE, ZURN Z1021-ADA OR EQUAL WATER SAVER TRAP PRIMER WHERE INDICATED ON PLANS. TRUEBRO MODEL 103, (ZURN Z8946-3-NT) INSULATING KIT. INSTALL PER A.D.A. REQUIREMENTS. CAULK AROUND PERIMETER OF FIXTURE. PROVIDE LAWLER 570 (LEONARD 170-LF, WATTS LFUSG-B SERIES) THERMOSTATIC MIXING VALVE, 3/8" INLETS & OUTLET CONNECTIONS, TEMPERATURE CONTROL DEVICE THAT CONFORMS TO ASSE 1070.
OCO	FLOOR CLEANOUT	J.R. SMITH, JOSAM, MIFAB, ZURN, WADE	-	-	4"	-	OUTSIDE CLEANOUTS SHALL BE AS DETAILED ON THE PLANS.
REF	REFRIGERATOR	OATEY 38681, SPECIALTY PRODUCTS P4129	1/2"	-	-	-	WALL RECESSED BOX WITH CHROME PLATED 1/2"x1/4" ANGLE STOP WITH SUPPLY
SH-HH	SHOWER HAND HELD SHOWER HEAD	BRADLEY 1C-EF-B24, ZURN Z-7101-SS-MT-LH-HW, AMERICAN STANDARD 1662.223.002	1/2"	1/2"	3"	2"	CONCEALED IN-WALL MULTICHOICE UNIVERSAL PRESSURE BALANCE MIXING VALVE, HEAVY DUTY FORGED BRASS VALVE BODY, INTEGRAL SCREWDRIVER STOPS, VANDAL RESISTANT A.D.A. BLADE HANDLE, COLOR CODED NON-REMOVABLE MARKING ON ESCUTCHEON, HAND HELD SHOWER WITH 60" STAINLESS STEEL FLEXIBLE HOSE, 24" METAL SLIDE MOUNTING BAR FOR MOUNTING HAND HELD SHOWER AND ASSE VACUUM BREAKER. REFER TO ARCHITECTURAL SPECIFICATIONS FOR TILE FLOOR & WALLS, GRAB BARS, ACCESSORIES, ETC.
SH-TH	SHOWER	DELTA R10700-UNWS with T13H153 valve trim, BRADLEY 1C-EF-SF-B24-DV, ZURN Z-7101-SS-MT-LH-DV-2P-HW-S3, AMERICAN STANDARD 1662.223.002	1/2"	1/2"	3"	2"	CONCEALED IN-WALL MULTICHOICE UNIVERSAL PRESSURE BALANCE MIXING VALVE, HEAVY DUTY FORGED BRASS VALVE BODY, INTEGRAL SCREWDRIVER STOPS, WITH T13H153 VALVE TRIM, VANDAL RESISTANT A.D.A. BLADE HANDLE, COLOR CODED NON-REMOVABLE MARKING ON ESCUTCHEON, HAND HELD SHOWER WITH 70" VINYL HOSE, 24" SLIDE MOUNTING BAR FOR MOUNTING HAND HELD SHOWER AND ASSE VACUUM BREAKER, AND IN-WALL DIVERTER VALVE; FLOOR DRAIN "FD", 3" DRAIN OUTLET, NICKEL BRONZE FINISH GRID STRAINER. REFER TO ARCHITECTURAL SPECIFICATIONS FOR TILE FLOOR & WALLS, FOLDING SEAT, GRAB BARS, ACCESSORIES, ETC.
SK-BA	SINK	ELKAY LRAD-3319653, JUST DL-ADA-1933-A-GR	1/2"	1/2"	2"	2"	SELF RIMMING, 33" X 19" X 6.5", DOUBLE COMPARTMENT, OFF-CENTER REAR DRAIN OPENING, 18 GAUGE, TYPE 304 SELF RIMMING SINK WITH LK810GN08T4 (Zurn 871C4-XL, A.S. 6409.170.002) 8" REACH GOOSENECK FAUCET WITH 4" WRIST BLADE HANDLES, LK-99 (JUST JB-99) STAINLESS STEEL BASKET STRAINERS, MCGUIRE 8912 1-1/2" CAST BRASS P-TRAP WITH CLEANOUT PLUG, CONTINUOUS WASTE PIPING AND 3/8" ANGLE SUPPLIES WITH STOPS. PROVIDE DISHWASHER DRAIN CONNECTION FOR DISHWASHER HOSE CONNECTION. CAULK AROUND PERIMETER OF FIXTURE.
SK-M	SINK	ELKAY LR-1919, JUST SL-2019-A-GR	1/2"	1/2"	2"	2"	SELF RIMMING, 19" X 19" X 7.5", SINGLE COMPARTMENT, 18 GAUGE, TYPE 304 STAINLESS STEEL, SELF RIMMING SINK WITH 8" FAUCET CENTERS; ZURN Z831B4-XL-18F (T & S BRASS B-2867-04 WITH B-0199-21, A.S. 6530.170.LV15.002) 5-3/8" REACH RIGID GOOSENECK FAUCET WITH LAMINAR FLOW AND 4" WRIST BLADE HANDLES, LK-18B PERFORATED 3" GRID STRAINER, MCGUIRE 8912 1-1/2" CAST BRASS P-TRAP WITH CLEANOUT PLUG AND 3/8" ANGLE SUPPLIES WITH STOPS. CAULK AROUND PERIMETER OF FIXTURE.
SS-F	SERVICE SINK	FIAT MSB-2424, MUSTEE 63M	3/4"	3/4"	2"	2"	FLOOR MOUNTED, 24" X 24" X 10" WHITE MOLDED STONE MOP SERVICE BASIN WITH #1453-BB FLAT TYPE STAINLESS STEEL DRAIN, VINYL BUMPER GUARD, #830-AA (T&S BRASS B-0665-BSTR) MIXING FAUCET, #832-AA (T&S BRASS B-0654) HOSE AND STAINLESS STEEL HOSE BRACKET, #889-CC (T&S BRASS B-0653) STAINLESS STEEL MOP HANGER, #893-AA SILICONE SEALANT AND TWO (2) #MSG 2424 STAINLESS STEEL WALL GUARDS (SIDE AND BACK). CAULK AROUND PERIMETER OF FIXTURE.
WC-FH	WATER CLOSET	KOHLER K-96057, AMERICAN STANDARD 3043.001	1"	-	4"	3"	FLOOR MOUNTED, WHITE, VITREOUS CHINA, SIPHON JET, ELONGATED WATER CLOSET. K-4670-C (A.S. 5901.100, BEMIS 1955CT, BENEKE 523, CHURCH 295CT, CENTOCO 500STSCC) SOLID PLASTIC, WHITE OPEN-FRONT TOILET SEAT LESS COVER, CHECK HINGE AND WITH STA-TITE COMMERCIAL FASTENING SYSTEM, K-4562 BOLT CAP. SLOAN 111 (ZURN AQUAFUSH PLUS Z6000PL-WS1) FLUSH VALVE WITH A.D.A. COMPLIANT HANDLE ASSEMBLY, VANDAL RESISTANT STOP CAP, VACUUM BREAKER AND STOP. INSTALL PER A.D.A. REQUIREMENTS. FLUSH VALVE HANDLE TO BE ON WIDE SIDE OF STALL. INSTALL WAX SEAL BELOW FIXTURE. CAULK AROUND PERIMETER OF FIXTURE.

WATER HEATER SCHEDULE

UNIT NO.	SERVICE	CAPACITY (GALLONS)	ELECTRIC KW INPUT	TEMPERATURE SETTING	ELECTRICAL SERVICE	RECOVERY RATE @ 80°F TEMP. RISE	COMMENTS
WH-1	PHASE 1	30	TWO (2) 4.5	140°F	208-1-60	23 GPH	STATE PCE3020LSAX, RHEEM OR PRIOR ELDS30 OR PRIOR APPROVED EQUAL

NOTES: 1. HEATING ELEMENTS SHALL BE WIRE FOR NON-SIMULTANEOUS OPERATION.

MIXING VALVE SCHEDULE

UNIT NO.	SERVICE	TYPE	TEMPERATURE SETTING	BASIS OF DESIGN
MV-1	WATER HEATER WH-1	STANDARD	110°F	BRADLEY MODEL S59-2025-TBP TMV25, LEONARD TM-26-E-RF

NOTES: 1. MIXING VALVE SHALL HAVE RELIABLE LIQUID-FILLED THERMOSTAT, DIAL THERMOMETER, WALL MOUNTING BRACKET, PIPED ASSEMBLY WITH INLET AND OUTLET SHUTOFF, INTEGRAL STRAINER CHECKSTOPS ON INLETS, ADJUSTABLE SET POINT (SET @ 110°F), POSITIVE SHUTOFF OF HOT WATER WHEN COLD SUPPLY IS LOST AND DIAL THERMOMETER. INSTALL THERMOMETER DOWNSTREAM OF UNIT IN PIPING. ASSE 1017.

DOMESTIC WATER CIRCULATING PUMP SCHEDULE

UNIT NO.	SERVICE	TYPE	GPM	H.D. FT. OF WATER	RPM	MOTOR HP	VOLTAGE	PHASE	BASIS OF DESIGN
CP-1	WATER HEATER WH-1	IN-LINE	0.7	6	3450	0.17	120	1	TACO 2400-20S, B&G PL-36B OR APPROVED EQUAL

NOTES: 1. PUMP SHALL BE FURNISHED WITH ALL STAINLESS STEEL/BRONZE TRIM, AQUASTAT WITH TEMPERATURE ADJUSTABLE SETTING (SET AT 105°F) AND CONTROL WIRING INTERLOCKED WITH PUMP, CHECK VALVE AND CONTROL WIRING.

NOTES:

1. PLUMBING CONTRACTOR SHALL COMBINE AND EXTEND VENT LINES AS REQUIRED TO V.T.R. VENT THRU ROOF SHALL MAINTAIN A MINIMUM OF 10'-0" FROM OUTSIDE AIR INTAKES.
2. CONTRACTOR SHALL SEAL ALL PIPE PENETRATIONS THRU RATED WALLS WITH FIRE RATED SEALANT SYSTEMS PER MANUFACTURER'S RECOMMENDATIONS FOR SPECIFIC U.L. ASSEMBLY.
3. WATER HAMMER ARRESTER(S) SHALL BE INSTALLED ON PIPING SYSTEMS AND AT QUICK-CLOSING VALVES AS PER MANUFACTURER'S RECOMMENDATIONS.
4. ALL FLOOR DRAINS (FD & FD-R) AND HUB DRAIN (HD) SHALL BE COMPLETE WITH TRAP GUARDS PER SPECIFICATIONS.

