

Addendum No. 1

Project: Spindletop Silsbee

Spindletop Center

Date: <u>3/7/2022</u>

All bidders are herewith notified of the following additions, deletions, changes or clarifications to the drawings dated 2/28/2022 and shall be acknowledged as received on the proposal.

See attached Pre-Bid Attendees' List

Project Manual:

1. See attached Bid Form with Alternate #1.

Drawings:

- 2. G00R1 See Revised Sheet Index
- 3. EC100 Added Energy Compliance Code Sheet
- 4. C001R1 Revised plumbing main sewer connection.
- 5. C100R1 Revised plumbing main sewer connection.
- 6. C101- Added new sheet Site Grading Plan
- 7. C102 Added new sheet Concrete Joint Plan
- 8. C103 Added new sheet New Site Plan Alternate #1 to remove and replace front parking lot.
- 9. A001R1 Revised demolition plan showing new main sewer connection.
- 10. A100R1, A100R1, A103R1
 - a. Added locations of (3) semi-recessed fire extinguisher cabinets, each with a 10 lb. multi-purpose fire extinguisher.
 - b. Added location of (1) Class K 6 Liter wall hung fire extinguisher in Kitchen Classroom 142.
 - c. Added Keynote #8: Appliances are furnished and installed by Owner except for Vented Hood by Mech Contractor.

11.A200R1

- a. Exterior Door Type B shall be 18 Ga. insulated with Polystyrene having a minimum R-Value of 2.8.
- b. Window Type 1 shall read as 2x6 Bronzed Anodized Aluminum Storefront Window.
- 12.A600R1, A601R1, A602R2

- a. Revise Keynote #12 to read as R-Panels on exterior walls shall be 26 Ga. 36" coverage with ribs at 12" Centers, Kynar paint finished.
- b. Delete Keynote #15
- 13.A704R1, A705R1, A706R1, A707R1, A708R1, A709R1, A710R1, A710R1 and A711R1
 - a. Change closed cell insulation on bottom of roof deck to R-38, and exterior walls to R-20.
 - b. Revise keynote # 26 to read "Existing R-panel metal roof to remain. Remove all existing weatherhead screws and replace with new cupped washer head stainless steel weatherhead screws with neoprene rubber.

14.A901R

a. Added note on roof plan to remove all existing weatherhead screws and replace with new cupped washer head stainless steel weatherhead screws with neoprene rubber.

15. Sheet F101

Detail 2 Corner Guard CG-1- Delete note "Patient Station Cabinet 6 309, 8 307, 9 306, 11 304 C.G. from top of toe kick to bottom of solid surface

- 16. SN101R1 Delete signage for FDC located adjacent to Door #3.
- 17. See attached Plumbing and Electrical Specifications and Drawings from M&E Consulting.

End of Addendum # 1



Date: 3/7/2022



1304 BERTRAND DR. STE. F7 LAFAYETTE, LA 70506 337 234 7474 FAX | 337 234 7774 meconsulting.com

March 7, 2022

Ronald Jones Architectural Alliance Incorporated 350 Pine Street, Suite 720 Beaumont, TX 77701

Re: SPINDLETOP MHMR SILSBEE

M&E Project No.: 21167.00

Ronald,

Please include the Mechanical and Electrical items on the following page or attached in your next addendum.

If you need additional information, please feel free to contact our office.

Sincerely,

Brent Trahan

Mechanical Designer

M&E Consulting, Inc.

h:\21\21167.00 (spindletop mhmr silsbee tx)\construction documents\addendums\21167 add-01.docx

Mechanical Specifications:

- 1. Section 22 13 29 Sewer Lift Station
 - a. Include the new specification section to the construction documents.

Mechanical Drawings:

- 1. Sheet P100 Plumbing Site Plan
 - a. Replace sheet P100 with revised sheet P100R1. See clouded area for changes.
- 2. Sheet P200 Plumbing Demolition Plan
 - a. Replace sheet P200 with revised sheet P200R1. See clouded area for changes.
- 3. Sheet P300 Plumbing Plan
 - a. Replace sheet P300 with revised sheet P300R1. See clouded area for changes.

Electrical Drawings:

- 1. Sheet E100 Electrical Site Plan
 - a. Replace sheet E100 with revised sheet E100R1. See clouded area for changes.
- 2. Sheet E700 Electrical Panel Schedules
 - a. Replace sheet E700 with revised sheet E700R1. See clouded area for changes.



350 Pine Street Suite 720 Edison Plaza

Beaumont, TX 77701 Phone: 409.866.7196 Fax: 409.866.1745

PRE-BID ATTENDEES' LIST

Project Number:

21061

Project Name:

Spindletop MHMR Silsbee

Project Owner:

Spindletop Center

Project Address: Date / Time: 222 Durdin Dr., Silsbee, TX 77656 Thursday, March 3, 2022 / 10:00 AM


NAME

COMPANY

EMAIL

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Bright ShiNN	SCTEX	BriANS@ SETEPLON STRUTTON
13rian Shipp Adam Chapman	chapman znowsties	Adama ChalmanIndicom
MARIO GORGANO II	ICM, LLC.	mario. gorganda ic-mechanical.com
Jeff Longle's	MHC Data COMA Tyes	ilonglois embadae. com
CINT DENNIS	Angels drywall	Odwity nt Hugels Com
Elaine Qubbia	N+T Const	Cjabbig@pandtoon struction.
Justin Taylor	Newson Elec.	STaylor @NTNED. COM
Told Herring	Custom Flooding	Todd HERENG 720 C. Mail. COM
Josh Champagne	Sety Plumbing	setxplumbing@(mail.com
Blake Laughlin	M3 Ranger Builders	Blake@M3 ranger.com
Jarred (012	Delk Construction	Kerziarret @ gmail.com
Kerin MAY		Kenum @ Cziglepakco 4
Chase Partain	CZ Danlels	daniels @daniels inc.com
Matthan Bargett Hogan Guiday	Air comfort	mbagget a gan aircowlad AC
Hogan Guiday	MAE Consulting	hogand meconsulting com
Daniel Hess	McInnis Construction	daniel Omcinnis projects.com
GARY HINGTE	Itmote plumbing	hinsteplagegtica com
Aaron Jones	Mid County Plumbing	Apjones 1293 agmail.com
Ben Newson	mid country Pludin	a Land mid to untuistanting.
Patael Pavon	Cp Construction.	C. O. HER AIR Services va I'm fed com
Chack Pills	AL Sauces	C. O. H& Assessices value fed con
PATLAROCCA	JEfforson ELector	Jep Jeffinson-Electric.Com
Jason Hommann	P+H Electrical	Punagne OdHelectrictxicim
Calby Doucet	Hir Confor	coorceterAircomfor. A.A



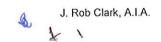

DOCUMENT 004113 - BID FORM - STIPULATED SUM (SINGLE-PRIME CONTRACT)

1.1	BID INFORMATION
A.	Bidder:
В.	Project Name: Spindletop Silsbee .
C.	Project Location: 222 Durdin, Silsbee, Texas.
D.	Owner: Spindletop Center.
E.	Architect: Architectural Alliance Incorporated .
F.	Architect Project Number: 21060.
1.2	CERTIFICATIONS AND BASE BID
A.	Base Bid, Single-Prime (All Trades) Contract: The undersigned Bidder, having carefully examined the Procurement and Contracting Requirements, Conditions of the Contract, Drawings, Specifications, and all subsequent Addenda, as prepared by Architectural Alliance Incorporated and Architect's consultants, having visited the site, and being familiar with all conditions and requirements of the Work, hereby agrees to furnish all material, labor, equipment and services, including all scheduled allowances, necessary to complete the construction of the above-named project, according to the requirements of the Procurement and Contracting Documents, for the stipulated sum of:
	1 Dollars (\$).
B.	Alternate #1: Remove and replace concrete parking lot. Add to Base Bid:
	1
1.3	BID GUARANTEE
A.	The undersigned Bidder agrees to execute a contract for this Work in the above amount and to furnish surety as specified within 10 days after a written Notice of Award, if offered within 60 days after receipt of bids, and on failure to do so agrees to forfeit to Owner the attached cash, cashier's check, certified check, U.S. money order, or bid bond, as liquidated damages for such failure, in the following amount constituting five percent (5%) of the Base Bid amount above:
	1 Dollars (\$).

B. In the event Owner does not offer Notice of Award within the time limits stated above, Owner will return to the undersigned the cash, cashier's check, certified check, U.S. money order, or bid bond.

1.4	SUBCONTRACTORS AND SUPPLIERS
A.	The following companies shall execute subcontracts for the portions of the Work indicated:
	1. Concrete Work: 2. Masonry Work: 3. Roofing Work: 4. Plumbing Work: 5. HVAC Work: 6. Electrical Work: 7. Paint Work: 8. Stucco Work: 9. Glass and Glazing Work: 10. Doors and Hardware: 11. Flooring Work:
1.5	TIME OF COMPLETION
A.	The undersigned Bidder proposes and agrees hereby to commence the Work of the Contract Documents on a date specified in a written Notice to Proceed to be issued by Architect, and shall fully complete the Work within calendar days.
1.6	ACKNOWLEDGMENT OF ADDENDA
A.	The undersigned Bidder acknowledges receipt of and use of the following Addenda in the preparation of this Bid:
	1. Addendum No. 1, dated

1.7 BID SUPPLEMENTS

- A. The following supplements are a part of this Bid Form and are attached hereto.
 - 1. Bid Form Supplement Allowances.
 - 2. Bid Form Supplement Bid Bond Form (AIA Document A310-2010).

1.8	SUBMISSION OF BID	
A.	Respectfully submitted this day of	, 2022 .
В.	Submitted By:	(Name of bidding firm or corporation).
C.	Authorized Signature:	(Handwritten signature)
D.	Signed By:	(Type or print name).
Е.	Title:	(Owner/Partner/President/Vice President).
F.	Street Address:	·
G.	City, State, Zip:	·
Н.	Phone:	
I.	Federal ID No.:	(Affix Corporate Seal Here).

END OF DOCUMENT 004113

SPINDLETOP SILSBEE

222 E Durdin Drive

Silsbee, TX 77656

OWNER

Spindletop MHMR 655 S 8th Street Beaumont, TX 77701

Contact: (409) 617-4746 Phone: William.Hill@stctr.org

ARCHITECT

Beaumont, Texas 77701

ARCHITECTURAL ALLIANCE, INCORPORATED 350 Pine Street Suite 720

Ronnie Jones (409) 866-7196 rjones@architect-aia.com

MECHANICAL, ELECTRICAL, PLUMBING

M&E CONSULTING 1304 Bertrand Dr., Suite F7 Lafayette, LA 70506

Contact: Hogan Guidry (337) 849-7759 hogan@meconsulting.com

STRUCTURAL

FITTZ & SHIPMAN 1405 Cornerstone Court Beaumont, Texas 77706

Daniel Dotson (409) 832-7238 ddotson@fittzshipman.com

ABBREVIATIONS

DIAMETER

DIAGONAL

DIMENSION

DISPENSER

DEAD LOAD

MASONRY

CONCRETE

PLYWOOD

GYPSUM BOARD

MASONRY

UNITS

CALLED NORTH

MATERIAL LEGEND

DIA

DIM

DISP

DL

DIAG

		•	
A.B.	ANCHOR BOLT	DR	DOOR
A/C	AIR CONDITIONING	DS	DOWNSPOUT
ACT	ACOUSTICAL CEILING TILE	DWR	DRAWER
A.D.	AREA DRAIN		
ADA	AMERICANS WITH	EA	EACH
	DISABILITIES ACT	EF	EACH FACE / EXHAUST
ADJ	ADJUSTABLE	EJ	EXPANSION JOINT
AFF	ABOVE FINISH FLOOR	EIFS	EXTERIOR INSULATED
ALT	ALTERNATE		FINISH SYSTEM
ALUM	ALUMINUM	ELEC	ELECTRICAL
ANOD	ANODIZED	ELEV	ELEVATION
APPROX	APPROXIMATE	EMER	EMERGENCY
ARCH	ARCHITECT(URAL)	ENCL	ENCLOSURE
ASPH	ASPHALT	EQ	EQUAL
	50455	EQUIP	EQUIPMENT
BD	BOARD	EW	EACH WAY
BIT	BITUMINOUS	EWC	ELECTRIC WATER COO
BLDG	BUILDING	EXH	EXHAUST
BLKG	BLOCKING	EXIST	
BM B.O.	BEAM BOTTOM OF	EXP EXT	EXPANSION / EXPOSED
B.O. BOT	BOTTOM OF	EXI	EXTERIOR
BRG	BEARING	FD	FLOOR DRAIN
BTWN	BETWEEN	FDN	FOUNDATION
BUR	BUILT-UP ROOF	FE	FIRE EXTINGUISHER
Вот	BOILT OF ROOF	FEC	FIRE EXTINGUISHER
CAB	CABINET	120	CABINET
CBU	CEMENTITIOUS	FF	FINISH FLOOR
020	BACKER UNIT	FFE	FINISH FLOOR ELEVATI
C/C	CENTER-TO-CENTER	FIN	FINISH
CEM	CEMENT	FLR	FLOOR
CER	CERAMIC	FLUOR	FLUORESCENT
C.G.	CORNER GUARD	FM	FACTORY MUTUAL
C.I.P.	CAST-IN-PLACE	FO	FACE OF (SPECIFY ITEM
C.J.	CONTROL JOINT	FOB	FACE OF BRICK
CL	CENTERLINE	FOC	FACE OF CONCRETE
CLG	CEILING	FOS	FACE OF STUD
CLR	CLEAR(ANCE)	FR	FIRE RESISTIVE
CLOS	CLOSET	FT	FEET / FOOT
CMU	CONCRETE	FTG	FOOTING
	MASONRY UNIT	FURR	FURRING / FURRED
C.O.	CLEAN OUT		
COL	COLUMN	GA	GUAGE
CONC	CONCRETE	GALV	GALVANIZED
CONSTR	CONSTRUCTION	GB	GRAB BAR
CONT COORD	CONTINUOUS COORDINATE	GC	GENERAL CONTRACTO
COORD	CORRIDOR	GL	GLASS / GLAZING
CTR	CENTER	GND GR	GROUND GRADE
C.Y.	CUBIC YARD	GWB	GYPSUM WALLBOARD
0.1.	CODIC TAND	GVB	GYPSUM WALLBOARD
DBL	DOUBLE	U 11	311 33m
DEMO	DEMOLITION	НВ	HOSE BIB
DEPT	DEPARTMENT	HC	HOLLOW CORE
DET	DETAIL	HDR	HEADER

	HW	HOT WATER
AN	ID IN INCL INSUL INT INV	INSIDE DIAMETER INCH INCLUDE(D) INSULATION INTERIOR INVERT
	JAN JST JT	JANITOR JOIST JOINT
	KD KIT KO	KNOCK DOWN KITCHEN KNOCK OUT
ĒR	LAB LAV LF LH LHR LL LLH LLV LWC	LABORATORY LAMINATE(D) LAVATORY LINEAL FOOT LEFT HAND LEFT HAND REVERSE LIVE LOAD LONG LEG HORIZONTAL LONG LEG VERTICAL LIGHT WEIGHT CONCRETE
N	MACH MAS MATL MAX MDF MECH MEMB MFR MEZZ MH MIN MIR MISC MO MR MTL MULL	MACHINE MASONRY MATERIAL MAXIMUM MEDIUM DENSITY FIBERBOARD MECHANICAL MEMBRANE MANUFACTURER MEZZANINE MANHOLE MINIMUM MIRROR MISCELLANEOUS MASONRY OPENING MOISTURE RESISTANT METAL MULLION
	N/A NIC NO. NOM NTS	NOT APPLICABLE NOT IN CONTRACT NUMBER NOMINAL NOT TO SCALE
	OC OD OFCI OFOI	ON CENTER OUTSIDE DIAMETER (OR OVERFLOW DRAIN) OWNER FURNISHED/ CONTRACTOR INSTALLED OWNER FURNISHED/ OWNER INSTALLED


PNG PP	OPENING OPPOSITE
ERP L LAM LAS LYWD NL NT R SF SI T TN VC	PERPENDICULAR PLATE (OR PROPERTY LINE) PLASTIC LAMINATE PLASTER PLYWOOD PANEL PAINT PAIR POUNDS PER SQUARE FOOT POUNDS PER SQUARE INCH PRESSURE TREATED PARTITION POLYVINYL CHLORIDE
A AD B CP D EBAR EC EF EINF EQD ES H HR M O WL	RETURN AIR RADIUS RESILIENT BASE REFLECTED CEILING PLAN ROOF DRAIN REINFORCING BAR RECESSED REFERENCE REFRIGERATOR REINFORCING / REINFORCED REQUIRED RESILIENT REVISION RIGHT HAND RIGHT HAND REVERSE ROOM ROUGH OPENING RAINWATER LEADER ROD AND SHELF
C CHED F HT IM PEC Q S T TC TD TL TOR TRUCT USP YM	SOLID CORE SCHEDULE SQUARE FEET SHEET SHEET SIMILAR SPECIFICATION SQUARE STAINLESS STEEL STONE SOUND TRANSMISSION CLASS STANDARD STEEL STORAGE STRUCTURAL SUSPENDED SYMMETRICAL
AS &B	TEXAS ACCESSIBILITY STANDARDS TOP AND BOTTOM

TONGUE AND GROOVE

TO BE DETERMINED


TELEPHONE

TERRAZZO

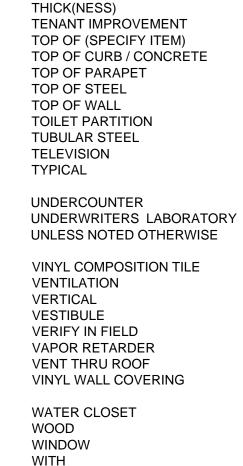

WATER HEATER WITHOUT WATERPROOF WATER RESISTANT WEIGHT WELDED WIRE FABRIC WELDED WIRE MESH



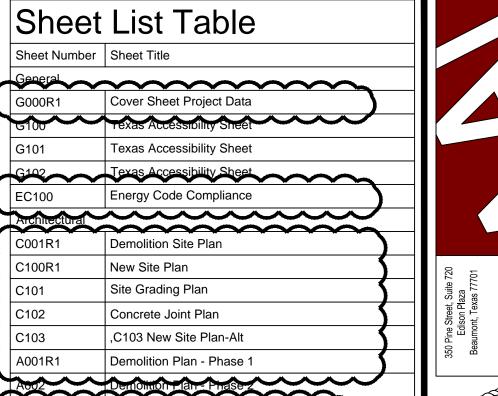

Sheet Number | Sheet Title

C101

A103R1

A200R1

Demolition Site Plan New Site Plan

Site Grading Plan Concrete Joint Plan

Floor Plan - Phase 1

Floor Plan - Phase 2

Doors and Windows A300 Reflected Ceiling Plain

> Interior Elevations Interior Elevations

Exterior Elevations

Exterior Elevations

Exterior Elevations

Building Sections

Building Sections

Wall Section

Wall Sections

Wall Section

Wall Section

Wall Section

Wall Section

New Roof Plan

General Notes

Foundation Plan

Framing Plans

Framing Details

Mechanical Plan

Mechanical Details Mechanical Schedule

E000 Electrical Legend & Notes

200 Electrical Demoiition Plan

Mechanical Power Plan

F800 Flectrical Risers

Fire Protection Plan

P000 Plumbing Legend & General Notes

P400 Plumbing Schedule & Risers

Plumbing Demolition Plan

ABS2022012961

E600 Floctrical Schedule & Details

Power & Special Systems Plan

Mechanical

M000

M300

Foundation Details

Signage Floor Plan


Finish and Wall Protection Plan

Mechanical Legend & General Notes

Mechanical Demolition Plan

Dimension Plan - Phase 1



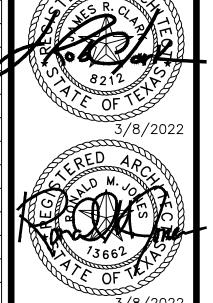

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SCHEMATIC DESIGN DATE: 11/15/2021 DESIGN DEVELOPMENT DATE: 12/20/2021

BIDS & CONSTRUCTION DATE: 2/28/2021 REVISION: /1 DATE: 3/7/2022

REVISION: DATE:_ REVISION:

DRAWINGS SHEET TITLE

COVER SHEET PROJECT DATA

SHEET NUMBER

SYMBOL KEY

(CONTINUOUS) **BLOCKING OR SHIM** (INTERMITTENT)

HARDWARE

HORIZONTAL

BLOCKING OR SHIM

INSULATION

INSULATION

HOLLOW METAL

HEATING, VENTILATION,

AND AIR CONDITIONING

DOOR NUMBER **TOILET ACCESSORY**



INTERIOR ELEVATION

OPPOSITE HAND (OR

OVERHEAD)



ENLARGED DETAIL




KEYNOTE




ROOM NAME & NUMBER

PARTITION TYPES

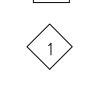


WINDOW TYPE

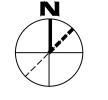


NORTH ARROW




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LOCATION MAP

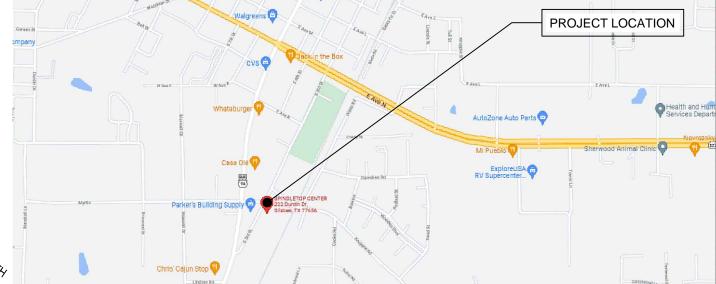

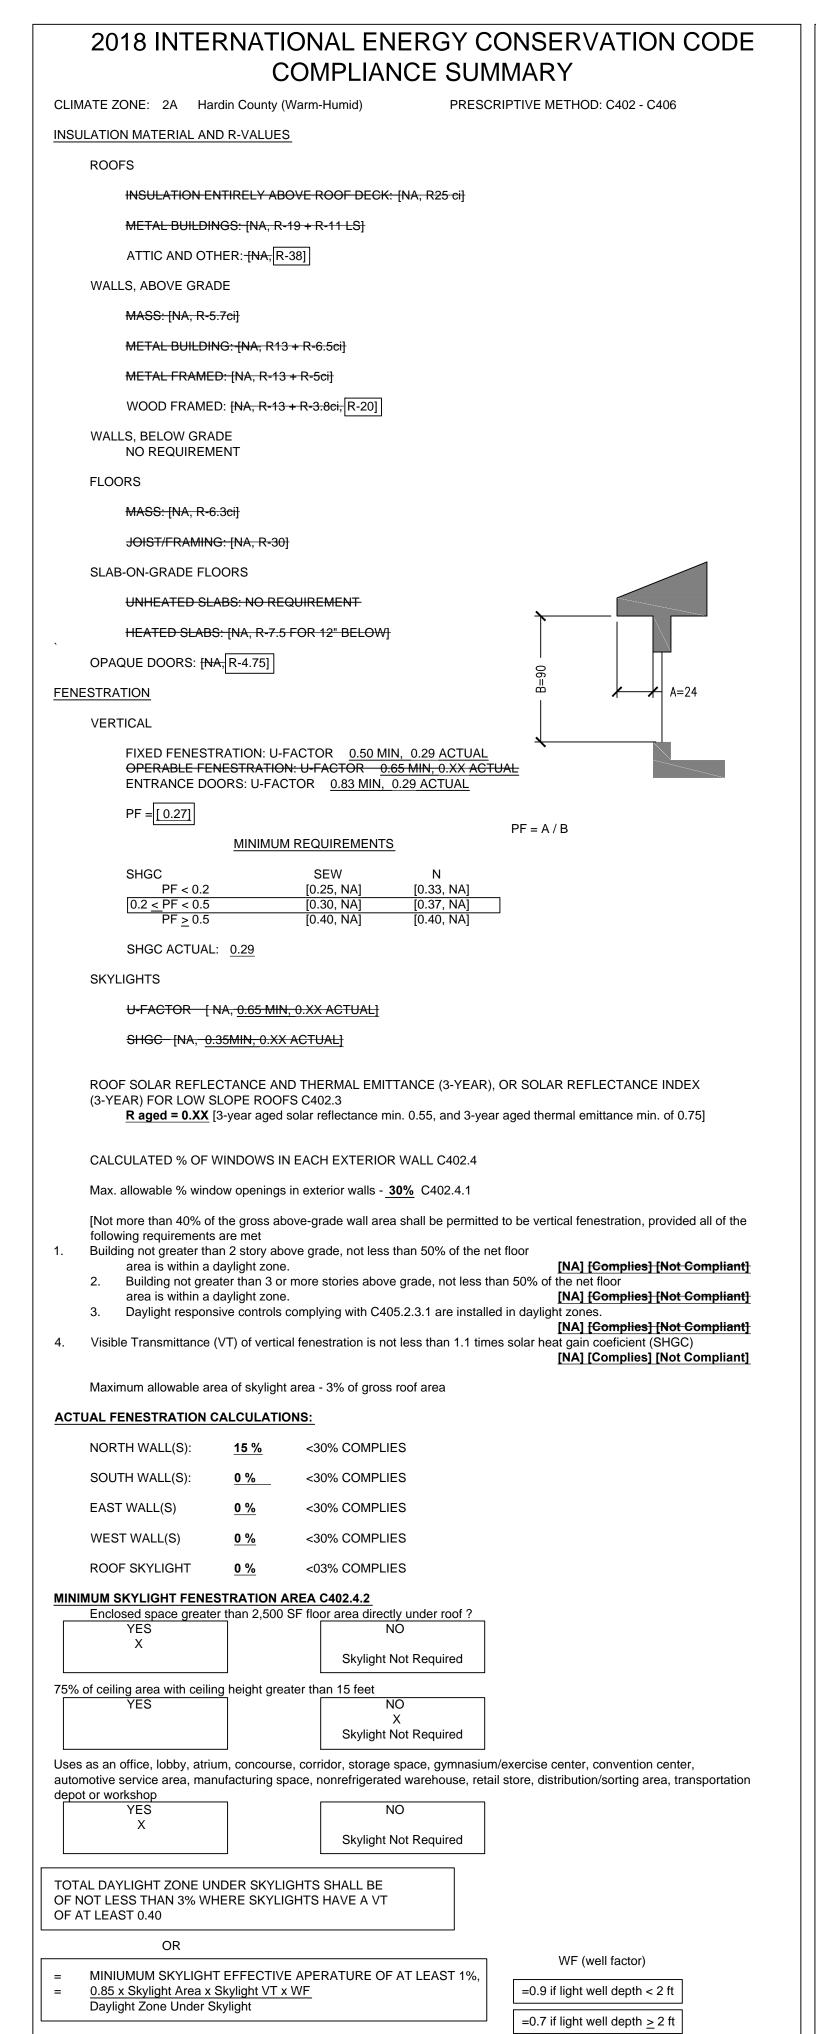

FENESTRATION ASSEMBLY	MAXIMUM RATE (CFM / FT2)	TEST PROCEDURE
Windows	0.20	
Sliding Doors	0.20	AAMA/WDMA/CSA101/
Swinging Doors	0.20	I.S.2/A440
Skylights - with condensation		or
weepage openings	0.30	NFRC 400
Skylights - All others	0.20	
Curtain Walls	0.06	
Storefront Glazing	0.06	NFRC 400
Commercial glazed swinging	1.00	or
entrance doors		ASTM E 283 at 1.57 psf
Revolving Doors	1.00	(75 Pa)
Garage Doors	0.40	ANSI/DASMA 105,
Rolling Doors	1.00	NFRC 400, or
High-speed doors	1.30	ASTM E283 at 1.57 psf (75 Pa)

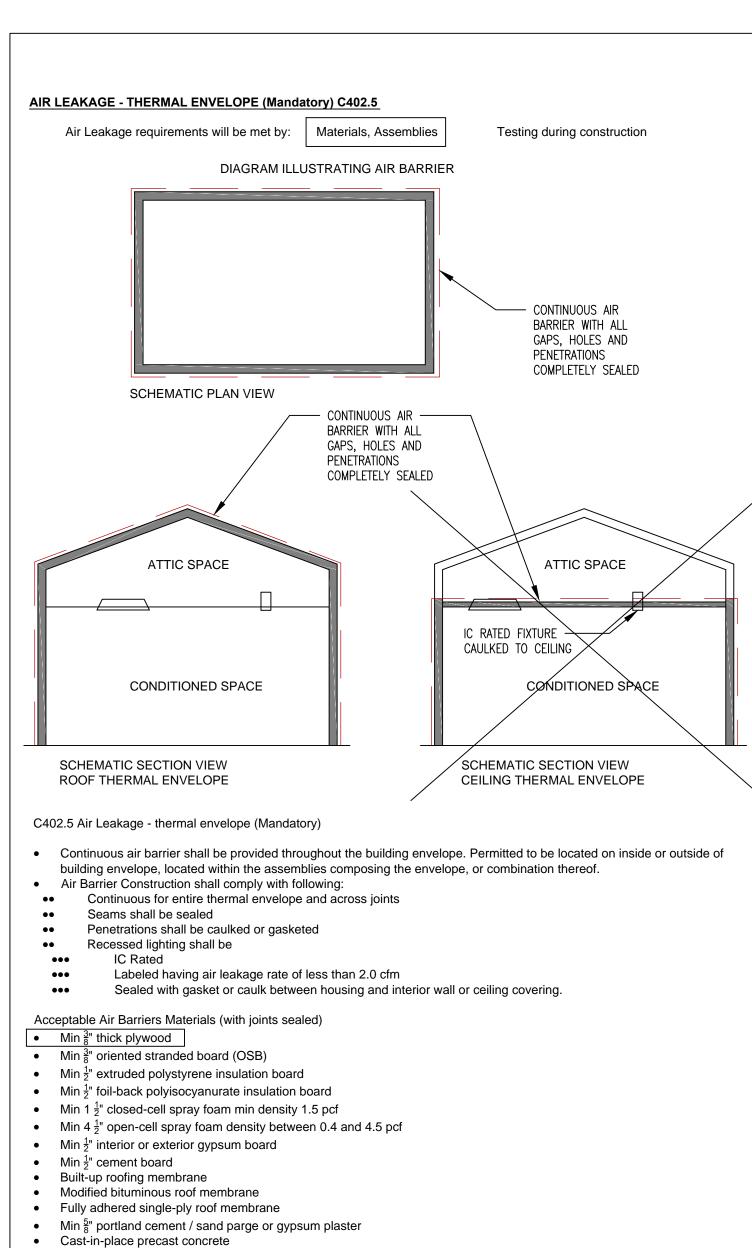C402.5.7 VESTIBULES Exception 1. Not required in climate zones 1 & 2.

Fully grouted concrete block masonry

Concrete masonry walls coated with

•• 2 applications of a paint or sealer coating

Portland cement stucco or plaster min ½" thick

1 application block filler, or

Solid or hollow masonry constructed of clay or shale masonry units

Masonry walls constructed of clay or shale masonry, min 4 inches width


Sheet steel or aluminum


Acceptable Air Barriers Assemblies

C403 MECHANICAL SYSTEMS

C404 SERVICE WATER HEATING (MANDATORY)

C404 ELECTRICAL POWER AND LIGHTING SYSTEMS

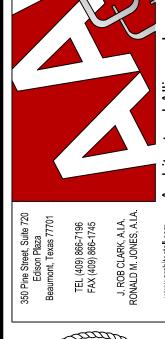

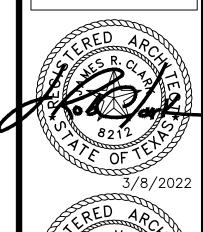



SILSBE

ETOP

SPINDLI

ISSUED FOR

REVISION: DATE:_

REVISION: DATE:_

DATE:_

COMPLIANCE

~~~ SHEET NUMBER

PROJECT NUMBER


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SCHEMATIC DESIGN DATE: 11/15/2021 DESIGN DEVELOPMENT X DATE: 12/20/2021 BIDS & CONSTRUCTION X


DATE: 2/28/2021

REVISION:


DRAWINGS SHEET TITLE **ENERGY CODE** 

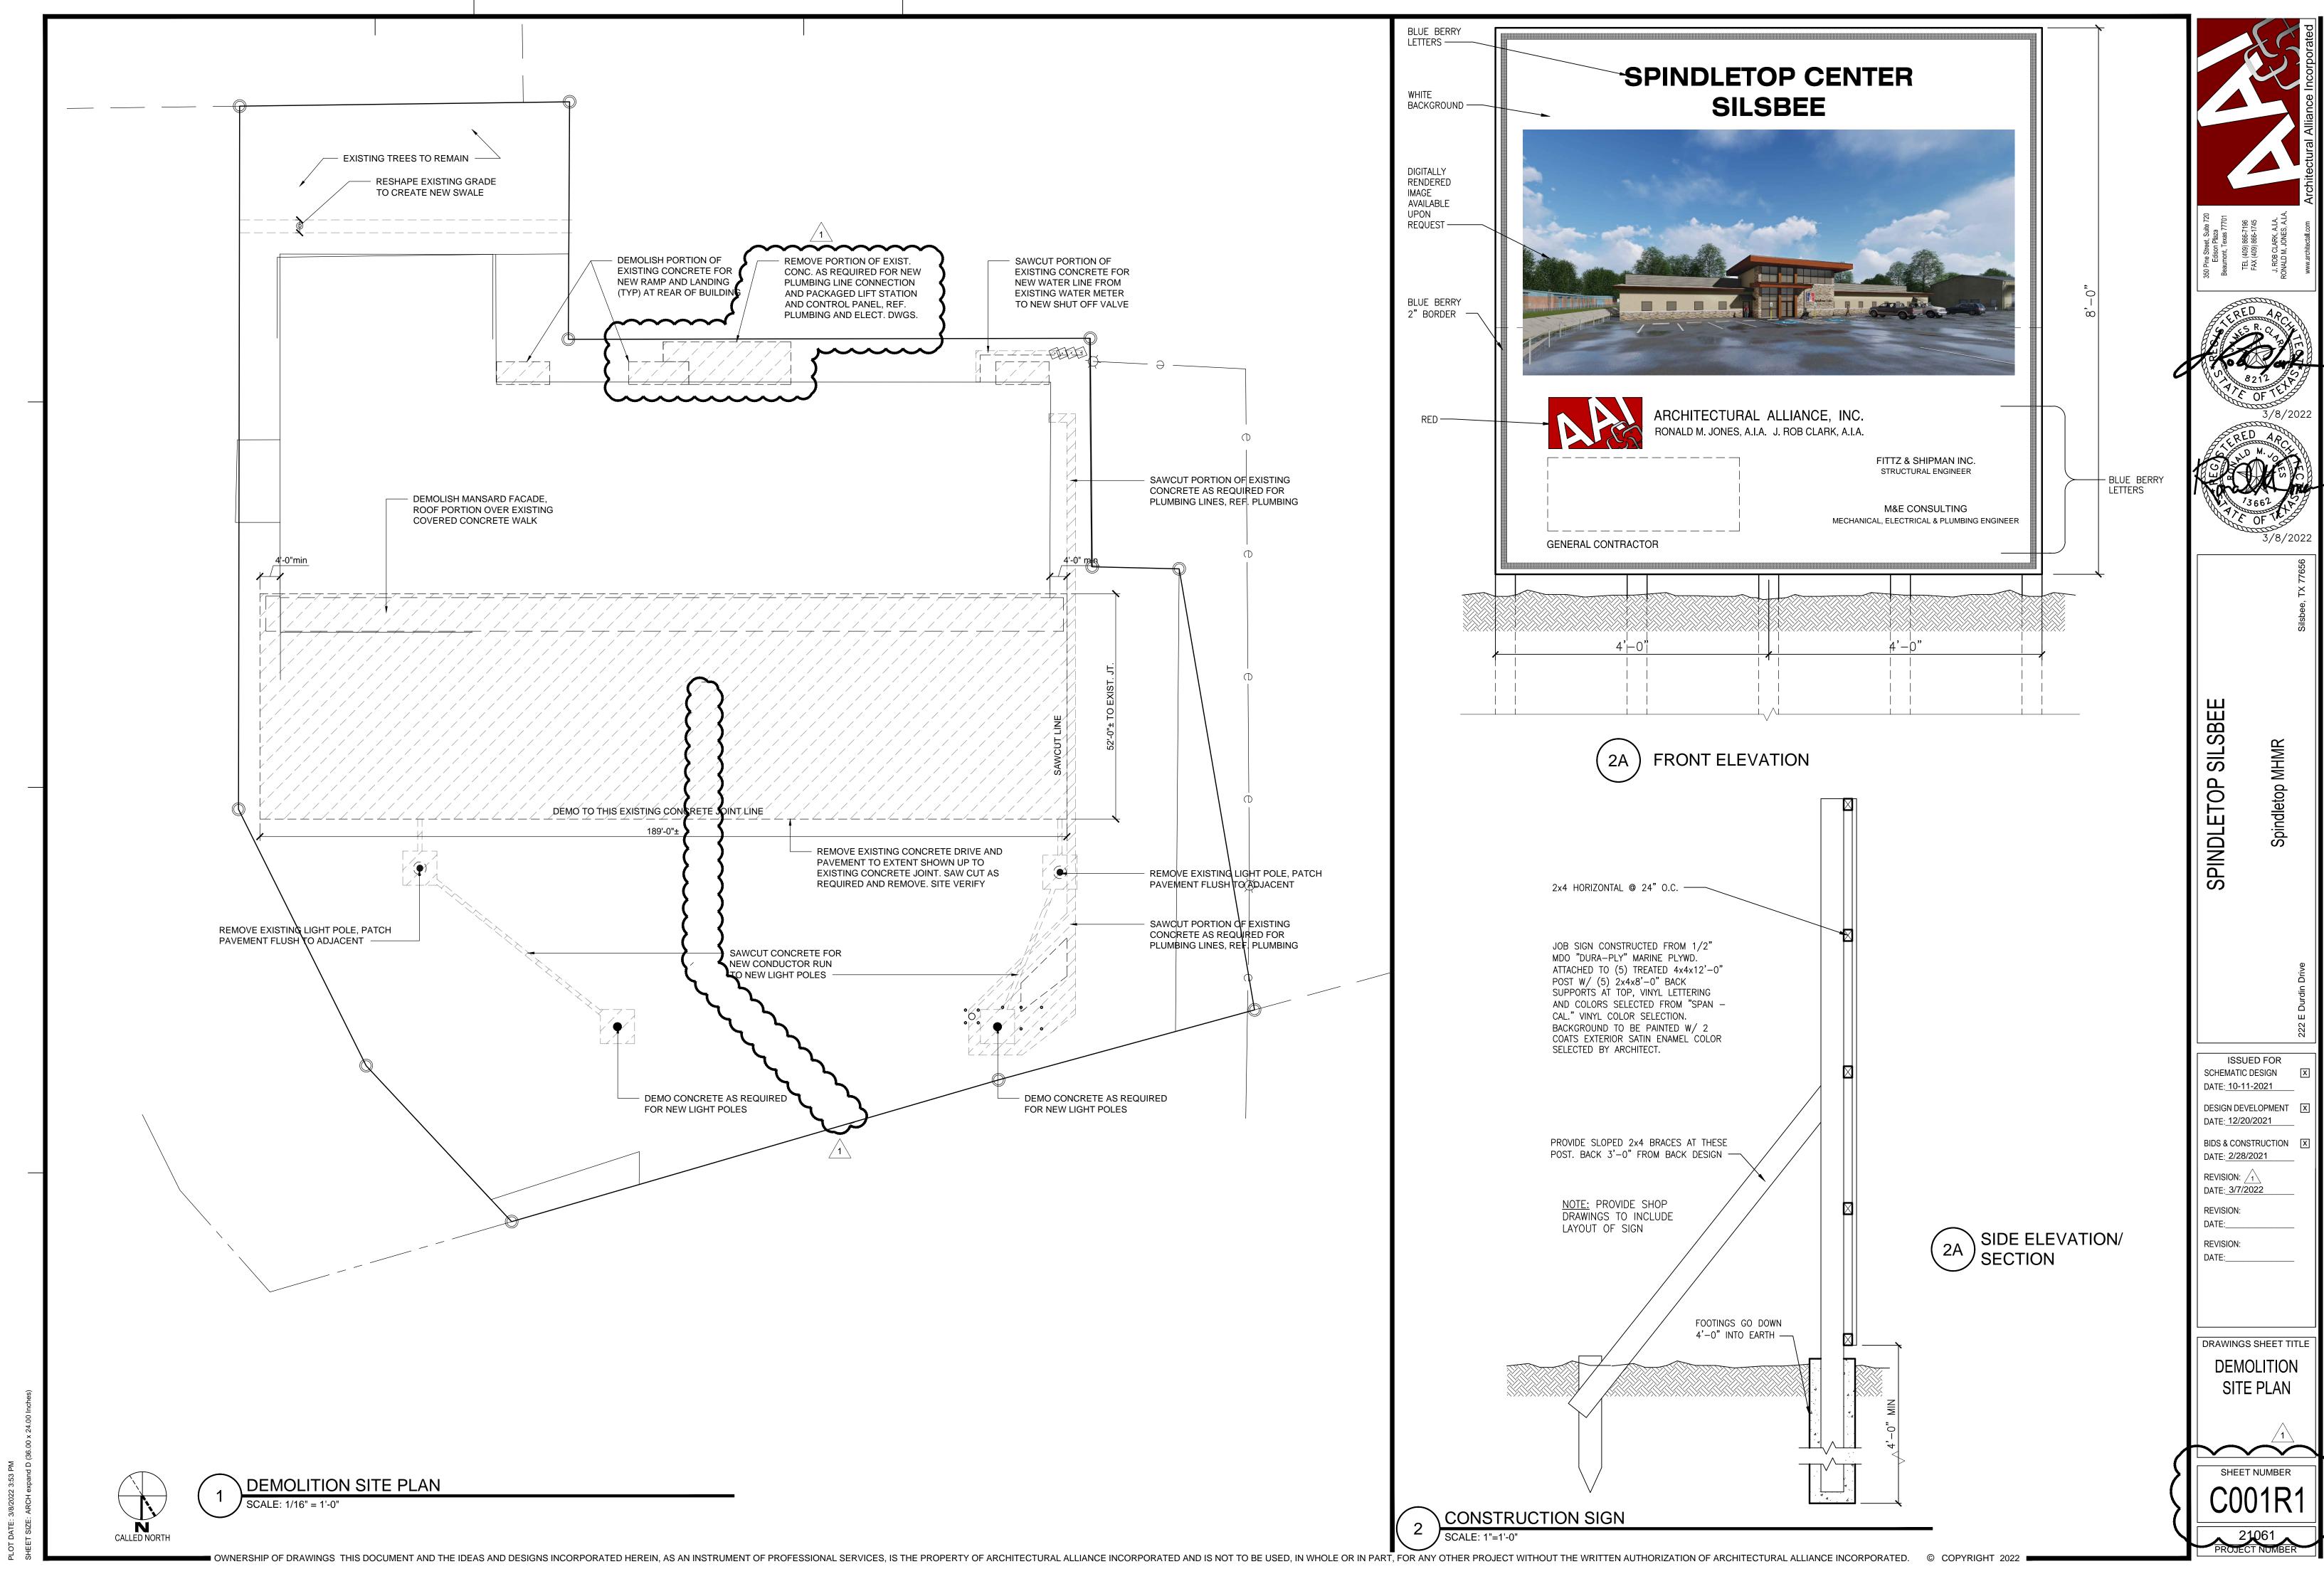

PLOT: MICHAEL MAGTAAN

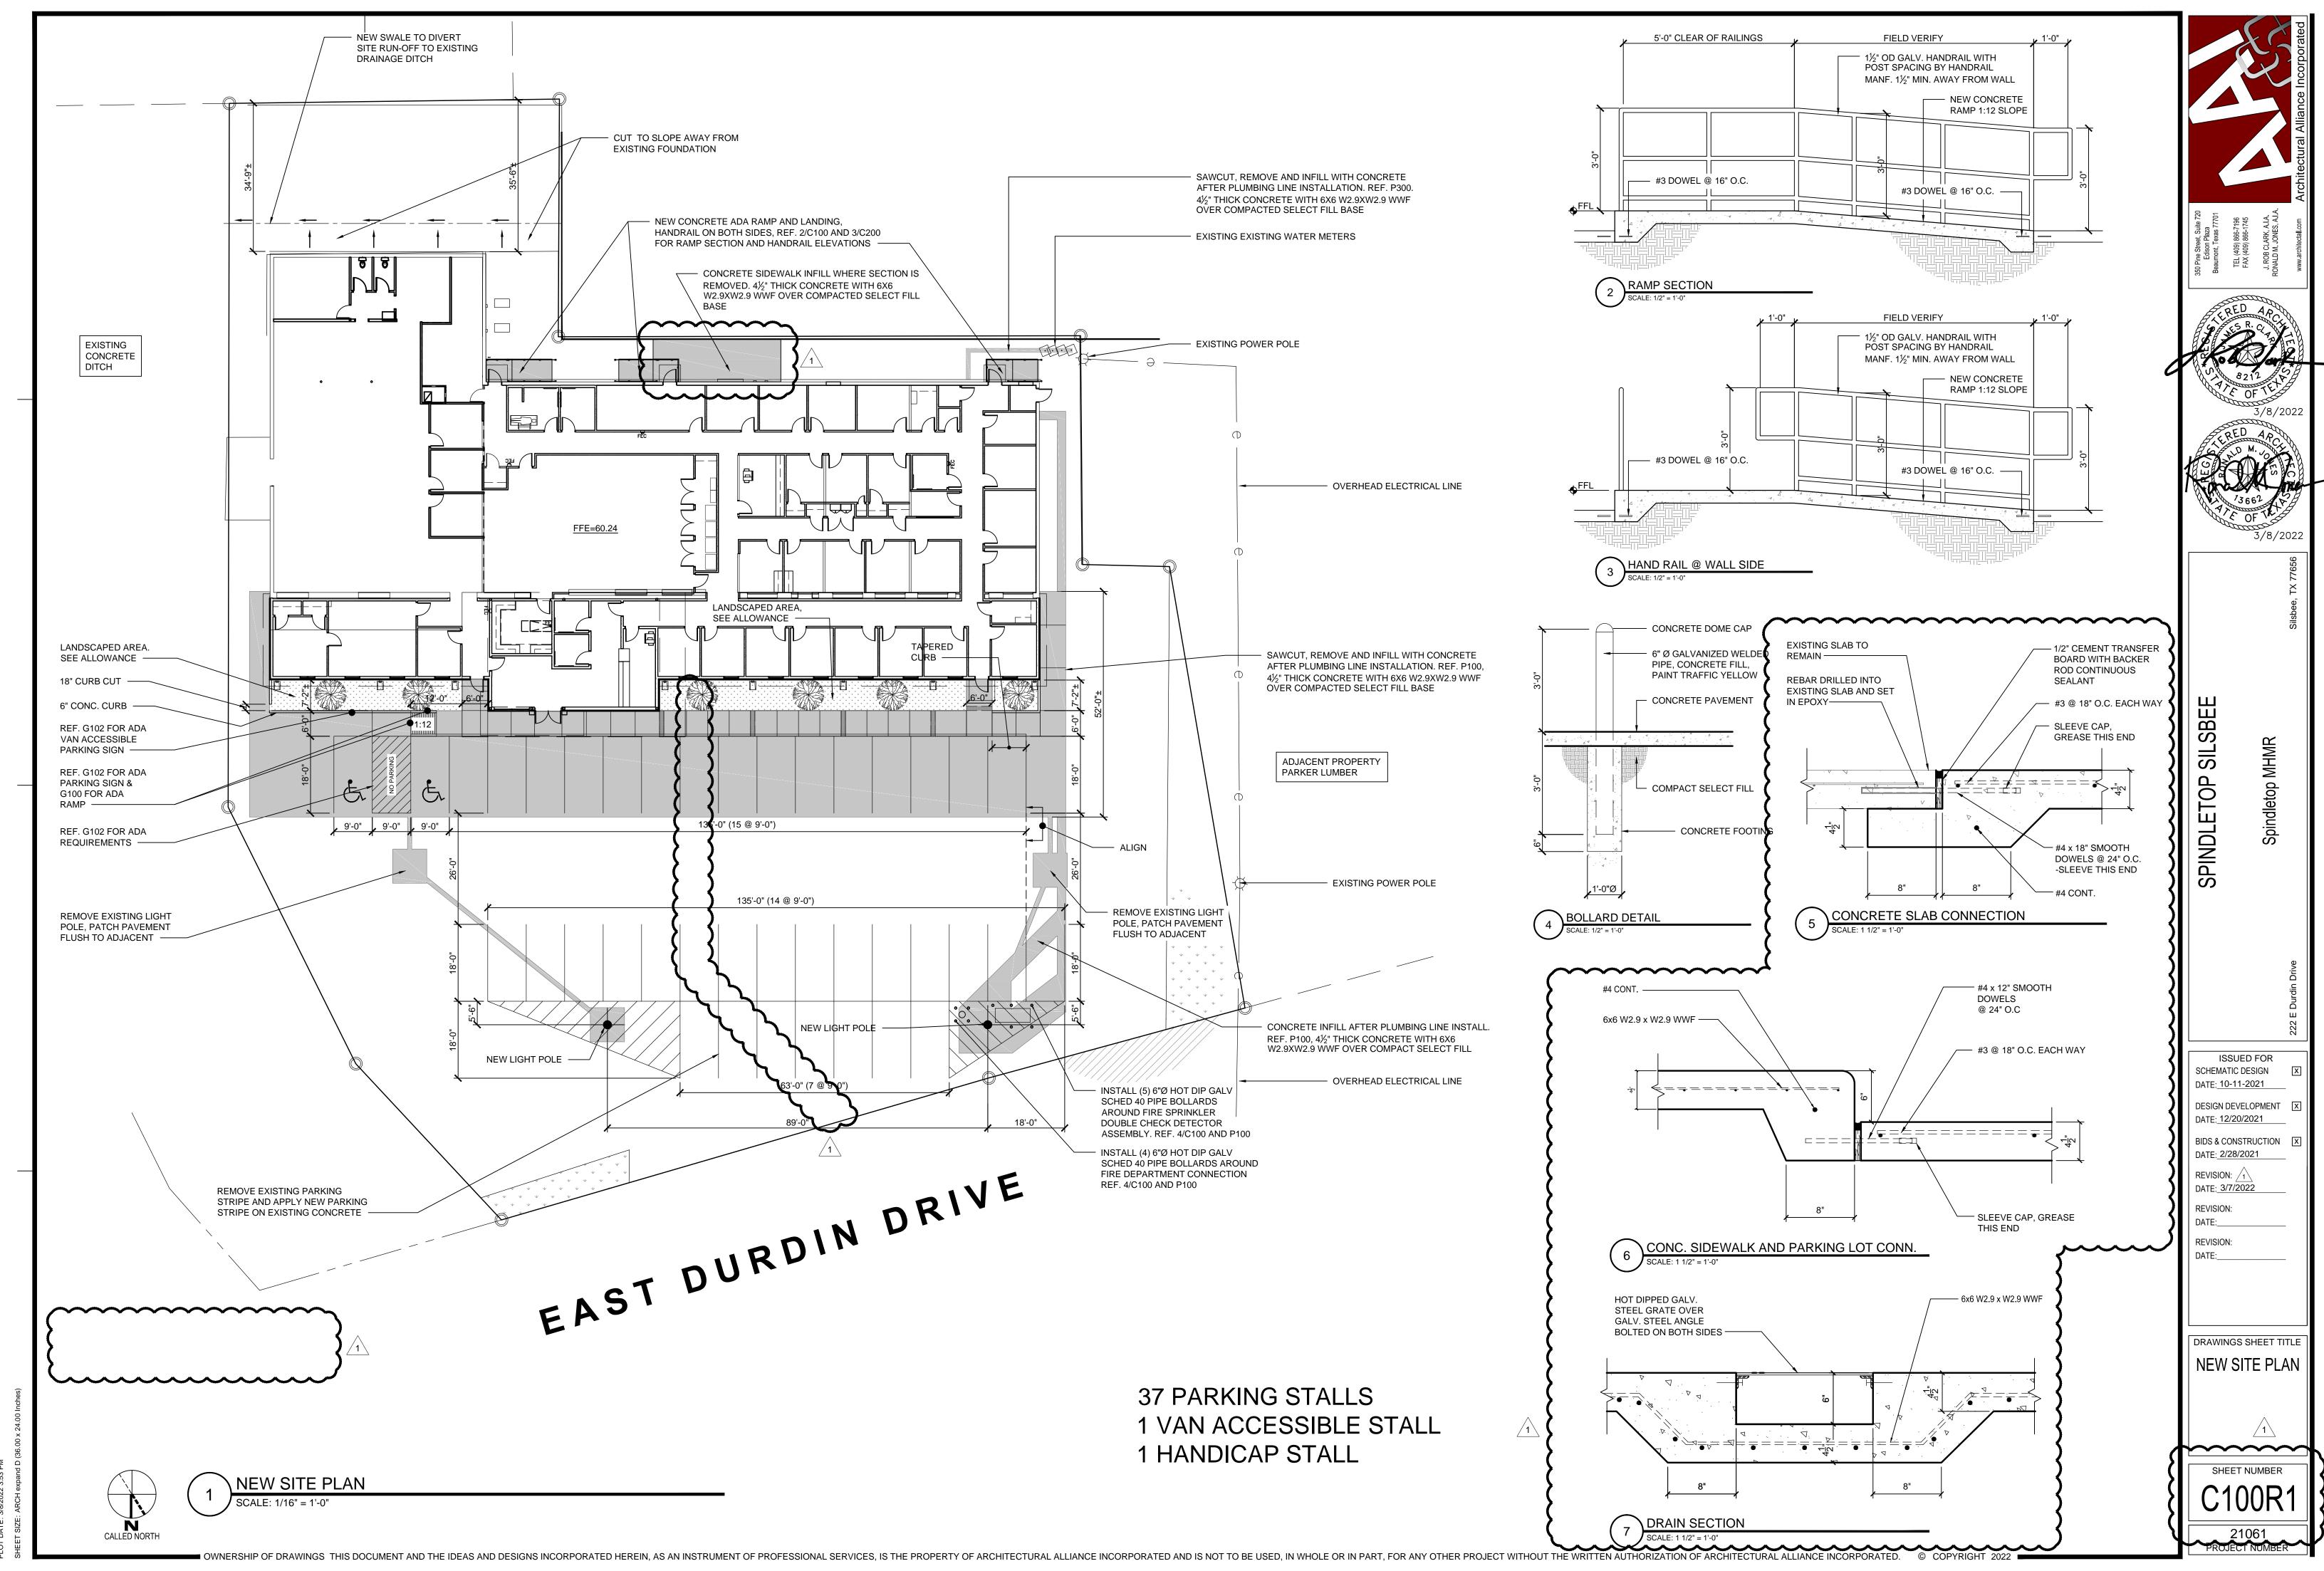

OT: MICHAEL MAGTAAN

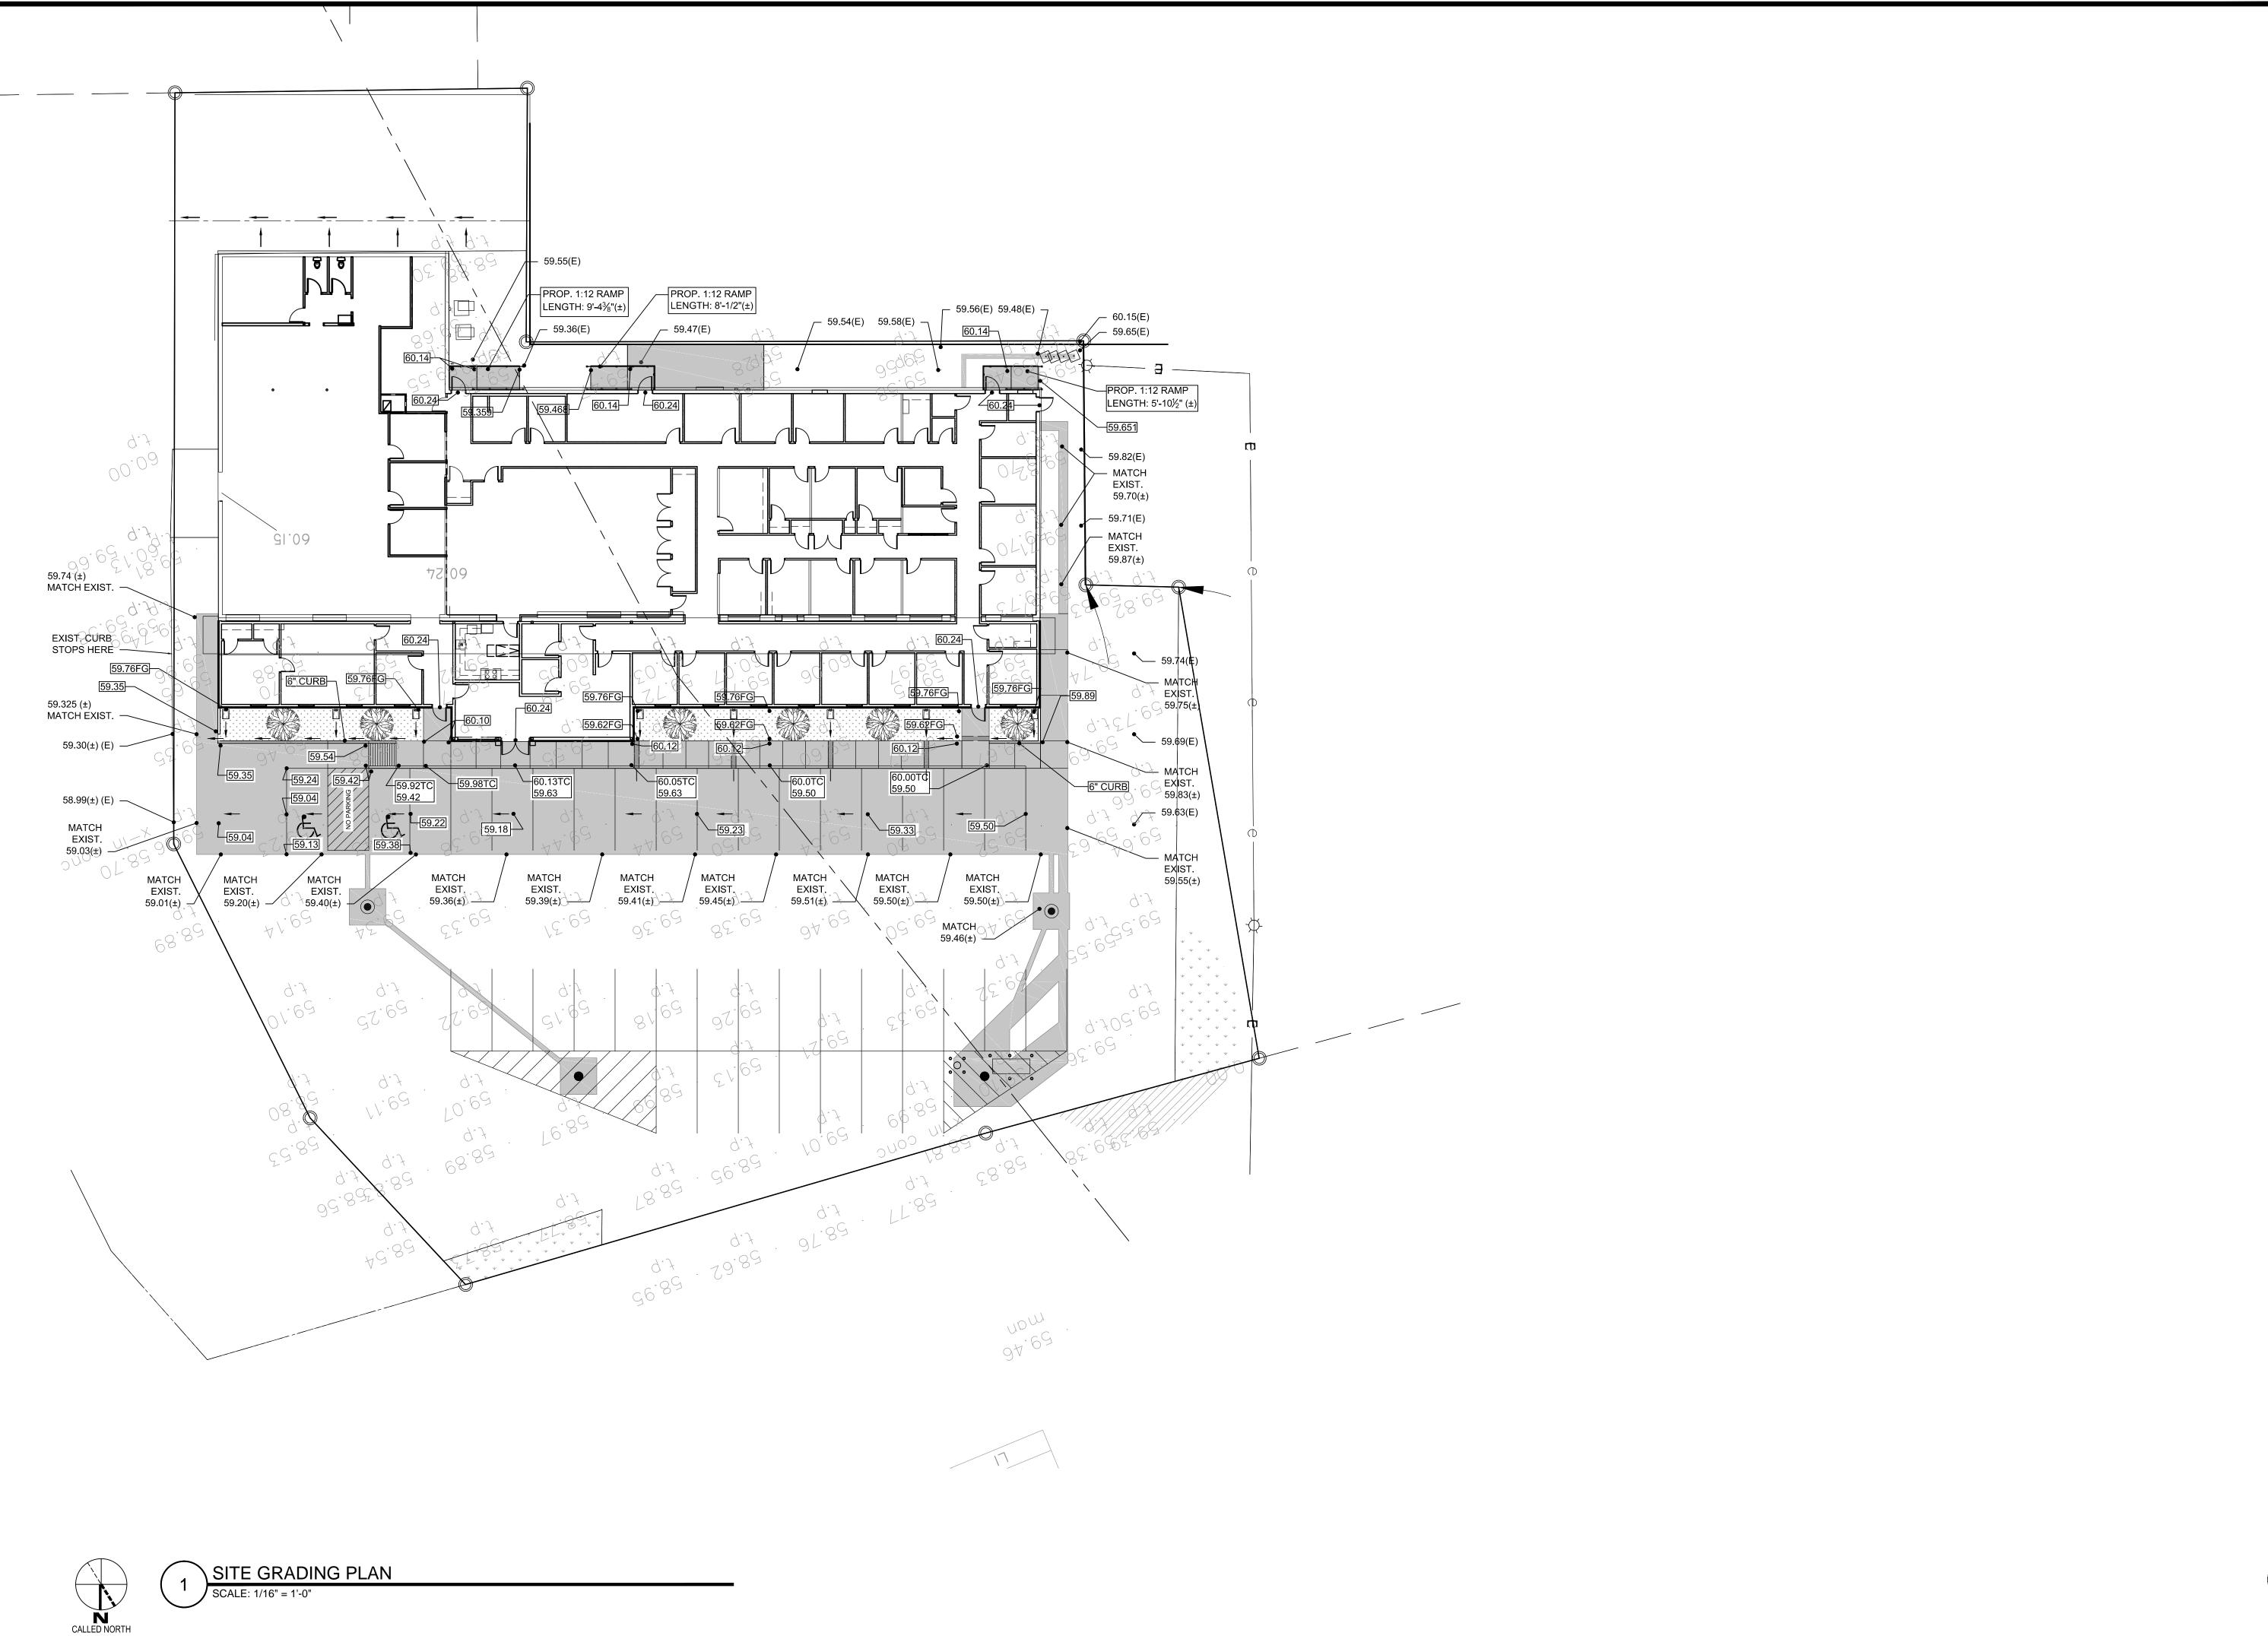

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SHEET NUMBER

DRAWINGS SHEET TITLE

SITE GRADING

SILSBEE

SPINDLETOP

ISSUED FOR SCHEMATIC DESIGN X

DESIGN DEVELOPMENT X

BIDS & CONSTRUCTION X

DATE: 10-11-2021


DATE: 12/20/2021

DATE: 2/28/2021

REVISION: /1 DATE: 3/7/2022

REVISION: DATE:\_\_

REVISION: DATE:\_

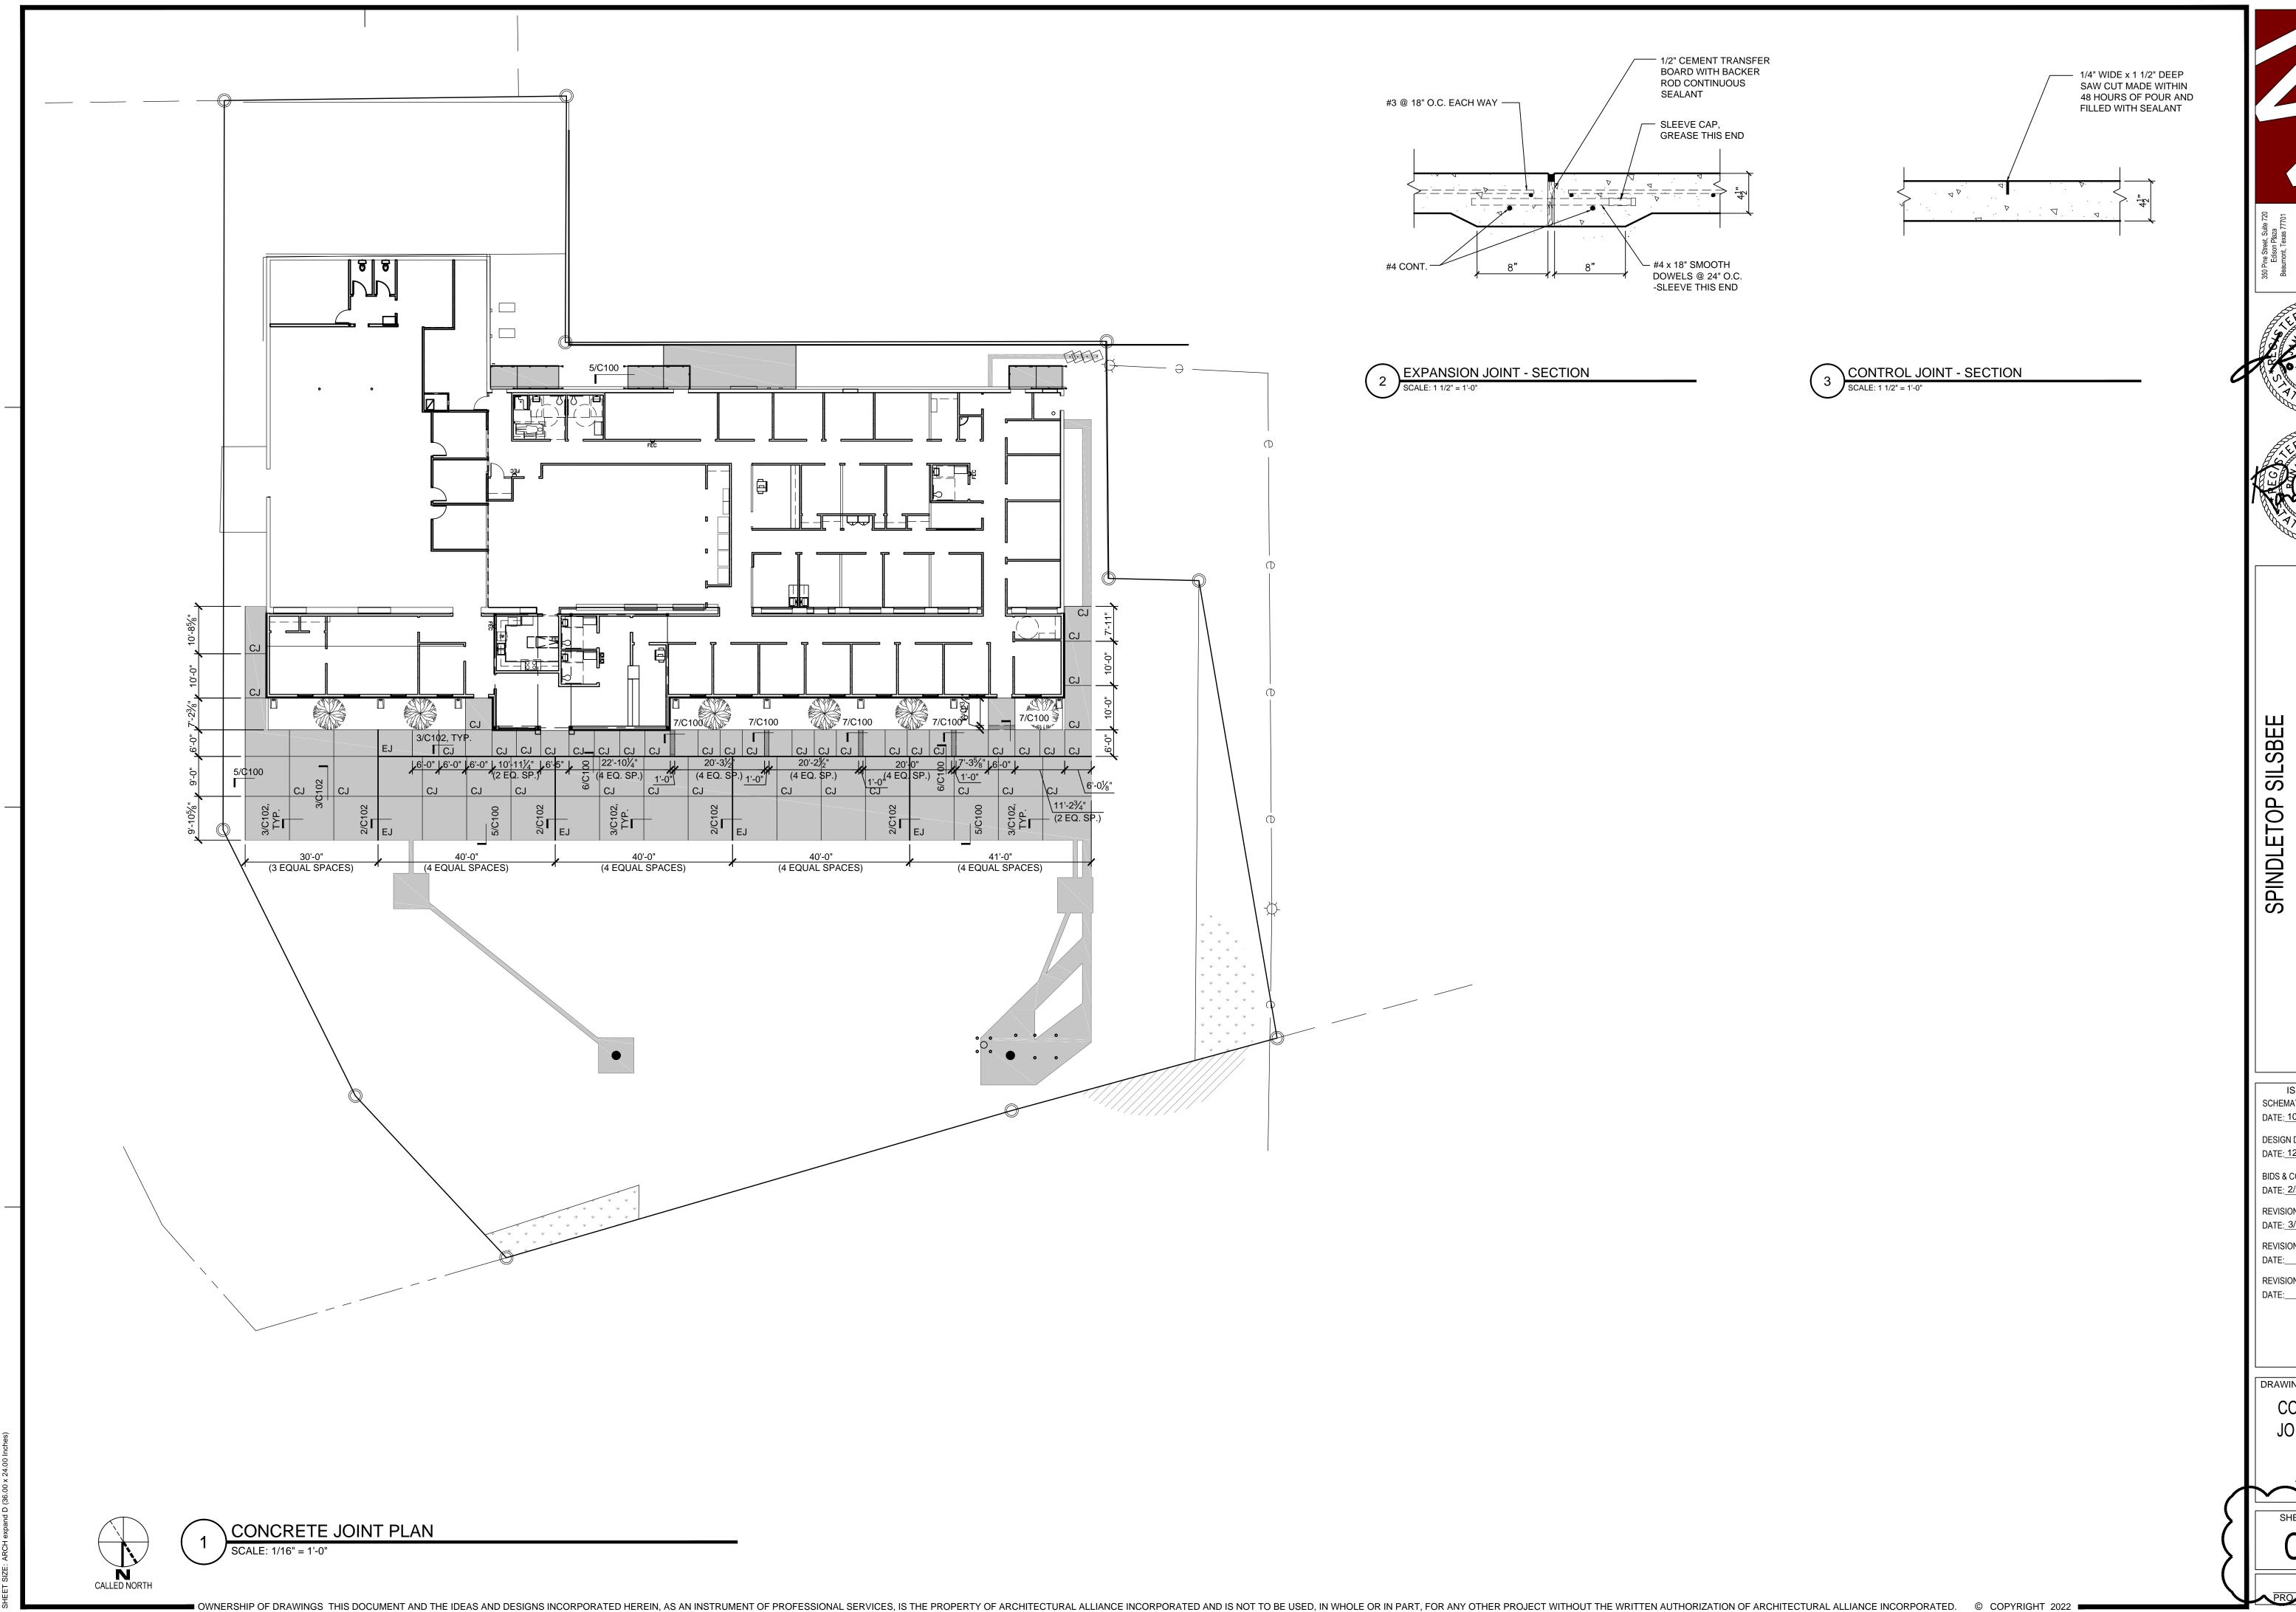

ISSUED FOR SCHEMATIC DESIGN X DATE: 10-11-2021 DESIGN DEVELOPMENT X

DATE: 12/20/2021 BIDS & CONSTRUCTION X

DATE: 2/28/2021 REVISION: 1

DATE: 3/7/2022 REVISION:


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DRAWINGS SHEET TITLE

CONCRETE JOINT PLAN


SHEET NUMBER

21061 PROJECT NUMBI

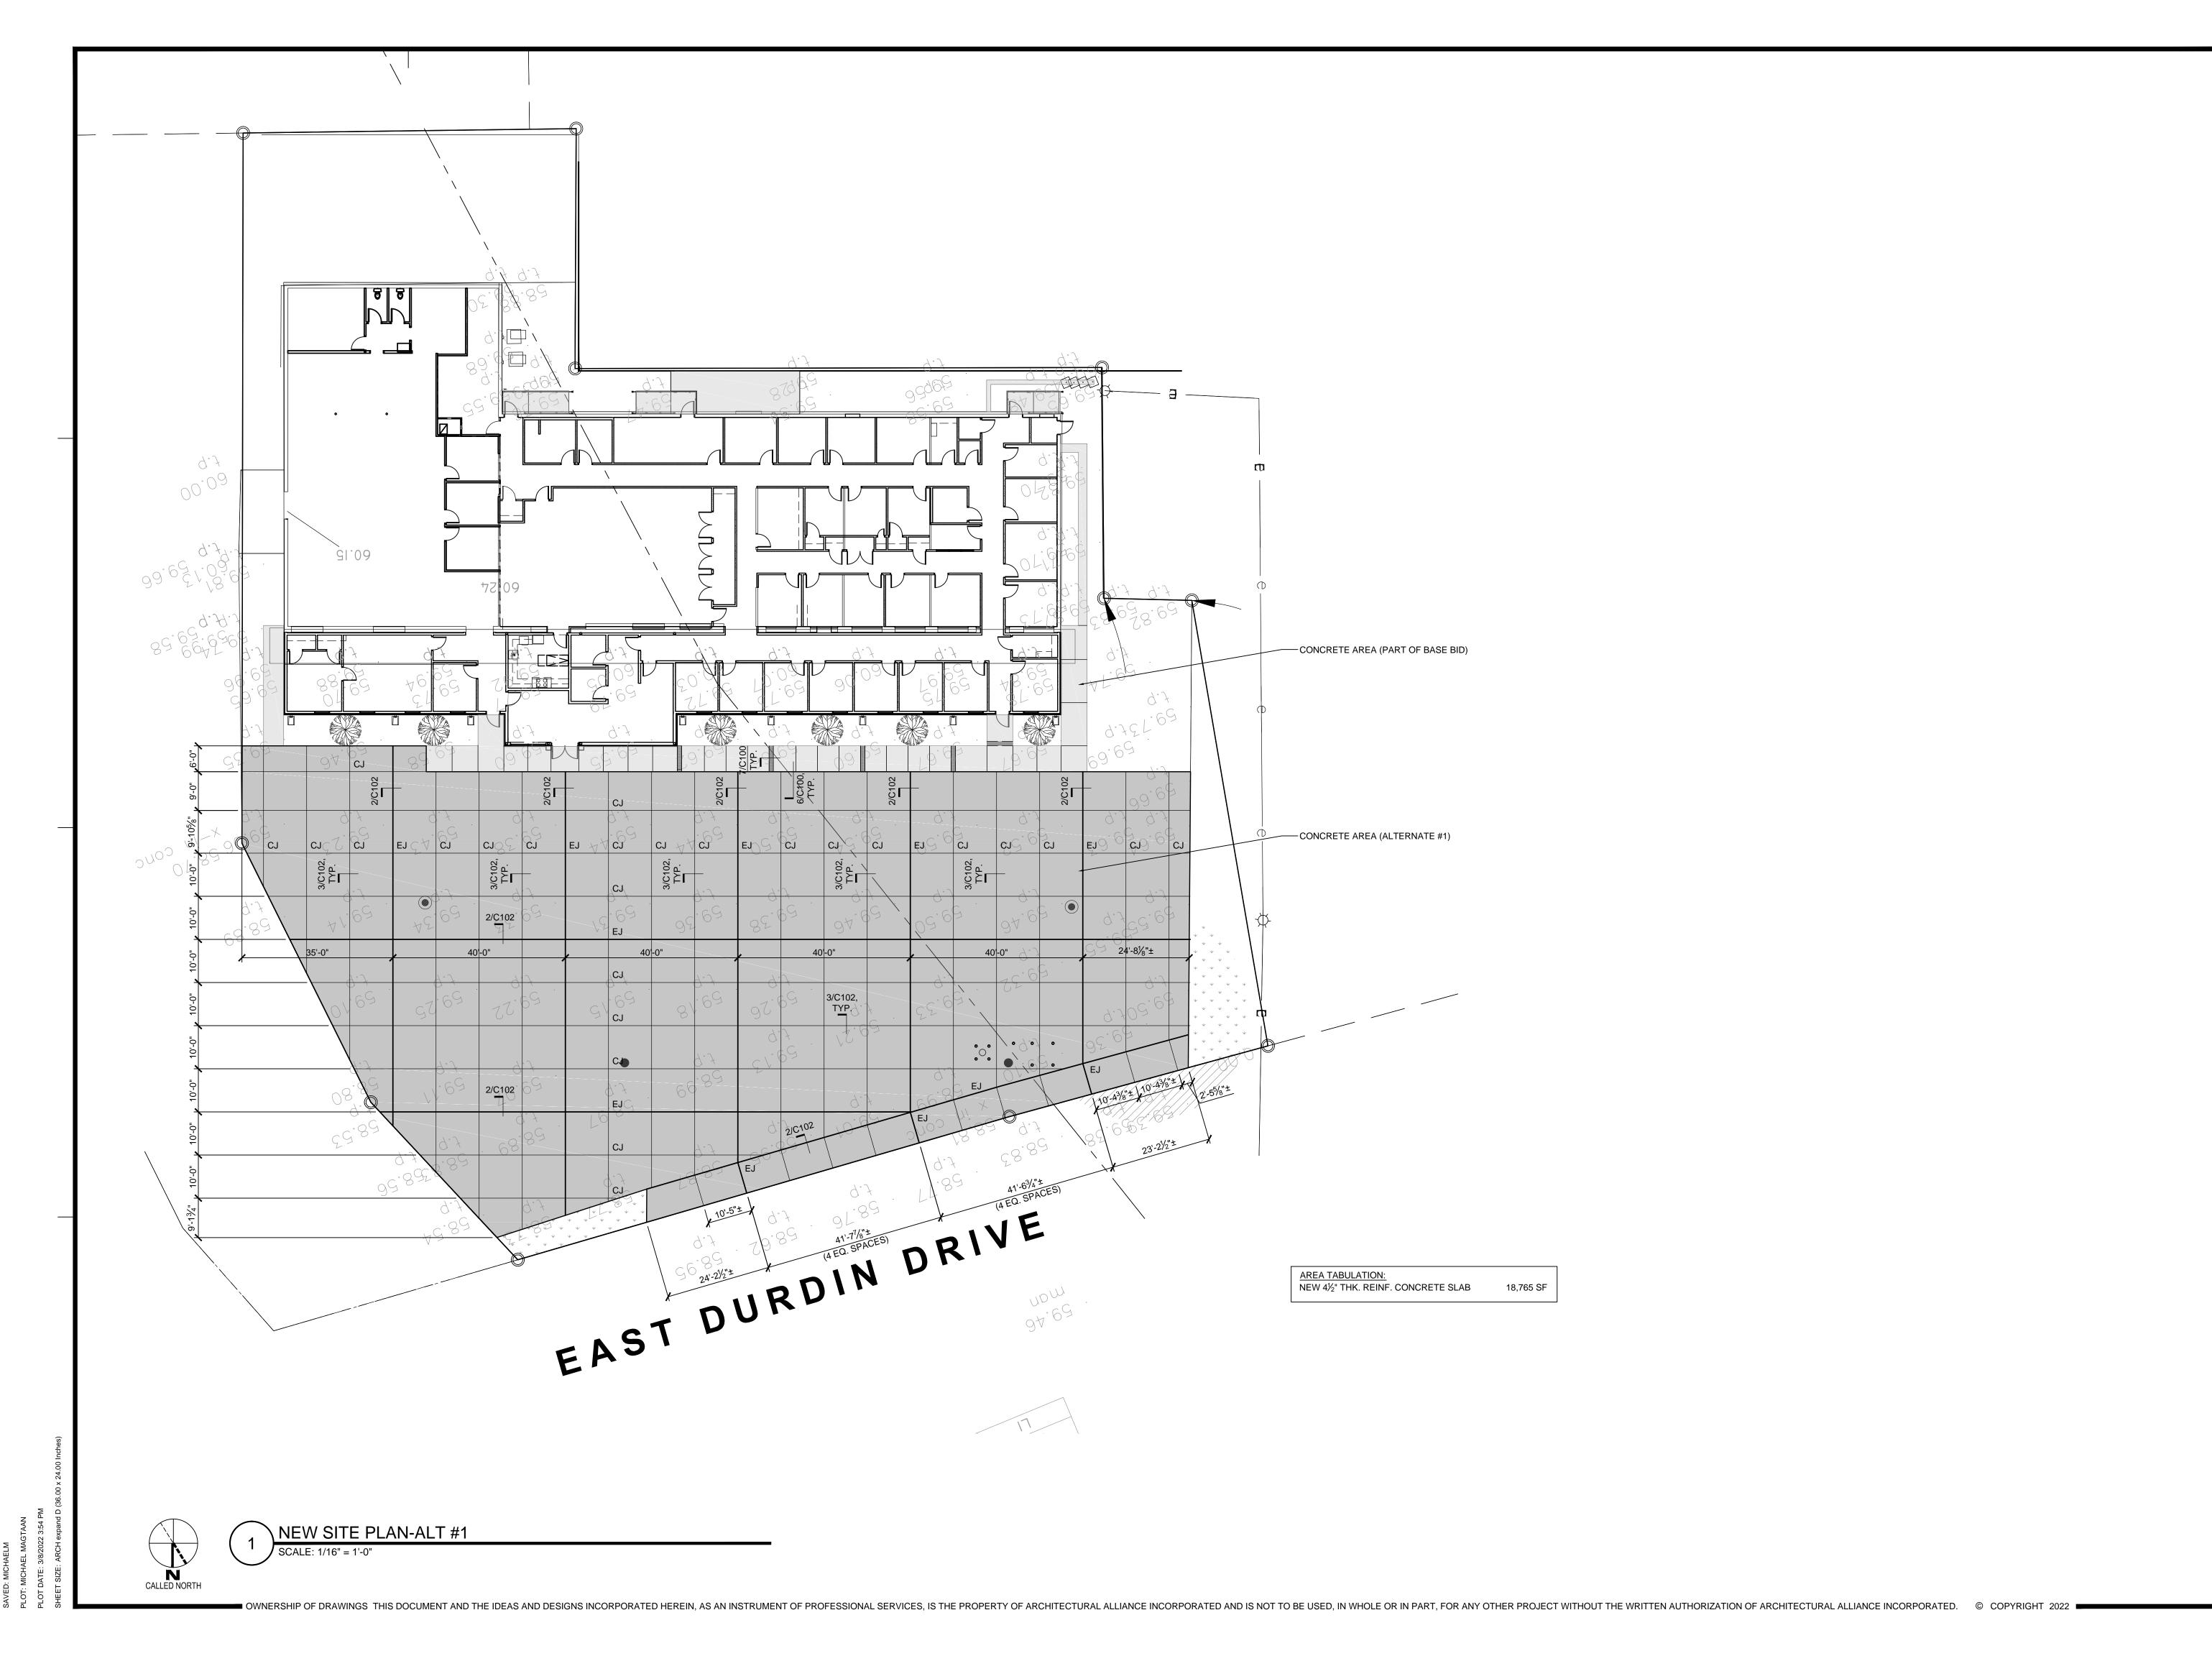

Architectural Alliance Incorporate

350 Pine Street, Suite 720
Edison Plaza
Beaumont, Texas 77701
TEL (409) 866-7196
FAX (409) 866-1745

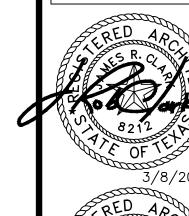



SPINDLETOP SILSBEE

22 E Durdin Drive

ISSUED FOR
SCHEMATIC DESIGN

DATE: 10-11-2021

DESIGN DEVELOPMENT

DATE: 12/20/2021

BIDS & CONSTRUCTION X

DATE: 2/28/2021

REVISION: 1 DATE: 3/7/2022


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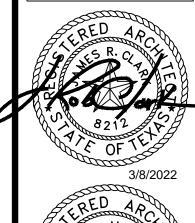
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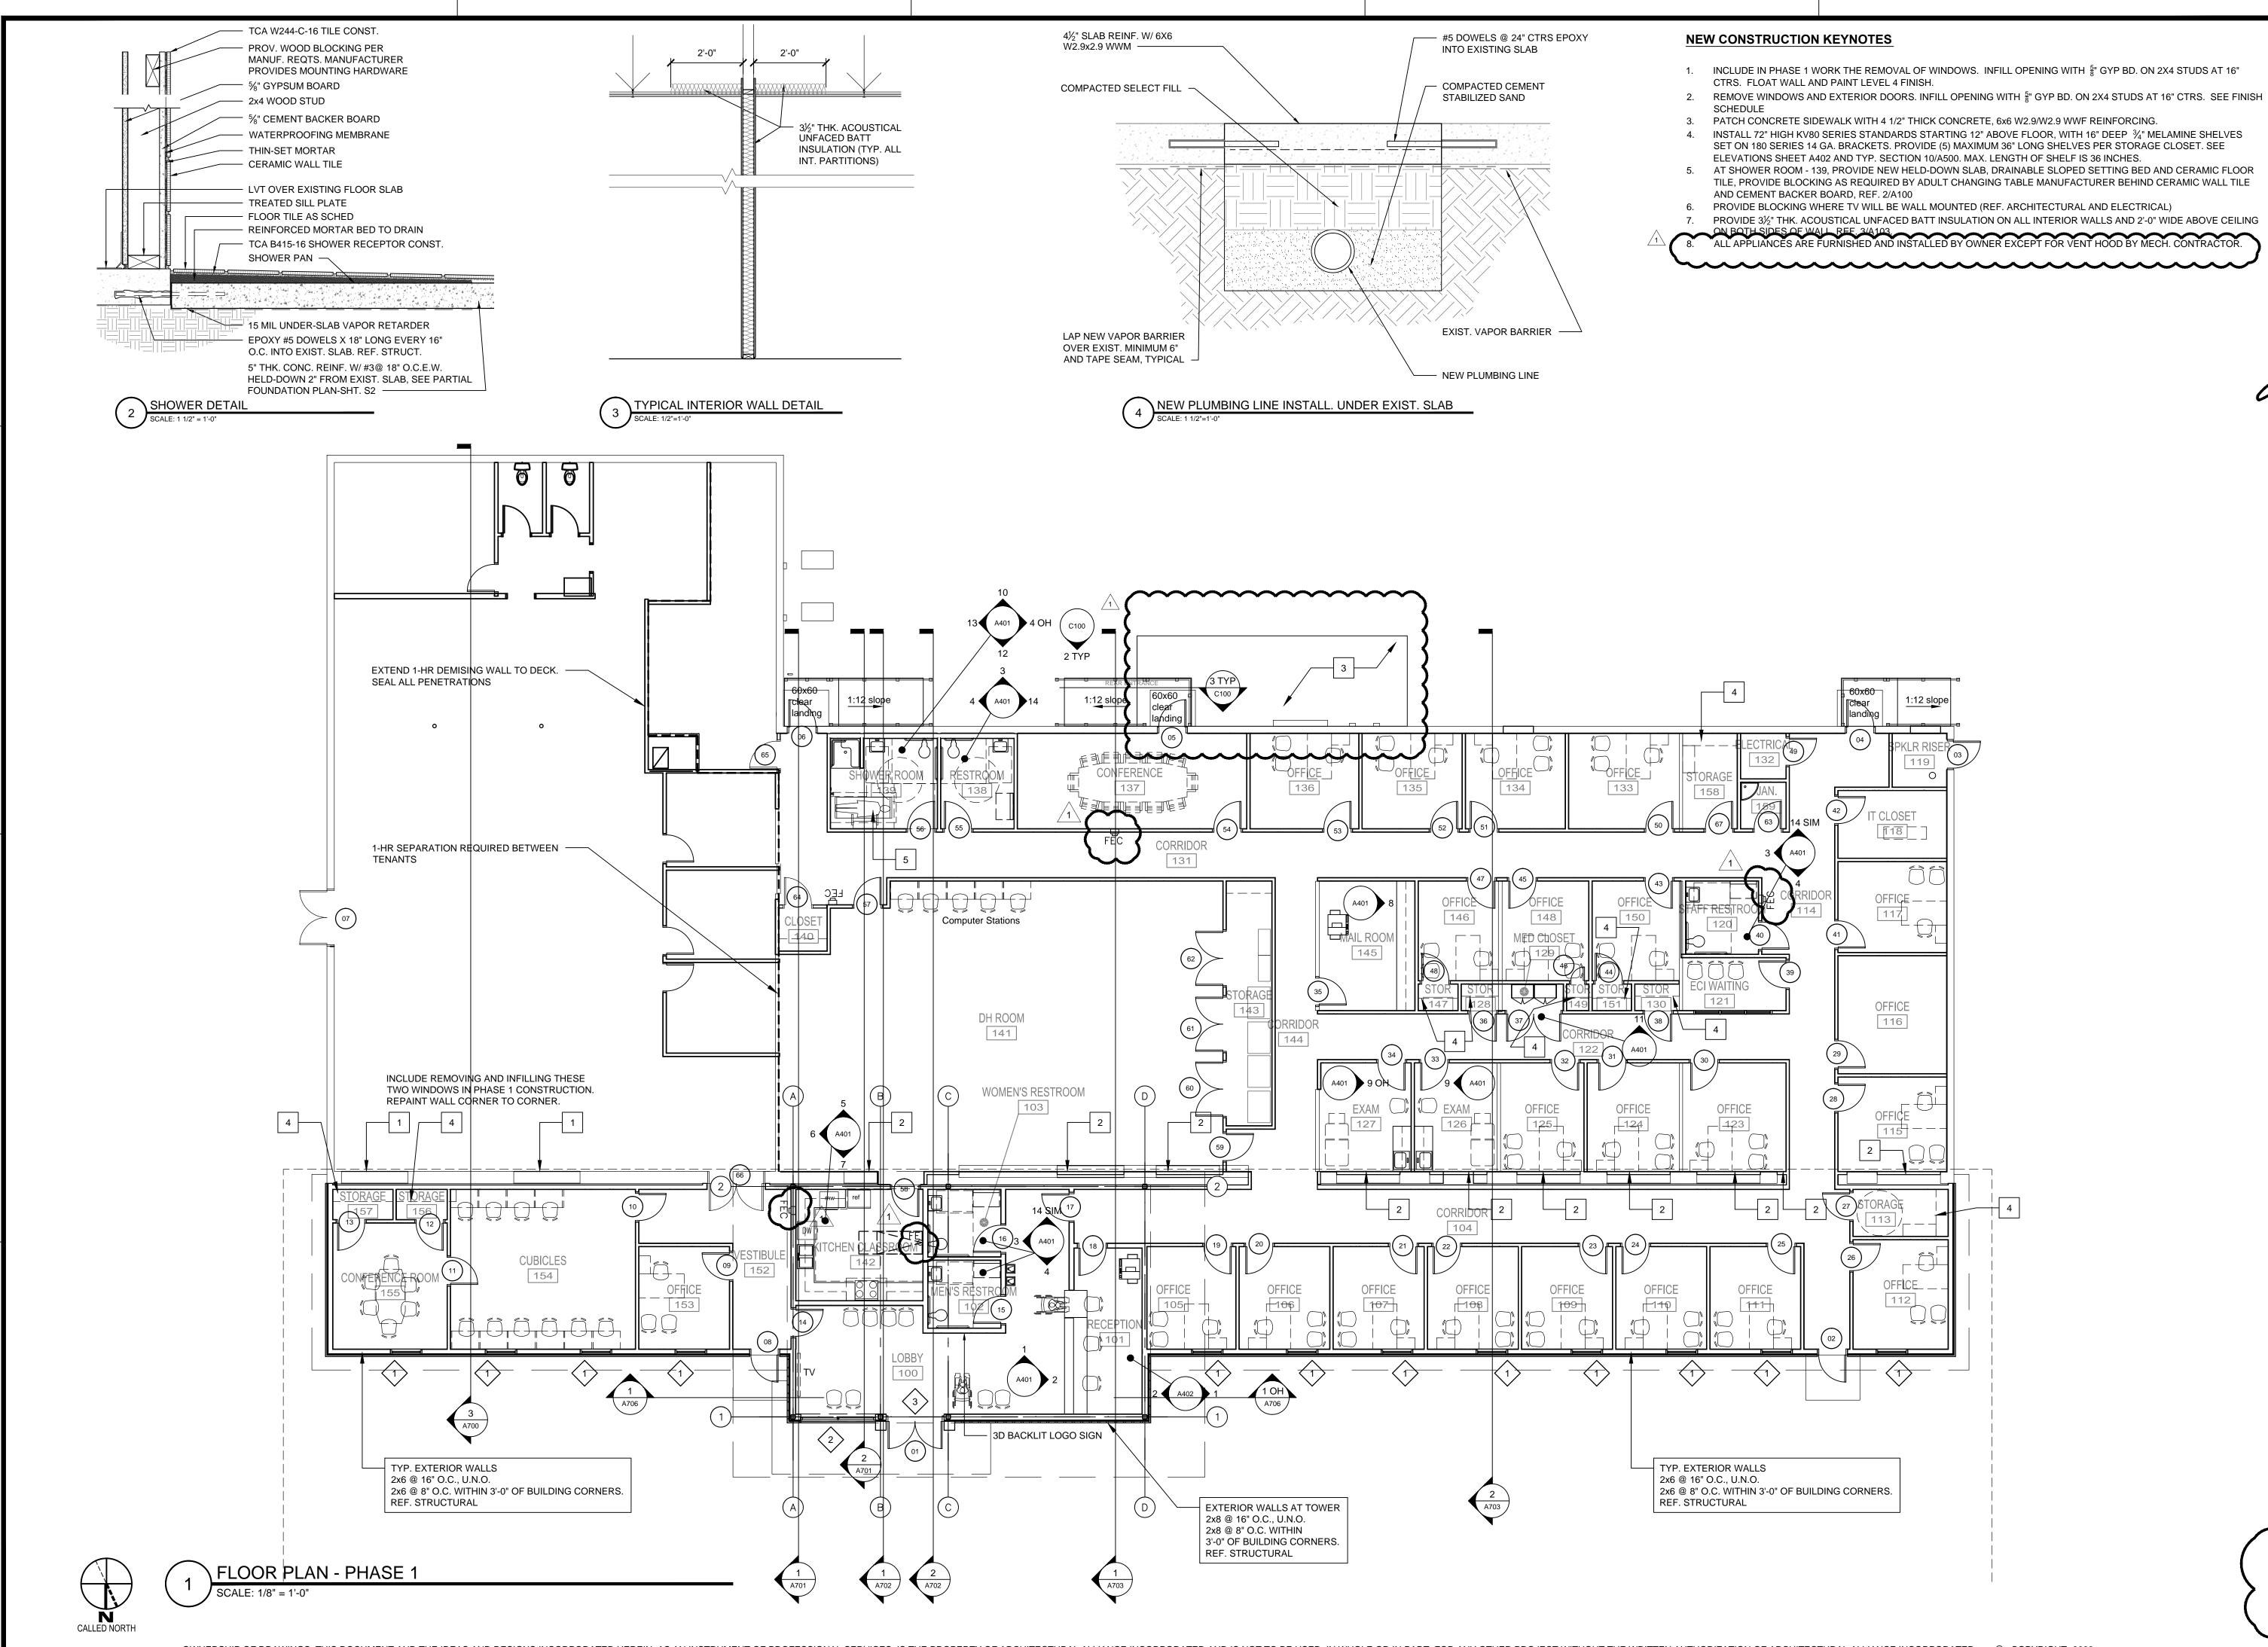
NEW SITE
PLAN-ALT #1

SHEET NUMBER
C103

21061 PROJECT NAMBE





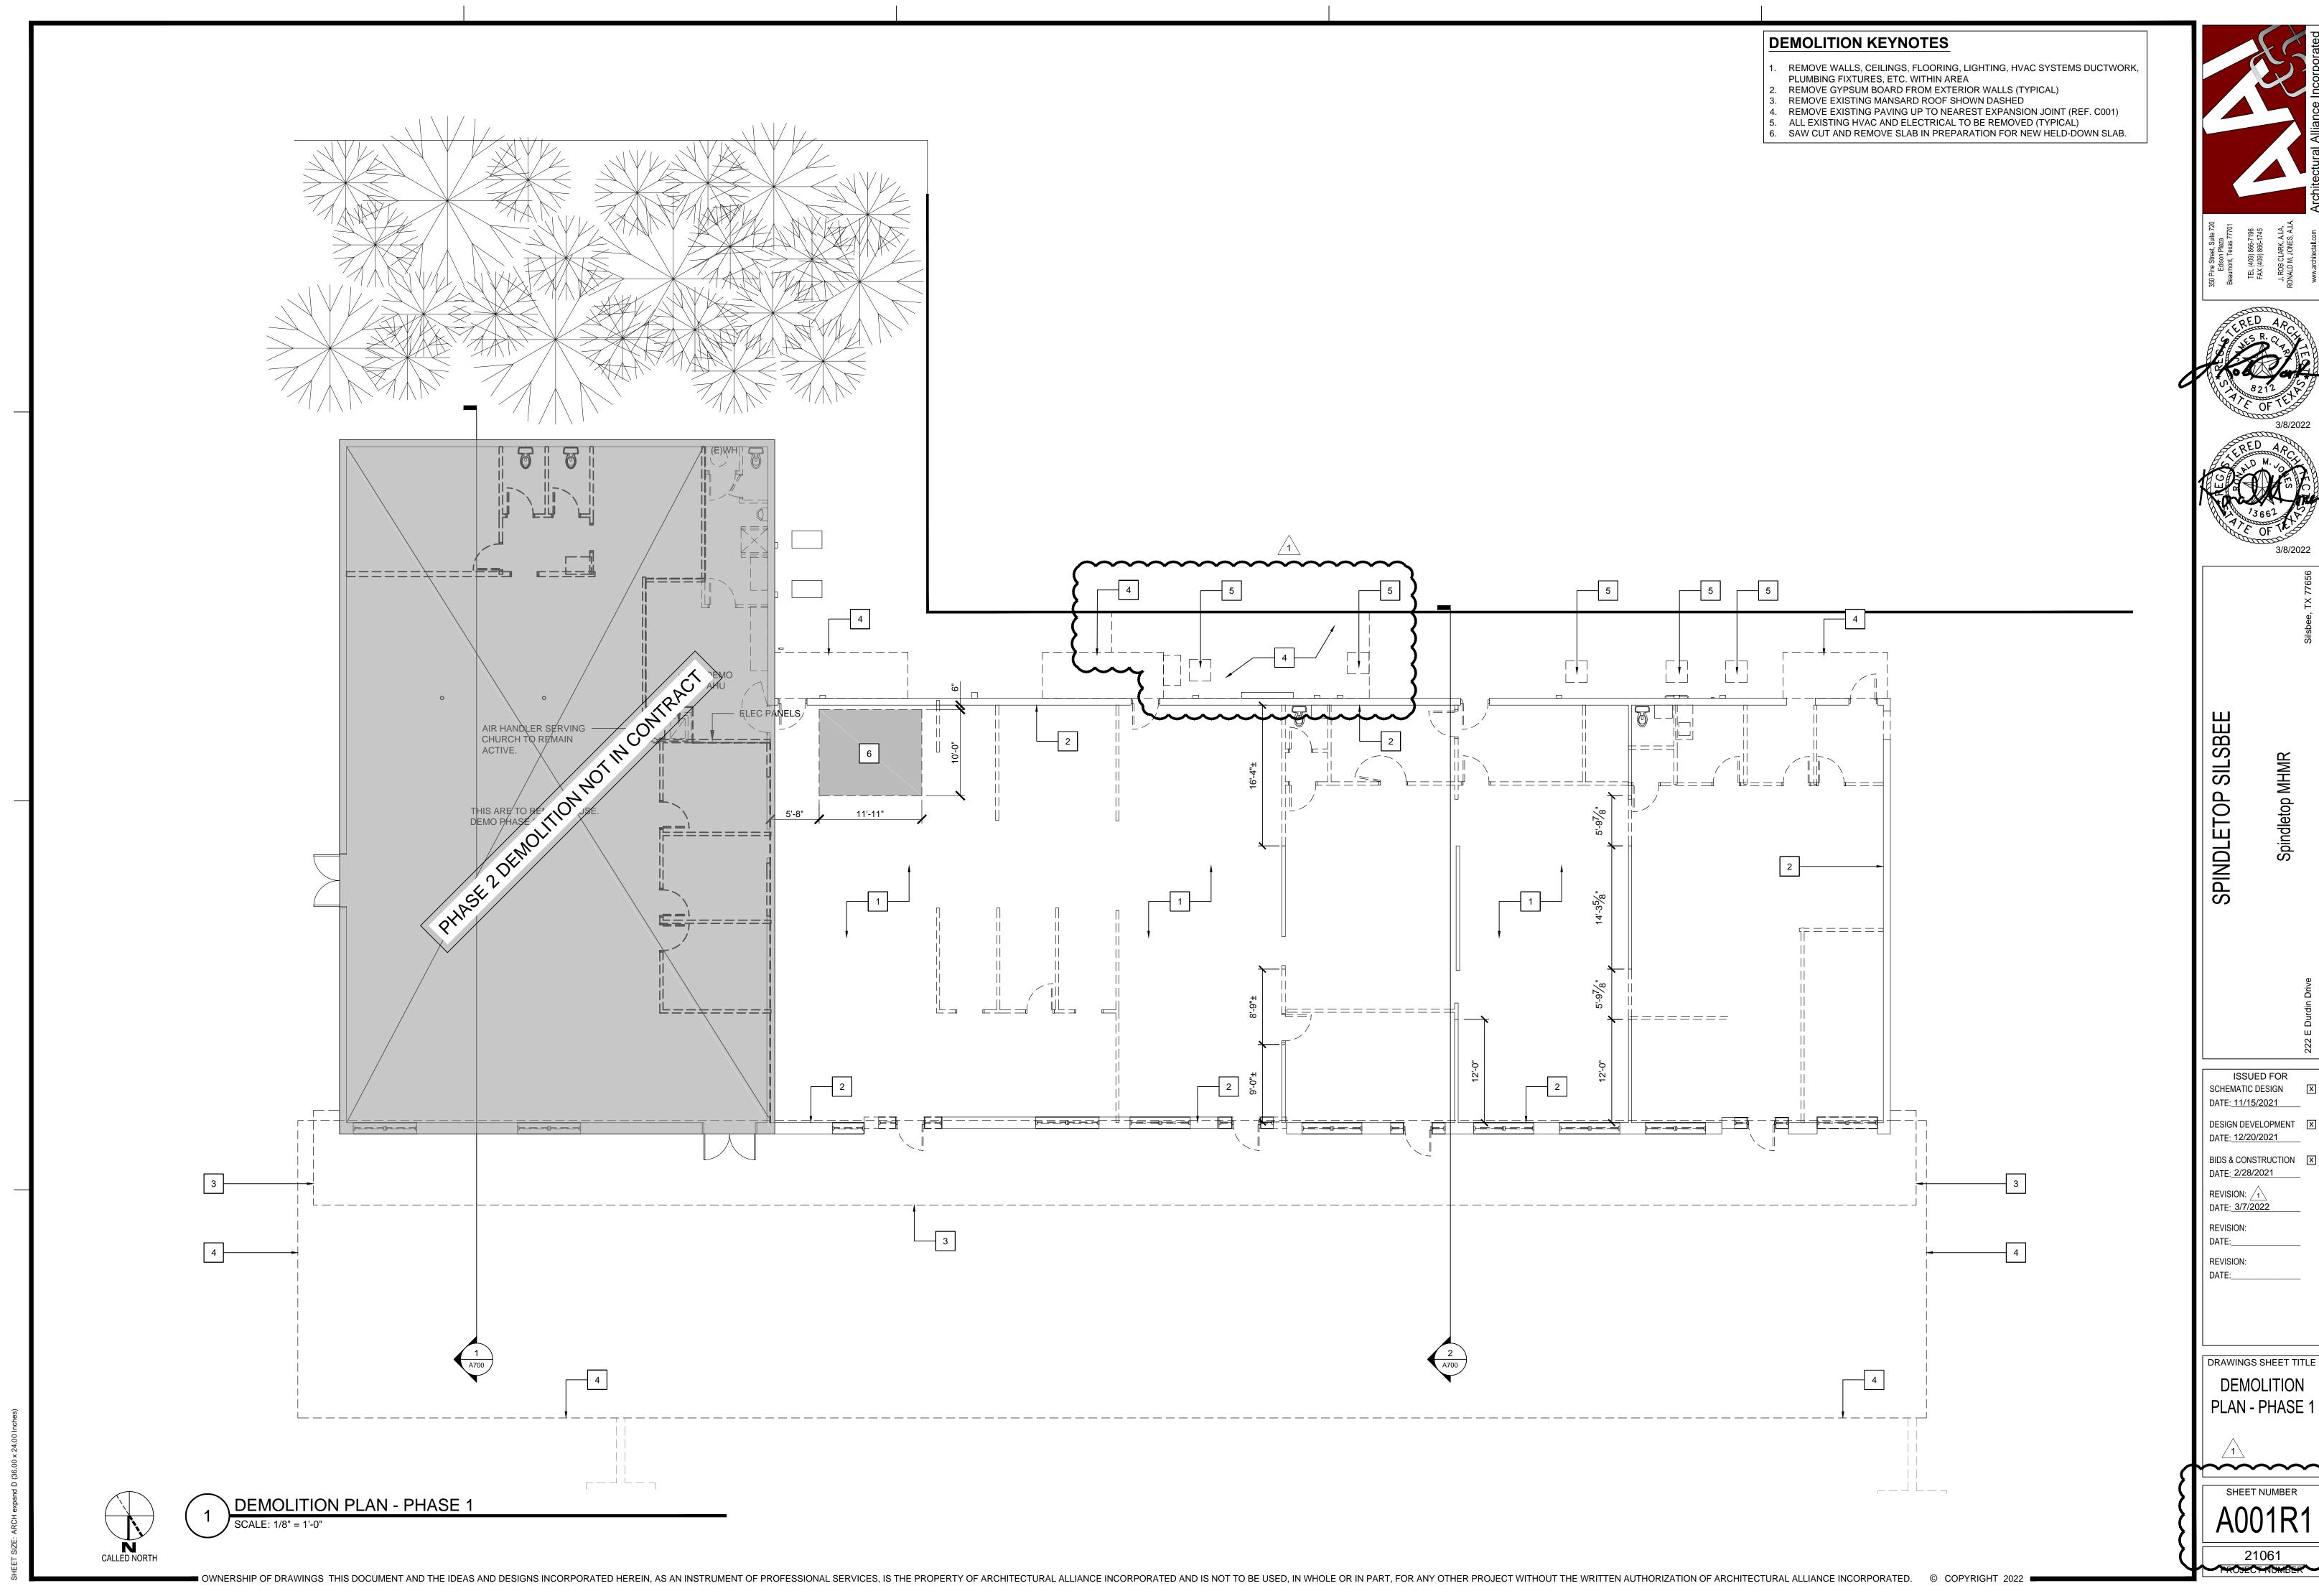

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ISSUED FOR SCHEMATIC DESIGN DATE: 11/15/2021 DESIGN DEVELOPMENT X

DATE: 12/20/2021 BIDS & CONSTRUCTION X DATE: 2/28/2021


REVISION: /1 DATE: 3/7/2022

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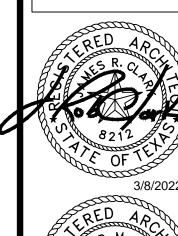
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DRAWINGS SHEET TITLE FLOOR PLAN -PHASE 1

SHEET NUMBER 21061



CALLED NORTH

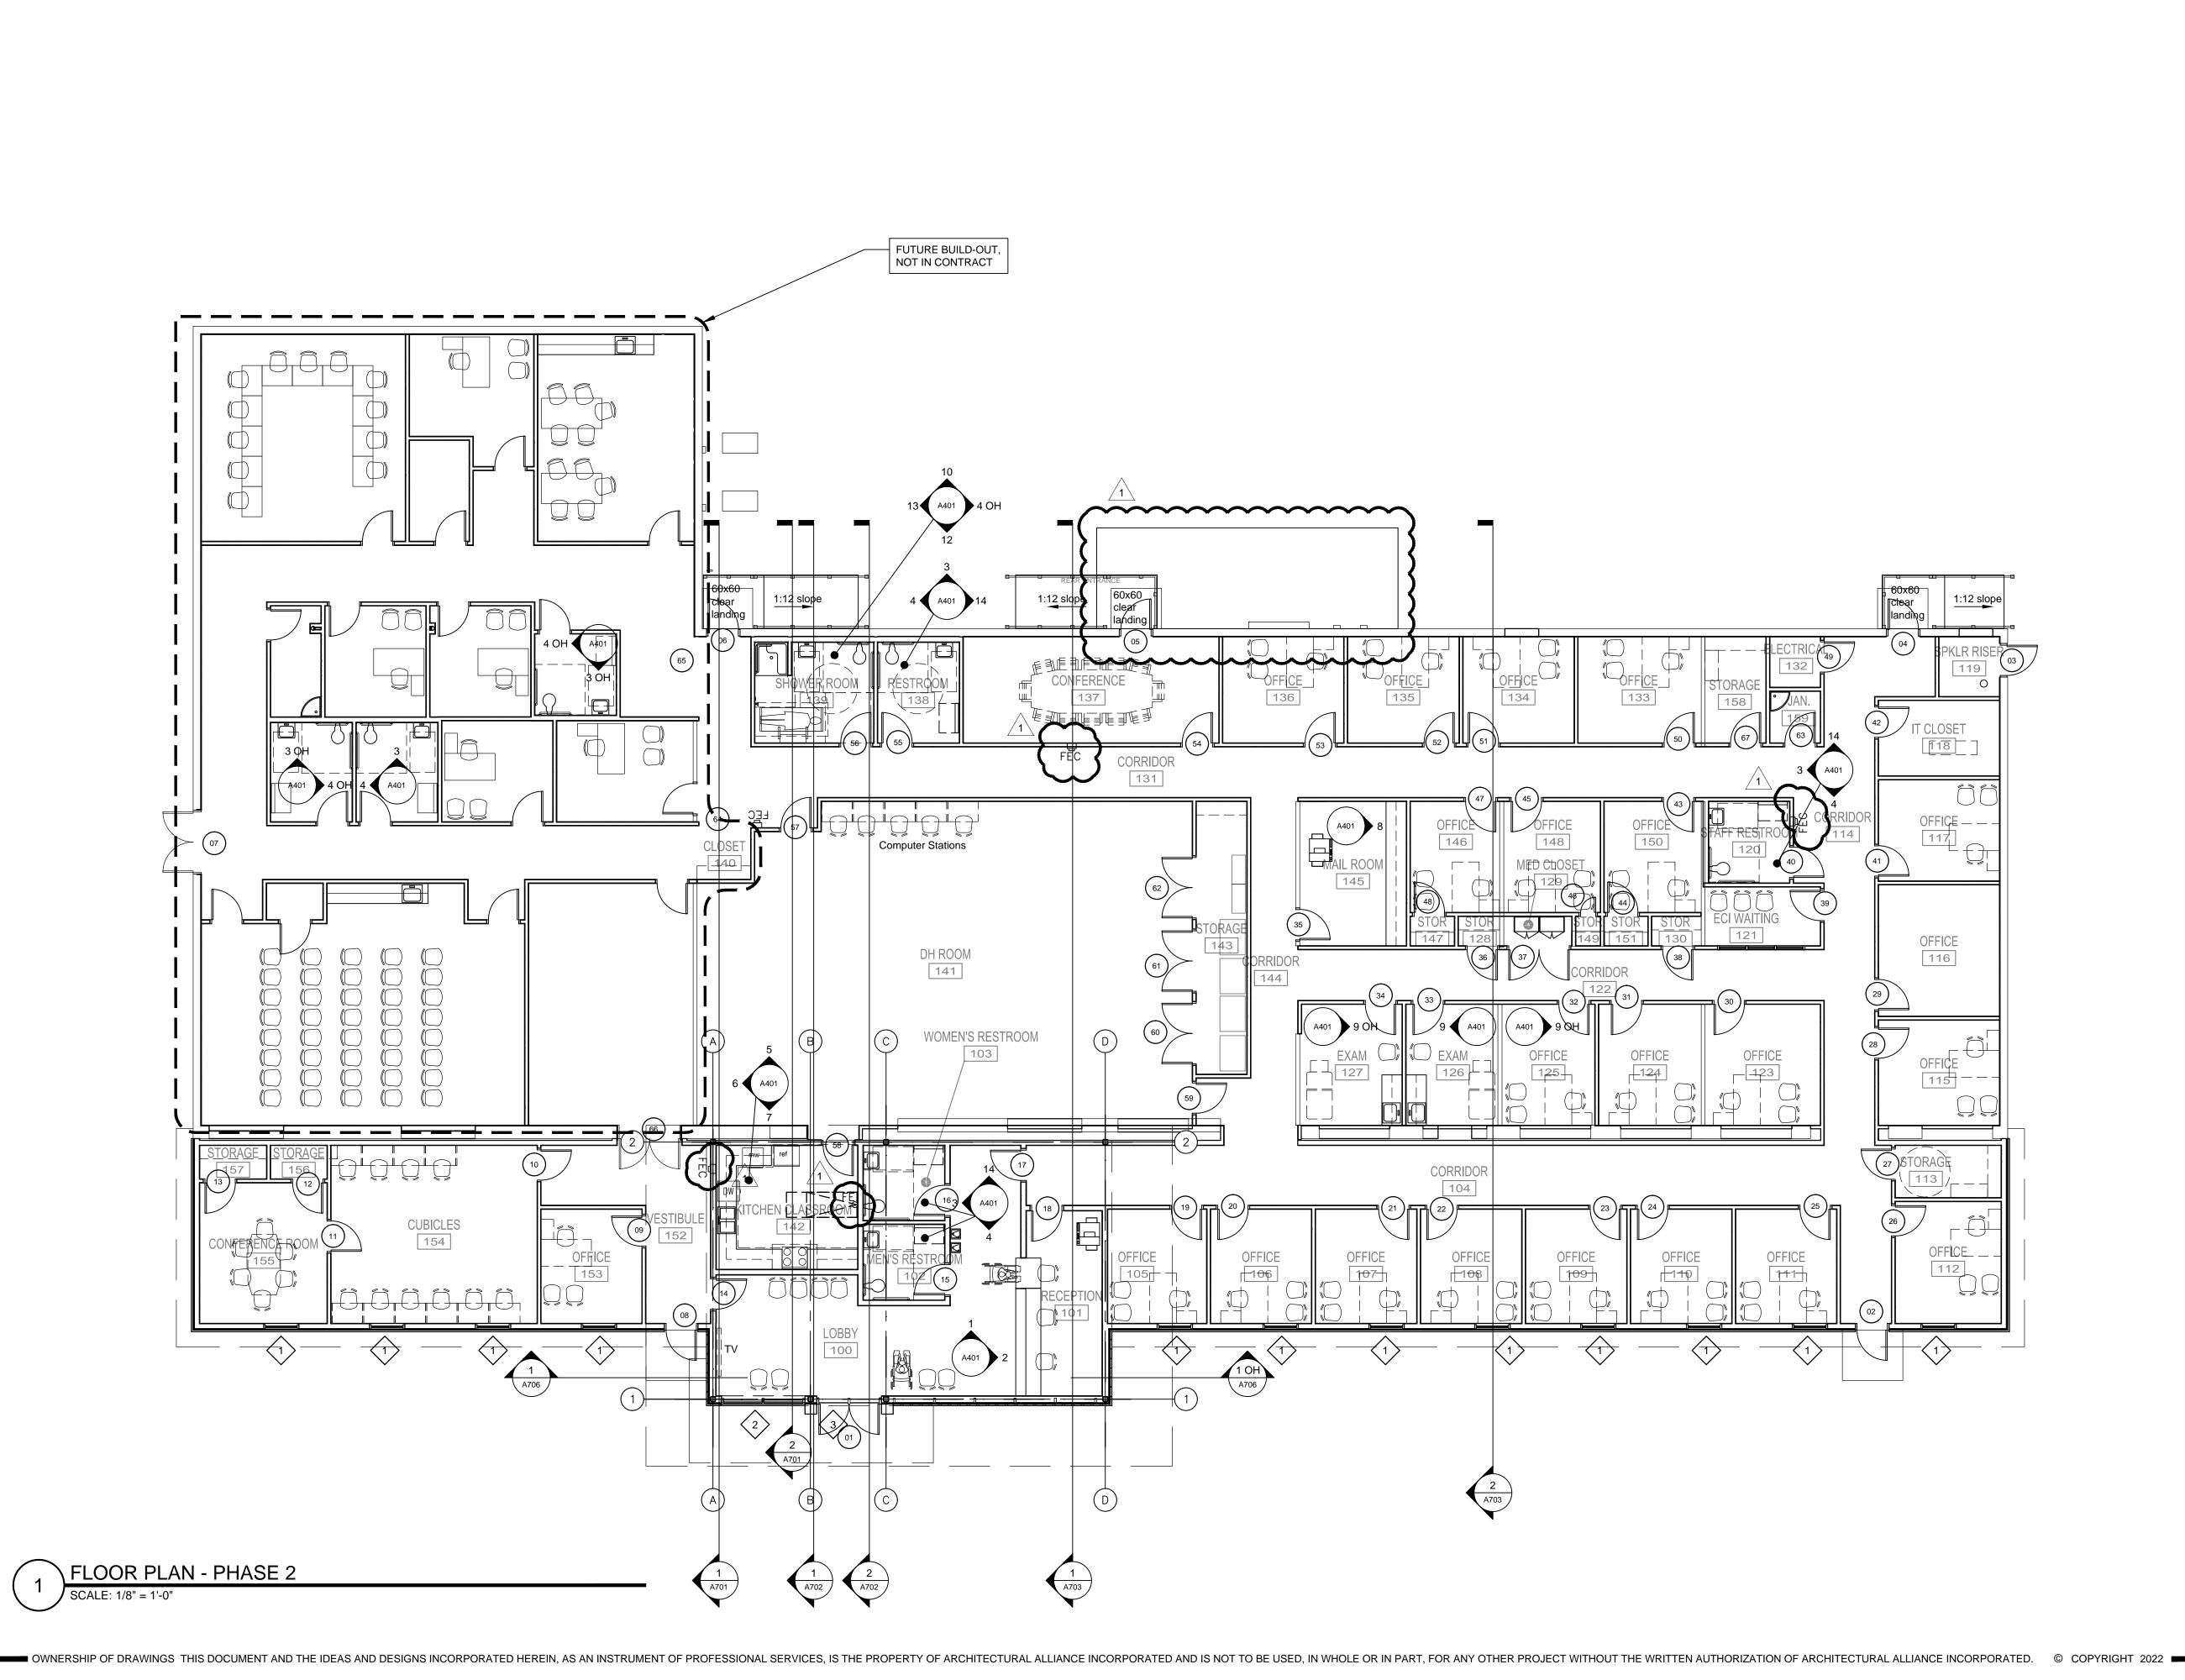



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SPINDLETOP

SCHEMATIC DESIGN DATE: 11/15/2021 DESIGN DEVELOPMENT X

ISSUED FOR

DATE: 12/20/2021 BIDS & CONSTRUCTION X DATE: 2/28/2021

REVISION: /1 DATE: 3/7/2022


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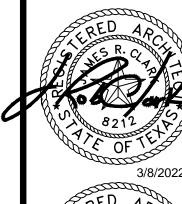
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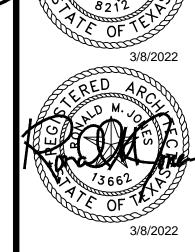
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FLOOR PLAN -PHASE 2

SHEET NUMBER 





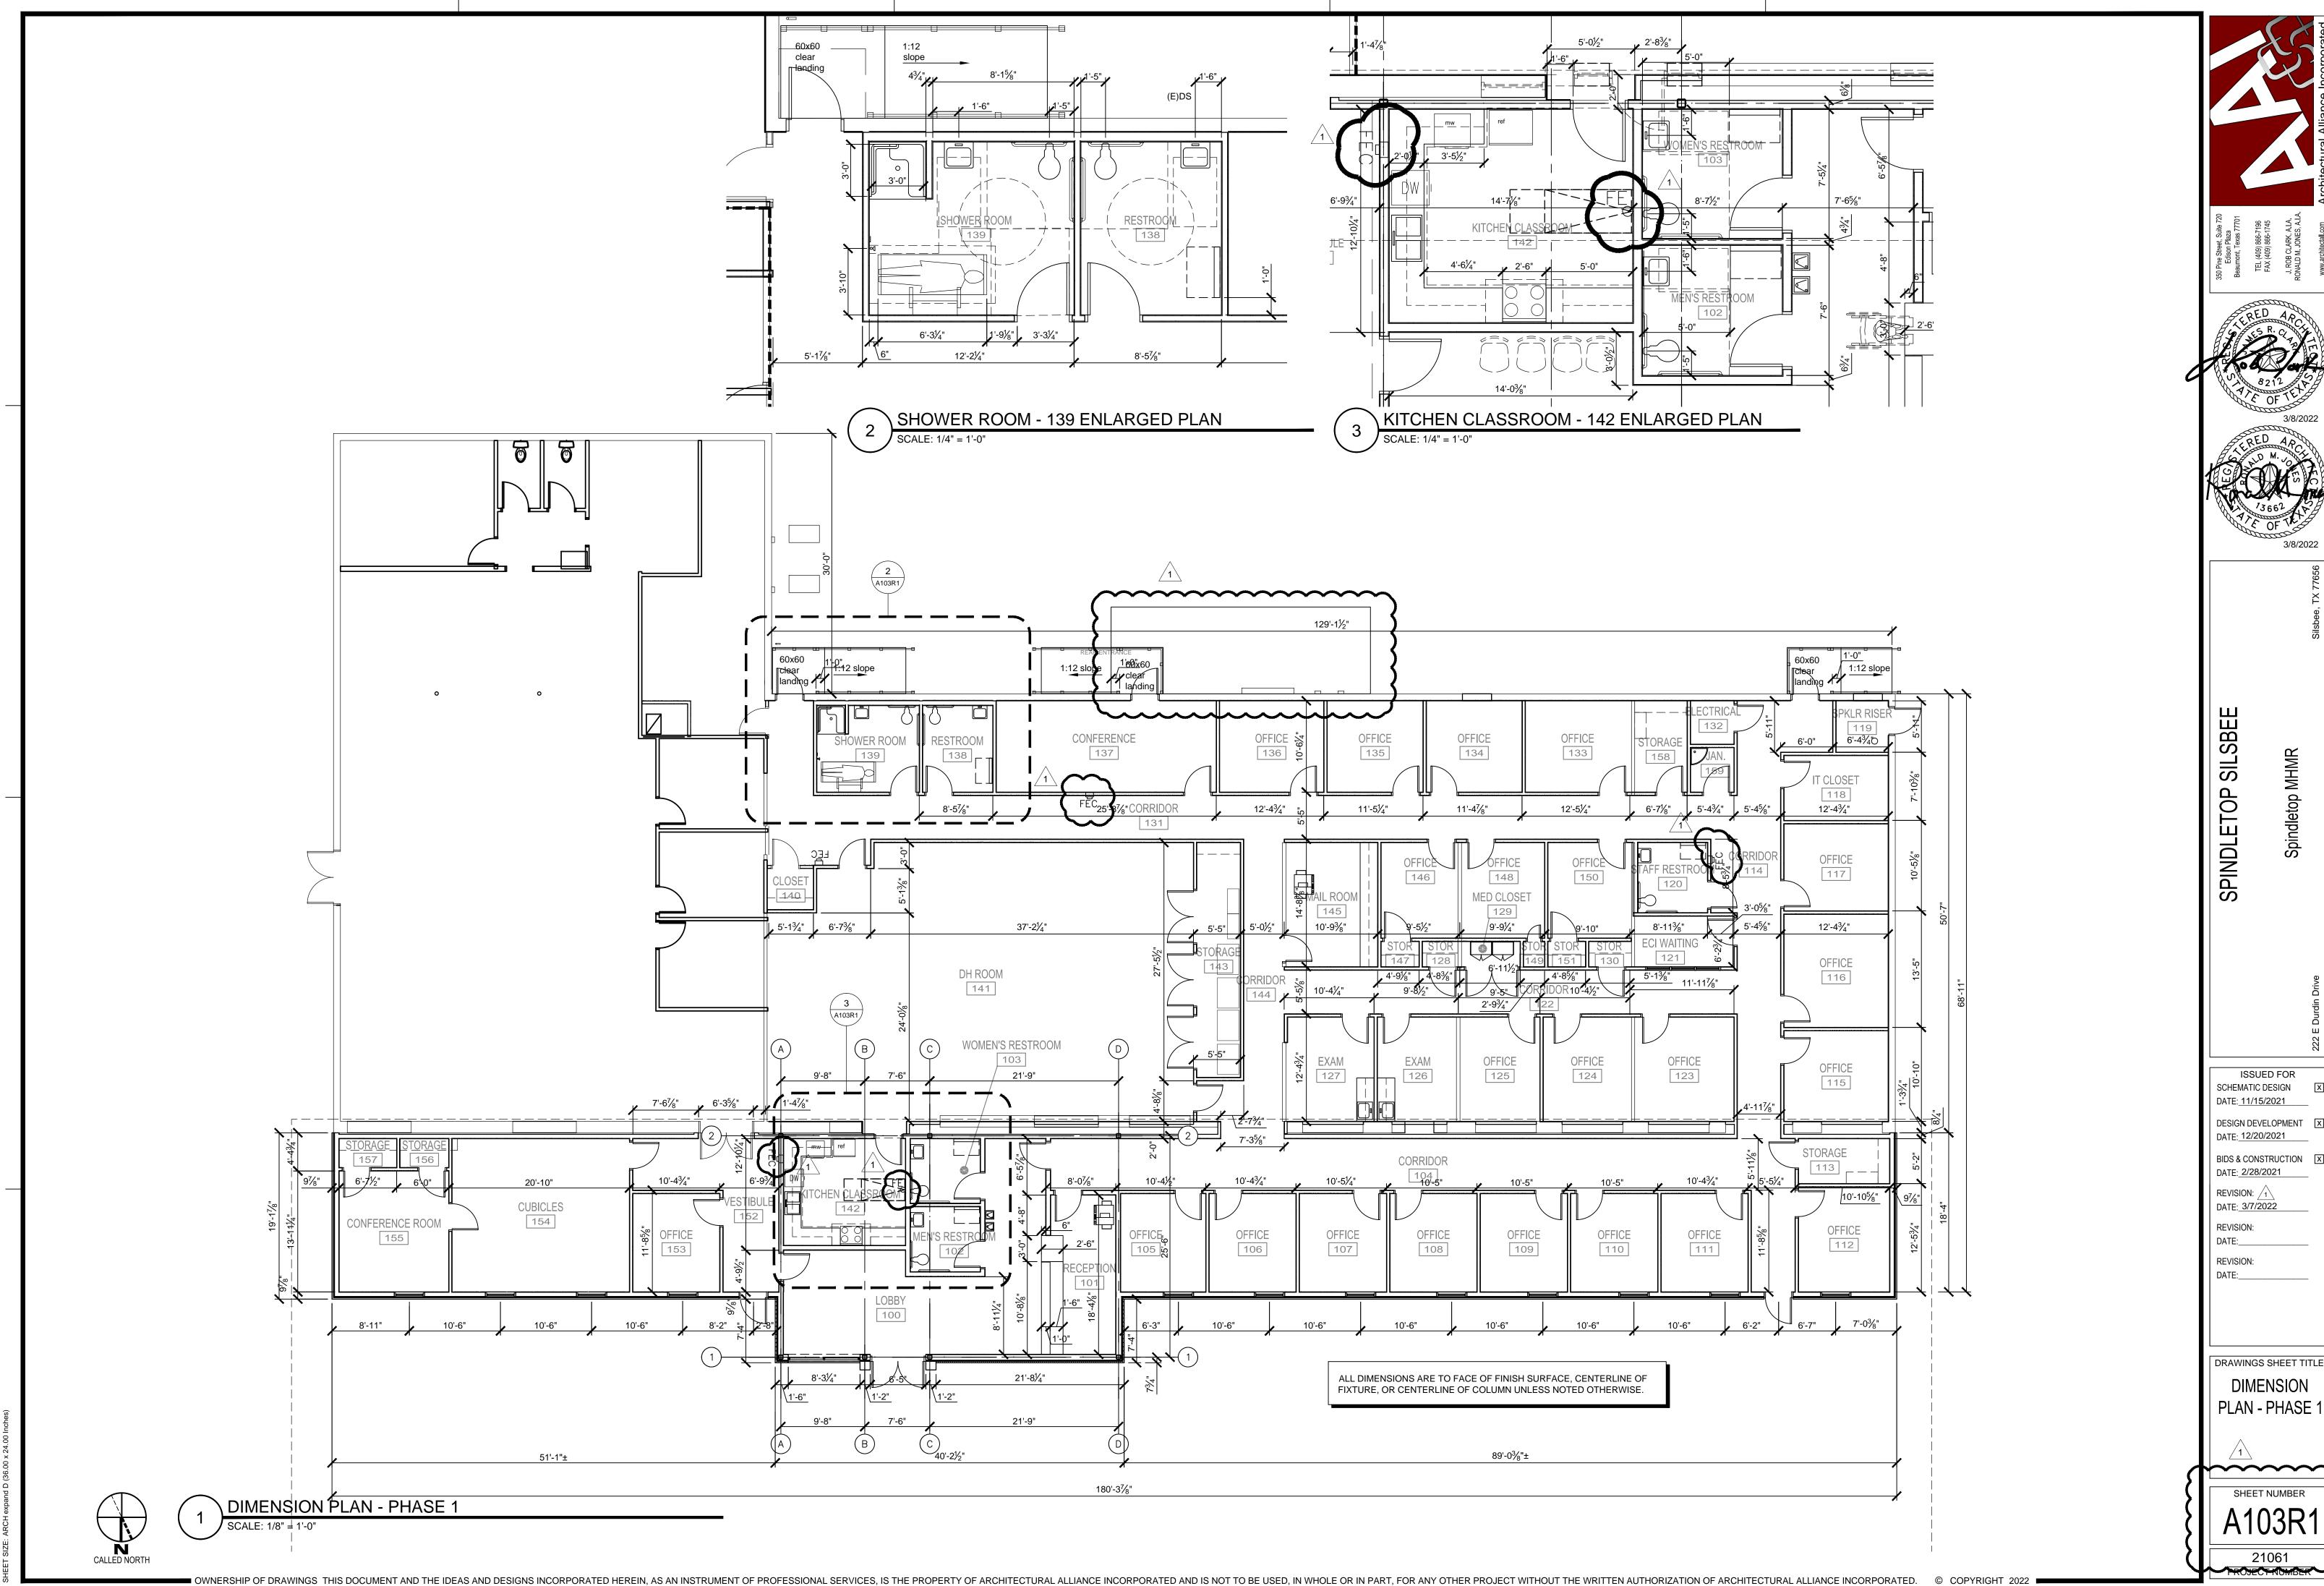


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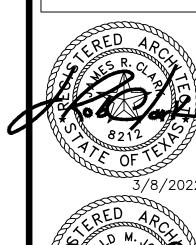
DATE: 12/20/2021 BIDS & CONSTRUCTION X

DATE: 3/7/2022

DIMENSION PLAN - PHASE 1

SHEET NUMBER



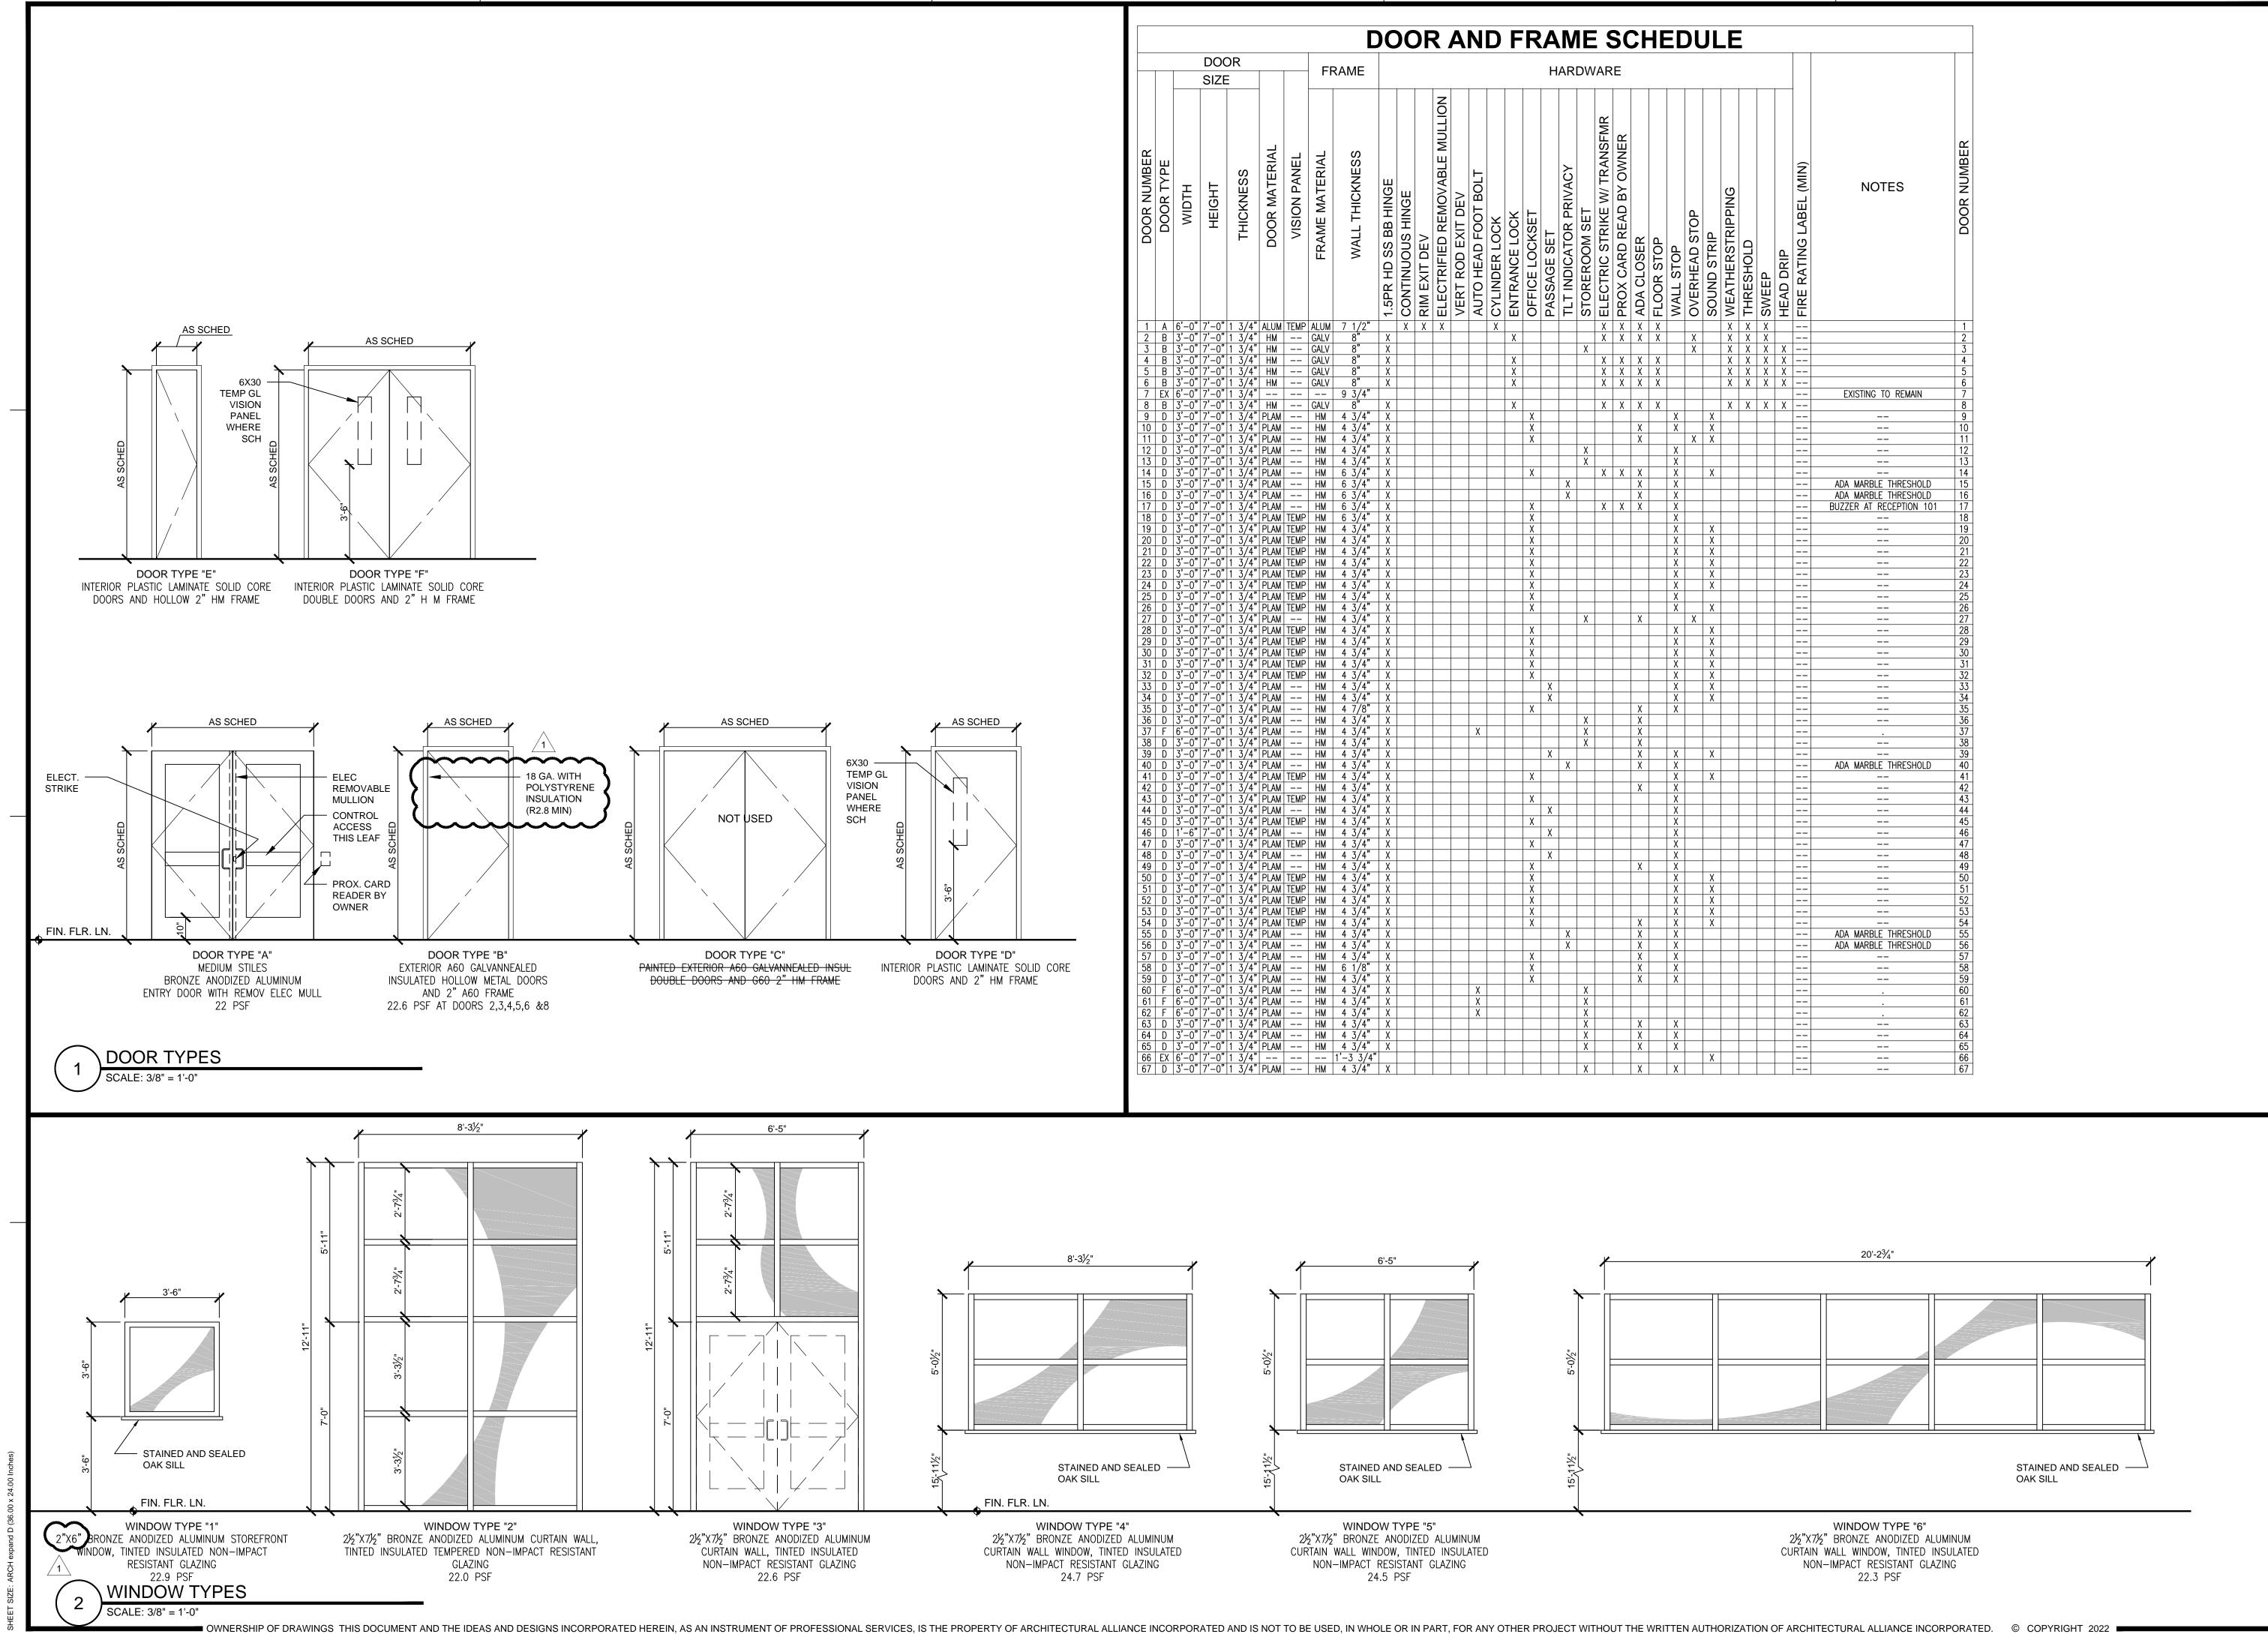



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ISSUED FOR SCHEMATIC DESIGN DATE: 11/15/2021 DESIGN DEVELOPMENT X

DATE: 12/20/2021 BIDS & CONSTRUCTION X

DATE: 2/28/2021 REVISION: /1

DATE: 3/7/2022 REVISION:

DATE:\_\_\_ REVISION:


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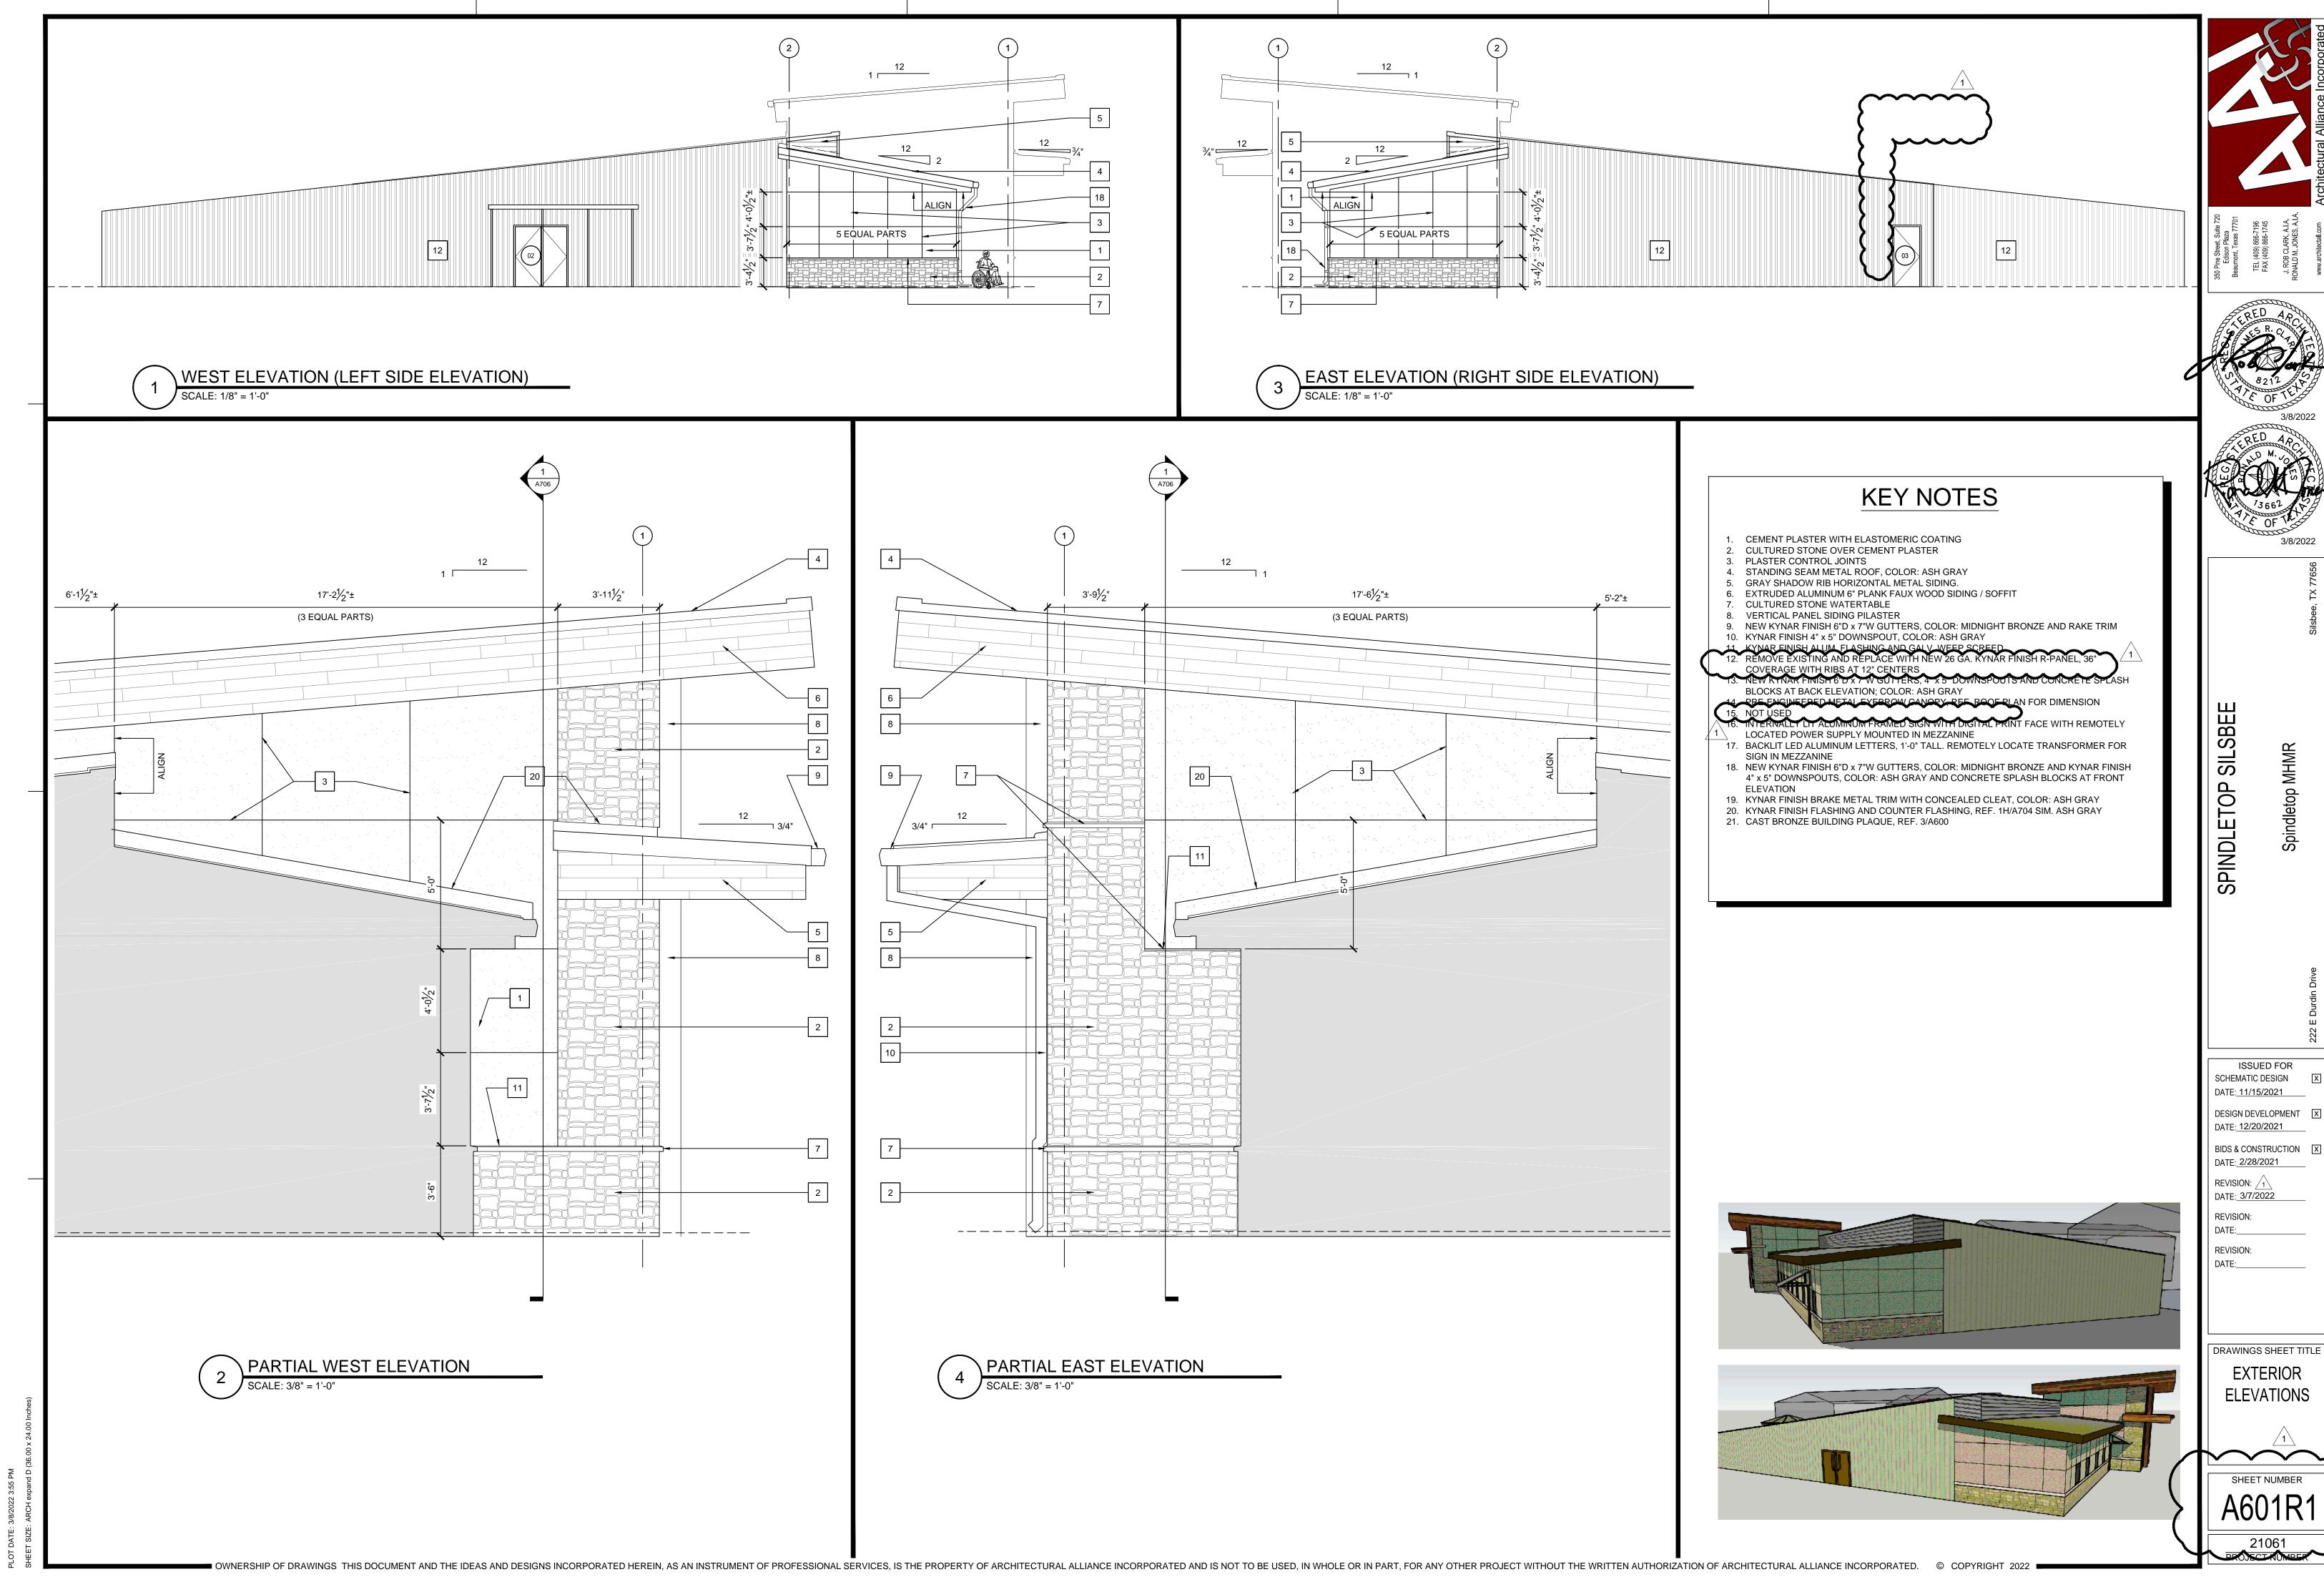
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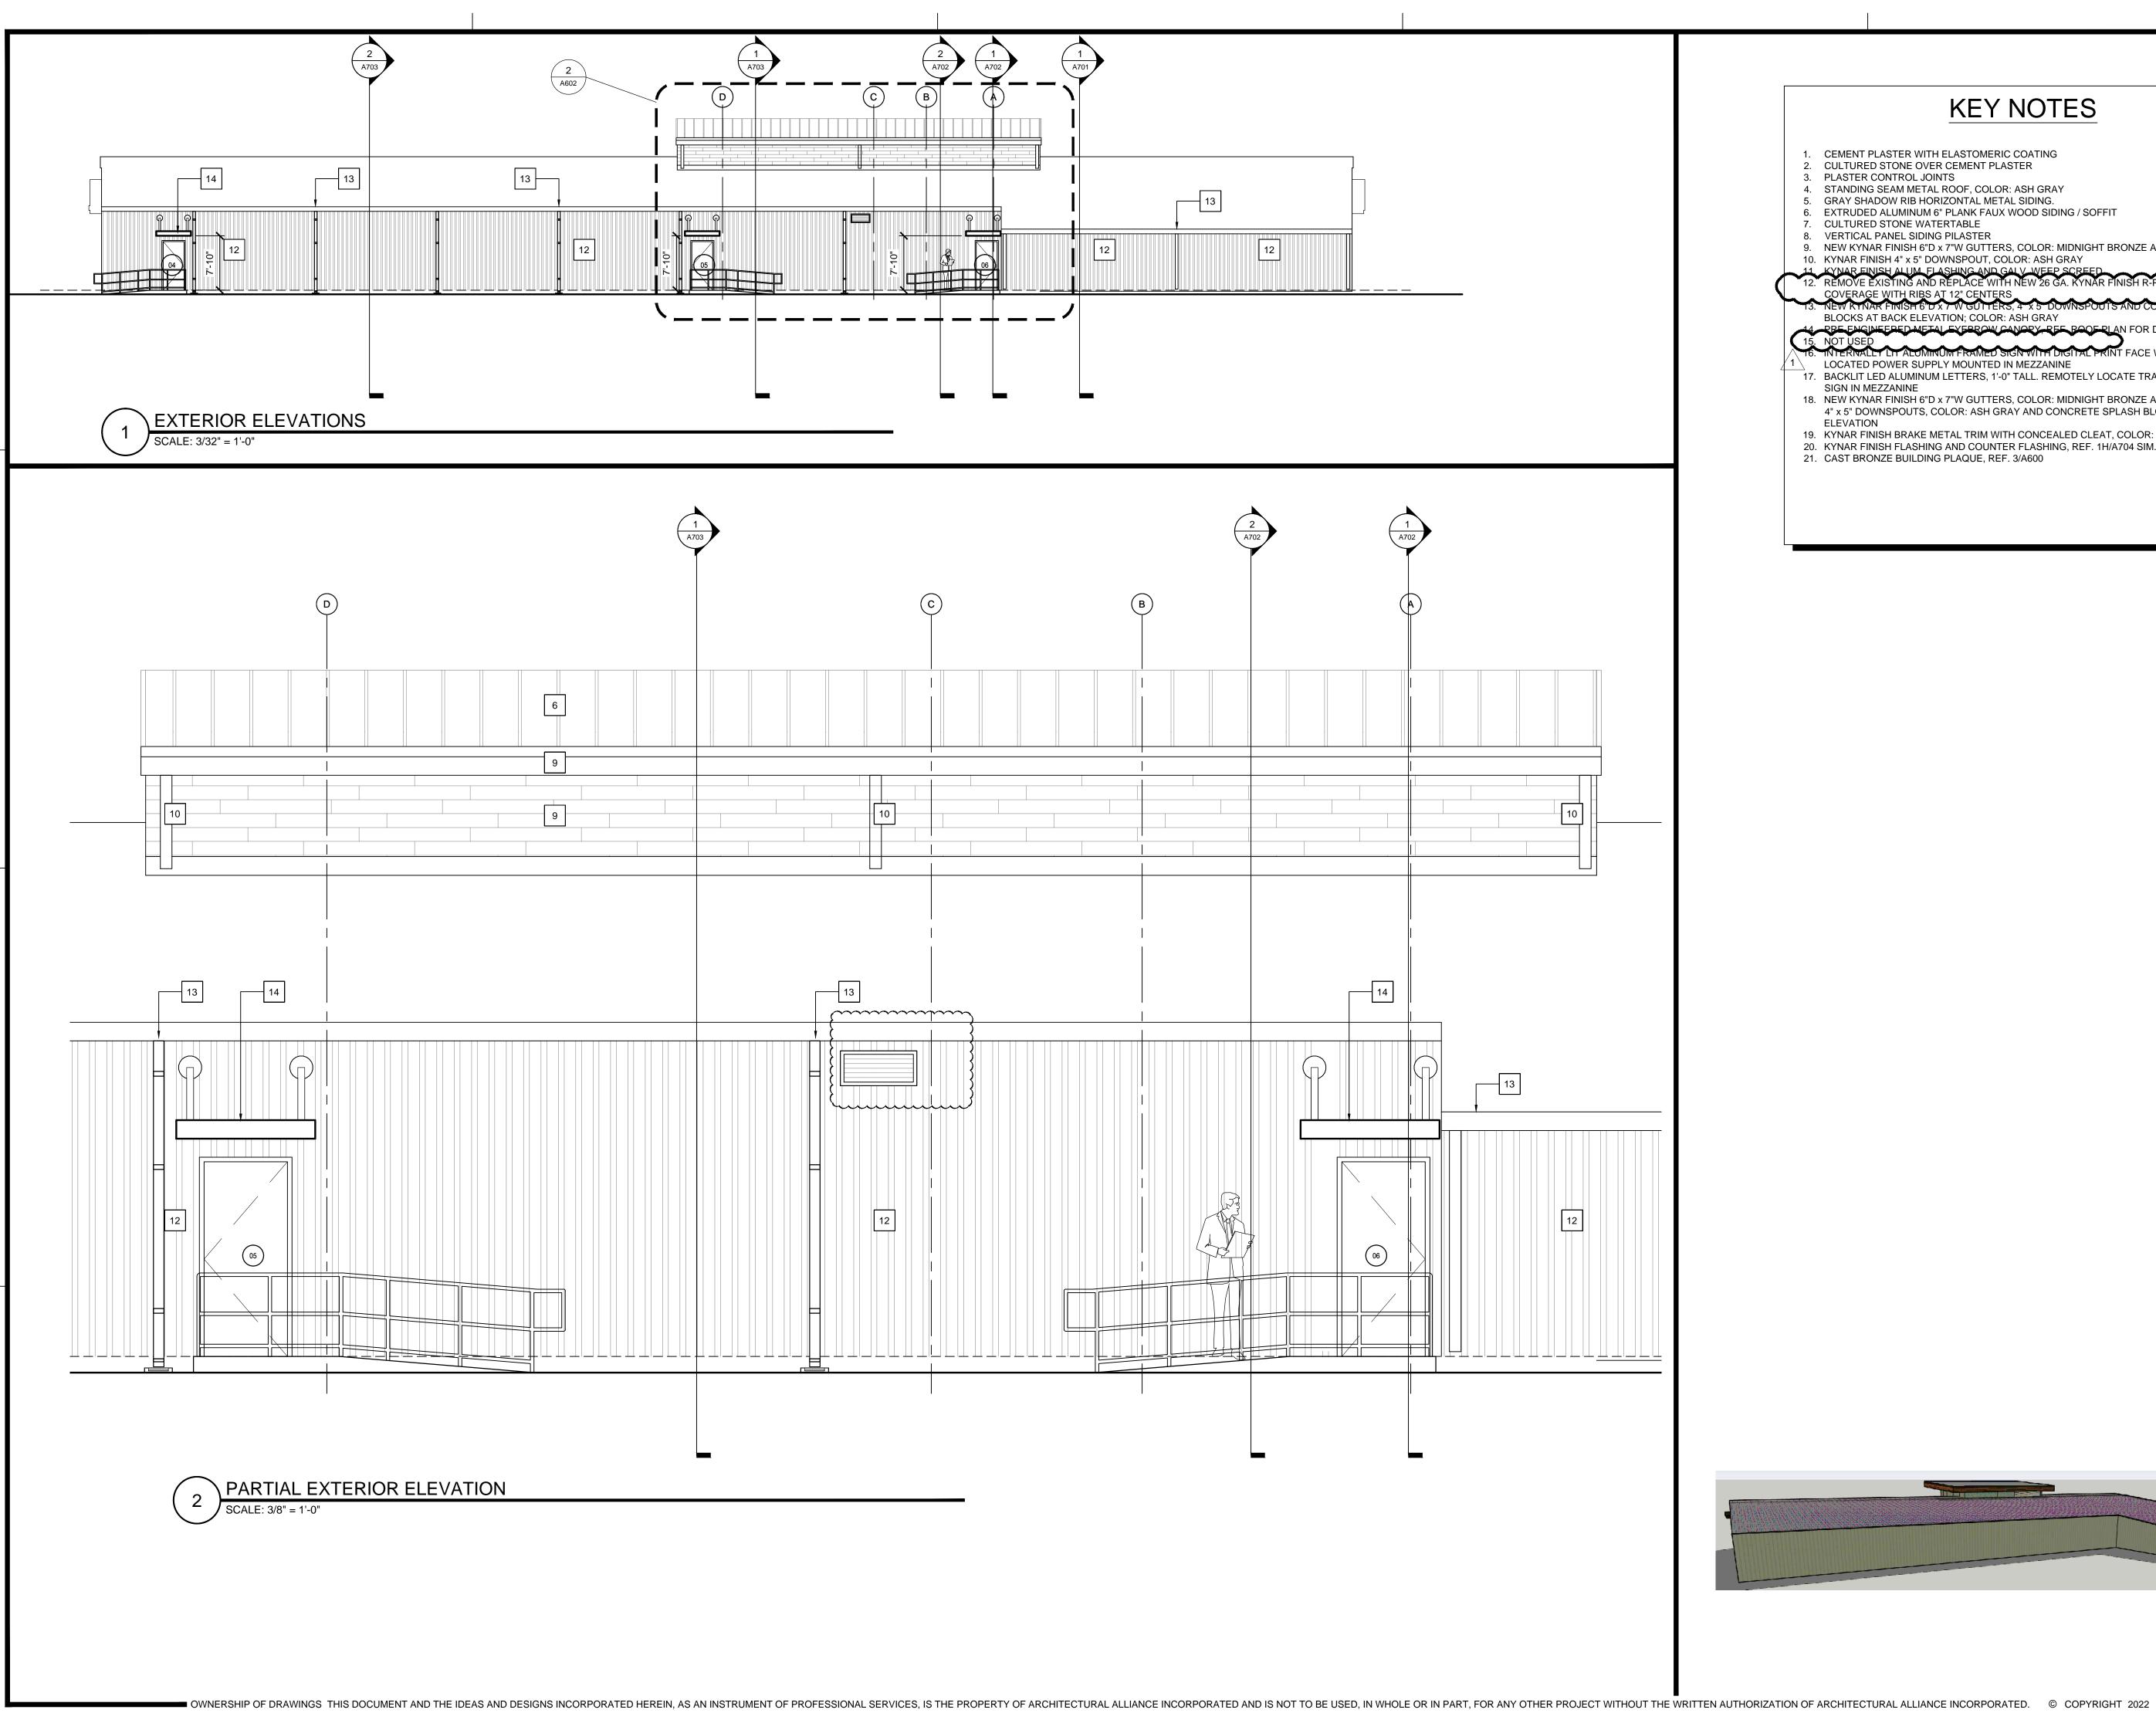
SHEET NUMBER 21061

PROJECT-NUMBER



LOT: MICHAEL MAGTAAN LOT DATE: 3/8/2022 3:55 PM



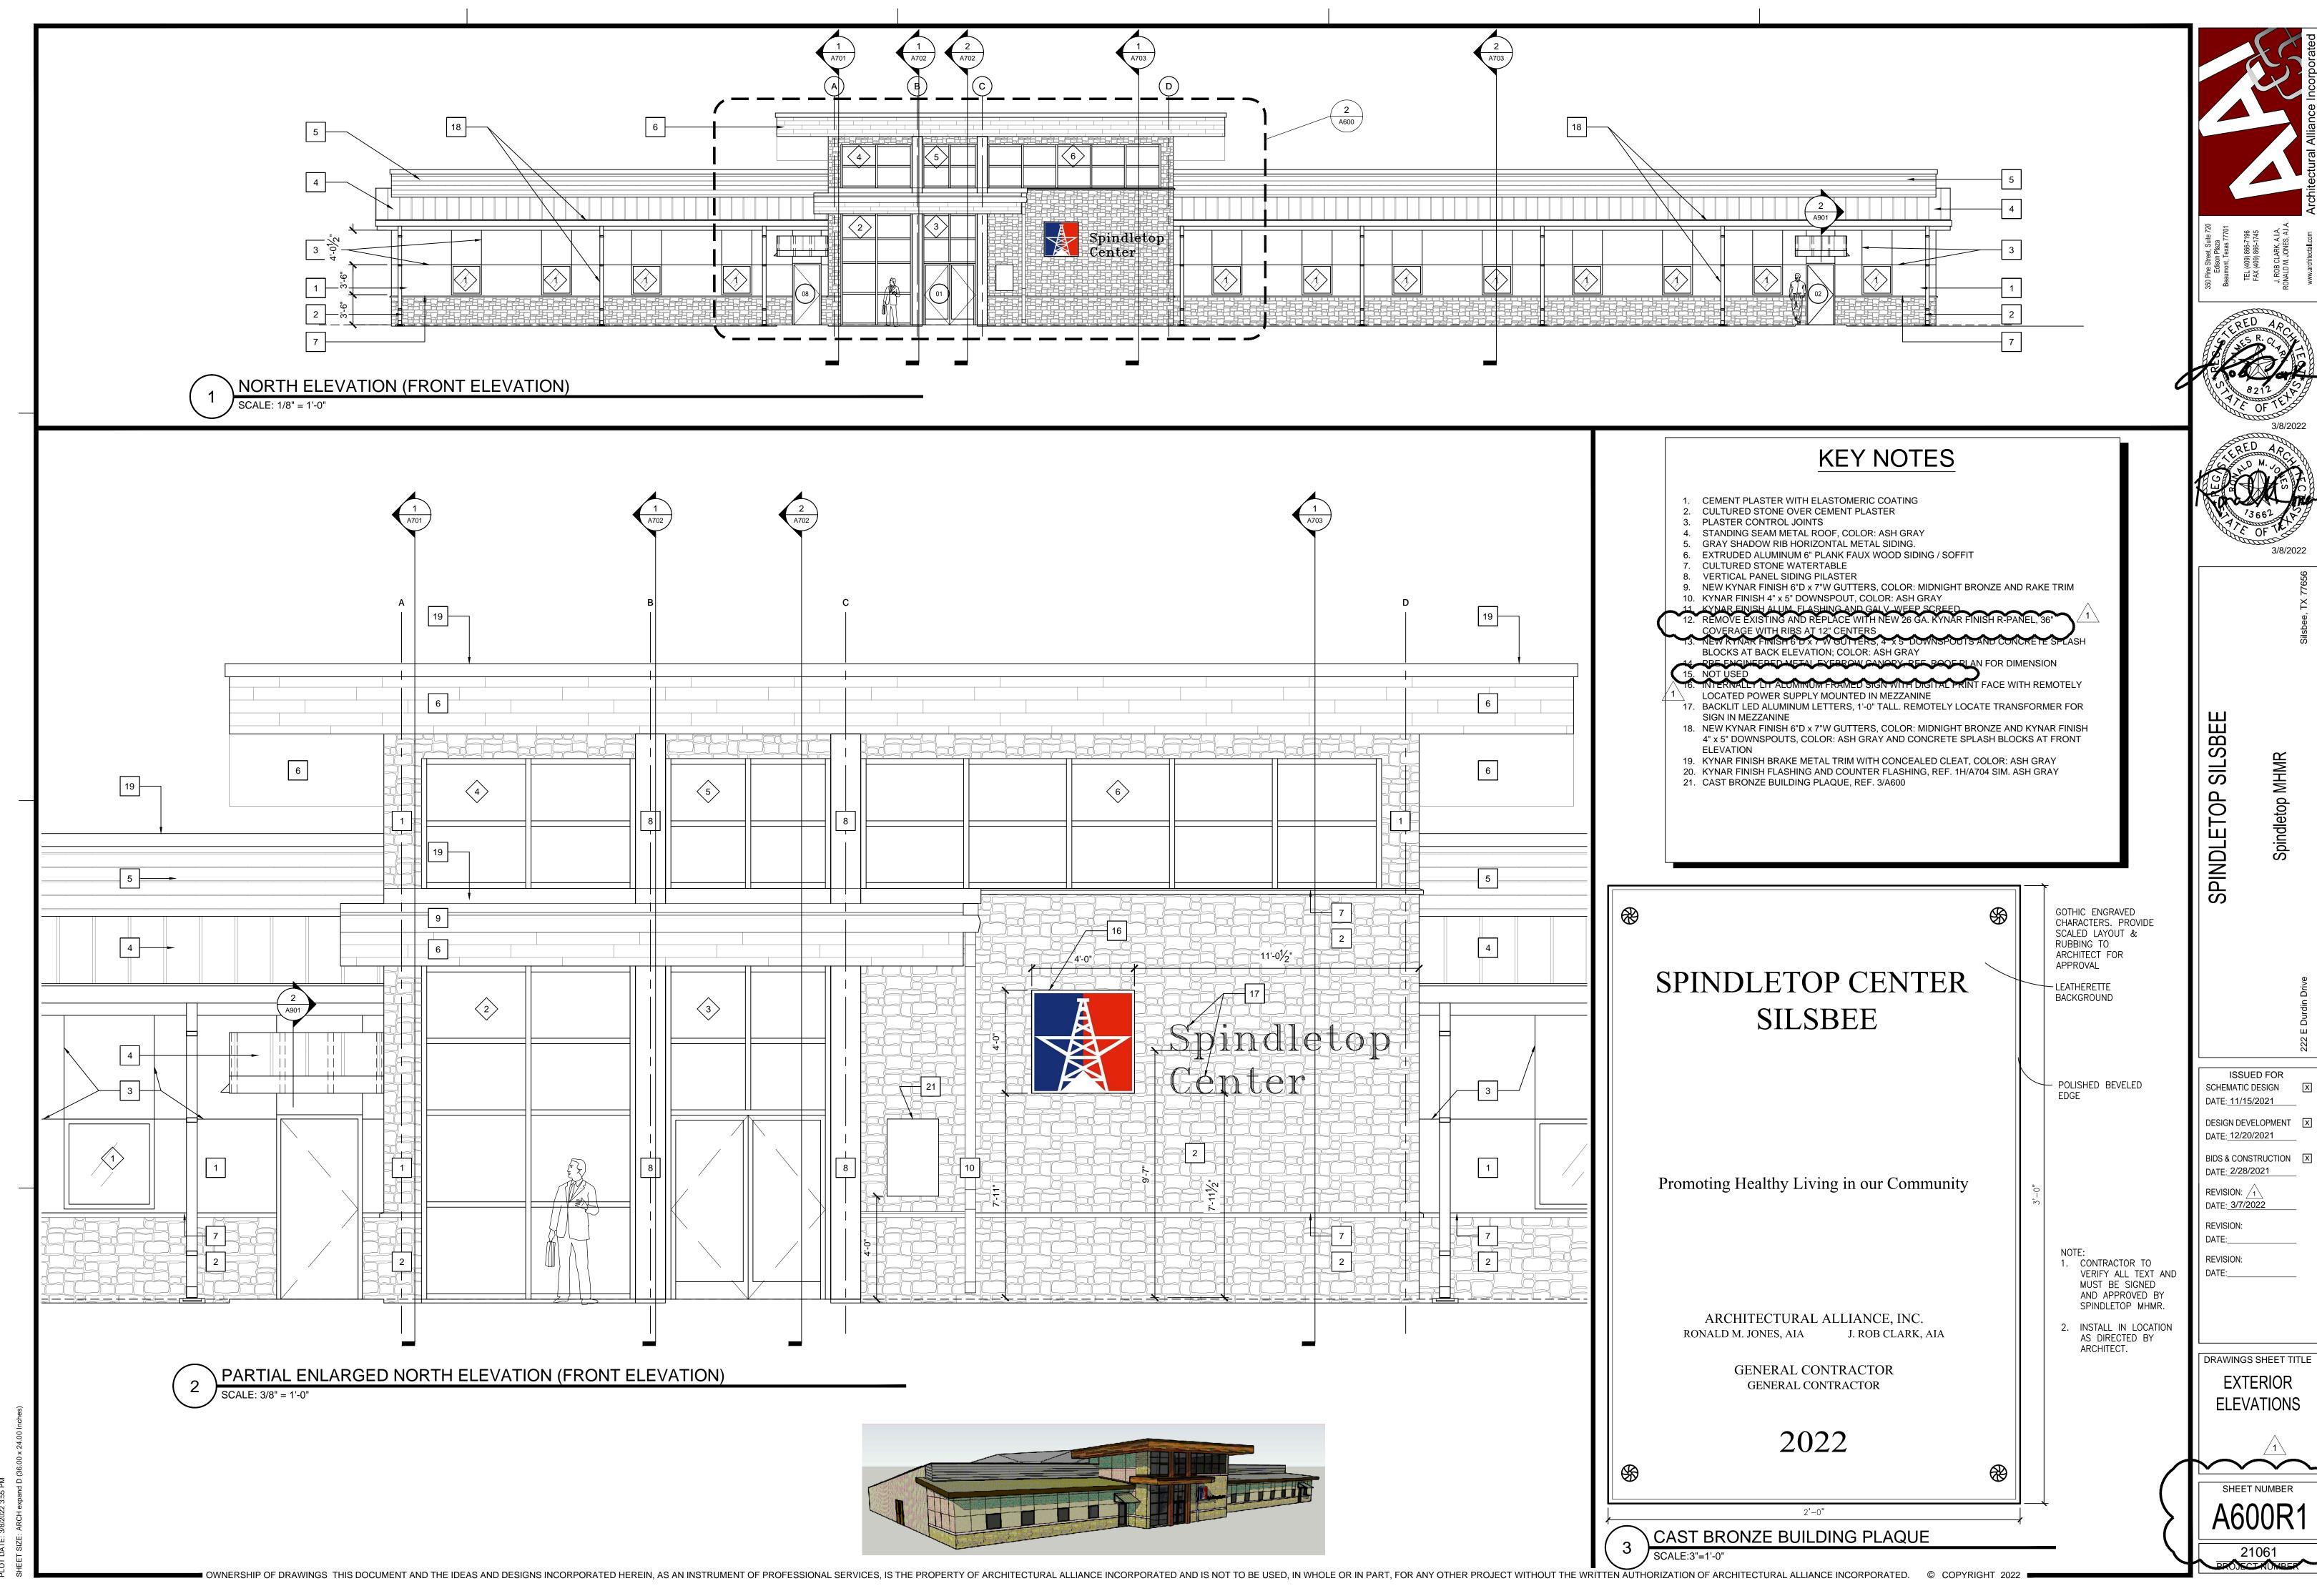

## **KEY NOTES**

- 1. CEMENT PLASTER WITH ELASTOMERIC COATING
- 2. CULTURED STONE OVER CEMENT PLASTER
- 3. PLASTER CONTROL JOINTS 4. STANDING SEAM METAL ROOF, COLOR: ASH GRAY
- 5. GRAY SHADOW RIB HORIZONTAL METAL SIDING.
- 6. EXTRUDED ALUMINUM 6" PLANK FAUX WOOD SIDING / SOFFIT 7. CULTURED STONE WATERTABLE
- 8. VERTICAL PANEL SIDING PILASTER
- 9. NEW KYNAR FINISH 6"D x 7"W GUTTERS, COLOR: MIDNIGHT BRONZE AND RAKE TRIM
- 10. KYNAR FINISH 4" x 5" DOWNSPOUT, COLOR: ASH GRAY

10. KYNAR FINISH 4 X5 DOWNSPOUT, COLOR: ASH GRAY

11. KYNAR FINISH ALUM. FLASHING AND GALV. WEEP SCREED.

12. REMOVE EXISTING AND REPLACE WITH NEW 26 GA. KYNAR FINISH R-PANEL, 36"

COVERAGE WITH RIBS AT 12" CENTERS


13. NEW KYNAR FINISH 6"D x 7" W GUTTERS, 4" x 5" DOWNSPOUTS AND CONCRETE SPLASH BLOCKS AT BACK ELEVATION; COLOR: ASH GRAY


15. NOT USED

16. INTERNALLY LIT ALUMINUM FRAMED SIGN WITH DIGITAL PRINT FACE WITH REMOTELY

- LOCATED POWER SUPPLY MOUNTED IN MEZZANINE 17. BACKLIT LED ALUMINUM LETTERS, 1'-0" TALL. REMOTELY LOCATE TRANSFORMER FOR SIGN IN MEZZANINE
- 18. NEW KYNAR FINISH 6"D x 7"W GUTTERS, COLOR: MIDNIGHT BRONZE AND KYNAR FINISH 4" x 5" DOWNSPOUTS, COLOR: ASH GRAY AND CONCRETE SPLASH BLOCKS AT FRONT
- **ELEVATION** 19. KYNAR FINISH BRAKE METAL TRIM WITH CONCEALED CLEAT, COLOR: ASH GRAY
- 20. KYNAR FINISH FLASHING AND COUNTER FLASHING, REF. 1H/A704 SIM. ASH GRAY 21. CAST BRONZE BUILDING PLAQUE, REF. 3/A600



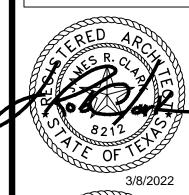

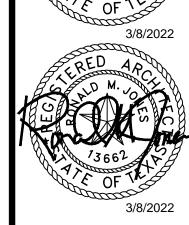

SILSBEE

SPINDLETOP

ISSUED FOR SCHEMATIC DESIGN X DATE: 11/15/2021

DESIGN DEVELOPMENT X DATE: 12/20/2021

BIDS & CONSTRUCTION X DATE: 2/28/2021 REVISION: /1

DATE: 3/7/2022 REVISION:


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DRAWINGS SHEET TITLE


**EXTERIOR ELEVATIONS** 

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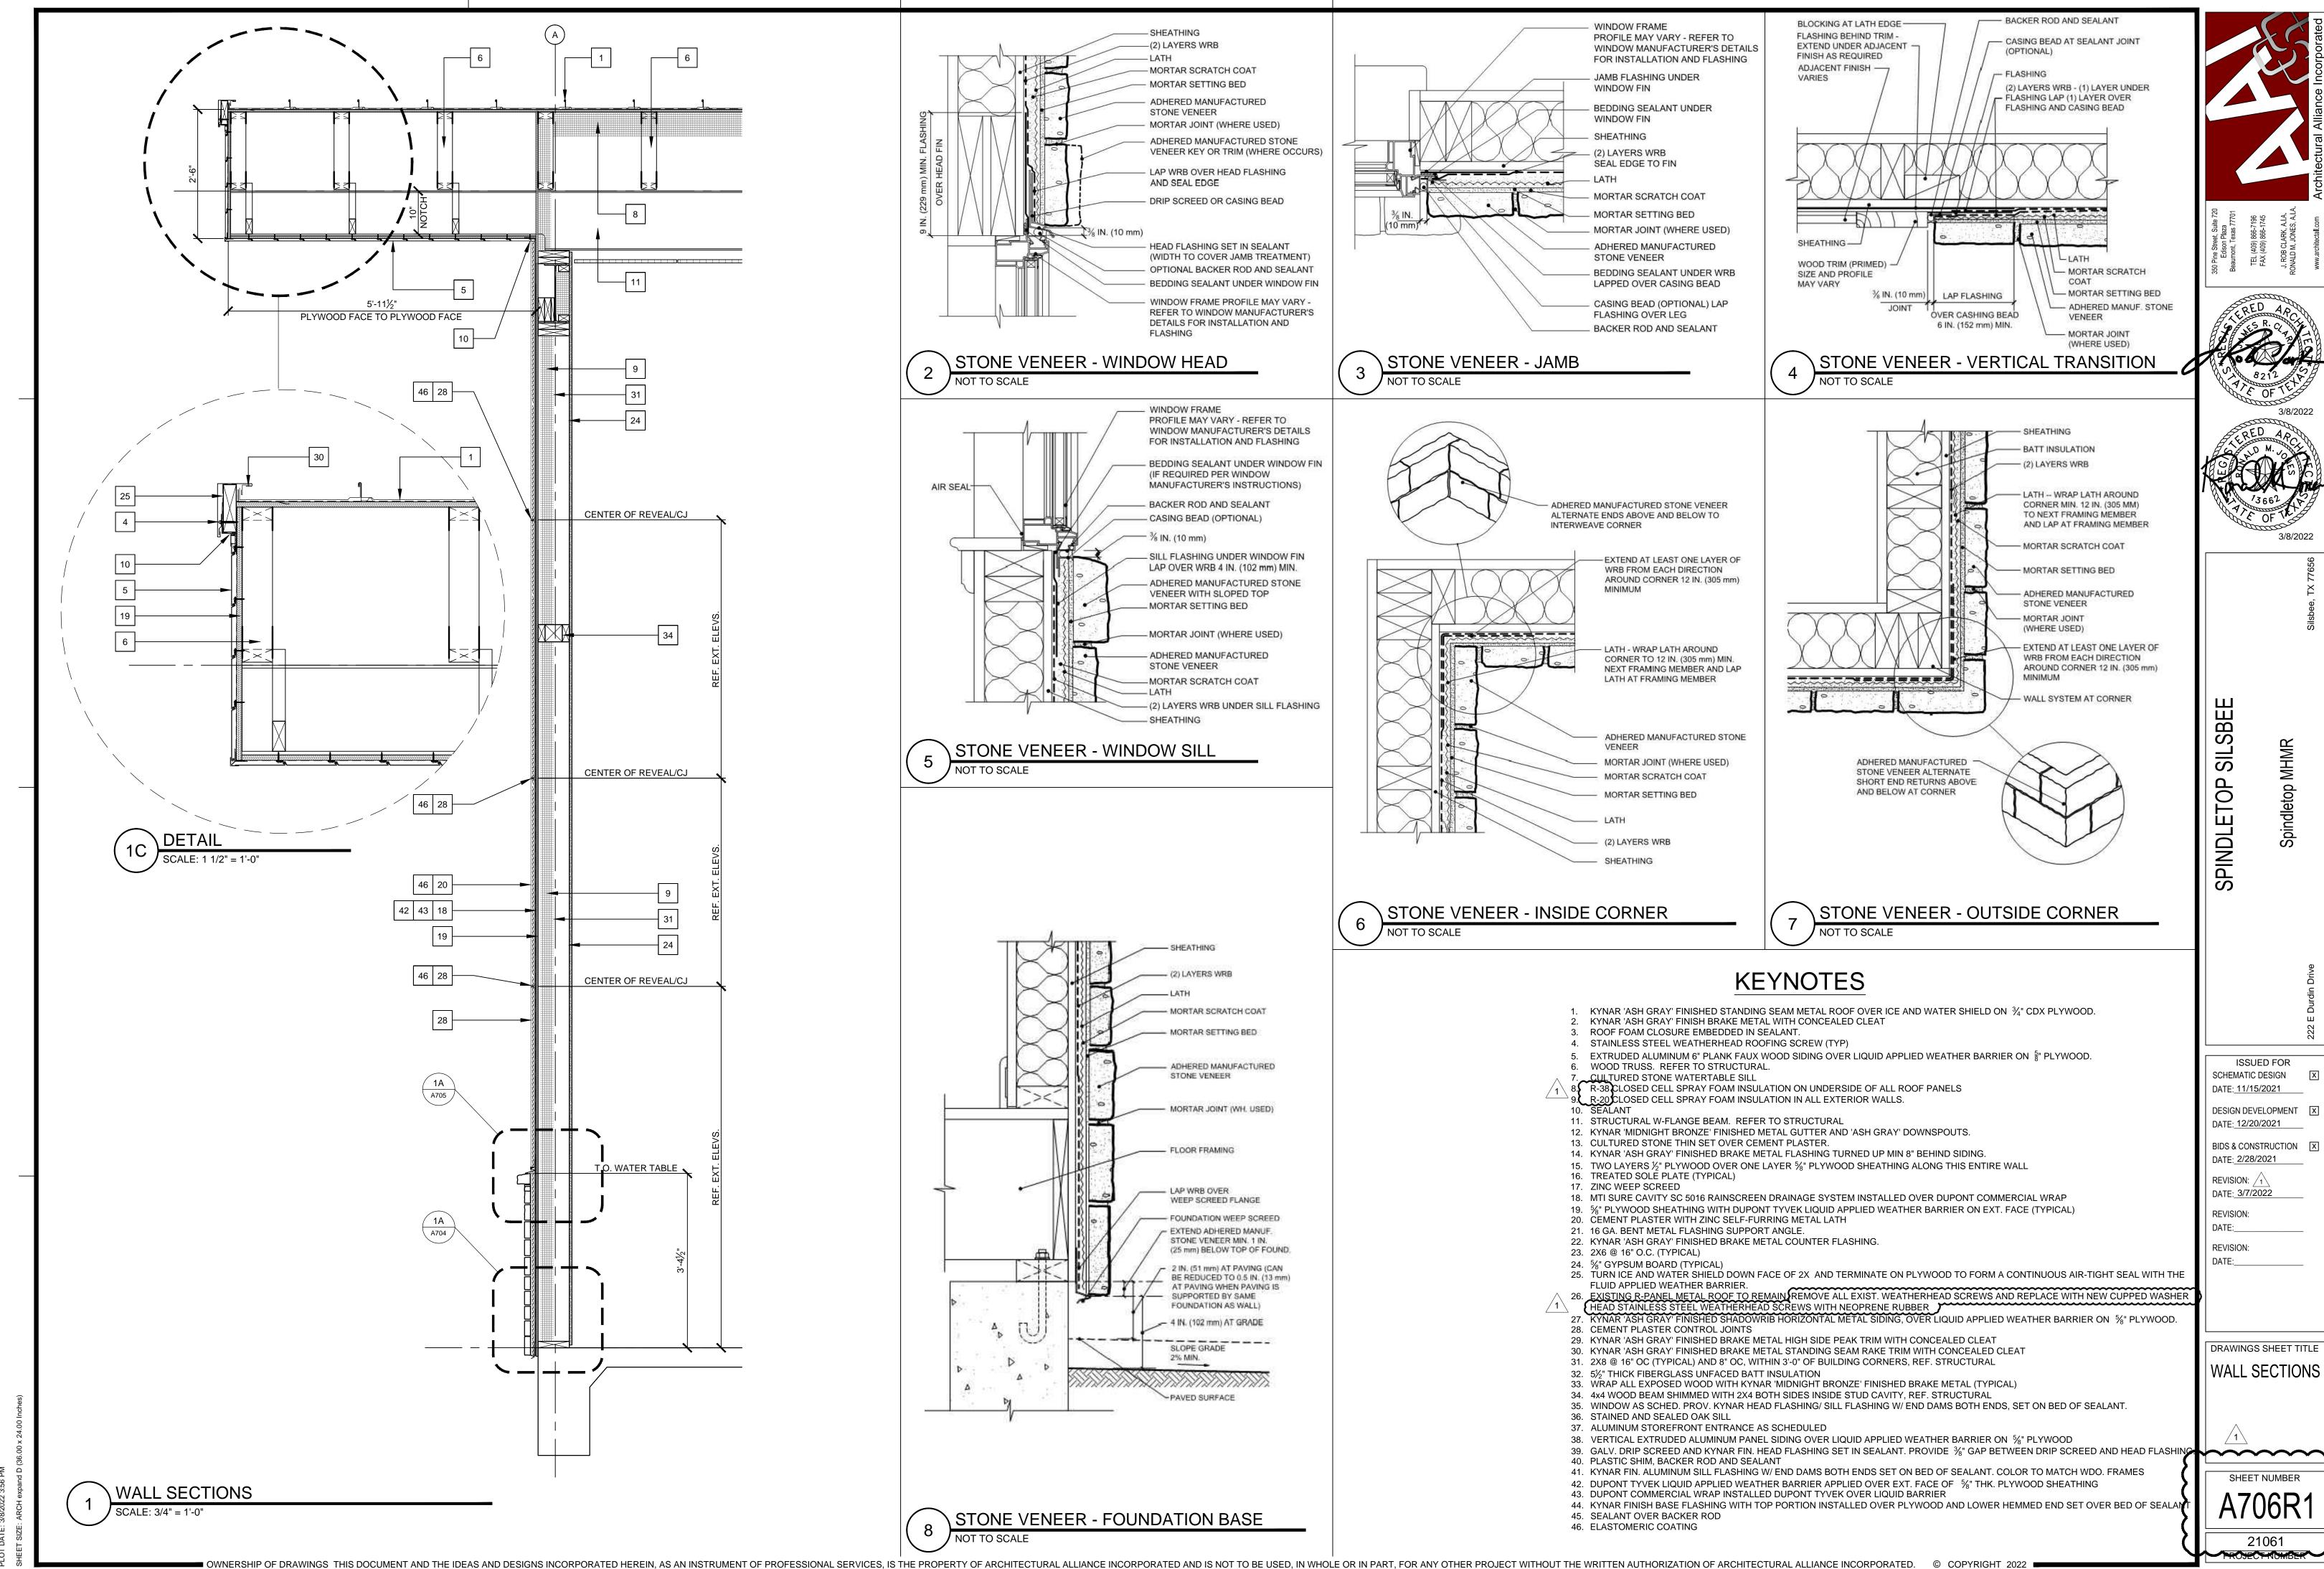
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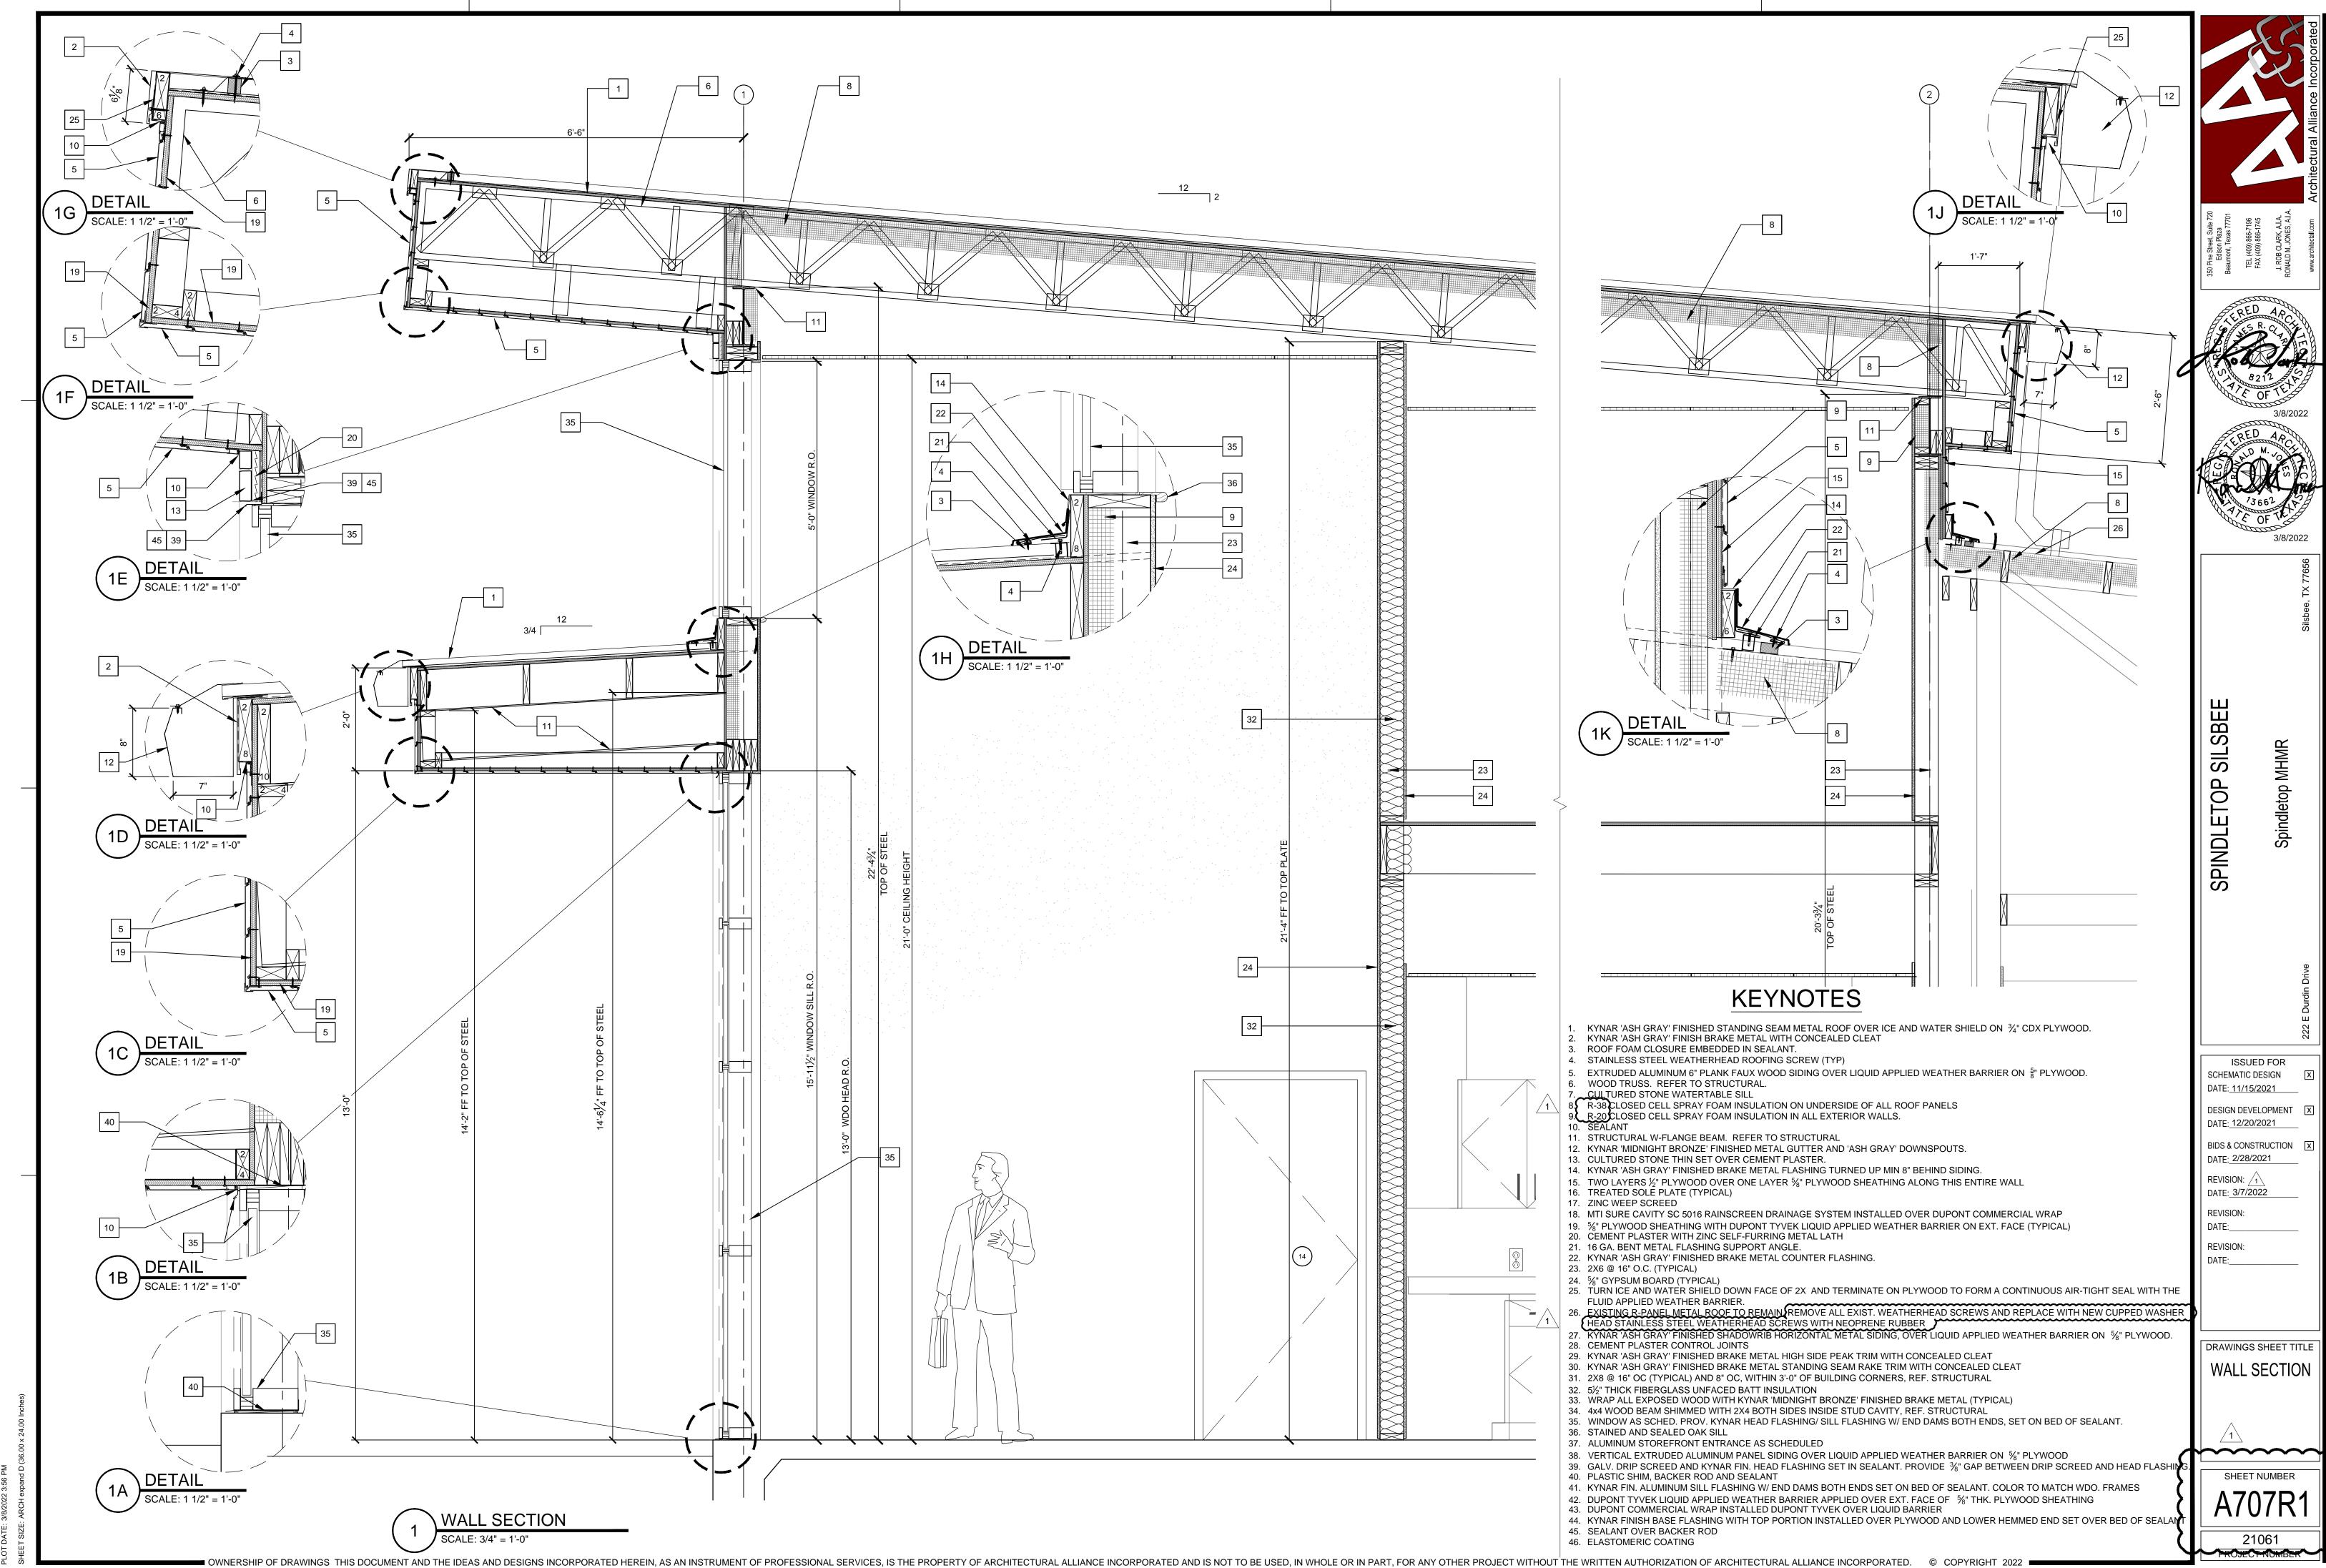


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PLOT: MICHAEL MAGTAAN
PLOT DATE: 3/8/2022 3:56 PM

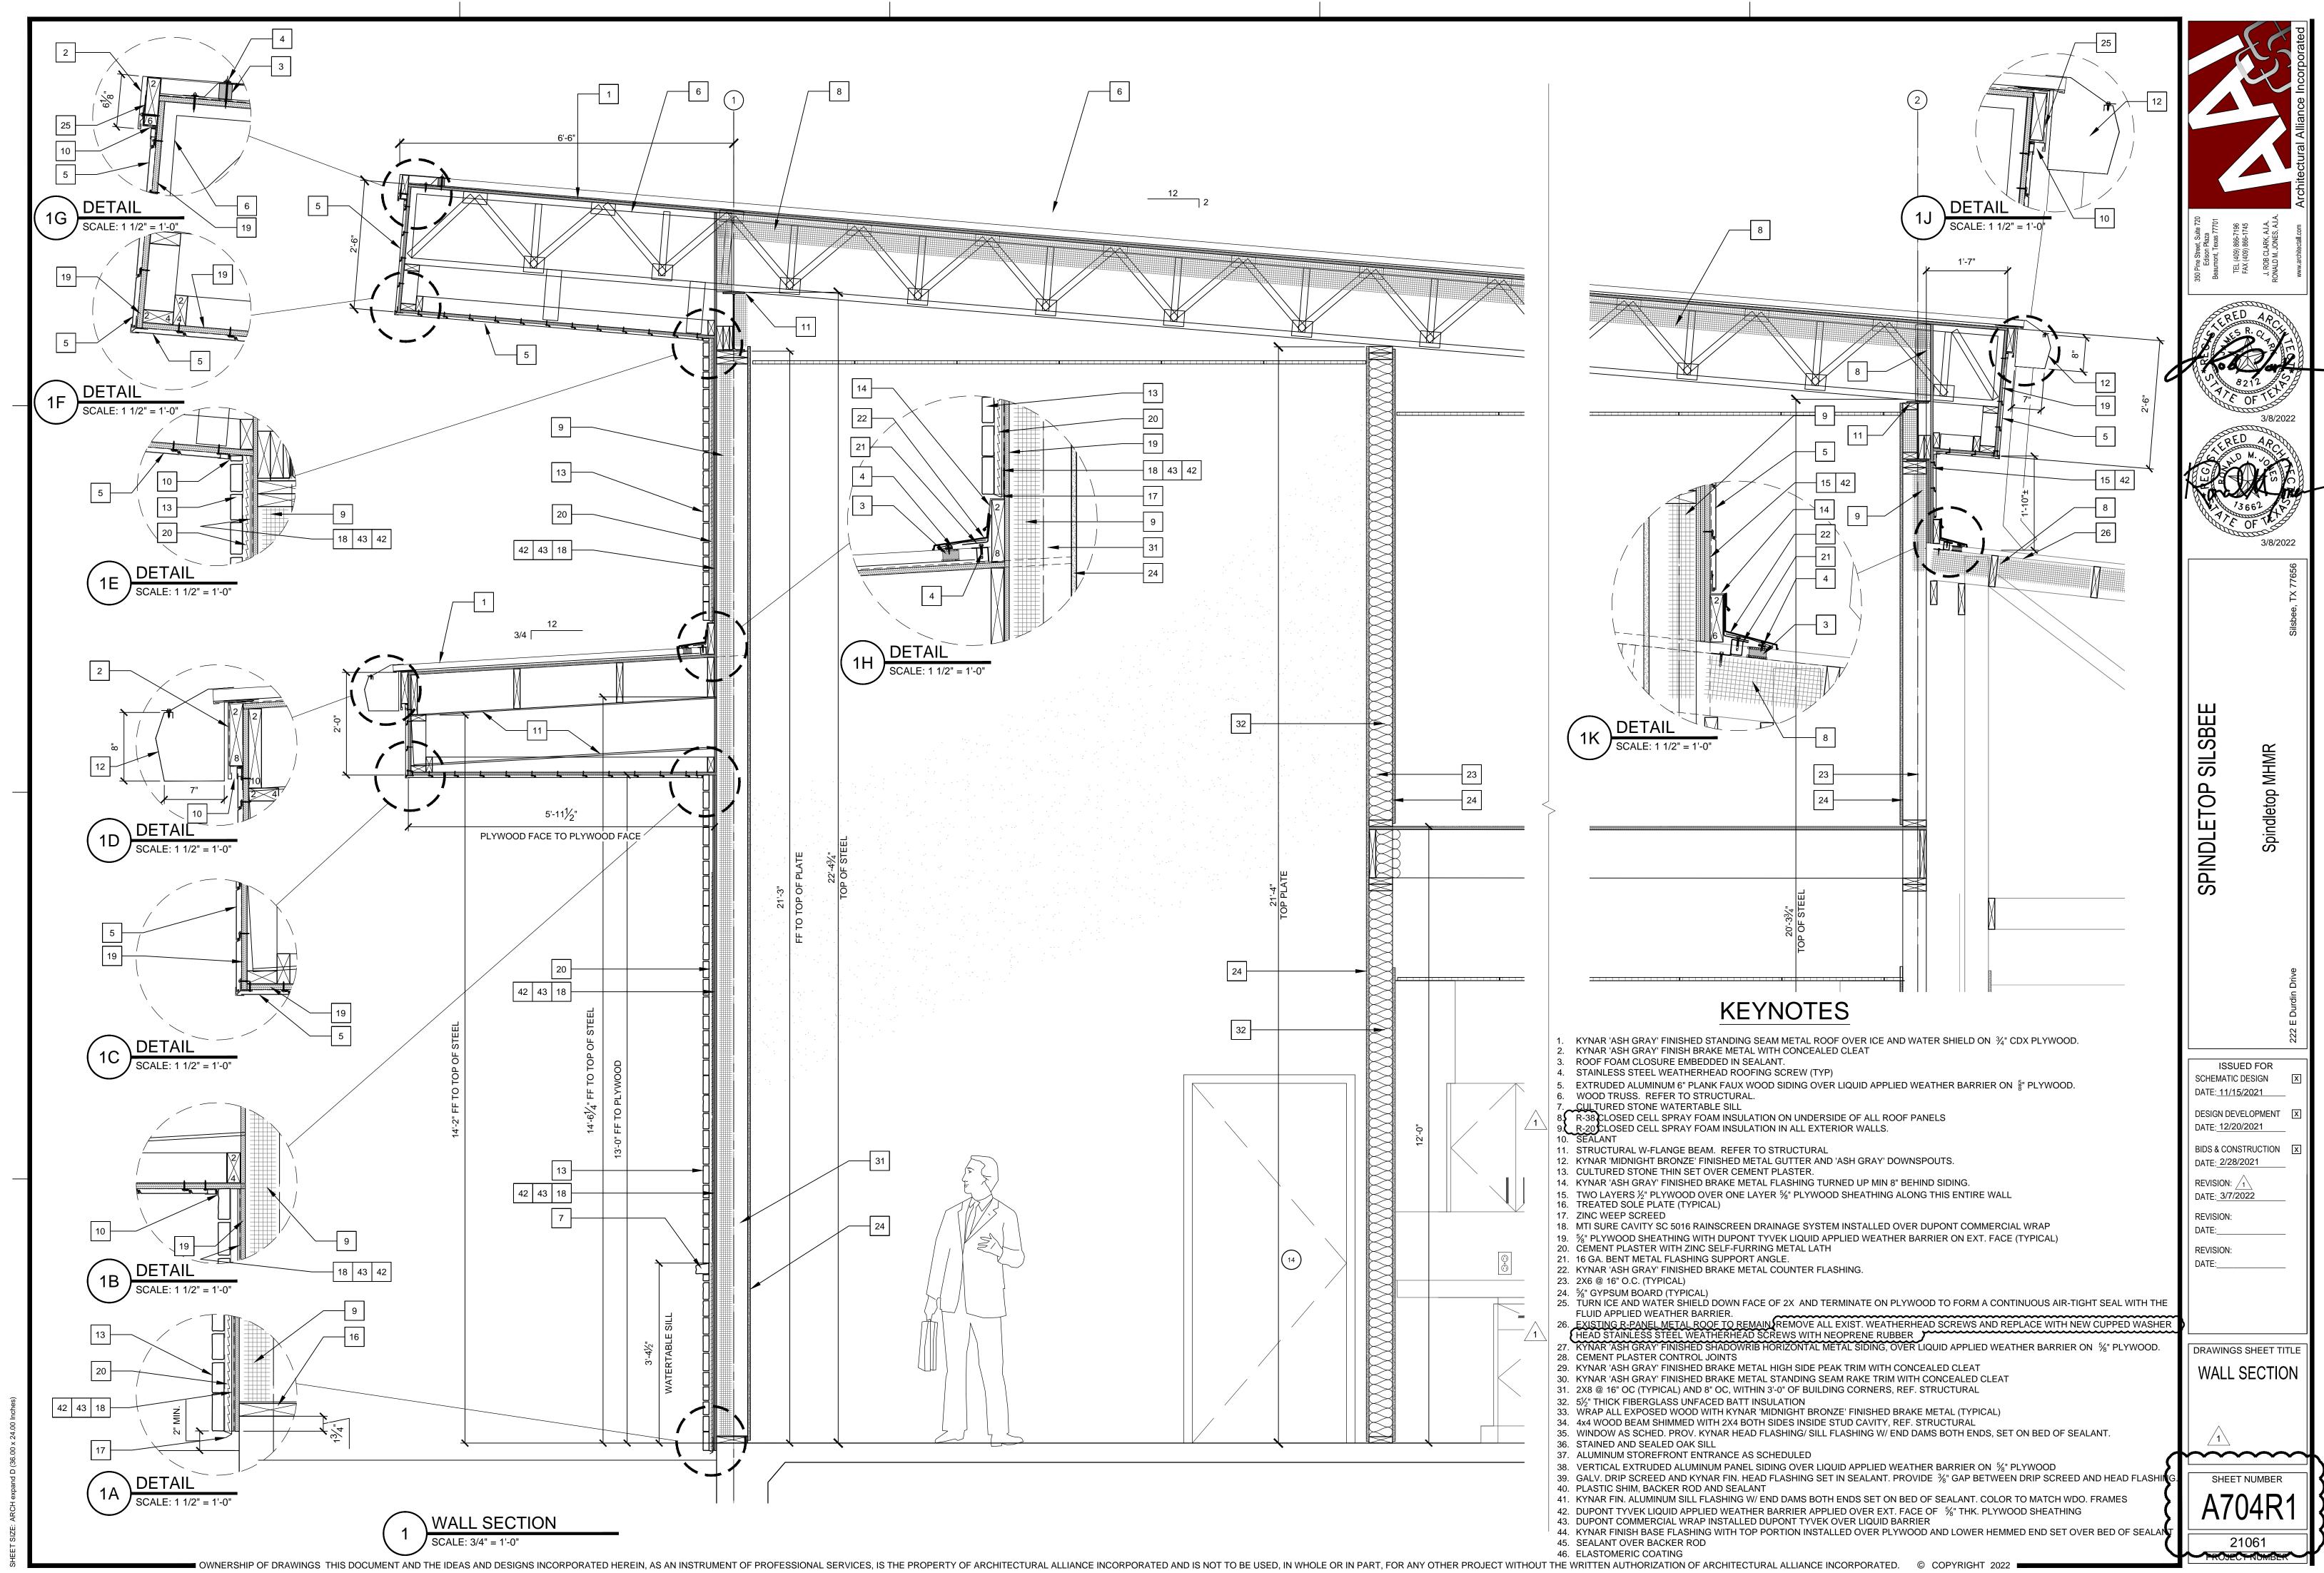


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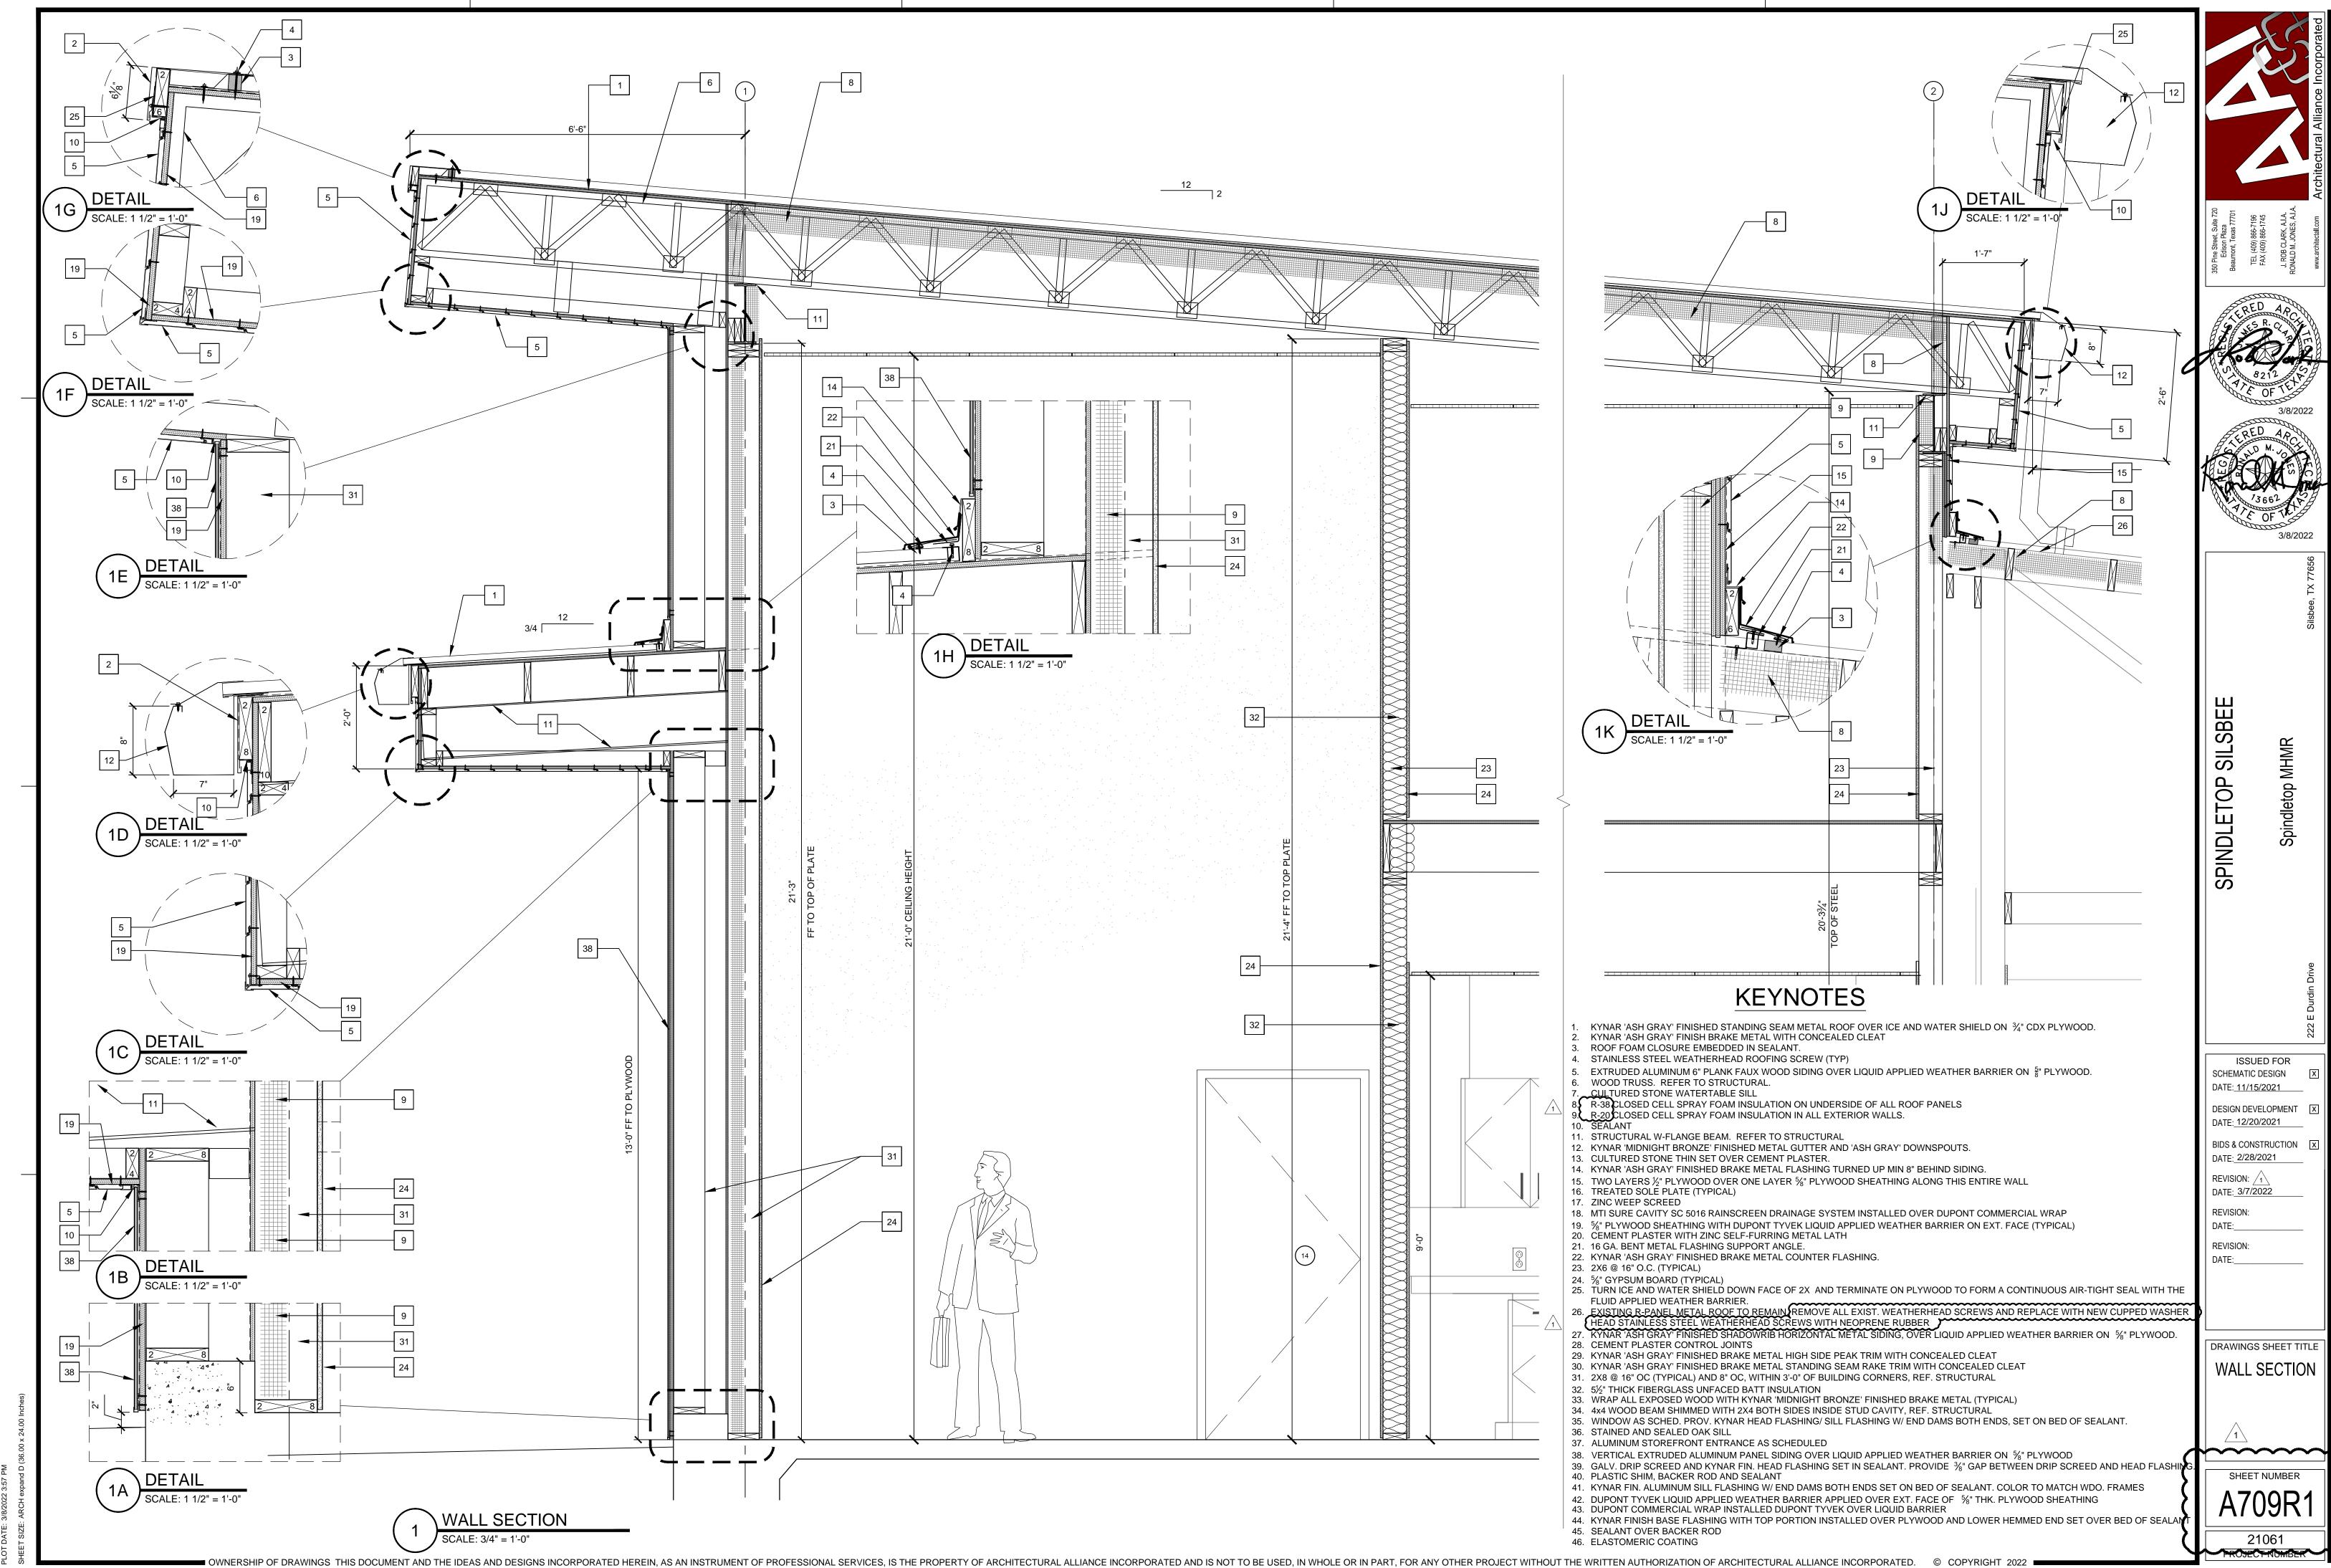


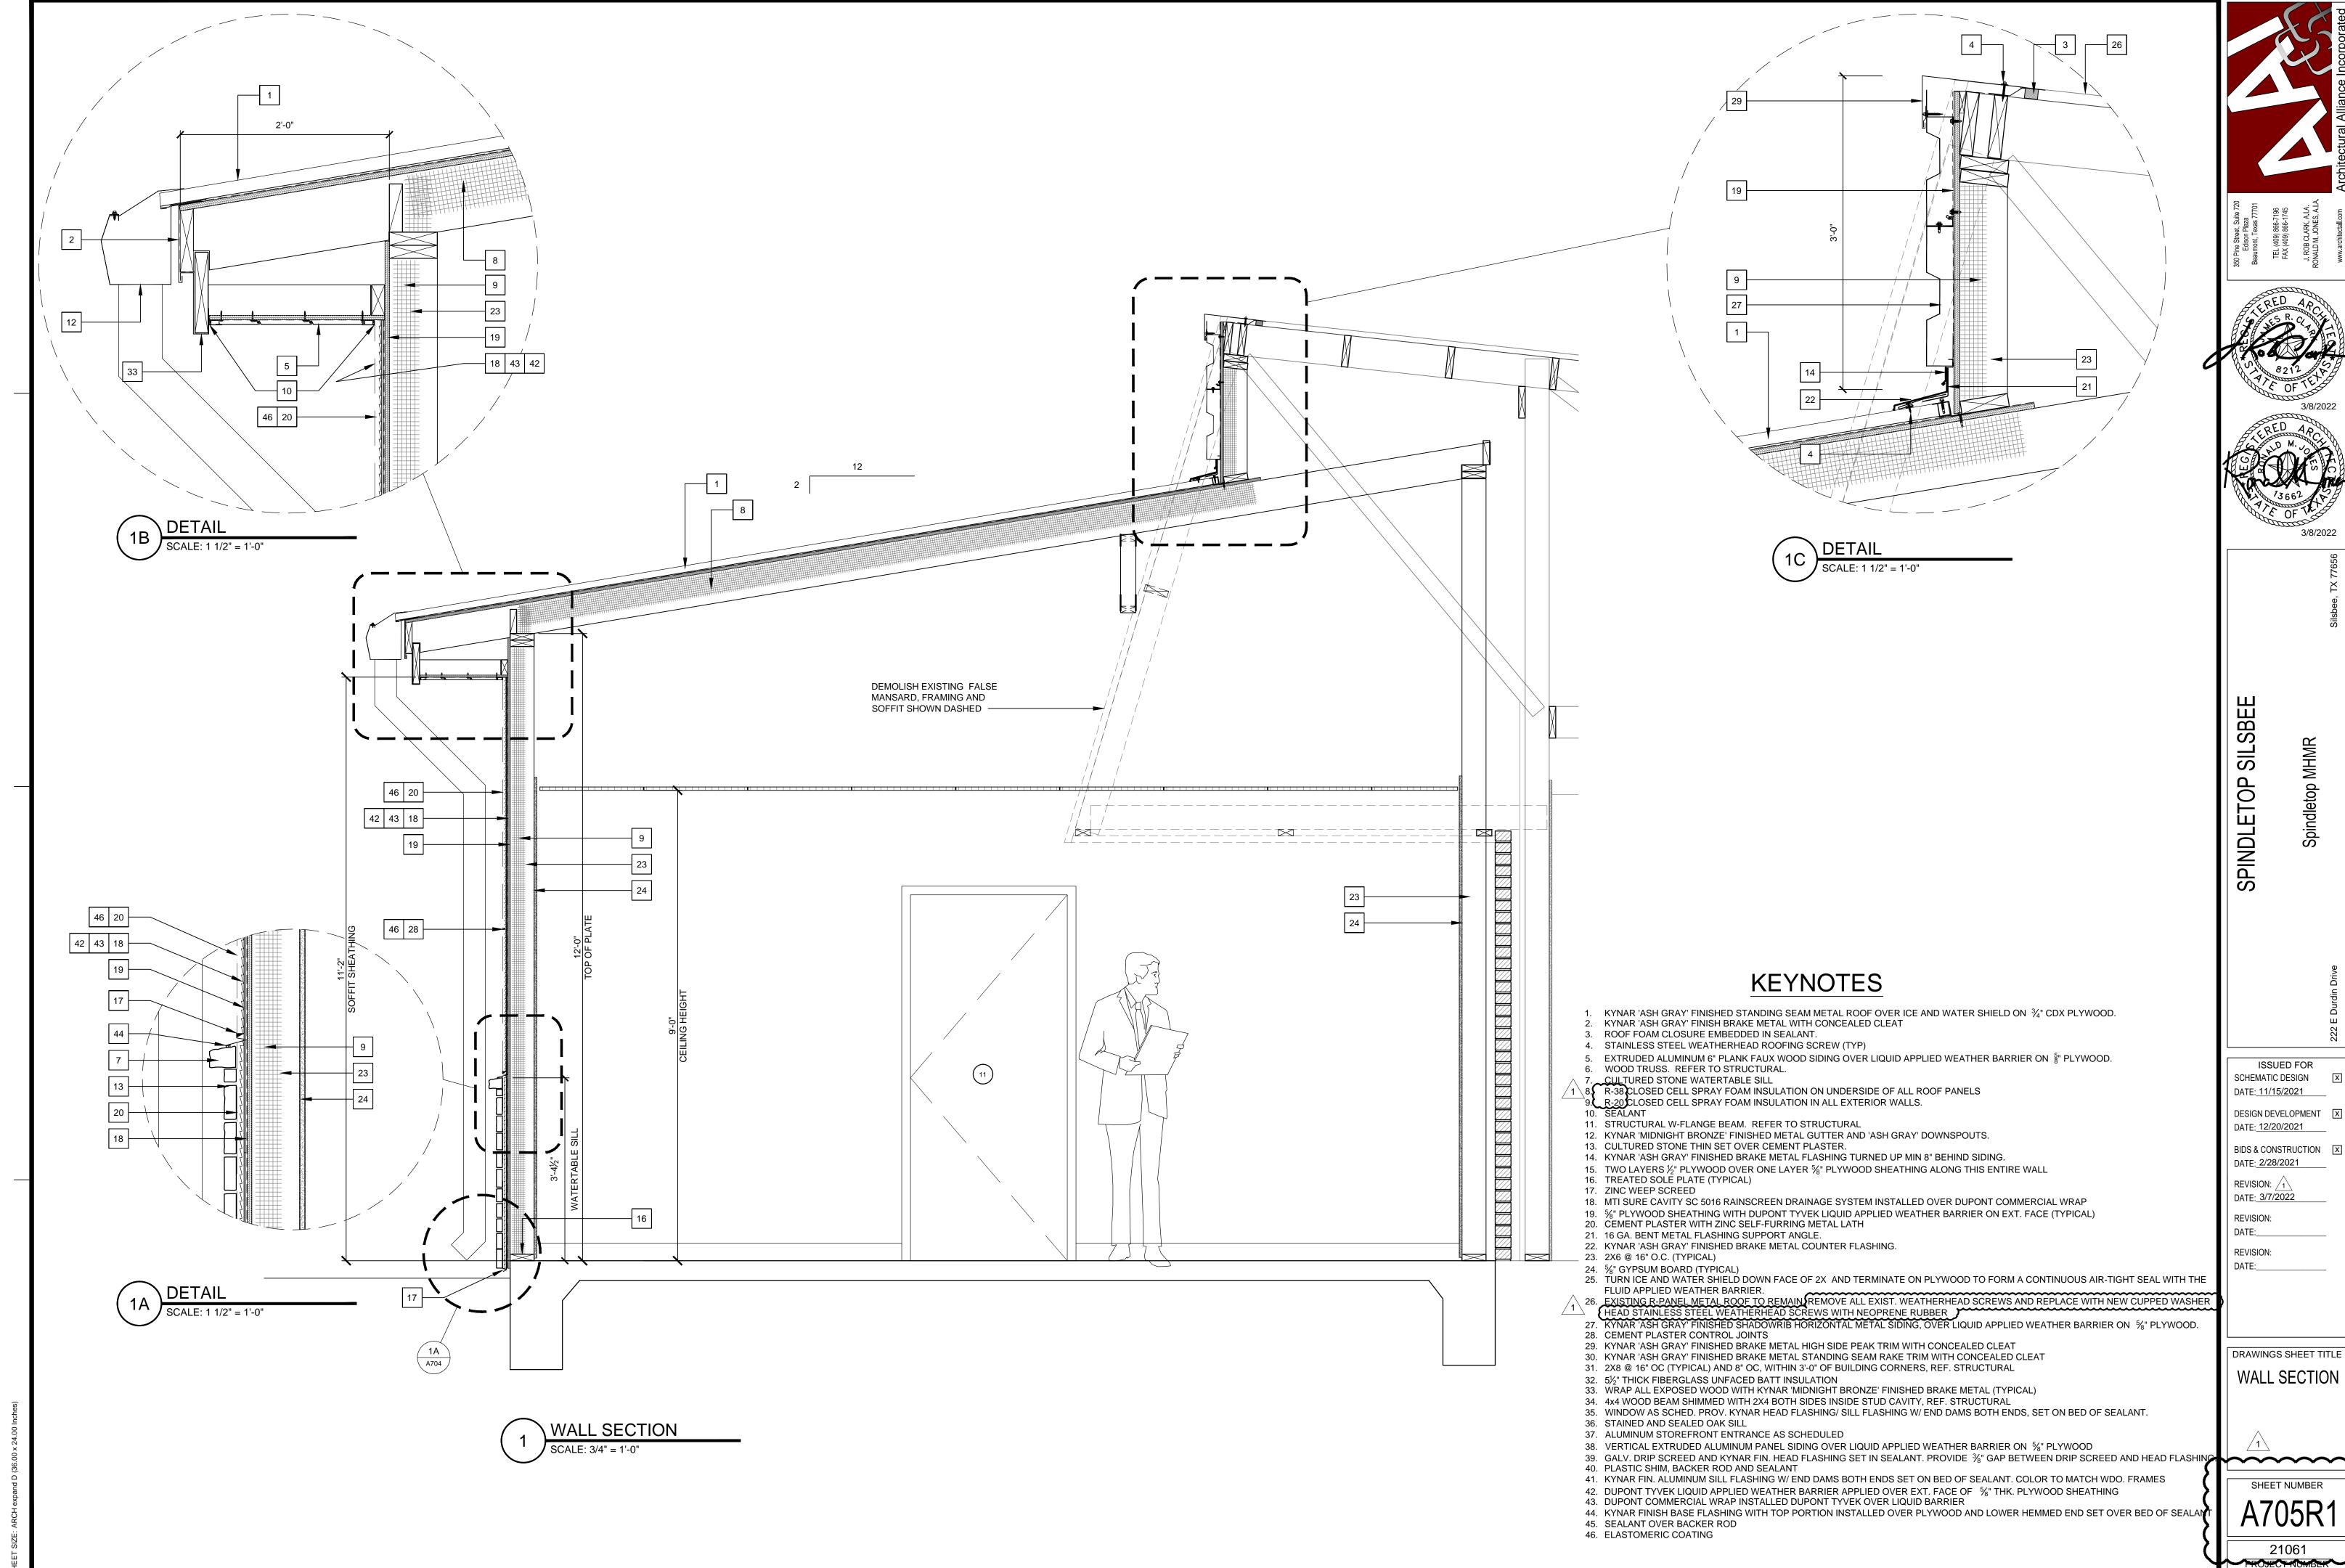


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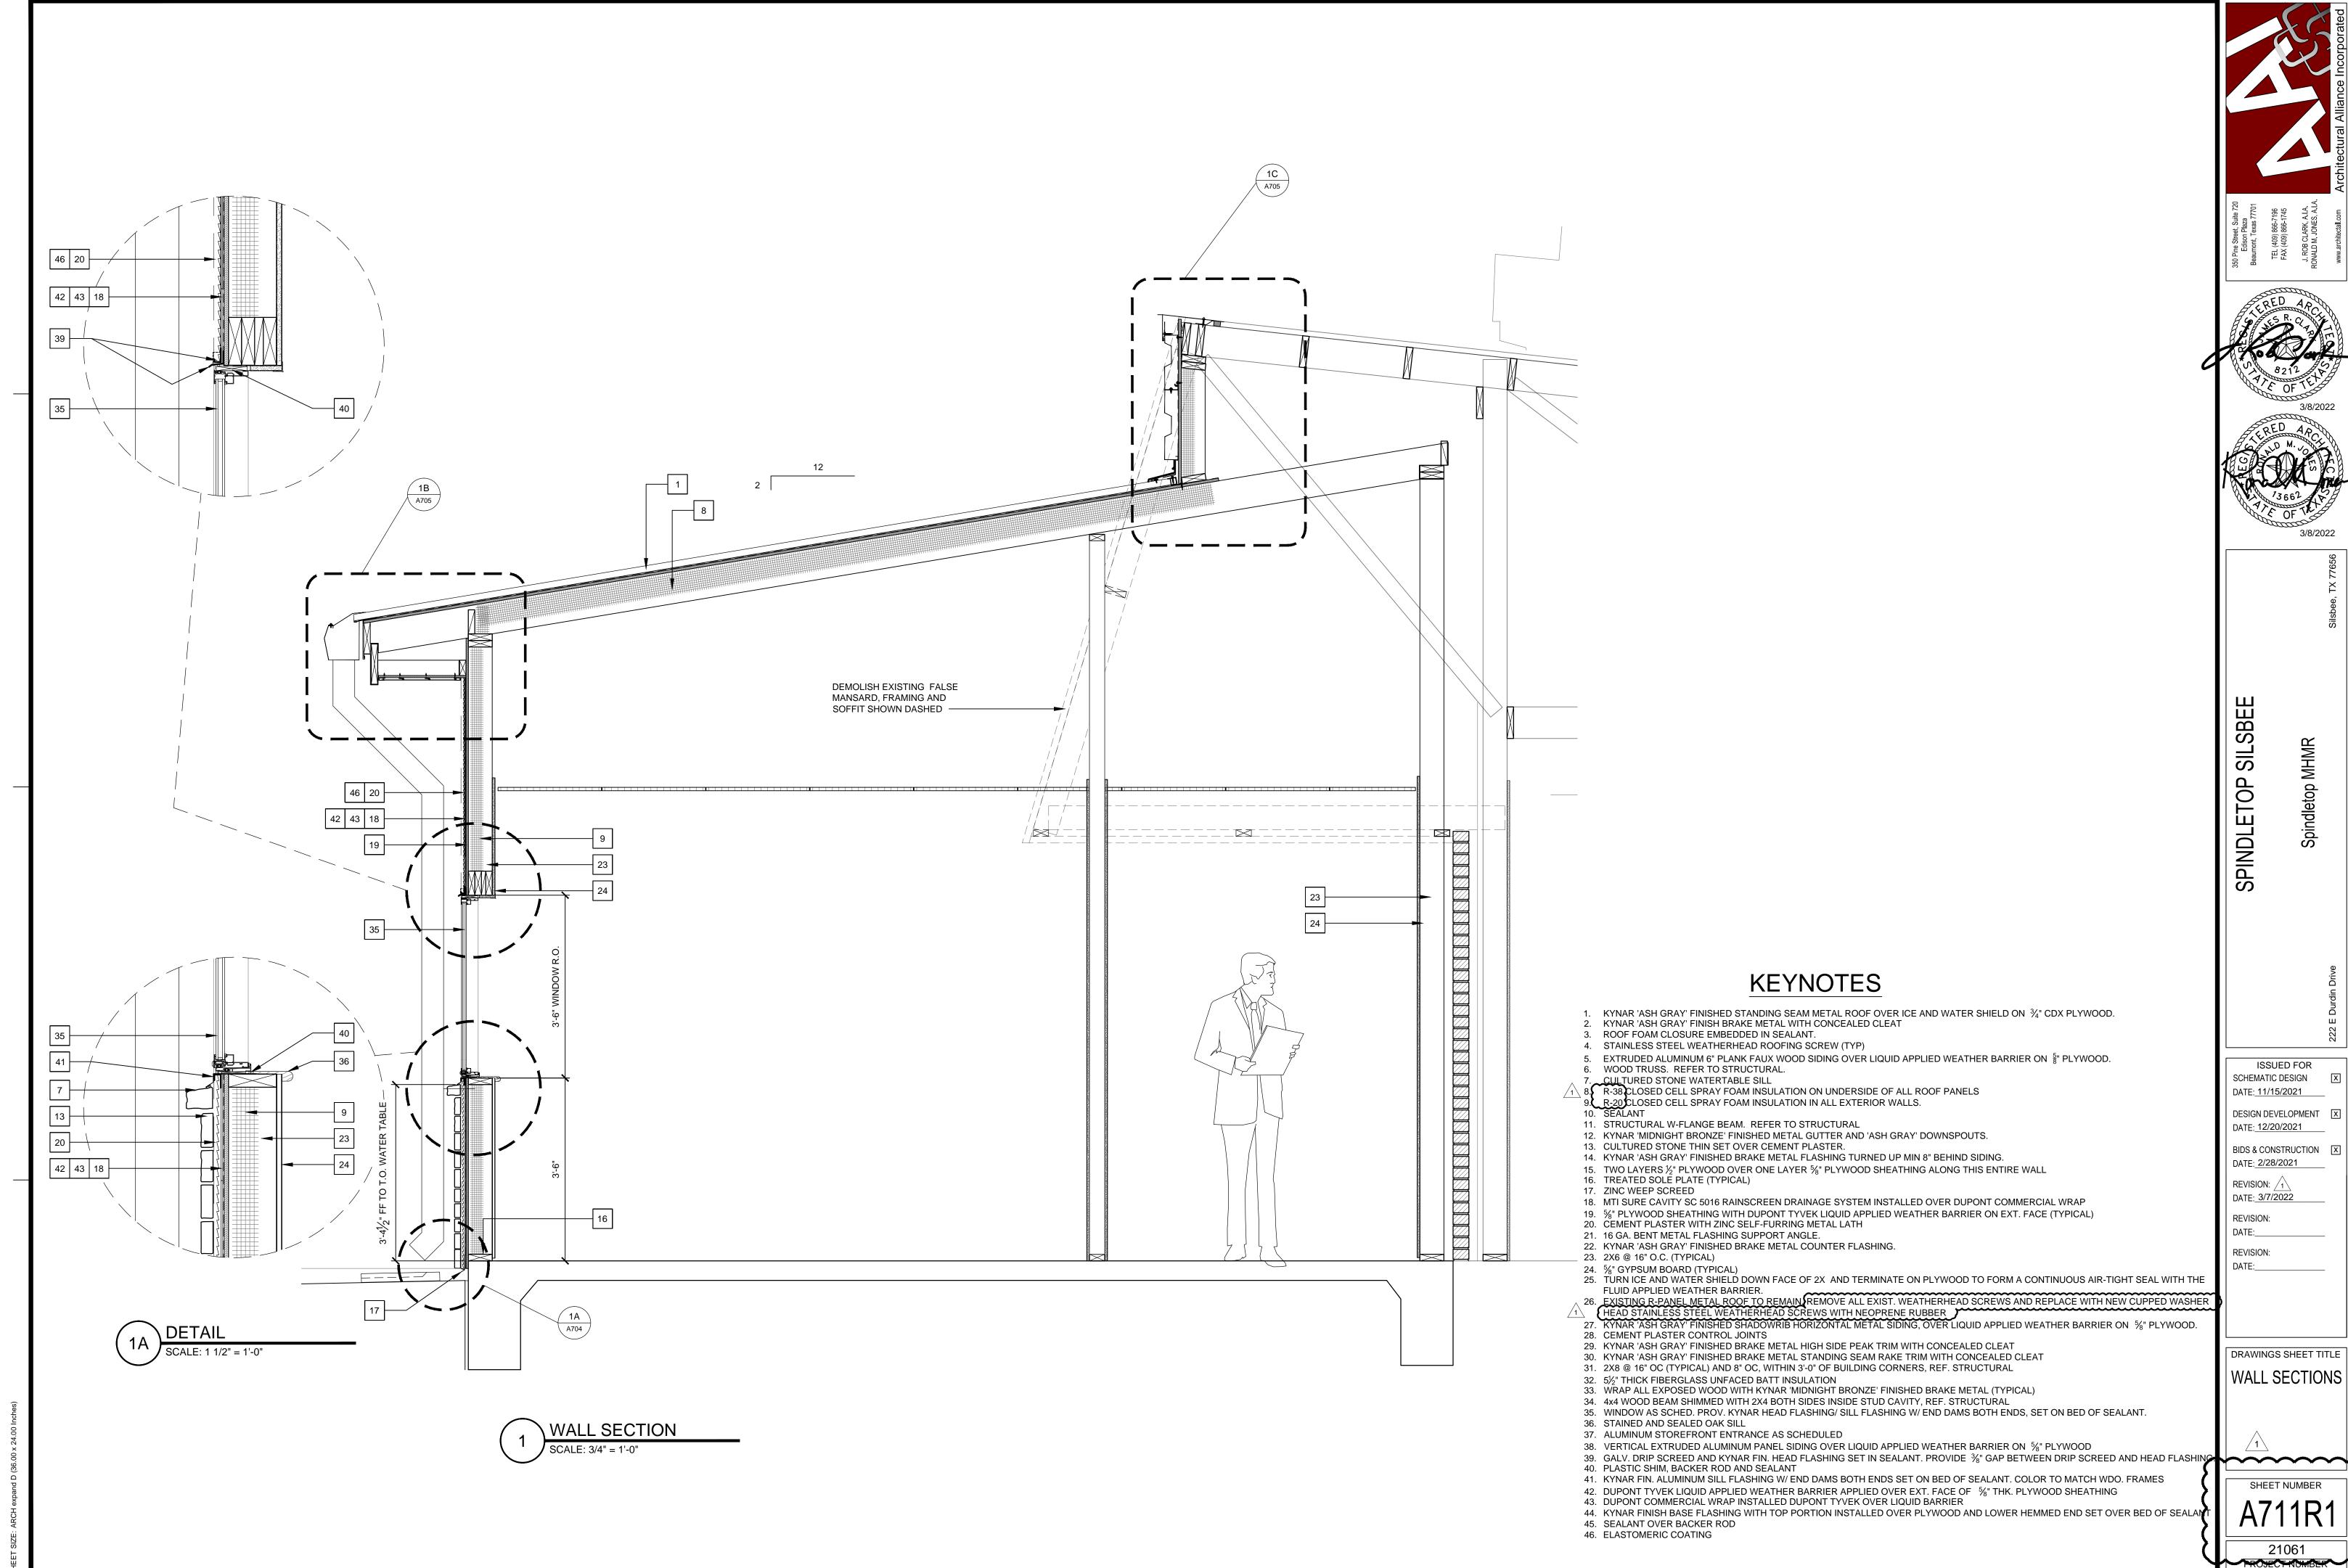
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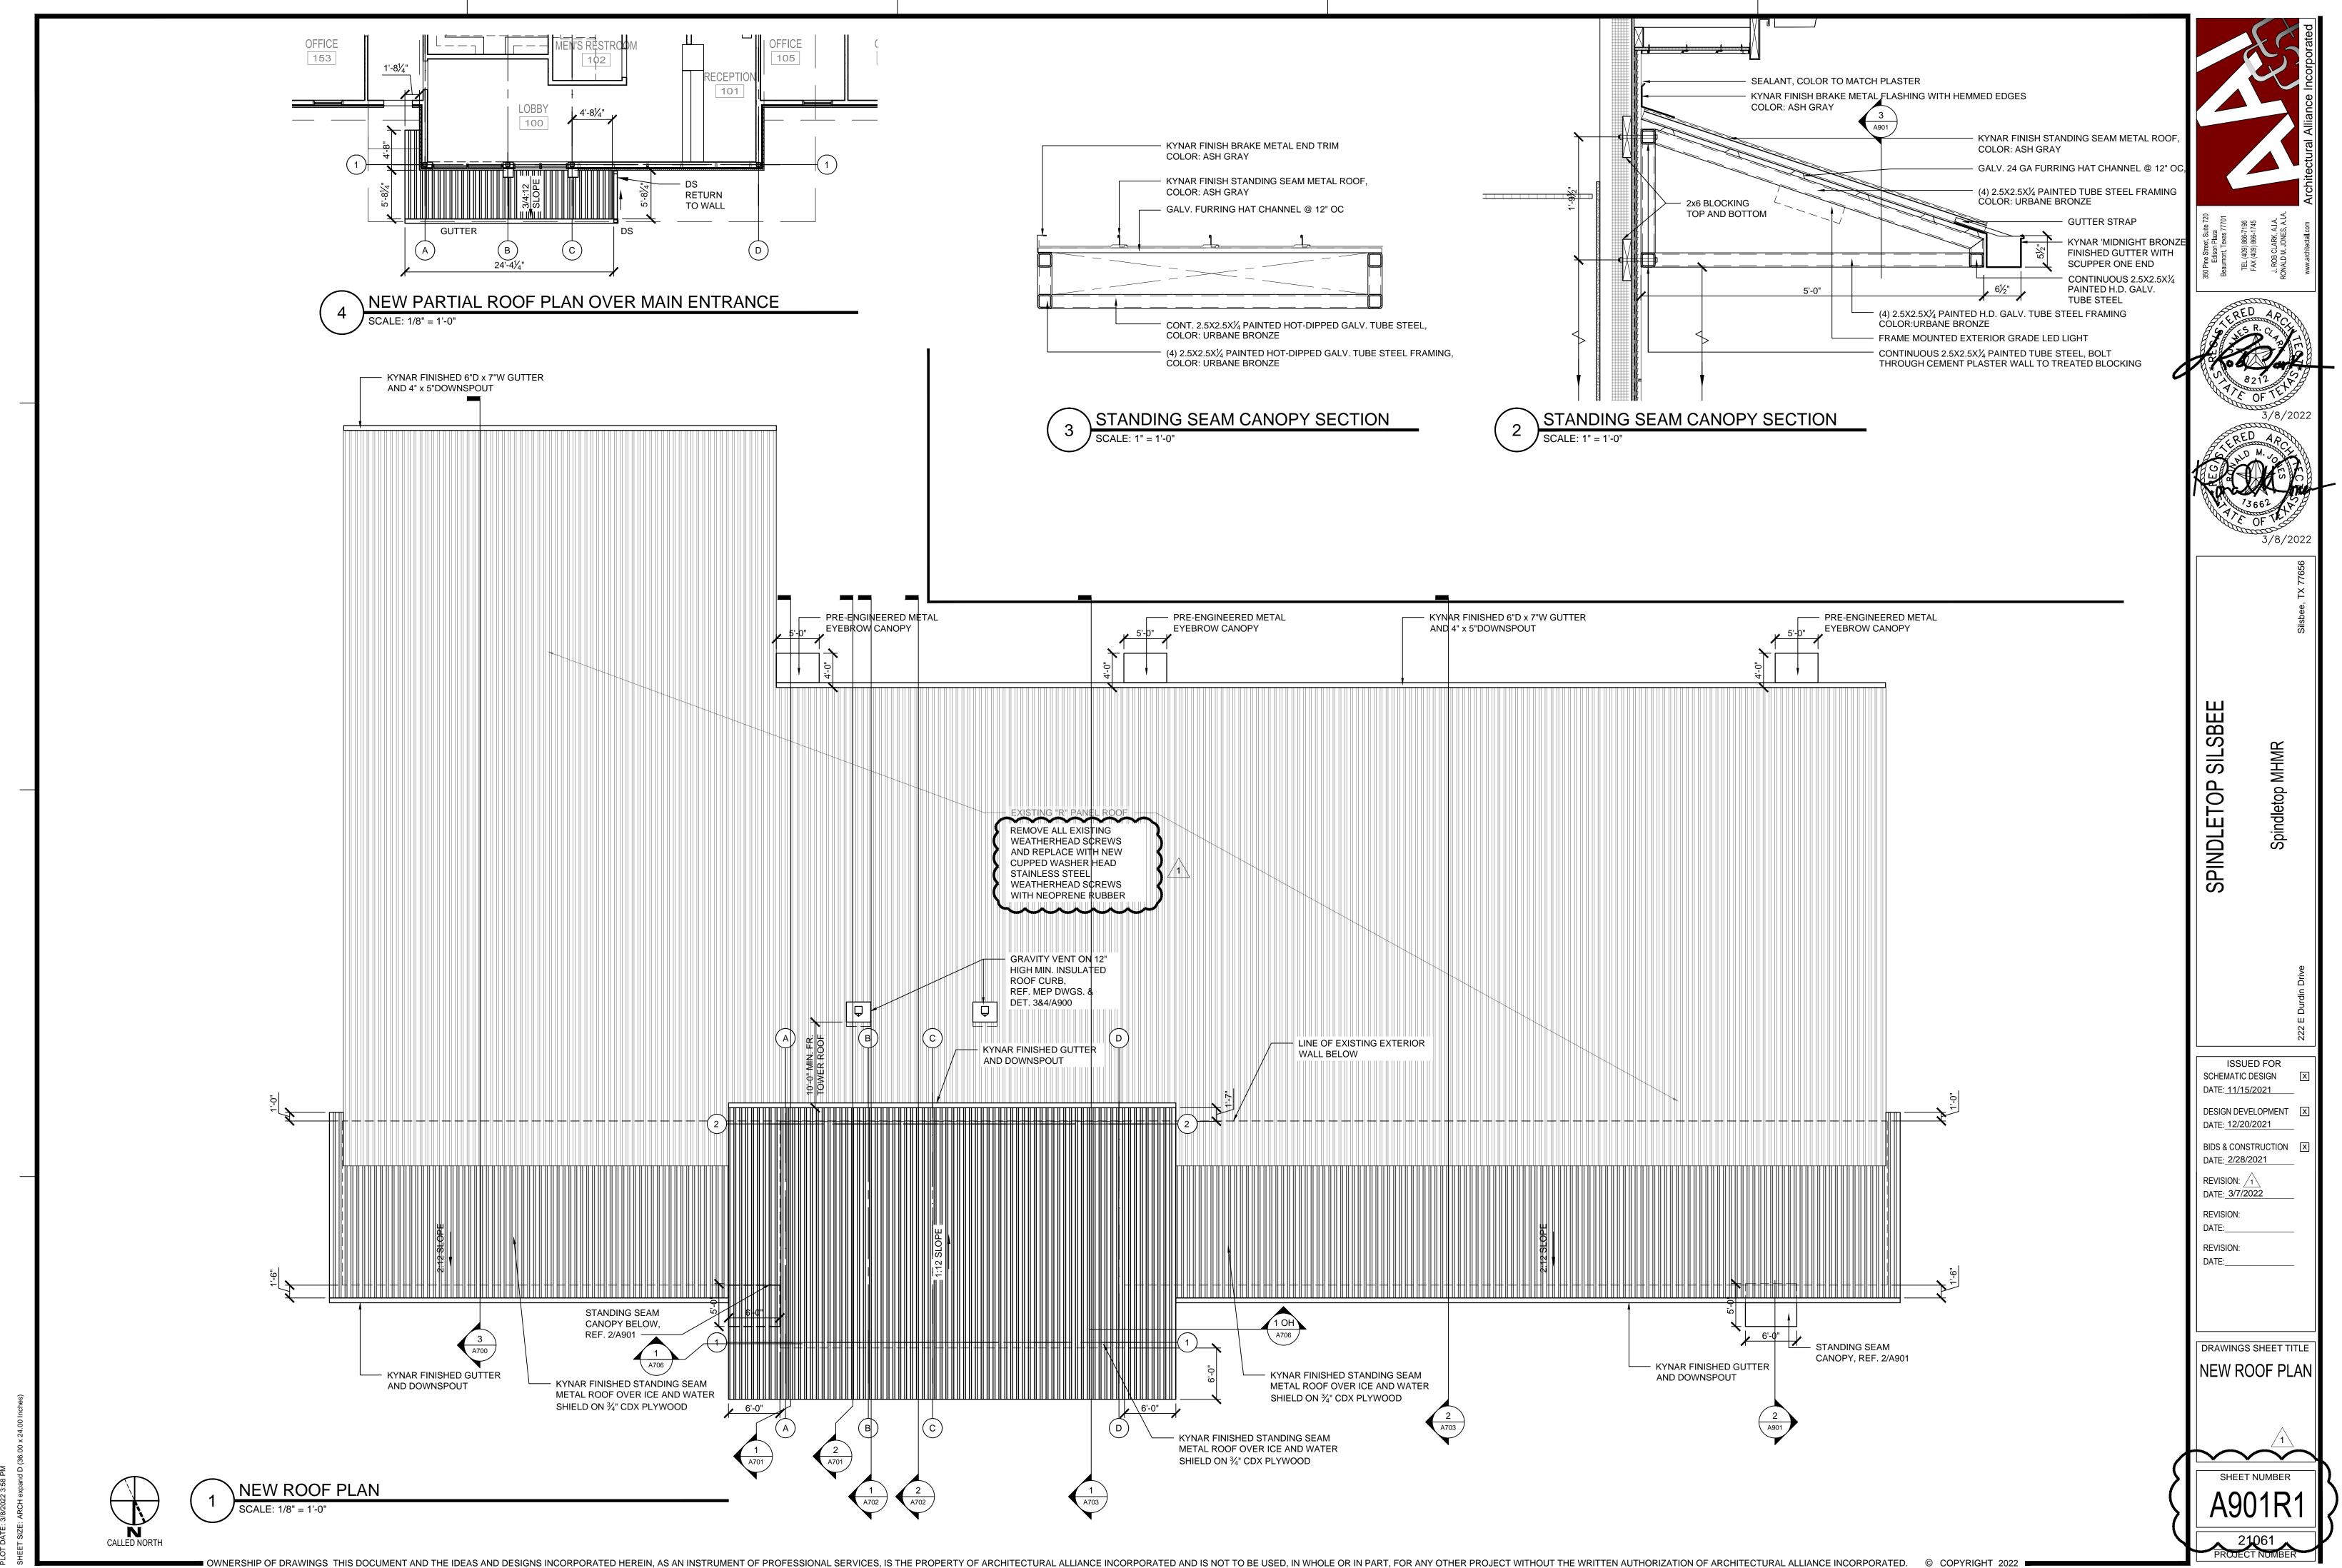


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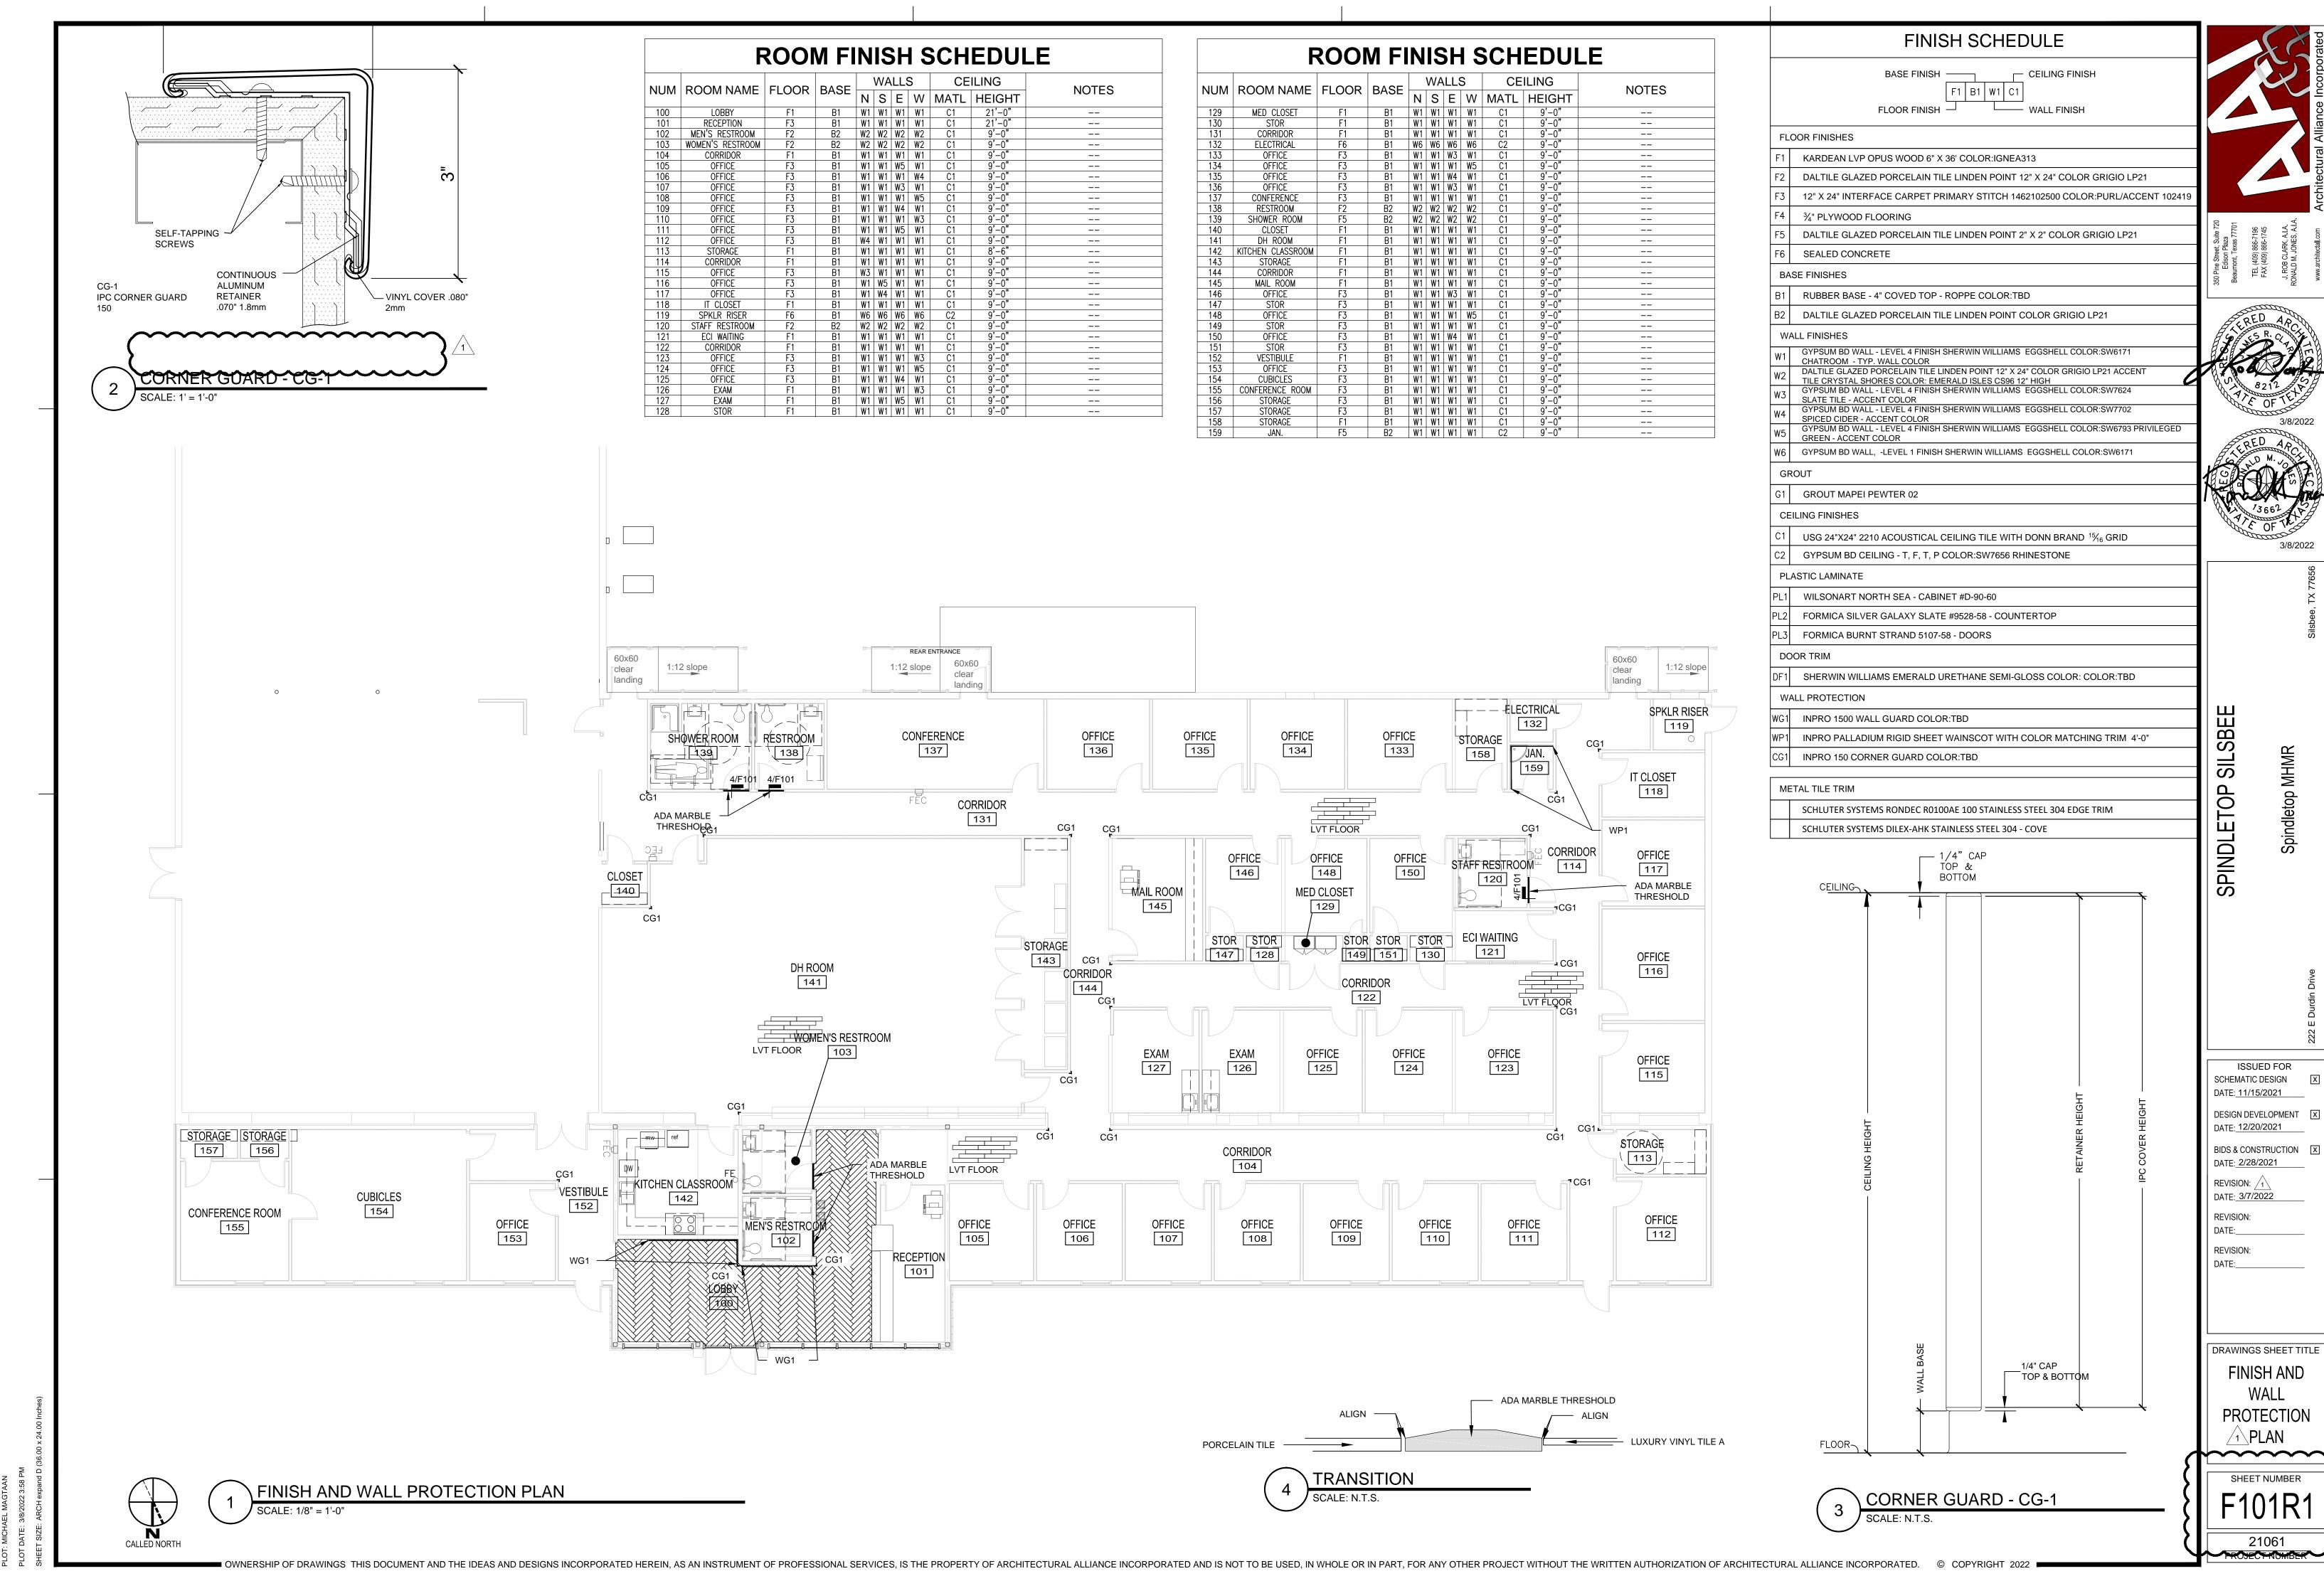


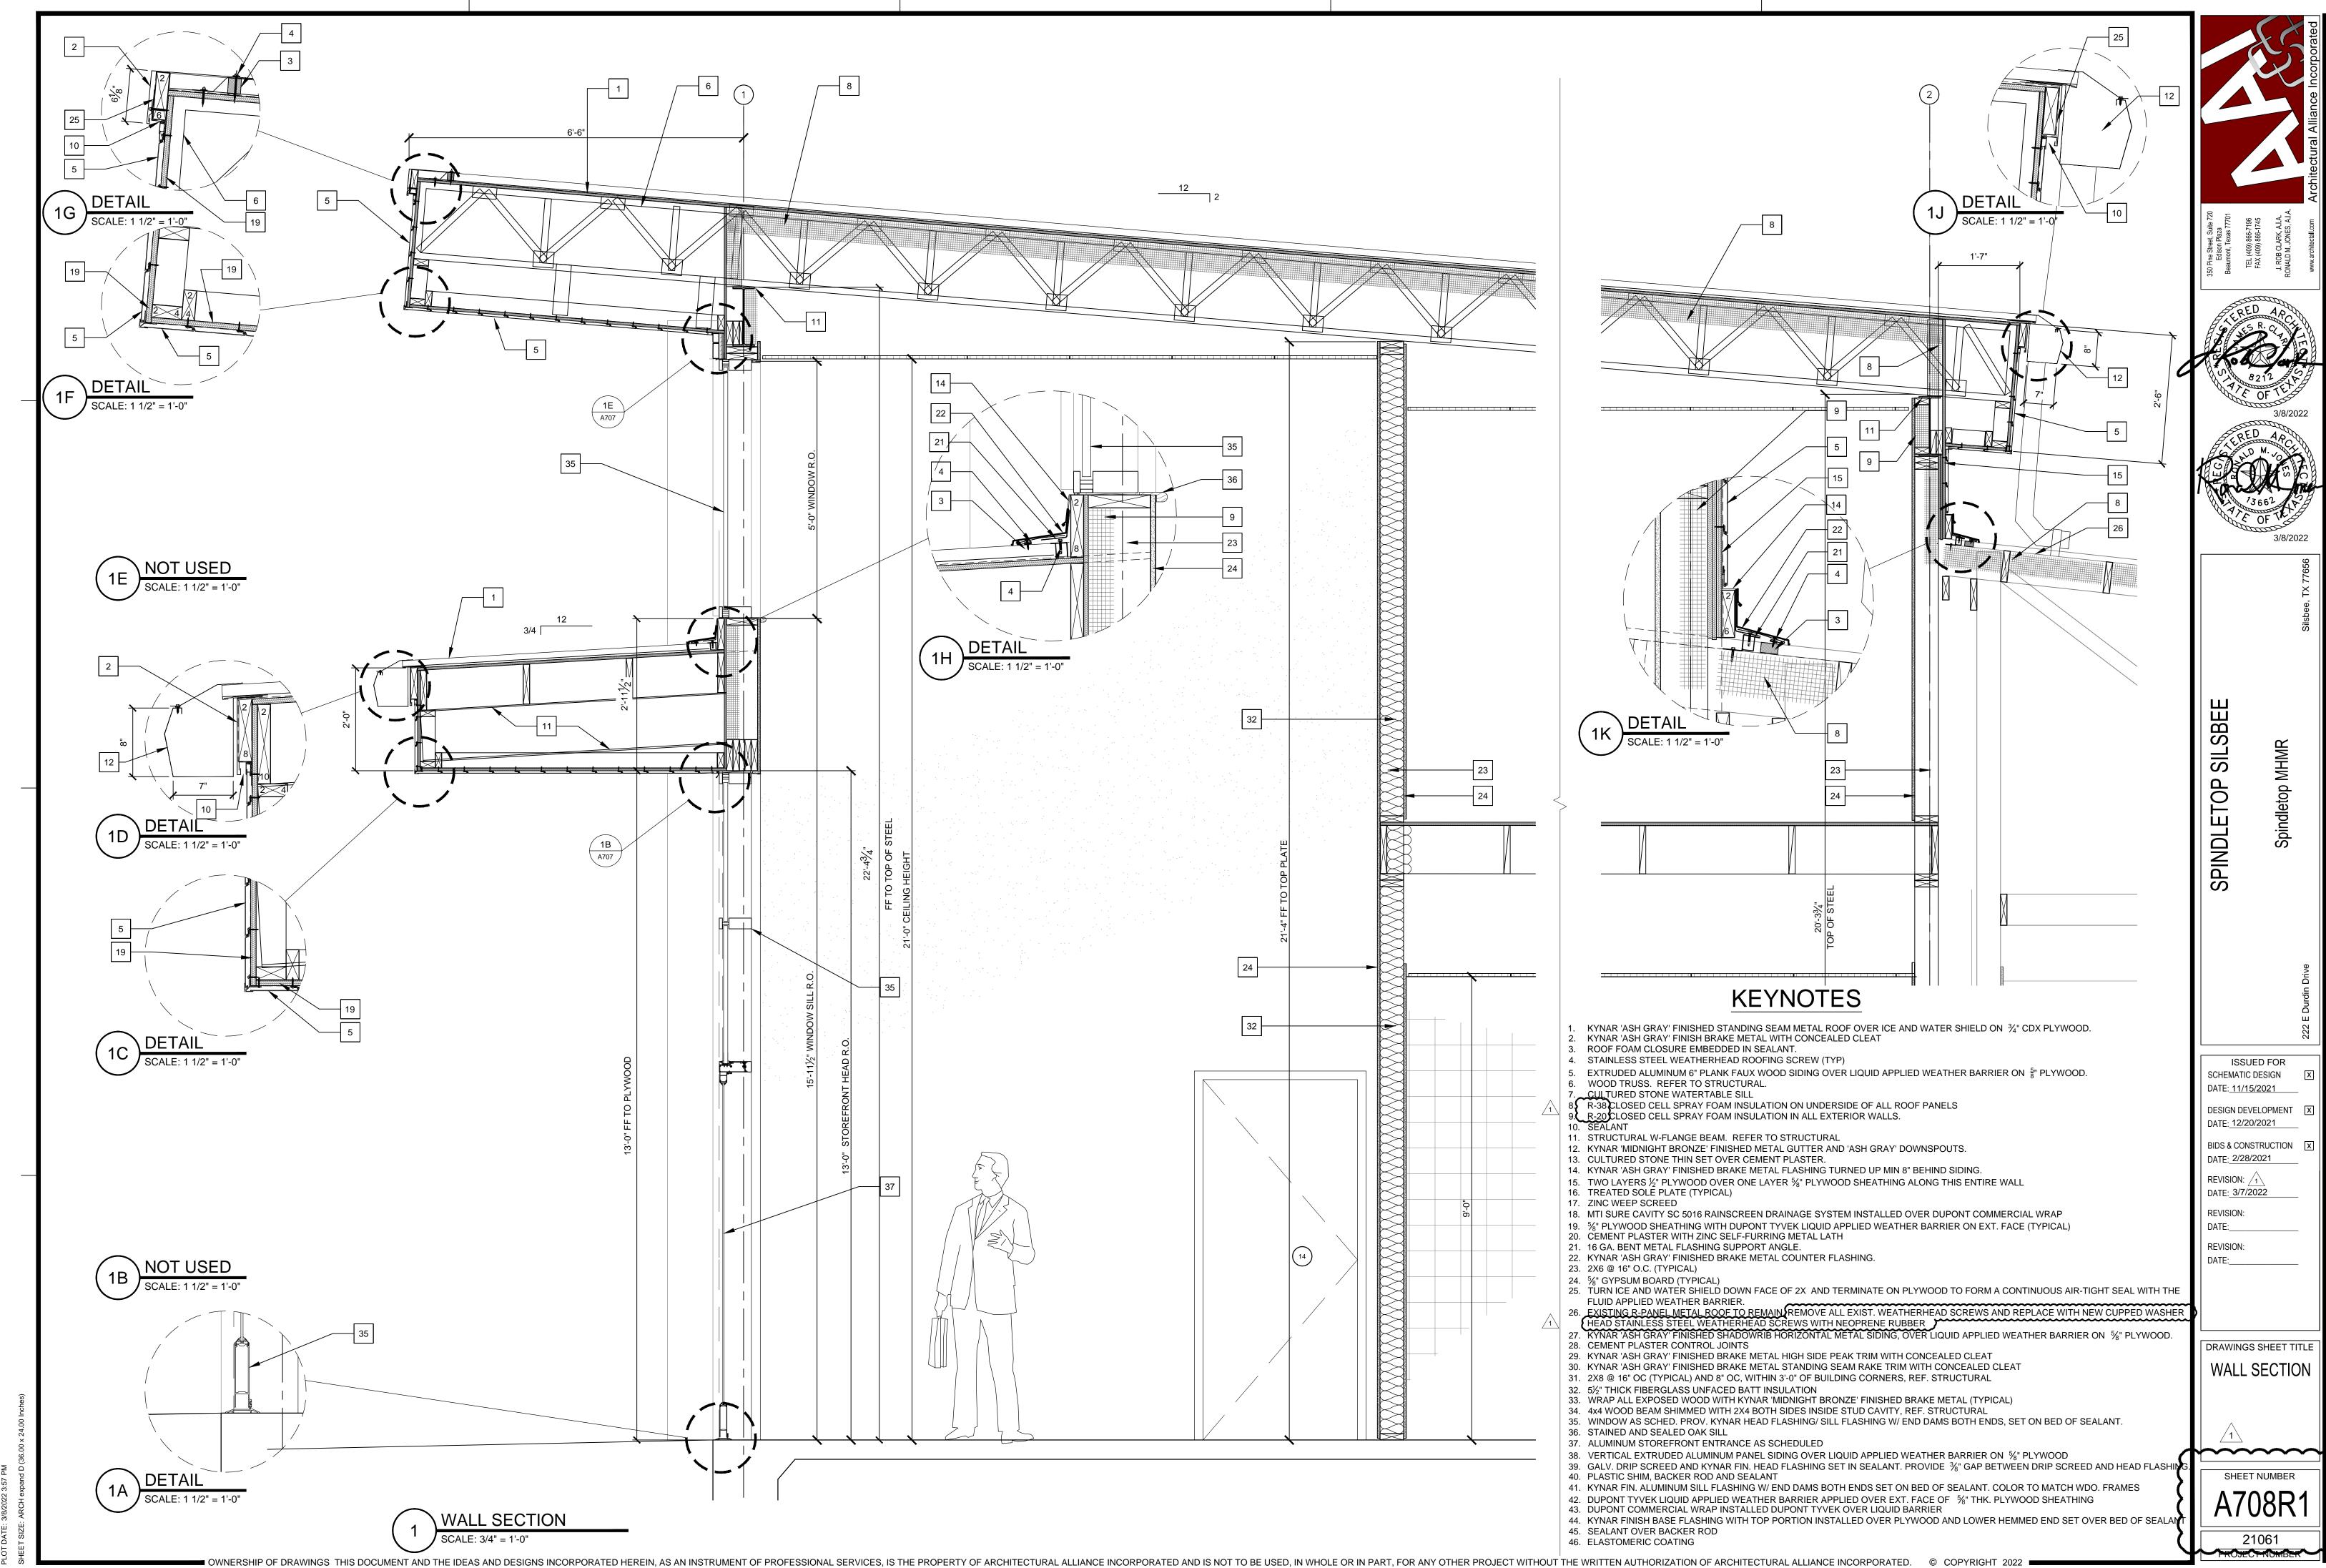
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PLOT DATE: 3/8/2022 3:58 PM



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#### SECTION 22 13 29 - SEWER LIFT STATION
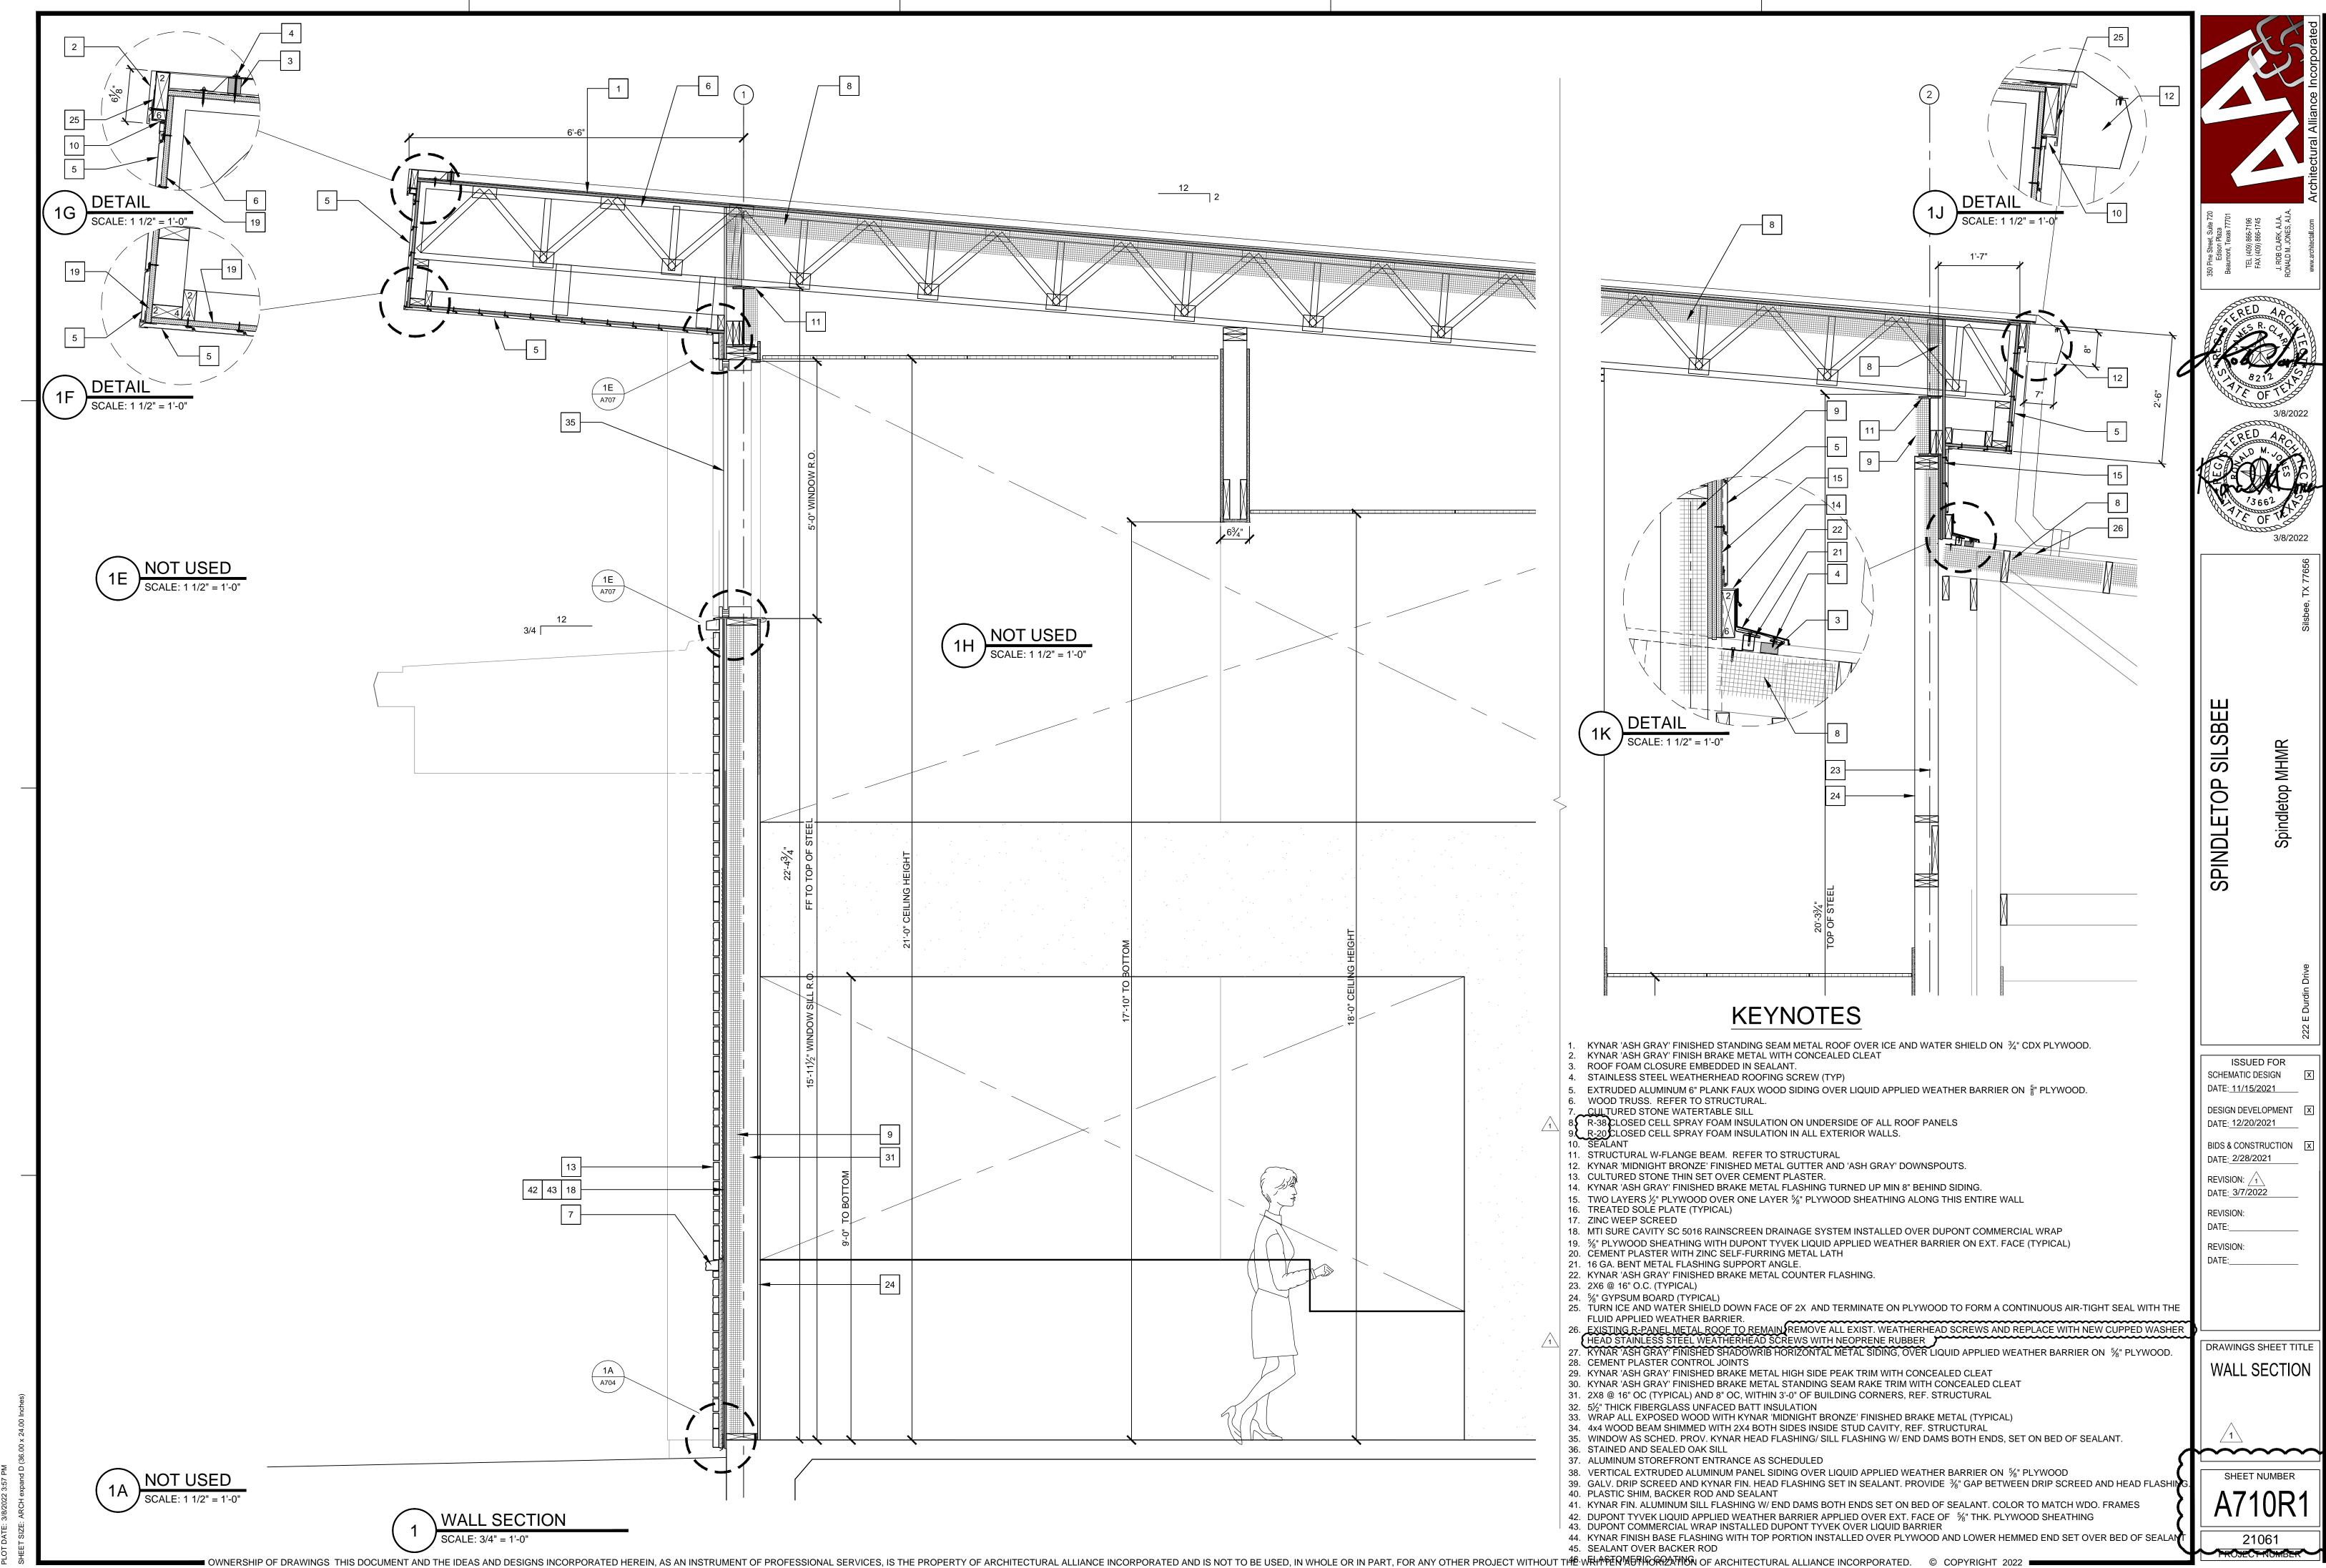
#### PART 1 - GENERAL

#### 1.1 RELATED DOCUMENTS

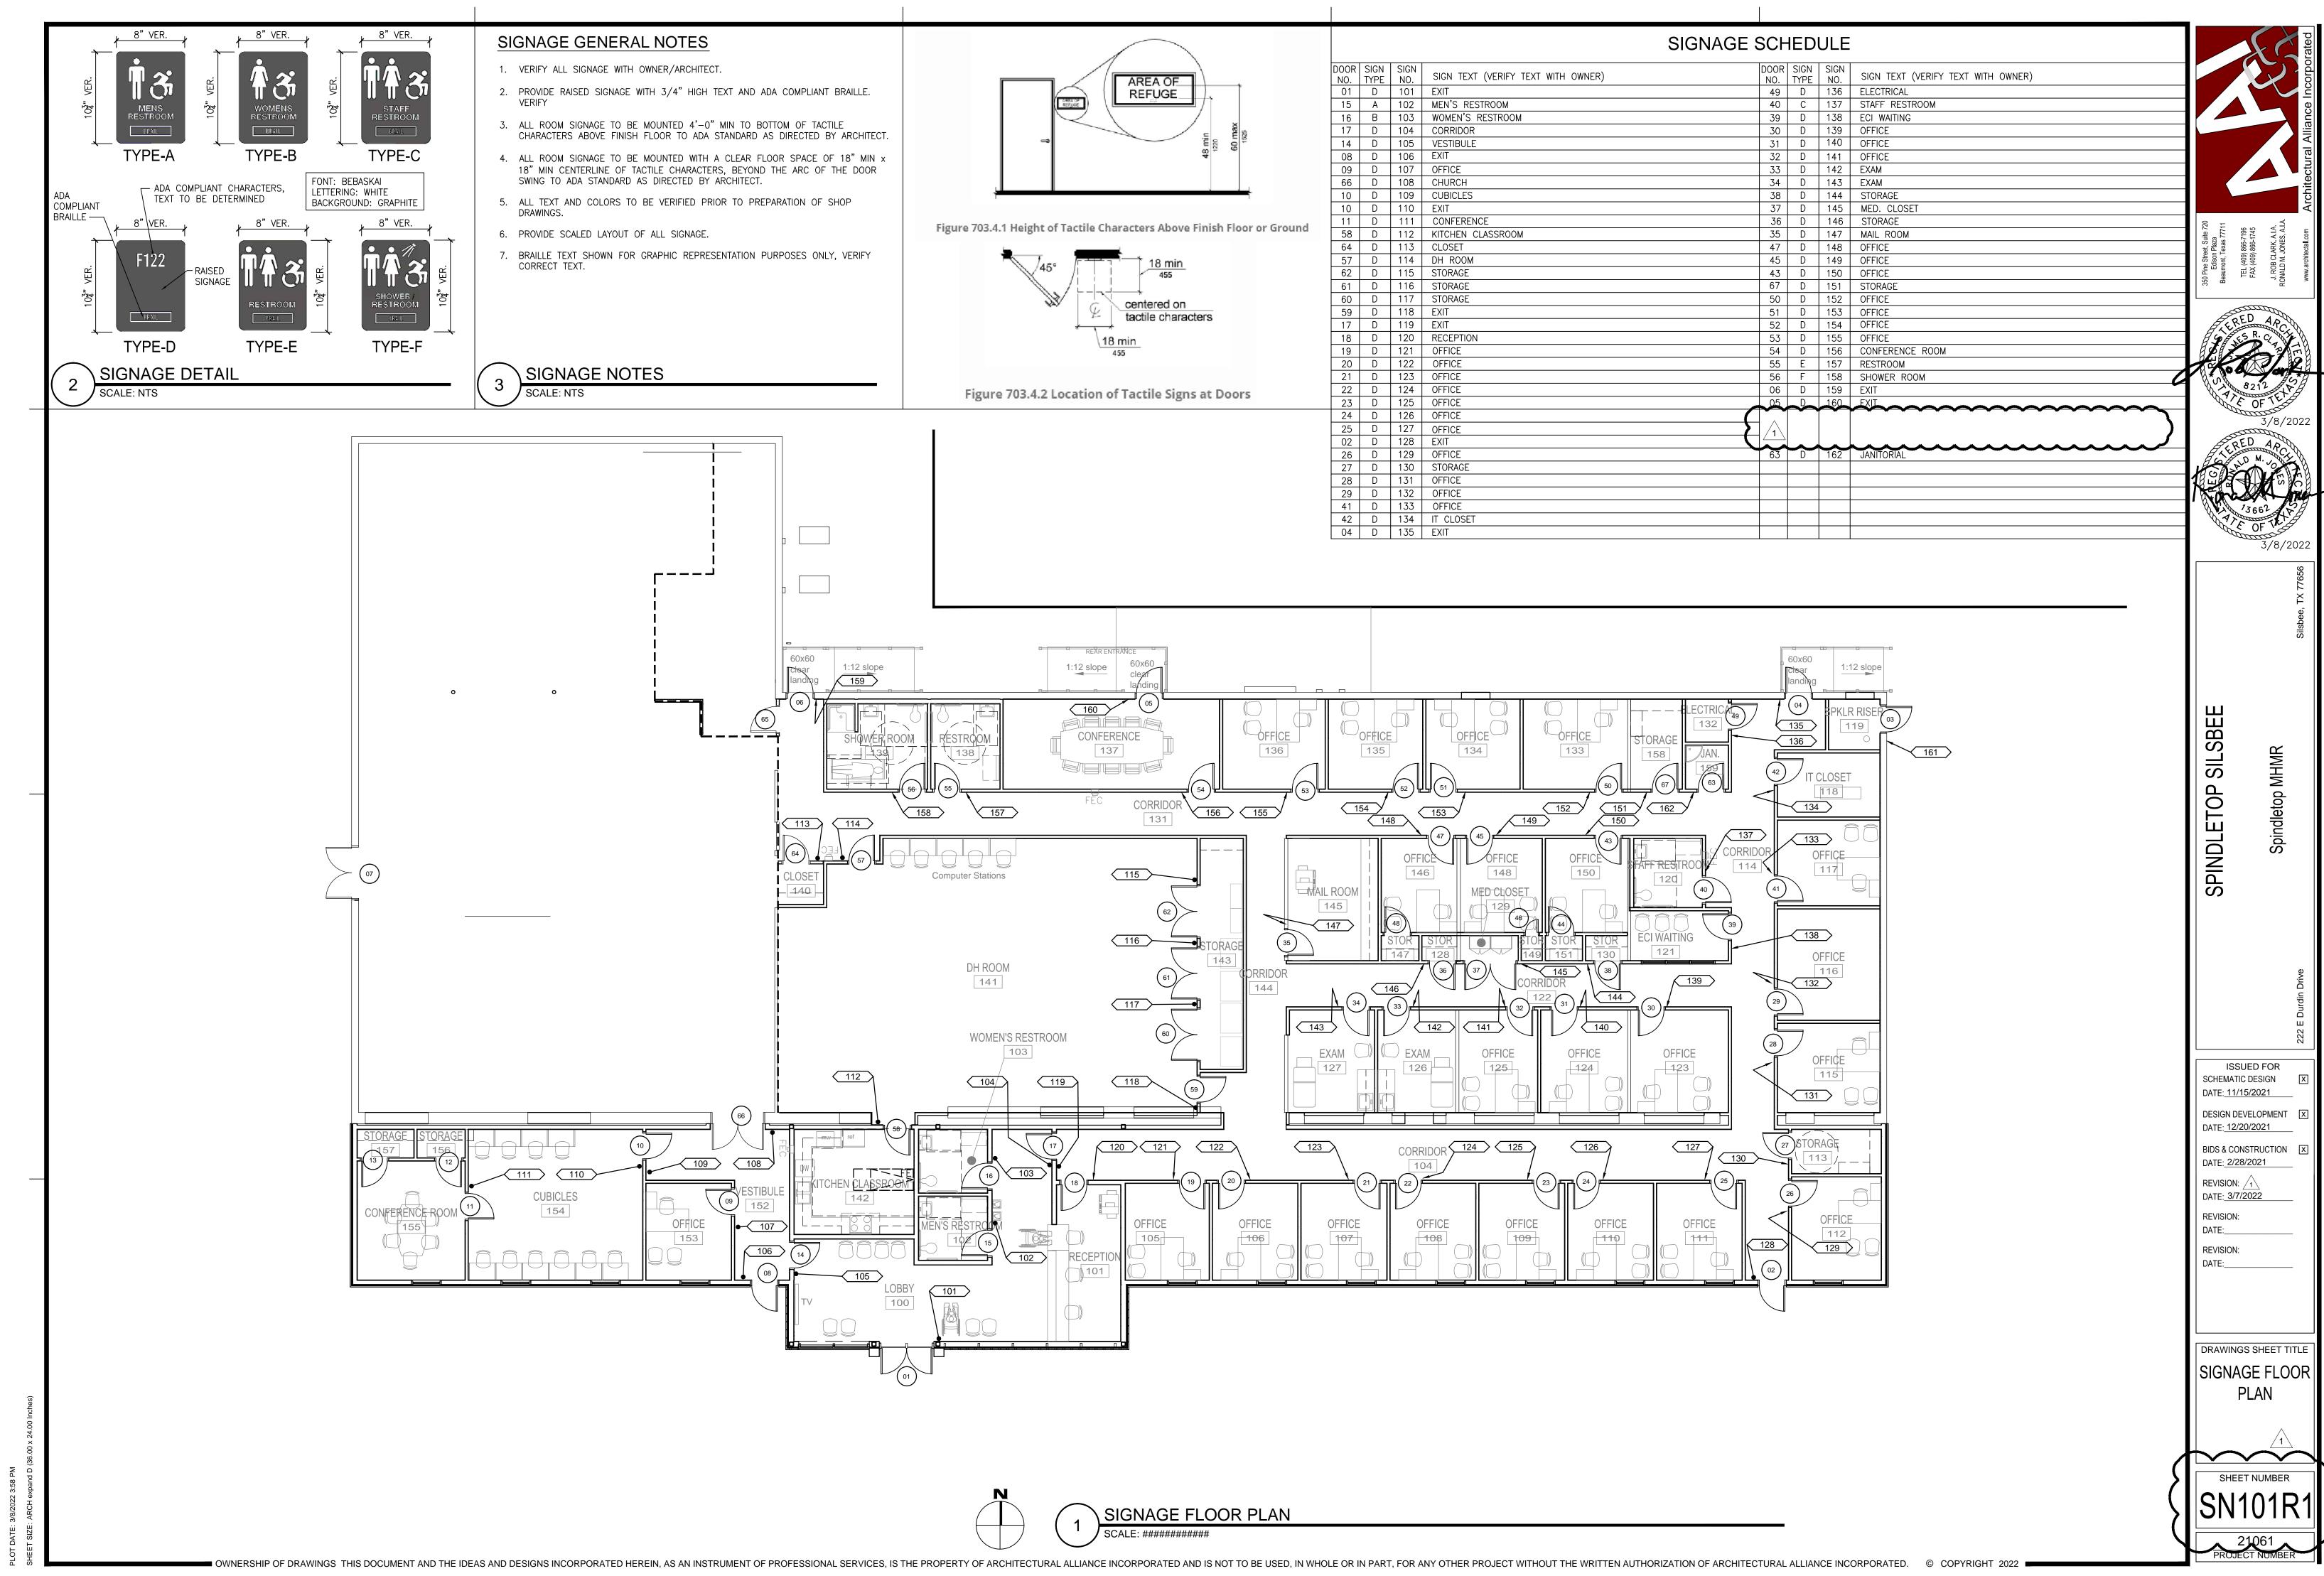A. Drawings and general provisions of the Contract, including General and Supplementary Conditions and Division 01 Specification Sections, apply to this Section.

#### 1.2 SUMMARY

- A. Provide a sewer lift station as indicated on Drawings. Capacity based on an estimated 35 occupants (employees) for an "Office" building in a 8 hour period.
- B. Contractor shall contact TX DSHS, TX DEQ, Local county health unit prior to bid to determine the extent of their requirements, pay all costs for complete working installation.
- C. Contractor shall be responsible for preparing and submitting the design summary package for the sewer lift station applications to the local, state and federal agencies for the review of the sewer lift station. Contractor shall be responsible for providing engineer's seal on the design summary package. Contractor shall be responsible for preparing and submitting the effluent outfall pattern description as required.
- D. CONTRACTOR SHALL VERIFY LOCATION AND ELEVATION OF SEWER MAIN PRIOR TO ROUGH-IN.

#### 1.3 ACTION SUBMITTALS

- A. Product Data: For each type of product indicated. Include construction details, material descriptions, dimensions of individual components and profiles. Include rated capacities, operating characteristics, electrical characteristics, and furnished specialties and accessories.
- B. Wiring Diagrams: For power, signal, and control wiring.

#### 1.4 CLOSEOUT SUBMITTALS

A. Operation and Maintenance Data: For pumps and controls, to include in operation and maintenance manuals.

#### 1.5 QUALITY ASSURANCE

- A. Electrical Components, Devices, and Accessories: Listed and labeled as defined in NFPA 70, by a qualified testing agency, and marked for intended location and application.
- B. UL Compliance: Comply with UL 778 for motor-operated water pumps.

#### 1.6 DELIVERY, STORAGE, AND HANDLING

- A. Retain shipping flange protective covers and protective coatings during storage.
- B. Protect bearings and couplings against damage.
- C. Comply with pump manufacturer's written rigging instructions for handling.

#### PART 2 - PRODUCTS

#### 2.1 SEWER LIFT STATION

- A. The Contractor shall furnish and install one Pre-assembled Duplex Grinder System lift station with (1) packaged duplex lift pumps and wet well required to meet invert and elevation requirements. Manufacturer shall be Liberty Model D3696LSG202-48 or approved equal.
- B. The lift station shall be equipped with Liberty LSG202, 2 HP duplex grinder pumps, duplex control panel (208-1-60), capacities of 50 GPM, a total dynamic head of 108', 25' power cord; lift-out package, GR20 guide rail assemblies, guide rail piping (galvanized steel), with high water alarm, seal failed alarm, float switches. 3'-0" diameter by 8'-0" fiberglass basin with anti-floatation flange with 2" side discharge down 24" from the cover, 36" blank fiberglass cover, stainless steel lift-out chains, 6" inlet flange, all piping inside wet well and junction box.
- C. The pumps shall be activated automatically be a mechanical float switches. The mechanical float switch controls shall be designed to automatically alternate the pumps at each cycle to equalize wear. An override control shall activate the lag pump automatically if liquid level in the lift station rises six inches above the activating point of the lead pump. In addition, a flashing light high water alarm shall be activated if liquid level rises six inches above the activating point of the lag pump. Each mechanical float switch control shall be installed completely from the bottom of the lift station to a point above the normal operating water level to insure normal operation of the mechanical float switch.
- D. Electrical controls shall be mounted within a weatherproof AE24H=NEMA 4X duplex alternating control panel including four floats, aux. contacts, and integral audio/visual high level alarm with built-in vent in the control pedestal. Controls shall include: duplex pump motor control center, 208-1-60, complete with across-the-line fusible switch type combination starters, 1 phase overload protection, control transformer, electrical alternator, pump running lights, reset push buttons, terminals for connection of overload or high-water alarm, and with "Hand-Off-On" selector switches. JB70 junction box, with watertight cable connectors and 2" conduit coupling.
- E. Discharge line shall include check valve and shut-off valve. Discharge shall be 2" diameter, solid wall schedule 40 PVC piping and fittings with solvent weld joints.
- F. Warranty: 3 years.

#### **PART 3 - EXECUTION**

#### 3.1 EXAMINATION

A. Examine roughing-in for plumbing piping to verify actual locations of sanitary drainage and vent piping connections before sewage pump installation.

#### 3.2 INSTALLATION

- A. Wiring Method: Comply with requirements in Section 260519 "Low-Voltage Electrical Power Conductors and Cables."
- B. Wiring within Enclosures: Bundle, lace, and train conductors to terminal points with no excess and without exceeding manufacturer's limitations on bending radii. Provide and use lacing bars and distribution spools.

#### 3.3 CONNECTIONS

- A. Comply with requirements for piping specified in Section 221316 "Sanitary Waste and Vent Piping." Drawings indicate general arrangement of piping, fittings, and specialties.
- B. Install piping adjacent to equipment to allow service and maintenance.

#### 3.4 FIELD QUALITY CONTROL

- A. Manufacturer's Field Service: Engage a factory-authorized service representative to inspect, test, and adjust components, assemblies, and equipment installations, including connections.
- B. Perform tests and inspections.
  - 1. Manufacturer's Field Service: Engage a factory-authorized service representative to inspect components, assemblies, and equipment installations, including connections, and to assist in testing.

#### C. Tests and Inspections:

- 1. Perform each visual and mechanical inspection.
- 2. Leak Test: After installation, charge system and test for leaks. Repair leaks and retest until no leaks exist.
- 3. Operational Test: After electrical circuitry has been energized, start units to confirm proper motor rotation and unit operation.
- 4. Test and adjust controls and safeties. Replace damaged and malfunctioning controls and equipment.
- D. Pumps and controls will be considered defective if they do not pass tests and inspections.
- E. Prepare test and inspection reports.

#### 3.5 STARTUP SERVICE

- A. Engage a factory-authorized service representative to perform startup service.
  - 1. Complete installation and startup checks according to manufacturer's written instructions.

#### 3.6 ADJUSTING

- A. Adjust pumps to function smoothly, and lubricate as recommended by manufacturer.
- B. Adjust control set points.

#### 3.7 OWNER TRAINING

A. Engage a factory-authorized service representative to train Owner's maintenance personnel to adjust, operate, and maintain controls and pumps.

END OF SECTION 22 13 29

**ELECTRICAL NOTES** 

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SPINDLETOP

DATE: 03/07/2022 REVISION: DATE:\_\_\_\_

REVISION: DATE:\_\_\_


DRAWINGS SHEET TITLE ELECTRICAL SITE PLAN

1304 BERTRAND DRIVE SUITE F7 LAFAYETTE, LOUISIANA 70506 (337) 234-7474 \* FAX (337) 234-7774

Mechanical Contact: Dustin Duval, P.E. dustin@meconsulting.com
Electrical Contact: David Carroll, P.E. david@meconsulting.com
PROJECT No.: 21167.00

SHEET NUMBER

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1/16" = 1'-0" Refer to Architectural Drawings for All Dimensions
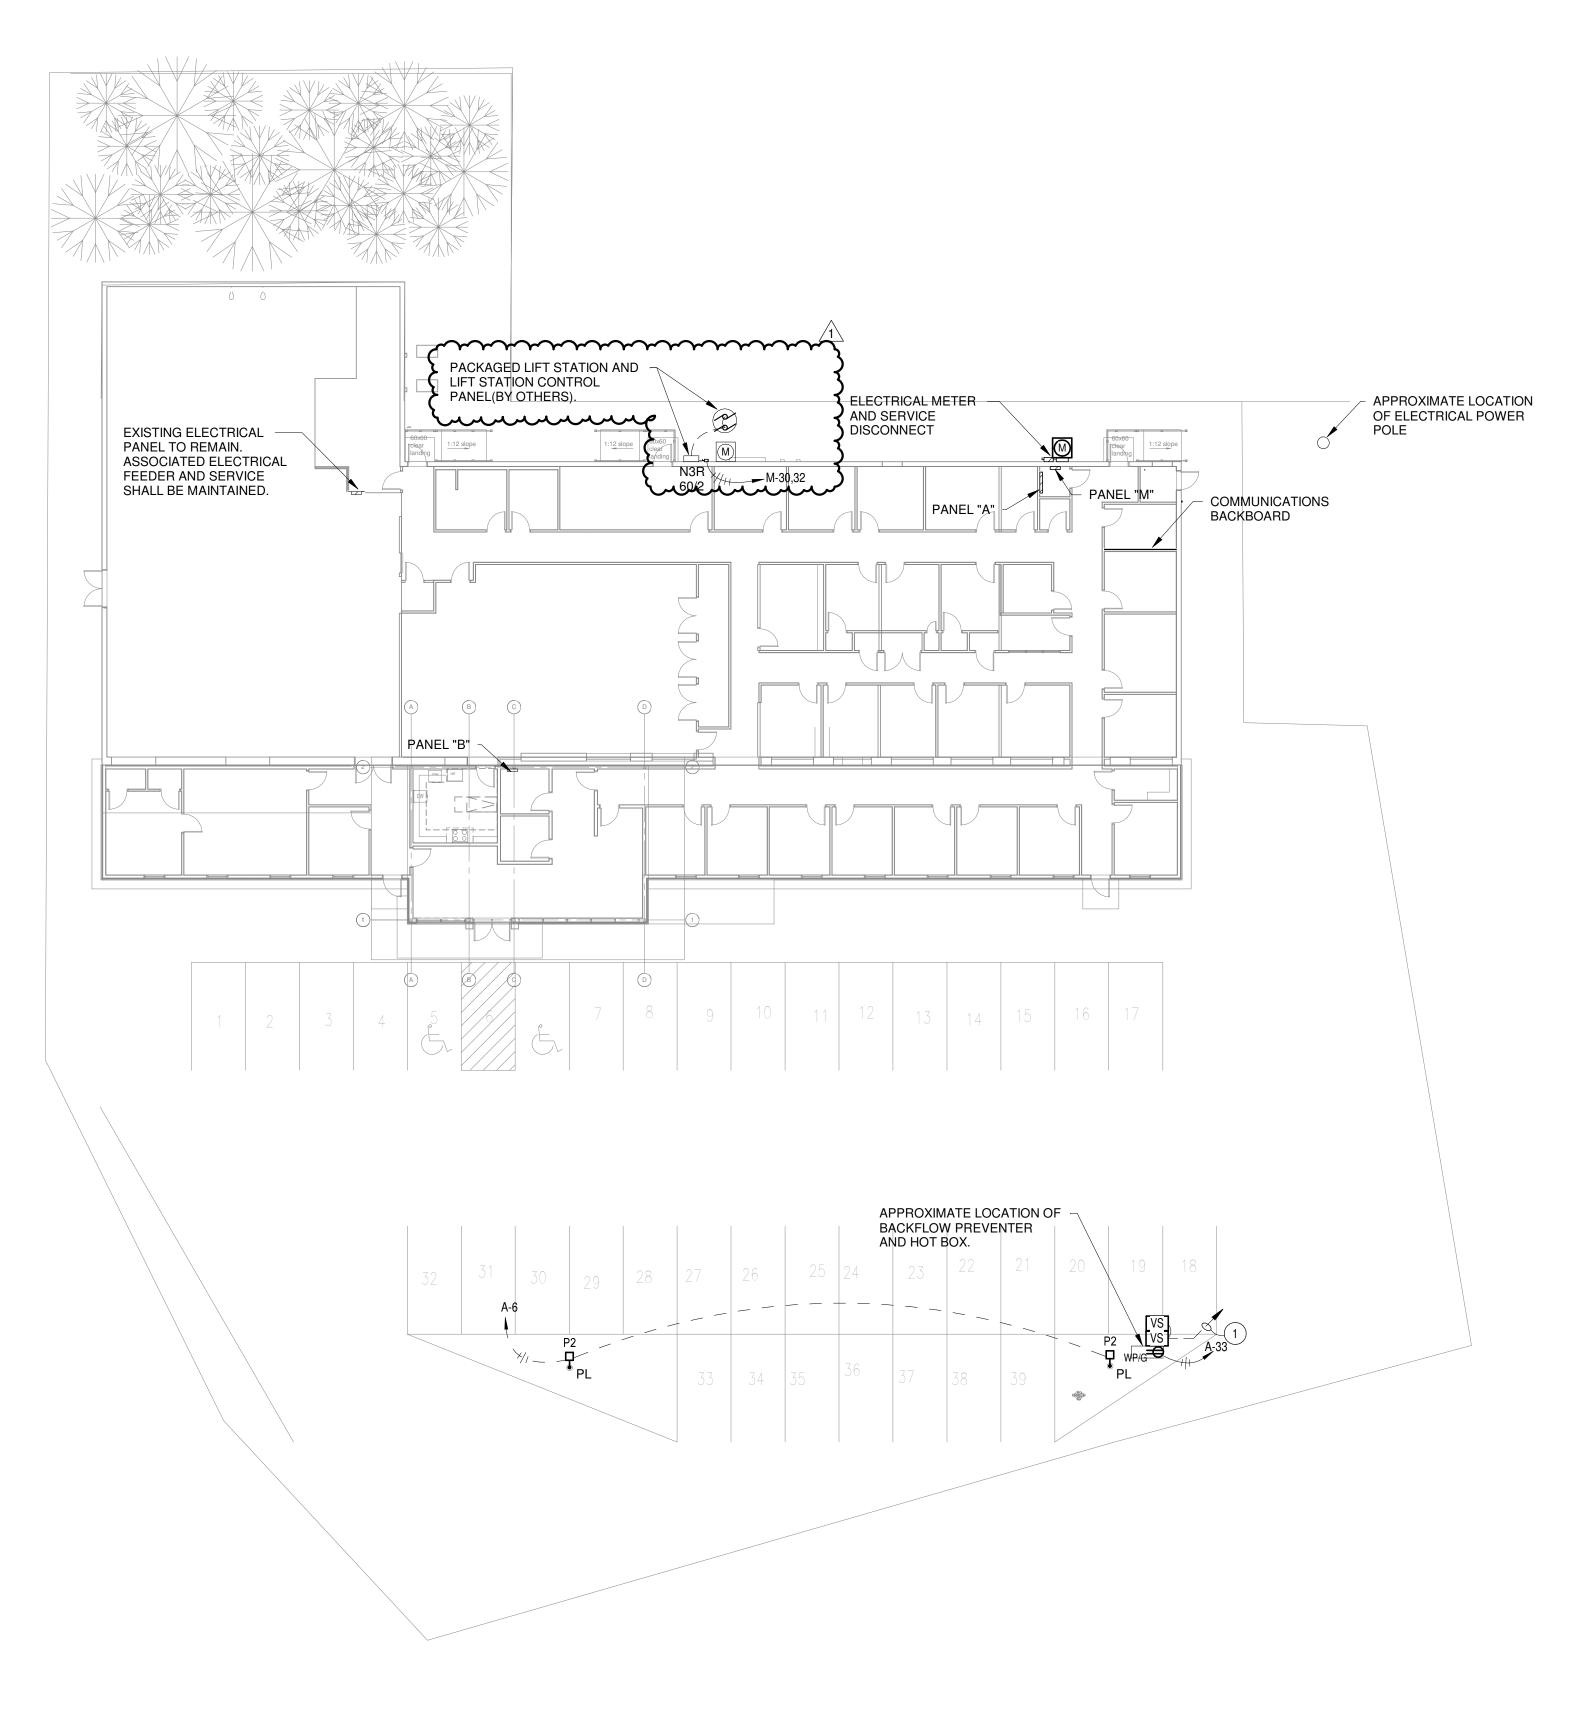
|        |       | Location<br>Mounting<br>Enclosure | <b>g։</b> Տս | ırface | ICAI | L 132    |          |       |       | Pha   | olts:<br>ises:<br>ires: |       | 208 W | Vye    |         |          |          | Mai | . Ratin<br>ns Typ<br>s Ratin | e: M | LO                       |    |       |
|--------|-------|-----------------------------------|--------------|--------|------|----------|----------|-------|-------|-------|-------------------------|-------|-------|--------|---------|----------|----------|-----|------------------------------|------|--------------------------|----|-------|
| Genera | ıl Sc | chedule Notes:                    |              |        |      | Veri     | fy prop  | er wo | rking | clear | ance                    | s per | N.E.  | C. pri | or to i | nstalla  | tion.    |     |                              |      |                          |    |       |
| Notes  | #     | Circuit Description               |              | Poles  | -    | Vire     | Gnd.     | C.    | Į.    | 1     | E                       | 3     | (     | 2      | C.      | Gnd.     | Wire     | •   | Poles                        | Trip | Circuit Description      | _  | Notes |
| 1      | 1     | Exterior Lighting                 | 20           | 1      | 2    | 10       | 10       | 3/4"  | 236   |       |                         |       |       |        |         |          |          |     |                              |      |                          | 2  |       |
|        | 3     | Lighting                          | 20           | 1      | 2    | 10       | 10       | 3/4"  |       |       | 1396                    | 1381  |       |        | 3/4"    | 10       | 10       | 2   | 1                            | 20   | Lighting                 | 4  |       |
|        | 5     | Comm bkbd 118                     | 20           | 1      | 2    | 12       | 12       | 1/2"  |       | 400   |                         |       | 180   | 332    | 3/4"    | 10       | 10       | 2   | 1                            | 20   | Pole Lights              | 6  | 1     |
|        | 7     | Rec(Off 116)                      | 20           | 1      | 2    | 12       | 12       | 1/2"  | 720   | 180   |                         |       |       |        | 1/2"    | 12       | 12       | 2   | 1                            | 20   | Comm bkbd 118            | 8  |       |
|        | 9     | Rec(Off 111)                      | 20           | 1      | 2    | 12       | 12       | 1/2"  |       |       | 720                     | 900   | 700   | 700    | 1/2"    | 12       | 12       | 2   | 1                            | 20   | Rec(Off 112)             | 10 |       |
|        | 11    | Rec(Off 109)                      | 20           | 1      | 2    | 12       | 12       | 1/2"  | 700   | 700   |                         |       | 720   | 720    | 1/2"    | 12       | 12       | 2   | 1                            | 20   | Rec(Off 108)             | 12 |       |
|        |       | Rec(Off 115/Hall)                 | 20           | 1      | 2    | 12       | 12       | 1/2"  | 720   | 720   | 700                     | 700   |       |        | 1/2"    | 12       | 12       | 2   | 1                            | 20   | Rec(Off 107)             | 14 |       |
|        |       | Rec(Off 106)                      | 20           | 1      | 2    | 12       | 12       | 1/2"  |       |       | 720                     | 720   | 1100  | 700    | 1/2"    | 12       | 12       | 2   | 1                            | 20   | Rec(Off 123)             | 16 |       |
|        |       | Rec(Conf. Rm. 137)                | 20           | 1      | 2    | 12       | 12       | 1/2"  | 700   | F00   |                         |       | 1180  | 720    | 1/2"    | 12       | 12       | 2   | 1                            | 20   | Rec(Exam 126)            | 18 |       |
|        |       | Rec(Exam 125)                     | 20           | 1      | 2    | 12<br>12 | 12<br>12 | 1/2"  | 720   | 500   | 720                     | 720   |       |        | 1/2"    | 12<br>12 | 12<br>12 | 2   | 1                            | 20   | FACP 119<br>Rec(Off 135) | 20 |       |
|        |       | Rec(Exam 127) Rec(Off 133)        | 20           | 1      | 2    | 12       | 12       | 1/2"  |       |       | 720                     | 720   | 720   | 900    | 1/2"    | 12       | 12       | 2   | 1                            | 20   | Rec(Mail Rm. 145)        | 24 |       |
|        |       | Copier 145                        | 20           | 1      | 2    | 12       | 12       | 1/2"  | 1000  | 1080  |                         |       | 720   | 900    | 1/2"    | 12       | 12       | 2   | 1                            | 20   | Rec(Off                  | 26 |       |
|        |       | Rec(Off 146)                      | 20           | 1      | 2    | 12       | 12       | 1/2"  | 1000  | 1000  | 720                     | 720   |       |        | 1/2"    | 12       | 12       | 2   | 1                            | 20   | Rec(Corridor 131)        | 28 |       |
|        |       | Rec(IT 118)                       | 20           | 1      | 2    | 12       | 12       | 1/2"  |       |       | 120                     | 120   | 360   | 1260   | 1/2"    | 12       | 12       | 2   | 1                            | 20   | Rec(Corridors)           | 30 |       |
|        |       | Rec(Elec 132)                     | 20           | 1      | 2    | 12       | 12       | 1/2"  | 900   | 720   |                         |       | 000   | 1200   | 1/2"    | 12       | 12       | 2   | 1                            | 20   | Rec(Off 110)             | 32 |       |
|        |       | Hot Box                           | 25           | 1      | 2    | 10       | 10       | 3/4"  | 300   | 120   | 1900                    | 720   |       |        | 1/2"    | 12       | 12       | 2   | 1                            | 20   | Rec(Off 124)             | 34 |       |
|        |       | Rec(Off 148)                      | 20           | 1      | 2    | 12       | 12       | 1/2"  |       |       | 1300                    | 120   | 720   | 720    | 1/2"    | 12       | 12       | 2   | 1                            | 20   | Rec(Off 117)             | 36 |       |
|        |       | Rec(Off 136)                      | 20           | 1      | 2    | 12       | 12       | 1/2"  | 720   | 720   |                         |       | 120   | 720    | 1/2"    | 12       | 12       | 2   | 1                            | 20   | Rec(Off 134)             | 38 |       |
|        |       | Space                             |              | 1      |      |          |          |       | •     |       |                         | 0     |       |        |         |          |          | _   | 3                            | 60   | SPD                      | 40 | (3)   |
|        |       | Space                             |              | 1      |      |          |          |       |       |       |                         |       |       | 0      |         |          |          |     |                              |      |                          | 42 |       |
|        |       | Space                             |              | 1      |      |          |          |       |       | 0     |                         |       |       |        |         |          |          | -   |                              |      |                          | 44 |       |
|        |       | Space                             |              | 1      |      |          |          |       |       |       |                         | 0     |       |        |         |          |          | -   | 1                            | 20   | Spare                    | 46 |       |
|        |       | Space                             |              | 1      |      |          |          |       |       |       |                         |       |       | 0      |         |          |          | -   | 1                            | 20   | Spare                    | 48 |       |
|        |       | Space                             |              | 1      |      |          |          |       |       | 0     |                         |       |       |        |         |          |          | -   | 1                            | 20   | Spare                    | 50 |       |
|        |       | Space                             |              | 1      |      |          |          |       |       |       |                         | 0     |       |        |         |          |          |     | 1                            | 20   | Spare                    | 52 |       |
|        |       | Space                             |              | 1      |      |          |          |       |       |       |                         |       |       | 0      |         |          |          |     | 1                            | 20   | Spare                    | 54 |       |
|        |       | Space                             |              | 1      |      |          |          |       |       | 0     |                         |       |       |        |         |          |          | -   | 1                            | 20   | Spare                    | 56 |       |
|        |       | Space                             |              | 1      |      |          |          |       |       |       |                         | 0     |       |        |         |          |          |     | 1                            | 20   | Spare                    | 58 |       |
|        |       | Space                             |              | 1      |      |          |          |       |       |       |                         |       |       | 0      |         |          |          |     | 1                            | 20   | Spare                    | 60 |       |
|        | 61    | -                                 |              |        |      |          |          |       |       |       |                         |       |       |        |         |          |          |     |                              |      | -                        | 62 |       |
|        | 63    |                                   |              64 |       |
|        | 65    |                                   |              66 |       |
|        | 67    |                                   |              68 |       |
|        | 69    |                                   |              70 |       |
|        | 71    |                                   |              72 |       |
|        | 73    |                                   |              74 |       |
|        | 75    |                                   |              76 |       |
|        | 77    |                                   |              78 |       |
|        | 79    |                                   |              80 |       |
|        | 81    |                                   |              82 |       |
|        | 83    |                                   |              84 |       |
|        |       |                                   |              |        |      |          | Total    |       | 9 k   |       | 11                      |       |       | VΑ     |         |          |          |     |                              |      |                          |    |       |

Panel Schedule Notes: (Notes below do not necessarily appear in panel schedule) CIRCUIT VIA 4 POLE LIGHTING CONTACTOR. CONTROL WITH (2) CIRCUIT INTERMATIC OR EQUAL ASTRONOMICAL TIME CLOCK WITH BATTERY BACKUP

100.00%

125.00%

70.03%

500 VA

4163 VA

17480 VA

Total Conn. Load: 29 kVA

Total Conn.: 80 A Total Est. Demand: 61 A

Total Est. Demand: 22 kVA

500 VA

3330 VA

24960 VA

AND PHOTOCELL. PHOTOCELL "ON" TIME CLOCK "OFF". PROVIDE GFCI PROTECTED CIRCUIT BREAKER. CONDUIT, WIRE, AND BREAKER SIZE PER MANUFACTURER'S REQUIREMENTS.

Receptacles

#### **Branch Panel: M** Location: ELECTRICAL 132 **A.I.C. Rating:** 22,000 Volts: 120/208 Wye Mounting: Surface Mains Type: MLO Phases: 3 Enclosure: Type 1 Mains Rating: 400 A General Schedule Notes: Verify proper working clearances per N.E.C. prior to installation. MSCU-1/MSAHU-1 20 2 2 12 12 3/4" 1165 4128 1 1/4" 8 4 3 3 70 HR-1 1165 4128 -- | 3 |--(1) | 5 | HR-2 80 | 3 | 3 | 3 | 8 | 1 1/4" | 4992 | 4128 | -- | -- | -- | -- | -- | ---- | -- | -- | -- | 4992 | 439 | 1/2" | 12 | 12 | 2 | 15 | HR-1 UNITS -- 9 --4992 439 (1) | 11 | HR-2 UNITS 15 2 2 12 12 12 1/2" | 1000 | 8924 | 2" | 6 | 1 | 4 | 3 | 125 | Panel "A" -- 13 --1000 112... 1) 15 EUH-1 20 2 2 12 12 1/2" 1500 8532 1500 4128 1 1/4" 8 4 3 3 70 OACU-1 -- 17 --20 2 2 12 12 1/2" 312 4128 1) | 19 | OAHU-1/OABC-1 312 4128 -- 21 --1) 23 WH-1 | 2250 | 0 | -- | -- | -- | 3 | 100 | SPD 30 2 2 10 10 3/4" | -- | -- | -- | -- | -- | 2250 | 0 -- 25 --27 Panel "B" 125 3 4 1 6 2" 139... 0 -- 29 ---- 31 ---- 33 Space -- 1 -- -- -- ---- 35 Space -- | 37 | Space - | -- | -- | 1 | -- |Space -- | 39 | Space -- 41 Space

| TI Opace            |                |        |           |          |           |      | ٠.      | Opa       | 00      | 72 |  |
|---------------------|----------------|--------|-----------|----------|-----------|------|---------|-----------|---------|----|--|
|                     | Total Load:    | 44 kVA | 39 kVA    | 37 kVA   |           |      |         |           |         |    |  |
|                     | Total Amps:    | 373 A  | 330 A     | 306 A    |           |      |         |           |         |    |  |
| Load Classification | Connected Load | Dema   | nd Factor | Estimate | ed Demand |      |         | Panel     | Totals  |    |  |
| HVAC                | 33375 VA       | 10     | 0.00%     | 333      | 375 VA    |      |         |           |         |    |  |
| Heating             | 3000 VA        | 10     | 0.00%     | 30       | 00 VA     | То   | tal Co  | nn. Load: | 120 kVA |    |  |
| Motor               | 5491 VA        | 10     | 0.00%     | 549      | 91 VA     | Tota | al Est. | Demand:   | 102 kVA |    |  |
| Lighting            | 8684 VA        | 12     | 5.00%     | 108      | 355 VA    |      | Tot     | al Conn.: | 334 A   |    |  |
| Water Heater        | 4500 VA        | 10     | 0.00%     | 450      | 00 VA     | Tota | al Est. | Demand:   | 283 A   |    |  |
| Condensing Units    | 14714 VA       | 10     | 0.00%     | 147      | 714 VA    |      |         |           |         |    |  |
| Receptacles         | <br>50720 VA   | 59     | 9.86%     | 303      | 360 VA    |      |         |           |         |    |  |

Panel Schedule Notes: (Notes below do not necessarily appear in panel schedule)

- VERIFY BREAKER SIZE PER EQUIPMENT MANUFACTURER'S RECOMMENDED NAME PLATE RATING PRIOR TO SHOP DRAWINGS PHASE OF PROJECT. CIRCUIT VIA \_ POLE LIGHTING CONTACTOR. CONTROL WITH (2) CIRCUIT INTERMATIC OR EQUAL ASTRONOMICAL TIME CLOCK WITH BATTERY BACKUP. PHOTOCELL "ON" TIME CLOCK "OFF".
- PROVIDE GFCI PROTECTED CIRCUIT BREAKER.
- CONDUIT, WIRE, AND BREAKER SIZE PER MANUFACTURER'S REQUIREMENTS. LABEL AS "MAIN SERVICE DISCONNECT".

**Branch Panel: B** 

Volts: 120/208 Wye **A.I.C. Rating:** 22,000 Location: Mounting: Surface Mains Type: MLO Enclosure: Type 1 Mains Rating: 125 A Wires: 4

General Schedule Notes:

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Verify proper working clearances per N.E.C. prior to installation.

| Votes | #  | Circuit Description | Trip | Poles | ٧ | Vire | Gnd. | C.   |      | 4    | ı    | В    | (    |      | C.   | Gnd. | Wir | е | Poles | Trip | Circuit Description | #  | Notes |
|-------|----|---------------------|------|-------|---|------|------|------|------|------|------|------|------|------|------|------|-----|---|-------|------|---------------------|----|-------|
| 2)    | 1  | Exterior Lighting   | 20   | 1     | 2 | 10   | 10   | 3/4" | 153  | 1455 |      |      |      |      | 1/2" | 12   | 12  | 2 | 1     | 20   | Lighting            | 2  |       |
|       | 3  | Lighting            | 20   | 1     | 2 | 12   | 12   | 1/2" |      |      | 1053 | 1080 |      |      | 1/2" | 12   | 12  | 2 | 1     | 20   | Rec(Cubicles 154)   | 4  |       |
|       | 5  | Rec(Conf. Rm. 155)  | 20   | 1     | 2 | 12   | 12   | 1/2" |      |      |      |      | 1080 | 720  | 1/2" | 12   | 12  | 2 | 1     | 20   | Rec(Cubicles 154)   | 6  |       |
|       | 7  | Rec(Cubicles 154)   | 20   | 1     | 2 | 12   | 12   | 1/2" | 720  | 1260 |      |      |      |      | 1/2" | 12   | 12  | 2 | 1     | 20   | Rec(Lobby 100/RR)   | 8  |       |
|       | 9  | Rec(Off 153)        | 20   | 1     | 2 | 12   | 12   | 1/2" |      |      | 900  | 1000 |      |      | 1/2" | 12   | 12  | 2 | 1     | 20   | Copier 101          | 10 |       |
|       | 11 | Rec(Reception 101)  | 20   | 1     | 2 | 12   | 12   | 1/2" |      |      |      |      | 540  | 1200 | 1/2" | 12   | 12  | 2 | 1     | 20   | Refrigerator 142    | 12 | (3)   |
| 3     | 13 | EWC's               | 20   | 1     | 2 | 12   | 12   | 1/2" | 1000 | 360  |      |      |      |      | 1/2" | 12   | 12  | 2 | 1     | 20   | Rec(Kitchen 142)    | 14 |       |
|       | 15 | Microwave 142       | 20   | 1     | 2 | 12   | 12   | 1/2" |      |      | 180  | 360  |      |      | 1/2" | 12   | 12  | 2 | 1     | 20   | Rec(Kitchen 142)    | 16 |       |
| 3)    | 17 | Dish Washer 142     | 20   | 1     | 2 | 12   | 12   | 1/2" |      |      |      |      | 1000 | 4160 | 1"   | 10   | 6   | 2 | 2     | 50   | Stove               | 18 | (5)   |
| 1)    | 19 | KH-1/KEF-1          | 20   | 1     | 2 | 12   | 12   | 1/2" | 500  | 4160 |      |      |      |      |      |      |     |   |       |      |                     | 20 |       |
|       | 21 | Rec(Off 105/Recep)  | 20   | 1     | 2 | 12   | 12   | 1/2" |      |      | 720  | 0    |      |      |      |      |     |   | 1     | 20   | Spare               | 22 |       |
|       | 23 | Rec(DH Rm 141)      | 20   | 1     | 2 | 12   | 12   | 1/2" |      |      |      |      | 900  | 500  | 1/2" | 12   | 12  | 2 | 1     | 20   | Changing Table 139  | 24 |       |
|       | 25 | Rec(Exterior & RRs) | 20   | 1     | 2 | 12   | 12   | 1/2" | 720  | 900  |      |      |      |      | 1/2" | 12   | 12  | 2 | 1     | 20   | Rec(DH Rm 141)      | 26 |       |
|       | 27 | Rec(DH Rm. 141)     | 20   | 1     | 2 | 12   | 12   | 1/2" |      |      | 720  | 720  |      |      | 1/2" | 12   | 12  | 2 | 1     | 20   | Rec(Corridor 104)   | 28 |       |
| 2)    | 29 | Lobby Sign          | 20   | 1     | 2 | 12   | 12   | 1/2" |      |      |      |      | 600  | 600  | 1/2" | 12   | 12  | 2 | 1     | 20   | CP-1                | 30 | (1)   |
| 2)    | 31 | Exterior Sign       | 20   | 1     | 2 | 12   | 12   | 1/2" | 1200 | 958  |      |      |      |      | 1/2" | 12   | 12  | 2 | 1     | 20   | Lighting            | 32 | (4)   |
|       | 33 | Rec(Mezzanine)      | 20   | 1     | 2 | 12   | 12   | 1/2" |      |      | 360  | 0    |      |      |      |      |     |   | 3     | 60   | SPD                 | 34 |       |
| 1)    | 35 | HR-1-7              | 15   | 2     | 2 | 12   | 12   | 1/2" |      |      |      |      | 708  | 0    |      |      |     |   |       |      |                     | 36 |       |
|       | 37 |                     |      |       |   |      |      |      | 708  | 0    |      |      |      |      |      |      |     |   |       |      |                     | 38 |       |
|       | 39 | Spare               | 20   | 1     |   |      |      |      |      |      | 0    | 0    |      |      |      |      |     |   | 1     | 20   | Spare               | 40 |       |
|       | 41 | Spare               | 20   | 1     |   |      |      |      |      |      |      |      | 0    | 0    |      |      |     |   | 1     | 20   | Spare               | 42 |       |

Total Load: 14 kVA 7 kVA 12 kVA

|                    | i otai Louai   |             | .   . =             |                    |        |  |  |  |
|--------------------|----------------|-------------|---------------------|--------------------|--------|--|--|--|
|                    | Total Amps:    | 123 A 59 A  | 106 A               |                    |        |  |  |  |
| oad Classification | Connected Load | Demand Fact | or Estimated Demand | Panel Totals       |        |  |  |  |
| VAC                | 2015 VA        | 100.00%     | 2015 VA             |                    |        |  |  |  |
| ighting            | 5360 VA        | 125.00%     | 6699 VA             | Total Conn. Load:  | 33 kVA |  |  |  |
| Receptacles        | 25760 VA       | 69.41%      | 17880 VA            | Total Est. Demand: | 26 kVA |  |  |  |
|                    |                |             |                     | Total Conn.:       | 92 A   |  |  |  |
|                    |                |             |                     | Total Est. Demand: | 74 A   |  |  |  |
|                    |                |             |                     |                    |        |  |  |  |
|                    |                |             |                     |                    |        |  |  |  |

## Panel Schedule Notes: (Notes below do not necessarily appear in panel schedule)

- VERIFY BREAKER SIZE PER EQUIPMENT MANUFACTURER'S RECOMMENDED NAME PLATE RATING PRIOR TO SHOP DRAWINGS PHASE OF PROJECT. CIRCUIT VIA 4 POLE LIGHTING CONTACTOR. CONTROL WITH (2) CIRCUIT INTERMATIC OR EQUAL ASTRONOMICAL TIME CLOCK WITH BATTERY BACKUP
- AND PHOTOCELL. PHOTOCELL "ON" TIME CLOCK "OFF". PROVIDE GFCI PROTECTED CIRCUIT BREAKER.
- CONDUIT, WIRE, AND BREAKER SIZE PER MANUFACTURER'S REQUIREMENTS. PROVIDE SHUNT TRIP BREAKER TO DE-ENERIGIZE EQUIPMENT SERVING UPON ACTIVATION OF FIRE SUPPRESSION SYSTEM. PROVIDE ALL NECESSARY WIRING.









SBE.

SI

**TOP** 

SPINDL

ISSUED FOR SCHEMATIC DESIGN

DATE:\_\_ DESIGN DEVELOPMENT

DATE:\_\_\_ BIDS & CONSTRUCTION X DATE: 02/28/2022 REVISION: Revision 1


DATE: 03/07/2022 REVISION:

DATE:\_\_\_ REVISION: DATE:\_\_\_\_

> DRAWINGS SHEET TITLE ELECTRICAL SCHEDULES

SHEET NUMBER

21061 PROJECT NUMBER

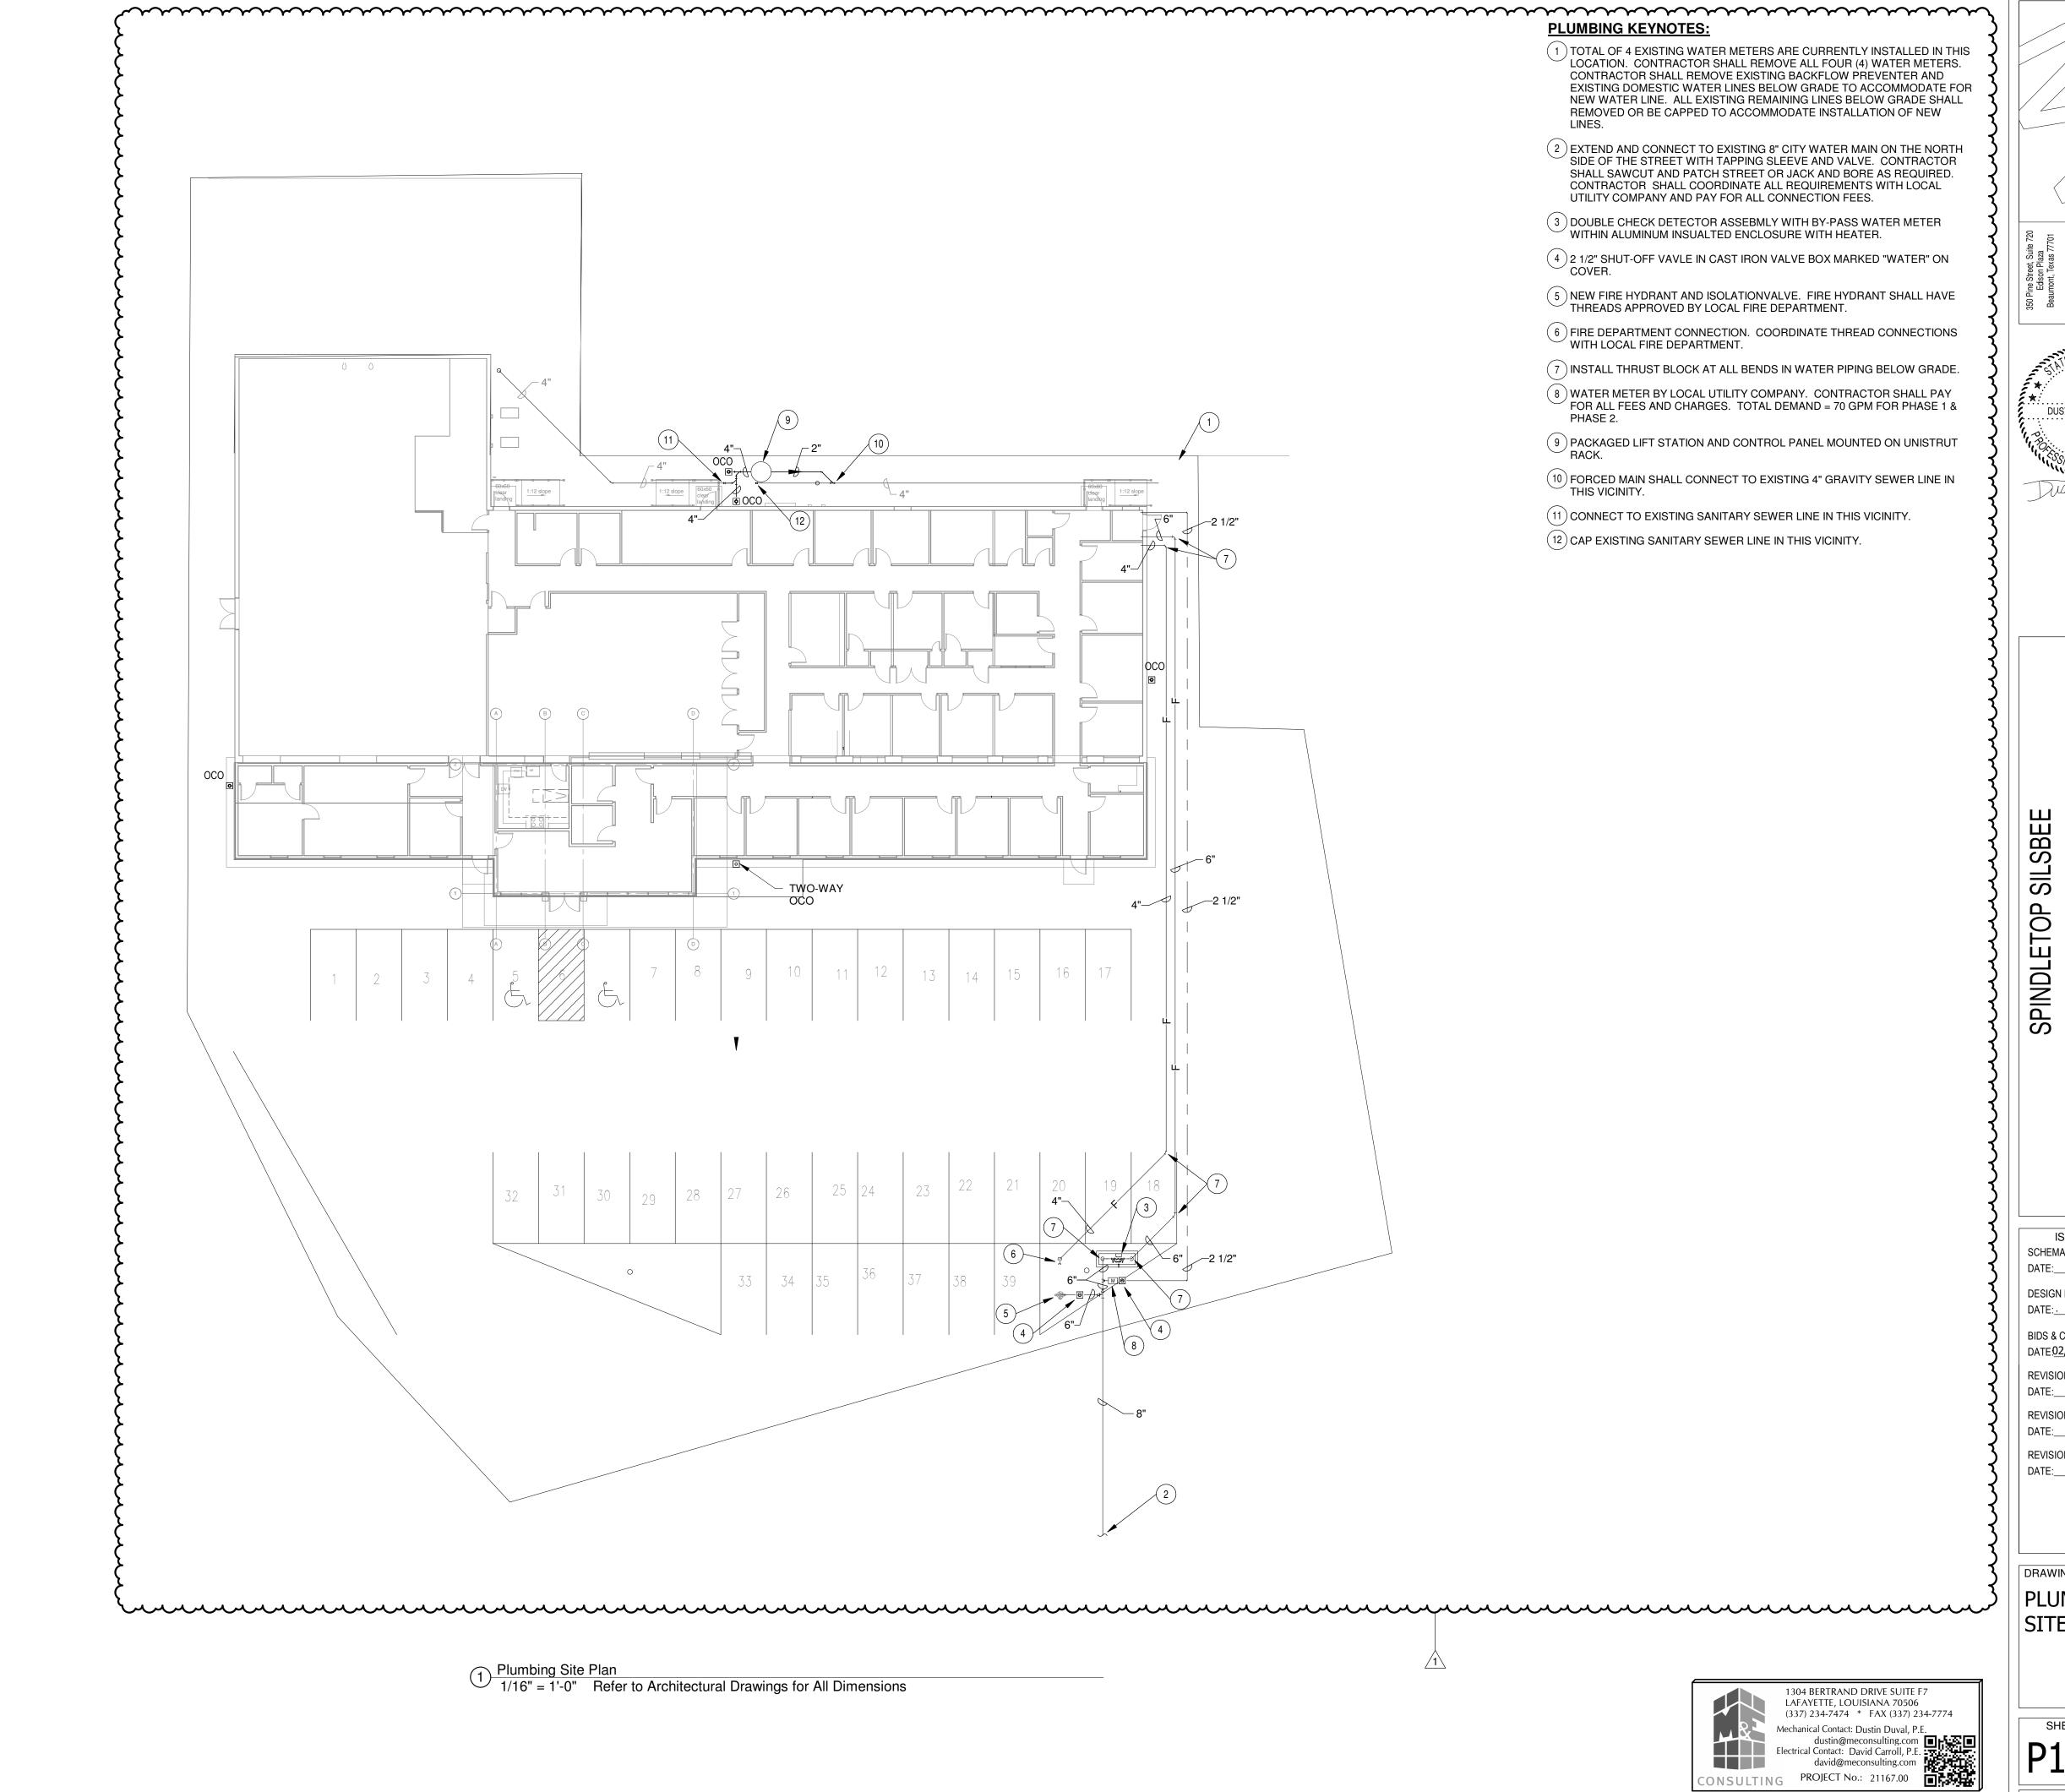

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DUSTIN W. DUVAL 117604

03-07-2022

SCHEMATIC DESIGN

DESIGN DEVELOPMENT

BIDS & CONSTRUCTION X DATE:02/28/2022

REVISION: DATE: 03/07/2022 REVISION:

DATE:\_\_\_ REVISION:

DRAWINGS SHEET TITLE

PLUMBING SITE PLAN

SHEET NUMBER

21061 PROJECT NUMBER

SILSBE

SPINDLETOP

DATE: 03/07/2022 REVISION:

DATE:\_\_\_\_ REVISION: DATE:\_\_\_\_

DRAWINGS SHEET TITLE PLUMBING DEMOLITION PLAN


1304 BERTRAND DRIVE SUITE F7 LAFAYETTE, LOUISIANA 70506 (337) 234-7474 \* FAX (337) 234-7774

Mechanical Contact: Dustin Duval, P.E. dustin@meconsulting.com Electrical Contact: David Carroll, P.E. david@meconsulting.com

PROJECT No.: 21167.00

SHEET NUMBER

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Plumbing Plan - Demolition

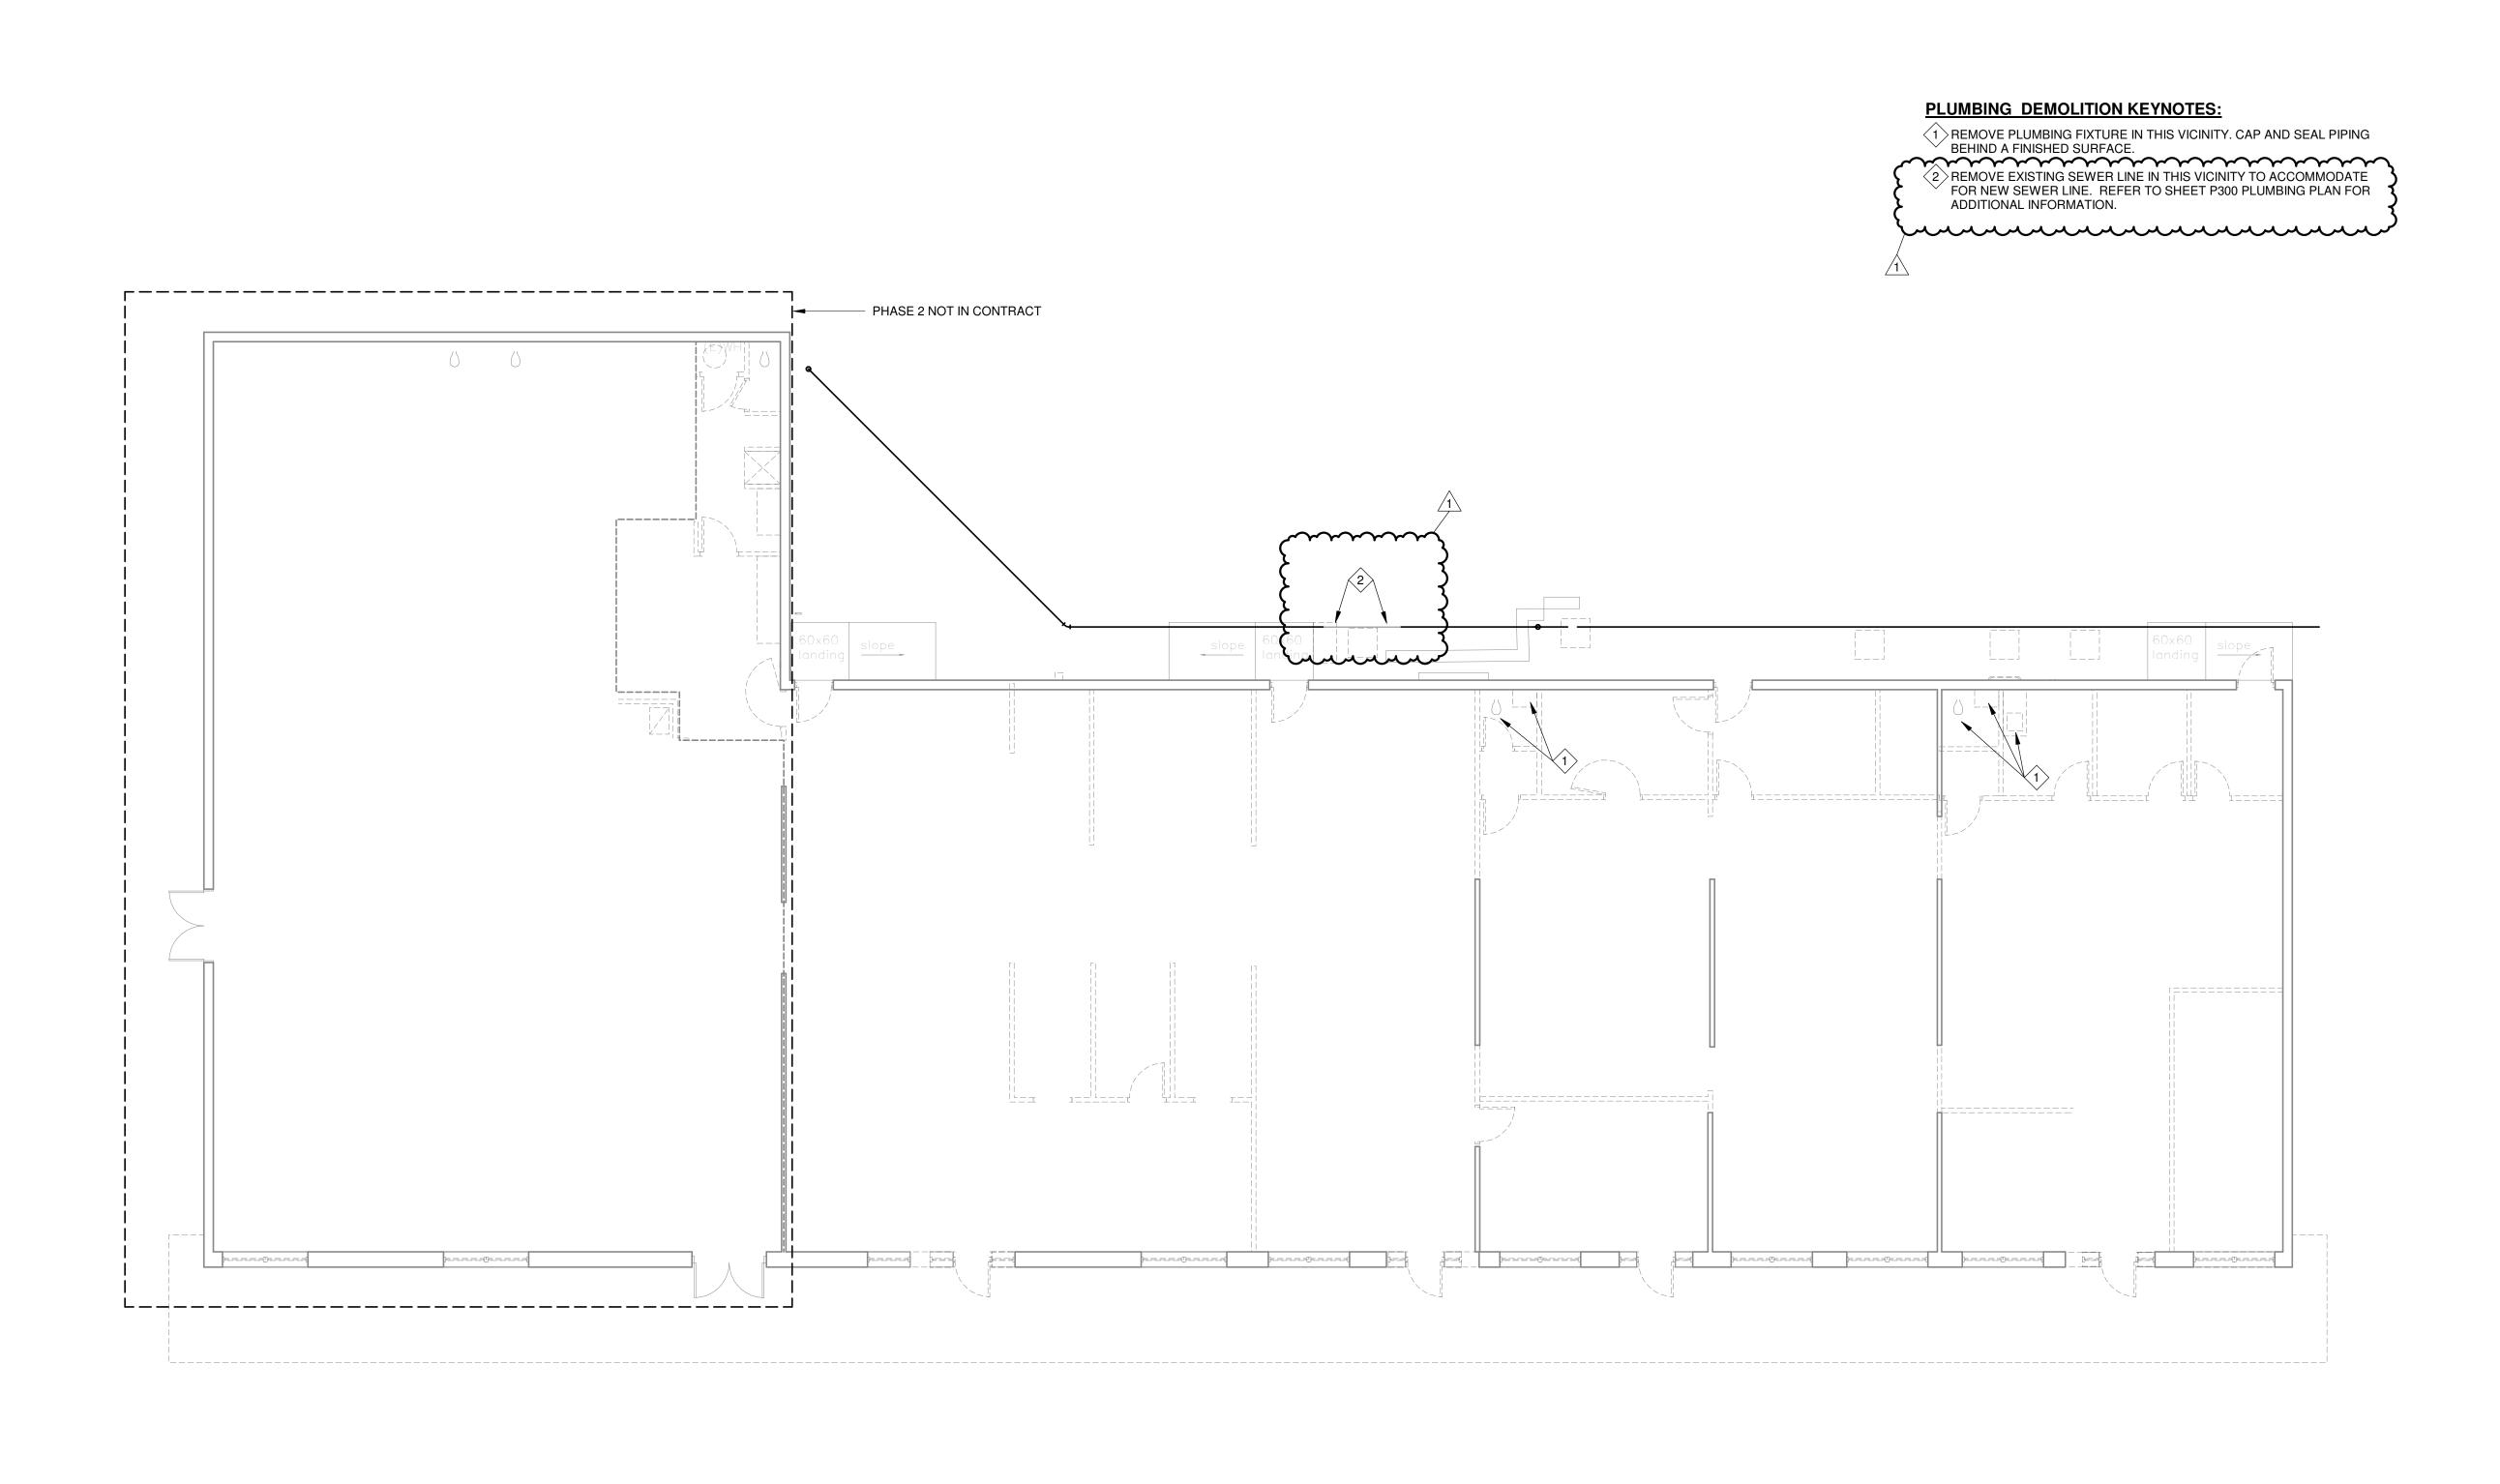1/8" = 1'-0" Refer to Architectural Drawings for All Dimensions

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