

Addendum No. 1

Project: **Dental Clinic** 

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Date: <u>11-04-2019</u>

All bidders are herewith notified of the following additions, deletions, changes or clarifications to the drawings dated 10-28-2019 and shall be acknowledged as received on the proposal.

### **Corrections/Clarifications:**

- 1. Civil C3.01
  - a. See attached civil drawing showing updated spot elevation behind dumpster enclosure. Ref. CSK-1
- 2. Architectural A100:
  - a. Add attic plan showing 3/4" plywood decking to from scuttle to A/C equipment. Ref. SK-1 attached
- 3. Architectural A100
  - a. At Janitor 114, provide (2) full sheets of FRP panels glued over moisture resistant gypsum board, (1) at North wall and (1) at east wall. Provide surface mounted mop and broom holder (Bobrick B-223 x 24") and mount top of rack at 6'-0" above finished floor at North wall.
- 4. Architectural A500
  - a. At Detail 5, replace 6" long brushed standoffs to 2" long standoffs.
- 5. Structural S2:
  - a. Relocate Attic Access Door to location in front of break room. Reference Architectural RCP
  - b. Ceiling Joist Framing Plan shows framing of barrel vault ceiling at Waiting Area-100, Ref. SA01, SA02 and SA03.
- 6. Structural S4:
  - a. Relocate Attic Access Door to location in front of break room. Reference Architectural RCP.
  - b. Modify roof framing members as shown.

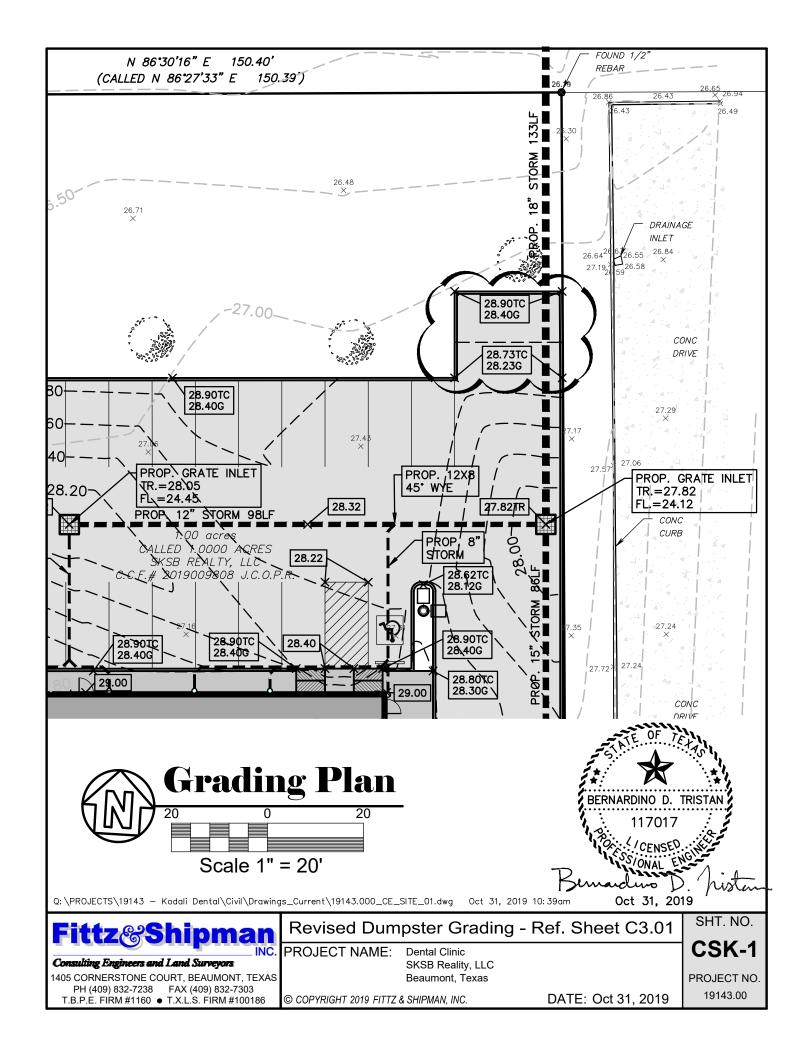
### 7. Mechanical, Electrical, Plumbing

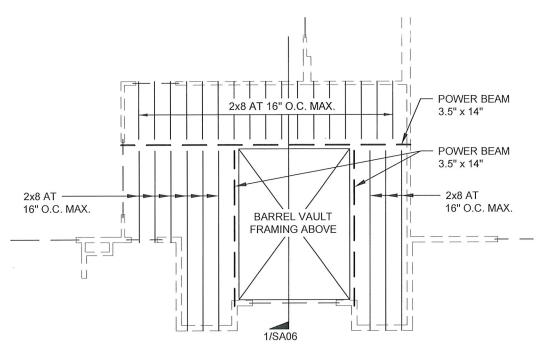
a. Replace issued sheets with attached M.1R, M.2R, E.1R, E.2R, E.3R, P.1R, P.2R, P.3R and P.4R.

### End of Addendum



Date: 11-04-2019

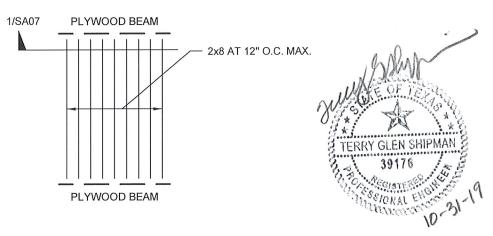






# **CEILING JOIST FRAMING PLAN**

SCALE: N.T.S.





# BARREL VAULT FRAMING PLAN

SCALE: N.T.S.

Q:\PROJECTS\|9|43 - Kodali Dental\Structura|\Drawings\_Current\|9|43\_SE\_ADDENDUM #l.dwg

Oct 31, 2019 02:38pm

# Fittz&Shipman

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### BARREL VAULT FRAMING PLAN

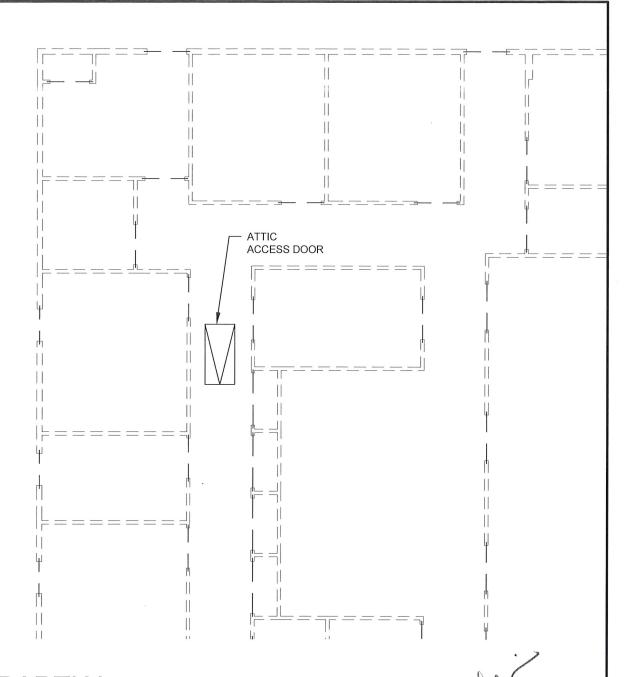
PROJECT NAME: KODALI DENTAL CLINIC

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SHT. NO.

**SA01** 





# PARTIAL CEILING JOIST FRAMING PLAN

SCALE: N.T.S.

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CEILING PL

Consulting Engineers and Land Surveyors

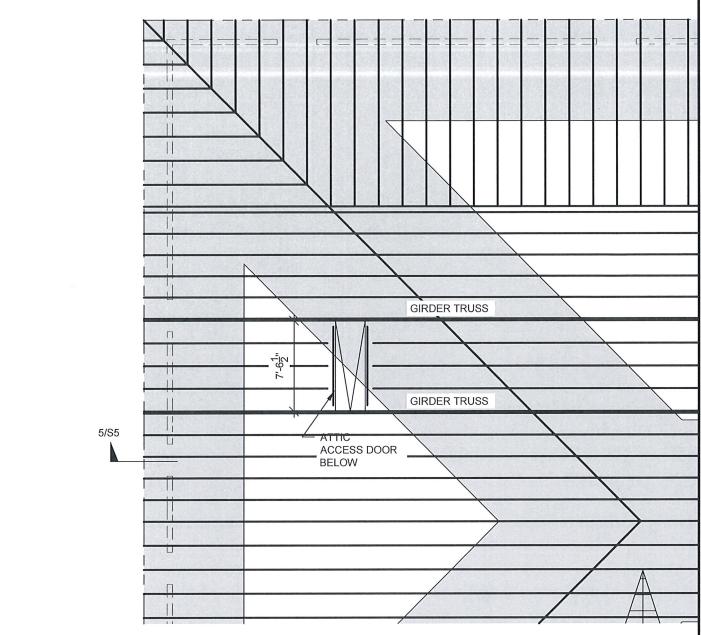
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KODALI DENTAL CLINIC

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DATE: Oct 31, 2019

SHT. NO. **SA02** 





# PARTIAL ROOF FRAMING DIAPHRAGM PLAN

SCALE: N.T.S.



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Oct 31, 2019 01:25pm

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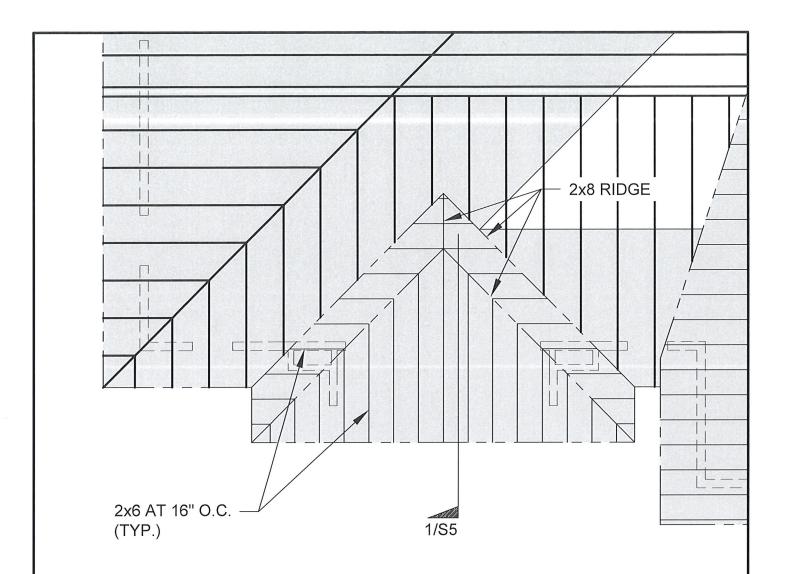
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DATE: Oct 31, 2019

SHT. NO.

**SA03** 





# <u>PARTIAL ROOF</u> FRAMING DIAPHRAGM PLAN

SCALE: N.T.S.



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### PARTIAL ROOF PLAN

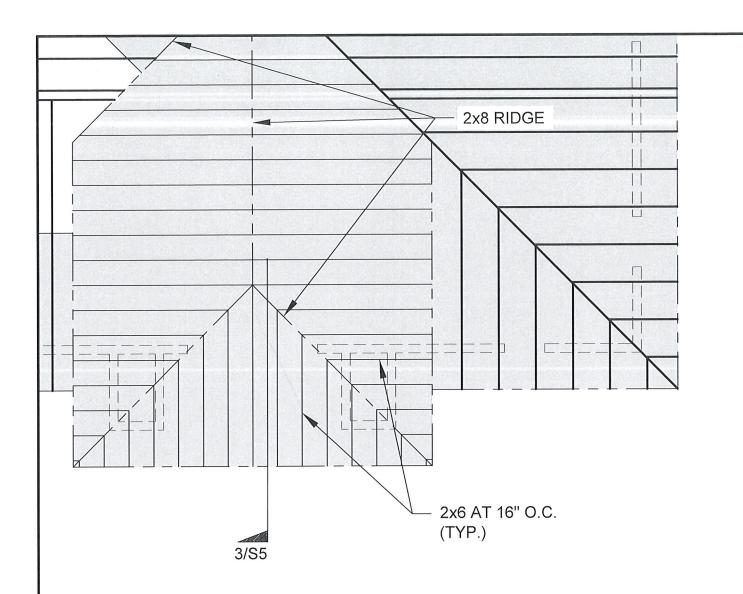
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SHT. NO.

**SA04** 





# PARTIAL ROOF FRAMING DIAPHRAGM PLAN

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### PLAN

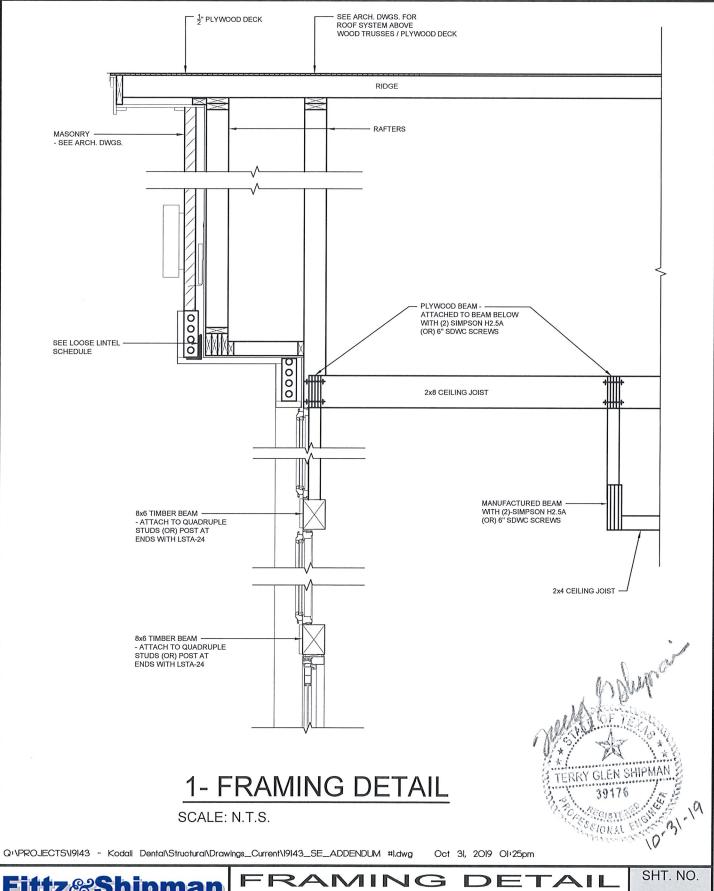
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**SA05** 



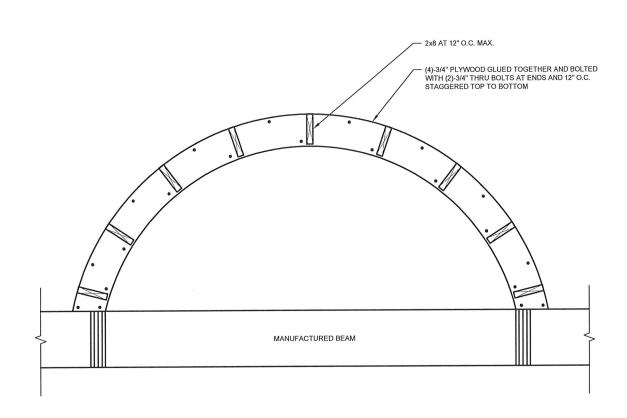
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PROJECT NAME: KODALI DENTAL CLINIC **SA06** 

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# 1- FRAMING DETAIL

SCALE: N.T.S.



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1405 CORNERSTONE COURT, BEAUMONT, TEXAS PH (409) 832-7238 FAX (409) 832-7303 T.B.P.E. FIRM #1160 • T.X.L.S. FIRM #100186 FRAMING DETAIL

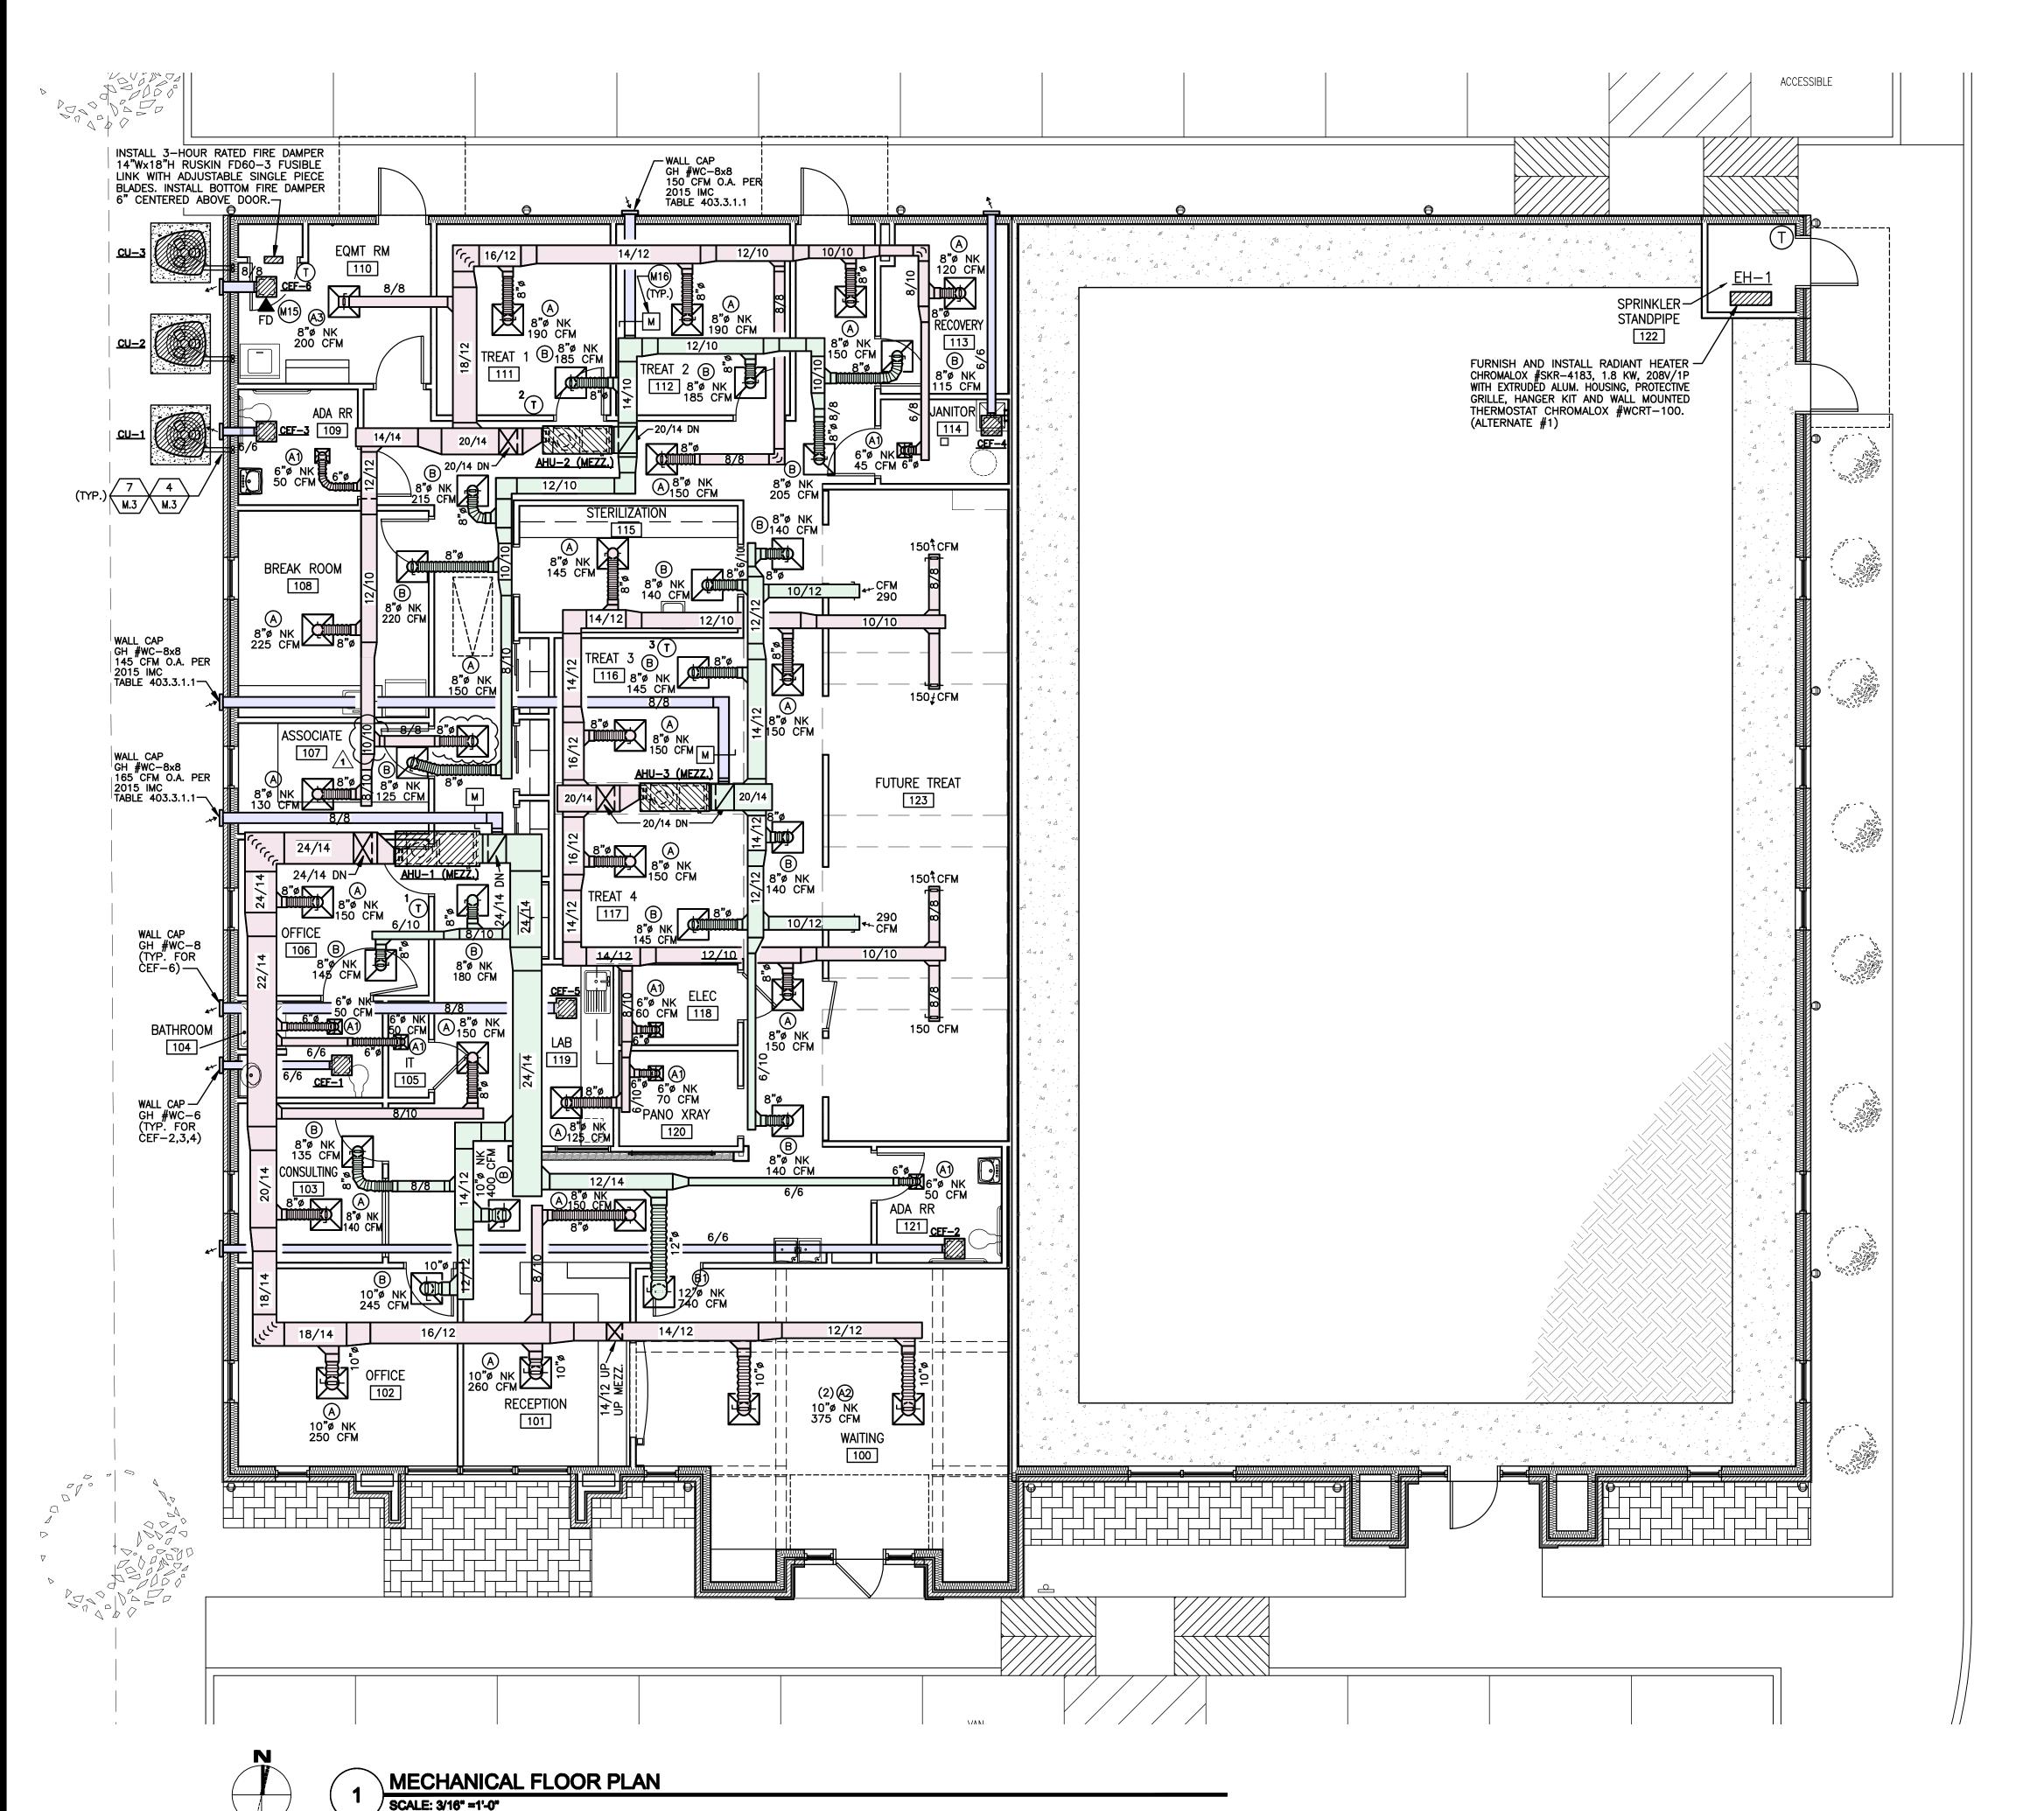
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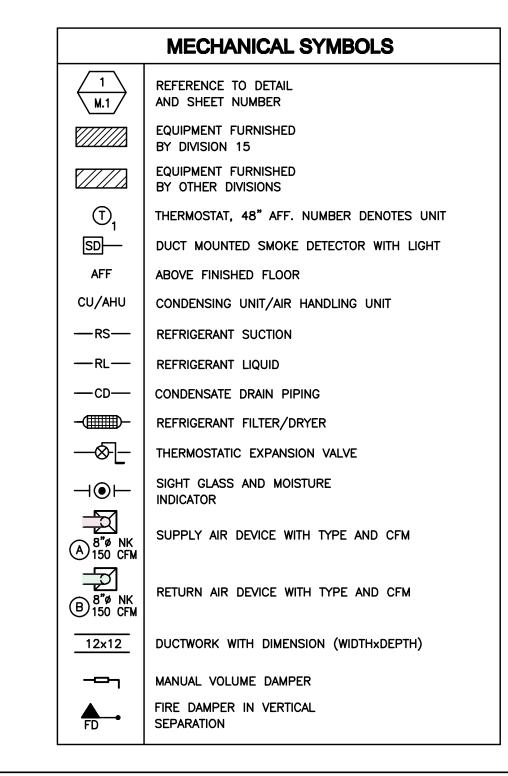
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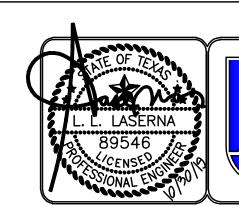
**SA07** 





# **MECHANICAL NOTES**

- THE EXACT MOUNTING HEIGHTS AND/OR LOCATIONS OF ALL HVAC EQUIPMENT SHALL BE FIELD VERIFIED AND COORDINATED WITH ALL OTHER MECHANICAL, ELECTRICAL, ARCHITECTURAL AND STRUCTURAL SYSTEMS.
- THE FINAL LOCATION OF AIR DEVICES MUST BE COORDINATED WITH THE LOCATION OF LIGHT FIXTURES, CEILING FANS, ARCHITECTURAL AND STRUCTURAL SYSTEMS.
- ALL ACCESS DOORS REQUIRED IN GENERAL CONSTRUCTION ARE TO BE PROVIDED AND INSTALLED BY THE GENERAL CONTRACTOR. IT IS THE RESPONSIBILITY OF THE HVAC CONTRACTOR TO IDENTIFY SIZE, TYPE AND LOCATION OF SUCH DOORS FOR PROPER ACCESS TO ALL CONCEALED HVAC EQUIPMENT, VALVES AND OTHER RELATED EQUIPMENT. THE HVAC CONTRACTOR SHALL IDENTIFY THESE REQUIREMENTS ON A COORDINATED SHOP DRAWING PRIOR TO SYSTEM FABRICATION AND INSTALLATION.
- THE EXACT SIZES AND LOCATIONS OF ALL WALL AND/OR ROOF OPENINGS REQUIRED MUST BE COORDINATED AND APPROVED BY GENERAL CONTRACTOR AND OWNER. STRUCTURAL frames around all openings shall be furnished and installed as required.
- PROVIDE SLEEVES AND FLASHING REQUIRED FOR PIPING AND DUCTWORK PENETRATIONS. PROVIDE ESCUTCHEON PLATES FOR ALL PIPING PENETRATING FINISHED WALLS AND
- VERIFY ALL EQUIPMENT VOLTAGES WITH THE ELECTRICAL CONTRACTOR PRIOR TO ORDERING ALL HVAC EQUIPMENT. ELECTRICAL CONTRACTOR WILL BE RESPONSIBLE FOR PROVIDING AND INSTALLING ALL POWER AND CONTROL CONDUIT FOR HVAC EQUIPMENT AS REQUIRED. HVAC CONTROLS CONTRACTOR WILL INSTALL CONTROL VOLTAGE WIRING IF REQUIRED. HVAC CONTRACTOR SHALL COORDINATE ALL REQUIREMENTS WITH ALL TRADES.
- ONLY THE MANUFACTURERS LISTED ON CONTRACT DRAWINGS OR SPECIFICATIONS ARE APPROVED FOR BIDDING UNLESS INSTRUCTED OTHERWISE BY OWNER. ALL OTHER MANUFACTURERS WILL BE CONSIDERED AS SUBSTITUTIONS AND MUST HAVE PRIOR APPROVAL IN WRITING SUBMITTED TO THE OWNER AS SOON AS POSSIBLE BEFORE
- FOR ALL CEILING SUPPLY AIR DIFFUSERS. PROVIDE A 2" THICK R-8 FOIL FACED INSULATION BLANKET COMPLETELY COVERING TOP OF DIFFUSERS. ALL INSULATION MATERIALS USED THROUGHOUT THE AIR DISTRIBUTION SYSTEMS SHALL BE FACTORY STAMPED WITH RELATED R VALUE OR PER LOCAL CODES.
- MAINTAIN MANUFACTURER'S RECOMMENDED CLEARANCE AROUND HVAC EQUIPMENT. ALL DUCT SIZES NOTED ARE INSIDE CLEAR DIMENSIONS.
- ALL INTERIOR SUPPORTS, CLAMPS AND RELATED ITEMS SHALL BE SHOP PRIMED UNLESS GALVANIZED CONSTRUCTION. ALL EXTERIOR SUPPORTS, CLAMPS AND RELATED ITEMS SHALL BE OF GALVANIZED CONSTRUCTION. COAT ANY FIELD WELDS, CUTS OR DAMAGED WITH GALVANIZED COATING WITH TWO COATS ZINC RICH CHROMATE
- FLEXIBLE DUCT DIAMETER SHALL MATCH THE NECK SIZE OF THE DIFFUSER TO WHICH IT CONNECTS, UNLESS NOTED OTHERWISE. THE TOTAL LENGTH OF FLEXIBLE DUCT RUN SHALL NOT EXCEED 6 FT.. EXTEND HARD DUCT WITHIN 6 FT. OF THE AIR DEVICE FOR COMPLIANCE. FLEXIBLE DUCTWORK IS NOT PERMITTED FOR USE IN ANY PARTS OF THE RETURN OR EXHAUST AIR SYSTEMS. FLEXIBLE DUCTWORK MUST BE INSTALLED WITH SUPERIOR WORKMANSHIP MAINTAINING FULL CROSS SECTIONAL AREA THROUGHOUT. SUPPORT FROM STRUCTURE AT 24" INTERVALS WITH THREADED RODS AND UNISTRUTS TO ENSURE FULL CROSS SECTIONAL AREA FOR MAXIMUM AIR FLOW.
- PROVIDE PROGRAMMABLE THERMOSTAT AT 48" AFF AT LOCATION AS SHOWN ON PLANS. VERIFY THE EXACT LOCATION AND REQUIREMENTS WITH OWNER AND/OR ARCHITECT. INSTALL WALL BOX AND CONDUIT SYSTEM REQUIRED FOR WALL MOUNTED THERMOSTAT. COORDINATE THE REQUIREMENTS WITH ELECTRICAL CONTRACTOR.
- ADJUST AND BALANCE THE OUTSIDE AIR REQUIREMENTS PER MECHANICAL SYSTEMS TESTING AND BALANCING.
- PROVIDE 1 1/4" INSULATED CONDENSATE DRAIN LINE FROM AHUS TO CONDENSATE RECEIVER. PLUMBING CONTRACTOR TO INSTALL AND RUN DRAIN PIPING TO NEAREST APPROVED DRAIN SYSTEM. COORDINATE WITH PLUMBING CONTRACTOR EXACT
- PROVIDE AND INSTALL CEF-6 WITH CEILING RADIATION DAMPER FOR FIRE RESISTANCE AT FIRE RATED CEILING. REFER TO ARCHITECTURAL PLANS FOR EXACT LOCATION AND FIRE RATING REQUIREMENTS. PROVIDE UL CLASSIFIED CEILING RADIATION DAMPER TO MEET UL555 STANDARDS.
- INSTALL LOW VOLTAGE MOTORIZED VOLUME DAMPER REQUIRED. INTERLOCK WITH AHU. OPENS WHEN FAN IS ON AND CLOSES WHEN FAN IS OFF.





**MEPTech** Engineering, Inc. TBPE FIRM # F-10227 5090 ADA AVENUE BEAUMONT, TEXAS 77708-4411

PHONE: (409) 673-2013 FAX: (409) 767-9224

1936 PROJECT NUMBER

SHEET NUMBER

DRAWINGS SHEET TITLE

**MECHANICAL** 

**FLOOR PLAN** 

ARCHITECT HAS REVIEWED THE CONSULTANT'S WORK

AND COORDINATED IT WITH

THE OVERALL PROJECT

CLINIC

ISSUED FOR

DESIGN DEVELOPMENT [2]

BIDS & CONSTRUCTION X

SCHEMATIC DESIGN

DATE: 6/19/2019

DATE: 8/1/2019

DATE: 10/28/2019

DATE: 11-04-2019

REVISION: 1

REVISION:

REVISION: DATE:\_\_

NOTES: 1.) TWO-STAGE (CU-1,2,3,4,5), HIGH EFFICIENCY COMPRESSOR WITH CRANKCASE HEATER.

2.) HEAVY-GAUGE STEEL CONSTRUCTION, PRE-PAINTED CABINET FINISH AND BASE SECTION AND HDP UNIT SUPPORT FEET.

3.) 15 SEER (CU-1) 15.7 SEER (CU-2,3) RATING.

4.) FIVE (5) YEARS LIMITED WARRANTY FOR COMPRESSOR & ALL COVERED COMPONENTS.

5.) APPROVED EQUAL: TRANE.

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						E۱	VAPORATOR	COIL							BLOWER						ELE	CTRIC HEAT	ATING COIL		REF	RIGERAN	Т	CONDENSATE DRAIN		SYSTEM ELE	.ECTRICAL	POWER	SUPPL'	Y	
MARK	DISCHARGE FLOW	CFM	COOLING	CAPACITY		NTERING P. (°F)		EAVING P. (°F)	NET FACE AREA	E TUBE	NO. OF	- FDI	DRIVE S	PEED	MOTOR FLA	ES	SP E	LECTRICAL SUPPLY	L	NO. C	OF NO. O	F N	MODEL	ELECTRICAL SUPPLY	TYPF	PIPE	E SIZE (IN.	CONNECTION/SIZE	POWER S CONTRO		VOLT	DUASE		MOV MOV	REMARKS
			TOTAL	SENSIBLE	db	wb	db	wb	(SF)	(IN.)	ROWS	FPI	TYPE SI	- EED	HP PLA	`   "H	VOL	T PHASE	Hz	STAGE	ES CIRCUI	rs N	NUMBER	_T PHASE H	''' =	GAS	LIQUID	(IN.)	CONNECTION	MODEL NO.		PHASE	пи	MCA MOC	
AHU-1	HORIZONTAL	2150	68.0	50.0	86.8	69.5	54.9	54.2	7.77	3/8	3	12	DIRECT VAF	RIABLE	1 7.4	0.	.50 208	3 1	60 11.3	5 1	1	ECB40-	-15CB (35W00) 20	8 3 6	R-410A	1 1/8	3/8	(2) 3/4	SINGLE-POINT	21H39	208	3	60	48 50	LENNOX CBX32MV-068-208-6-01
AHU-2,3	HORIZONTAL	1600	48.0	39.5	86.8	69.5	54.9	54.2	7.22	3/8	3	12	DIRECT VAF	RIABLE	1 7.4	0.	.50 208	1	60 7.5	1	1	ECB40-	0-10 (34W99) 20	8 3 6	R-410A	7/8	3/8	(2) 3/4	SINGLE-POINT	21H39	208	3	60	35 40	LENNOX CBX32MV-048-208-6-01
N/	TFS: 4 \ ALIII	1 0 7 WITH.																																	

a.) HEALTHY CLIMATE FILTER CABINET AND UV GERMICIDAL LAMP MODEL NO. PCO20-28.

AHU-1: FILTER SIZE - 20"x25"x1", 50A/3P CB AND COVER KIT MODEL NO. 93M85.  $\triangle$  AHU-2,3:) FILTER SIZE - 20"x24"x1", 40A/3P CB AND COVER KIT MODEL NO. 93M85.

MARK

b.) SINGLE-POINT POWER SOURCE CONTROL BOX (FAN, HEATER AND UV LAMP) WITH CB DISCONNECT SAFETY SWITCH AND COVER KIT MODEL NO. 21H39/93M85,

c.) DEEP, CORROSION RESISTANT PLASTIC DRAIN PANS HAVE DUAL PIPE DRAINS.

d.) TOUCHSCREEN THERMOSTAT.

e.) APPROVED EQUAL: TRANE.

			EXHA	UST FA	N SC	CHE	DUL	E		
MARK	CFM	STATIC PRESSURE	DRIVE	FAN	МОТ	ΓOR	ELECTF	RICAL S	SUPPLY	REMARKS
MARK	CFM	"H <sub>2</sub> 0"	DRIVE	RPM	AMPS	WATTS	VOLT	Ø	Hz	REMARKS
CEF-1,2,3,4	85	0.125	DIRECT	850	0.27	20.2	115	1	60	GREENNECK SP-A90
CEF-5	160	0.25	DIRECT	1400	1.30	113	115	1	60	GREENNECK SP-A190
CEF-6	250	0.25	DIRECT	1050	0.72	81	115	1	60	GREENNECK SP-A290-CRD

1. PROVIDE BACKDROP DAMPER FOR EACH FAN.

2. PROVIDE SAFETY DISCONNECT SWITCH FOR EACH FAN.

3. PROVIDE ALUMINUM GRILLE IN WHITE ENAMEL FINISH. 4. CEF-1, 2, 3, 4 & 5 CONTROLLED BY LIGHT SWITCH.

5. CEF-6 CONTROLLED BY WALL THERMOSTAT AND WITH CEILING RADIATION DAMPER.

		AIR DIS	STRIBUTIO	N DEVIC	E SCHEDUL	.E	
MARK	FUNCTION	MAKE AND MODEL NO.	FACE SIZE (INCH)	OPENING SIZE (INCH)	MOUNTING STYLE BORDER	MATERIAL OF CONSTRUCTION	REMARKS
A	SUPPLY AIR DIFFUSER	TITUS OMNI-AA	24×24	22×22	GRID/LAY-IN	ALUMINUM	NOTES: 1, 2, 3, 4
(A1)	SUPPLY AIR DIFFUSER	TITUS OMNI-AA	12x12	10x10	GRID/LAY-IN	ALUMINUM	NOTES: 1, 2, 3, 4
<b>A2</b>	SUPPLY AIR DIFFUSER	TITUS OMNI-AA	24x24	22×22	SURFACE	ALUMINUM	NOTES: 1, 2, 3, 4
(A3)	SUPPLY AIR DIFFUSER	TITUS TDCA-FR	16x16	14x14	SURFACE	STEEL	NOTES: 1, 2, 3, 4, 5
В	RETURN AIR GRILLE	TITUS 45F	24x24	22×22	GRID/LAY-IN	ALUMINUM	NOTES: 1, 2, 3, 4, 6

REFER TO MECHANICAL FLOOR PLAN FOR NECK SIZES.

2. 4-WAY THROW UNLESS OTHERWISE NOTED.

3. WITH ALUMINUM VOLUME CONTROL DAMPER. 4. STANDARD FINISH #26 WHITE. CONFIRM COLOR WITH OWNER.

5. 1-HOUR RATED SUPPLY AIR REGISTER WITH DAMPER.

6. 1/2" x 1/2" x 1" EGGCRATE RETURN GRILLES

# MECHANICAL SPECIFICATIONS

## 1. CONTRACTOR QUALIFICATIONS

a. Be a specialist in this field and provide trained, experienced and skilled personnel to construct a practical working system.

b. Coordinate with other divisions of work to provide a complete and functioning system. c. All materials and equipment shall be new and of best grade and quality,

provided by reputable manufacturers. d. The mechanical drawings are diagrammatic in nature, but should be

followed as closely as possible. e. Any changes required due to poor workmanship or coordination shall be made without additional expense to the owner.

Install all equipment, materials and required supports in a neat, workman-like manner in accordance with the manufacturers printed instructions. The design is based on the equipment scheduled. The contractor shall

bear all costs of variations in electrical, mechanical, structural requirementds if the contractor chooses to utilize any other approved equipment manufacturer.

2. CORRECTIONS AND MAINTENANCE DURING THE WARRANTY PERIOD

a. The guarantee and warranty period is for 12 months after substantial completion of the project.

Corrections to failures or defects during this period shall be at no cost to

c. Response time shall be no longer than the day after notification.

## 3. SHOP DRAWINGS AND SUBMITTALS

a. Provide submittals of all equipment and materials utilized for this project for review by owner/architect/engineer.

## 4. CONDENSATE DRAIN PIPING SYSTEMS

a. Type L copper tubing with drainage pattern fittings, soldered joints and a water seal trap.

b. Insulate same as specified for refrigerant suction piping.

c. Provide condensate drain piping from each cooling coil drain connection sized equal to the unit drain connection and auxiliary drain.

## 5. DUCTWORK SYSTEMS

a. Coordinate the duct installation with Architectural and Structural elements of the project.

b. Construct and install systems in accordance with SMACNA and other referenced standards.

Provide turning vanes in all square elbows.

Seal all joints and seams with fireproof, non-hardening, non-migrating mastic. Leakage in excess of 5% of total airflow is not acceptacle. All mastics and adhesives utilized shall meet flame spread of 25 and developped smoke of 50 per ASTM E-84, NFPA 255 and U.L. 723.

e. Provide all unit duct connections with flexible duct connectors.

Provide the following duct systems:

1.) Outside air/Exhaust air duct — Galvanized sheet metal with 2" thick, 3/4 lb. external insulation or per local code. 2.) All supply and return air ductwork shall be fiberglass ductwork shall have 1 1/2" thick aluminum cased certainteed #475R4 "TOUGHGARD" or approved with as thermosetting acrylic polymer coating with immobilized EPA approved

anti-microbial agent fiberglass ductwork. Foil tape to be U.L. 181/181A listed. All flexible ductwork to supply air diffusers to be insulated with minimum R-6 external insulation. All starting collars, spin-ins for flexible ductwork shall be sealed with mastic, both under and on top of the collar with no metal surfaces of the starting collar exposed. Insulation on the flexible ductwork to be sealed to the main trunk and shall not be crushed at the main trunk to be U.L. 181/181A listed or local codes.

g. Seal airtight all ductwork penetrating non-rated wall assemblies.

a. The wall mounted thermostat (specified to be provided with the HVAC equipment) shall cycle the stages of direct expansion cooling and the electric heating cycle as required to maintain the space set point temperature ( $\pm$  74° F.) when place in the "AUTO" mode. Seven (7) day Programmable Thermostat.

7. MECHANICAL SYSTEMS TESTING AND BALANCING

a. Provide a trained, experienced technician to test, adjust and balance the air distribution and exhaust systems.

1.) Adjust the outside and return air to the design conditions.

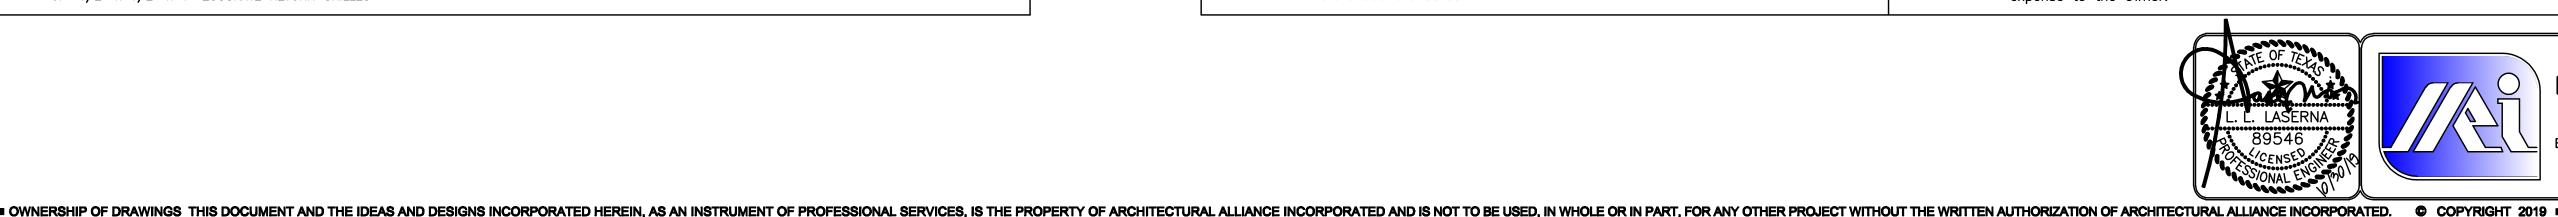
2.) Adjust fan rpm required to obtain design air quantities. 3.) Measure and adjust all duct systems and air outlets to design air

8. DELIVERY, STORAGE AND HANDLING a. Protect all equipment and materials to be installed from weather

and damage. 9. CODES, PERMITS AND FEES

a. Installation of mechanical systems in their entirety shall comply with the 2015 International Building Code and Mechanical Code, and comply with the most recent versions of all applicable laws, rules, regulations and ordinances of all governing codes and authorities. Obtain

all required permits and pay all fees required by these authorities. b. Modifications required by above Authorities shall be made without additional expense to the owner.





**MEPTech** Engineering, Inc. TBPE FIRM # F-10227 5090 ADA AVENUE BEAUMONT, TEXAS 77708-4411 PHONE: (409) 673-2013 FAX: (409) 767-9224

ARCHITECT HAS REVIEWED THE CONSULTANT'S WORK AND COORDINATED IT WITH THE OVERALL PROJECT

CLINIC 出

ISSUED FOR SCHEMATIC DESIGN

DATE: 6/19/2019 DESIGN DEVELOPMENT X DATE: 8/1/2019

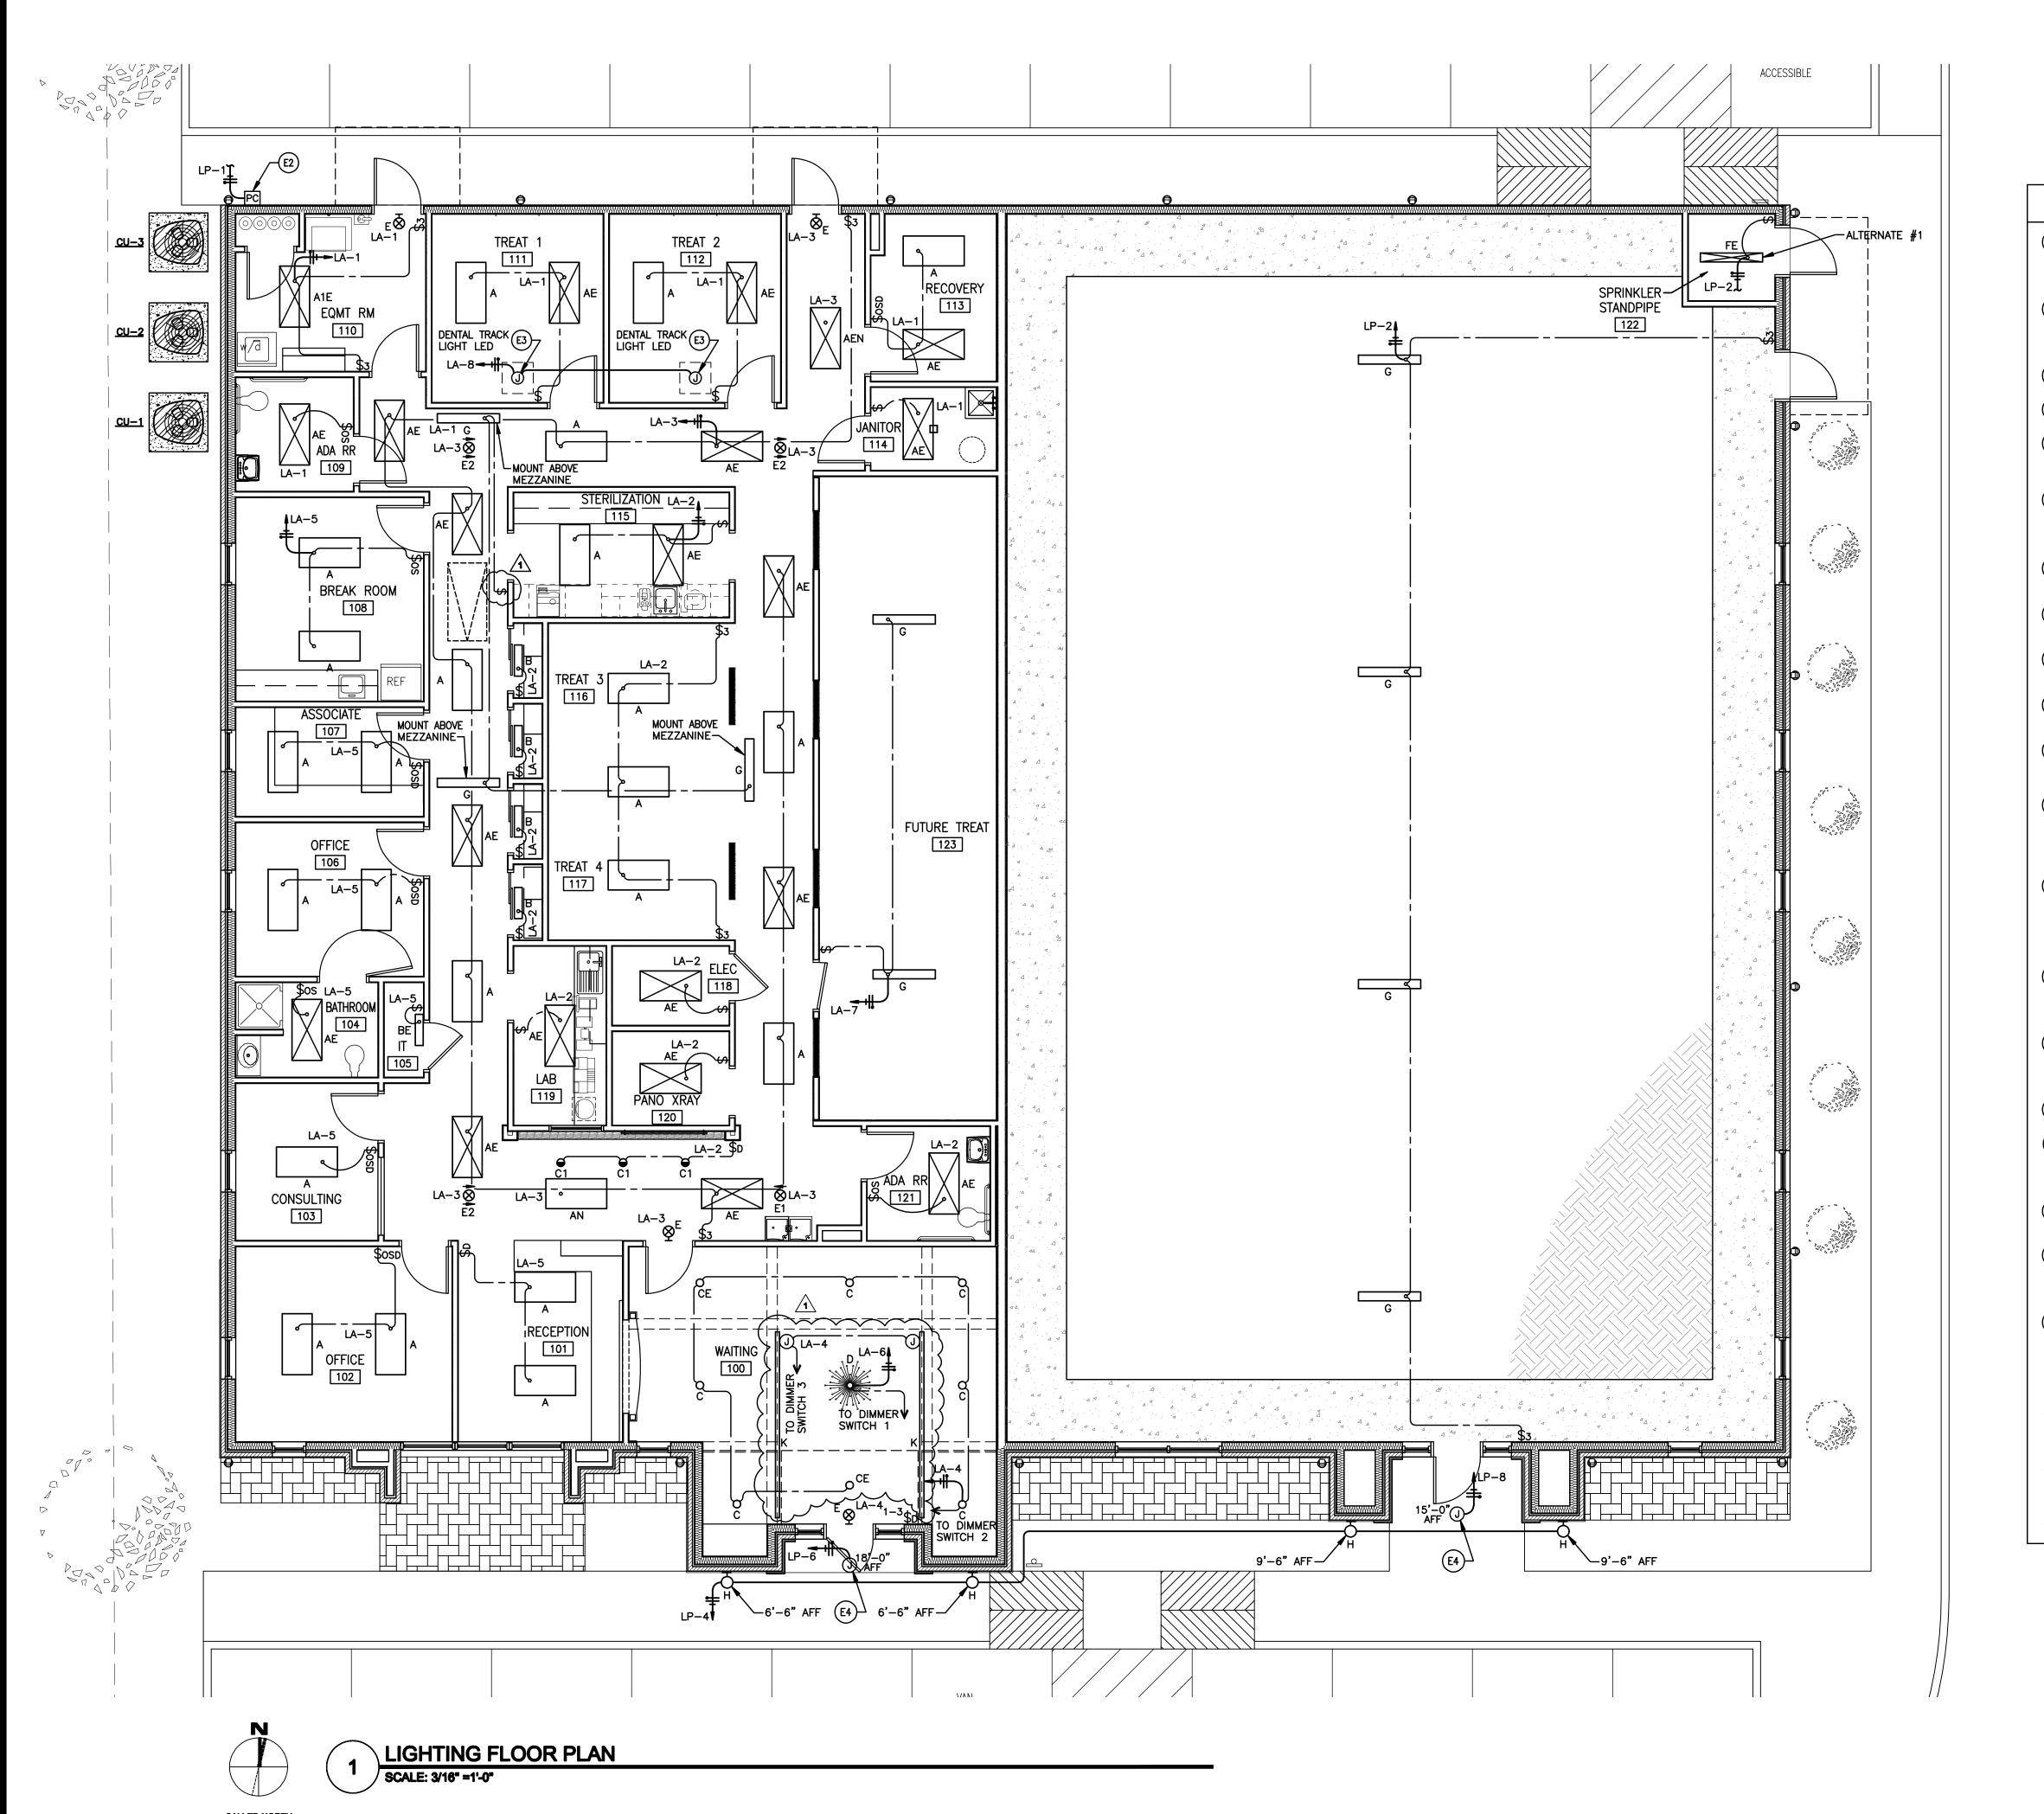
BIDS & CONSTRUCTION X DATE: 10/28/2019 REVISION: 1

DATE: 11-04-2019 **REVISION:** DATE:\_

**REVISION:** DATE:\_\_

> DRAWINGS SHEET TITLE **MECHANICAL SCHEDULES & SPECIFICATIONS**

SHEET NUMBER



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### **ELECTRICAL NOTES**

- COORDINATE EXACT LOCATION OF ALL LIGHT FIXTURES WITH ACTUAL CEILING GRID SYSTEMS AND STRUCTURES. REFERENCE ARCHITECTURAL REFLECTED CEILING PLAN, WALLS, ROOF/CEILING STRUCTURES, SECTIONS & ELEVATIONS. IN EXPOSED CEILING STRUCTURES, CONFIRM WITH ENGINEER AND ARCHITECT EXACT CONDUIT ROUTING PRIOR TO MAKE INSTALLATION AND MUST BE CONCEALED AS MUCH AS POSSIBLE.
- INSTALL INTERMATIC PHOTO ELECTRIC CONTROL SERIES K4521 WITH COMPLETE OF ACCESSORIES AND ADJUSTABLE STEM TO CONTROL LP-3 TO LP-10 THROUGH 10 POLES, 30 AMP, 120V, NEMA 1, MECHANICALLY HELD LIGHTING CONTACTOR "LC1" WITH CONTROL RELAY. LOCATE PHOTO ELECTRIC CONTROL AT 8'-0" AFF OR AS REQUIRED TO FACE FACE NORTH. CONNECT PHOTO ELECTRIC CONTROL AND LIGHTING CONTACTOR TO LA-4.
- MOUNT LIGHT FIXTURE TYPE "G" UNDER ROOF STRUCTURE ABOVE MEZZANINE FOR ATTIC LIGHT. FIELD COORDINATE FINAL LOCATION PRIOR TO MAKE FINAL INSTALLATION.
- INSTALL JUNCTION BOX WITH CIRCUIT AS INDICATED FOR BUILDING SIGN FURNISHED AND INSTALLED BY OTHERS. FIELD COORDINATE WITH OWNER EXACT REQUIREMENTS.
- INSTALL WALL BOX AT 48" AFF FOR INTRA ORAL X-RRAY REMOTE SWITCH AT LOCATION AS SHOWN. INSTALL CONDUIT SYSTEM AND WIRES FROM X-RAY DOWN WALL UP TO CENTRAL CABINET WHEREIN THE X-RAY LOCATED. CONFIRM EXACT TERNIMATION AND REQUIREMENTS WITH PATTERSON DENTAL.
- INSTALL WALL BOX AT 48" AFF FOR MASTER CONTROL PANEL AT LOCATION AS SHOWN. INSTALL CONDUIT SYSTEM WITH 3#18 WIRES EACH RUNS FROM MASTER CONTROL PANEL TO VACUUM PUMP, COMPRESSOR AND WATER SHUT-OFF/SOLENOID VALVES LOCATED IN MECH. 116. FIELD COORDINATE EXACT TERMINATION AND REQUIREMENTS WITH PATTERSON DENTAL EQUIPMENT INSTALLER.
- INSTALL DEDICATED SINGLE RECEPTACLE AS INDICATED FOR DENTAL XRAY POWER. FIELD CONFIRM EXACT REQUIREMENTS WITH EQUIPMENT INSTALLER PRIOR TO MAKE FINAL
- INSTALL POWER CIRCUIT AS INDICATED AND CONDUIT SYSTEM FOR FUTURE DENTAL EQUIPMENT. EQUIPMENT. REFER TO PATTERSON DENTAL DRAWINGS FOR EXACT TERMINATION, STUB-
- INSTALL POWER CIRCUIT AS INDICATED FOR STERILIZATION CABINET. REFER TO PATTERSON DRAWINGS EXACT REQUIREMENTS. CONFIRM EXACT REQUIREMENTS PRIOR TO SUBMIT
- E10 INSTALL SINGLE GANG DEEP WALL BOX WITH APPROPRIATE COVER PLATE FOR DATA AND/OR VOICE OUTLETS. PROVIDE (1)-1" EMPTY CONDUIT WITH PULL STRING FROM SINGLE GANG DEEP WALL BOX UP WALL TO 6" ABOVE ACCESSIBLE CEILING WITH BUSHING.
- INSTALL SINGLE GANG DEEP WALL BOX WITH APPROPRIATE COVER PLATE FOR TV CABLE OUTLET. PROVIDE (1)—1" EMPTY CONDUIT WITH PULL STRING FROM SINGLE GANG DEEP WALL BOX UP WALL TO 6" ABOVE ACCESSIBLE CEILING WITH BUSHING IN ELEC.
- (E12) INSTALL WALL AND/OR BACK BOX WITH 3/4" EMPTY CONDUIT WITH PULL STRING UP WALL TO 6" ABOVE ACCESSIBLE CEILING WITH BUSHING FOR FIRE ALARM AND/OR SECURITY DEVICES. CONFIRM ALL REQUIREMENTS WITH FIRE ALARM AND SECURITY SYSTEMS INSTALLER. ALL LOCATIONS AND REQUIREMENTS OF SECURITY SYSTEM MUST BE CONFIRMED AND COORDINATED WITH SECURITY SYSTEM INSTALLER. FIRE ALARM AND SECURITY SYSTEMS INSTALLER TO PROVIDE SEPERATE DRAWINGS PER NFPA 72 AND 101.
- E13) INSTALL 4'x8'x3/4" GRADE PLYWOOD ON WALL AS SHOWN FOR DATA, VIDEO & TELEPHONE BOARD. PAINT TO MATCH WALL COLOR. PROVIDE GROUNDING WITH #6 GROUND CONDUCTOR AND TO CONNECT TO ELECTRICAL SERVICE GROUND ROD. INSTALL (2)-3" EMPTY CONDUIT WITH PULL STRINGS FROM 6" STUB UP BELOW TELEPHONE BOARD DOWN UNDEGROUND UP TO 12" STUB UP ABOVE FINISHED GRADE 6" AWAY FROM ENTERGY POWER POLE. FIELD COORDINATE EXACT CONDUIT TERMINATION WITH TELEPHONE AND/OR CABLE COMPANY PRIOR TO MAKE FINAL INSTALLATION.
- INSTALL WALL BOX AT 48" AFF FOR N/O ALARM MONITORING STATION AT LOCATION AS SHOWN. INSTALL 3/4" EMPTY CONDUIT SYSTEM FROM N/O ALARM MONITORING STATION UP WALL DOWN TO CLOSET NITROUS OXIDE AND OXYGEN MANIFOLD/CONTROLS IN EQUIPMENT ROOM 110. INSTALL ALL WIRES REQUIRED BY PATTERSON DENTAL. FIELD COORDINATE EXACT TERMINATIONS AND REQUIREMENTS PRIOR TO MAKE FINAL INSTALLATION.
- E15 INSTALL STAINLESS STEEL PEDESTAL FOUR GANG BOX WITH TWO DUPLEX OPENINGS AND BLANK PLATE HUBBELL #SA6687 (HOUSING WITH 3/4" HUB), S82 (FACEPLATE) AND S23 (BLANK PLATE) WITH DOUBLE DUPLEX RECEPTACLES FOR DENTAL CHAIR POWER AND SECRETARIES FOR PROPERTY AND SECRETARIES FOR PRO ALL CONDUIT SYSTEM REQUIRED. REFER TO PATTERSON DENTAL DRAWINGS FOR EXACT REQUIREMENTS.
- E16 LOCATE RECEPTACLE BEHIND ELECTRIC WATER COOLER ENCLOSURE. FIELD COORDINATE EXACT REQUIREMENTS AND LOCATION WITH PLUMBING CONTRACTOR.
- INSTALL SINGLE GANG WALL BOX WITH APPROPRIATE COVER PLATE FOR HVAC THERMOSTAT.
  PROVIDE 3/4" EMPTY CONDUIT WITH PULL STRING FROM SINGLE GANG WALL BOX UP TO 6" ABOVE ACCESSIBLE CEILING WITH BUSHING. COORDINATE EXACT LOCATION WITH DIVISION 15. MECHANICAL CONTRACTOR. REFER TO MECHANICAL FLOOR PLAN, SHEET 1/M.1 FOR LOCATION OF WALL MOUNTED THERMOSTAT.
- ROUGH-IN AND MAKE FINAL CONNECTIONS TO EQUIPMENT SPECIFIED IN OTHER DIVISIONS, OR FURNISHED BY OWNER. FIELD CONFIRM WITH EQUIPMENT SUPPLIER AND/OR INSTALLER EXACT REQUIREMENTS PRIOR BIDDING AND INSTALLATION.
- ALL LOCATIONS OF ELECTRICAL AND TECHNOLOGY DEVICES MUST BE CONFIRMED WITH ARCHITECTURAL SECTIONS, ELEVATIONS, MILLWORKS AND CASEWORK PRIOR TO MAKE FINAL INSTALLATIONS. ALL CHANGES DUE TO CONFLICT OF LOCATIONS AND/OR LACK OF ARCHITECTURAL SHEETS COORDINATION SHALL BE MADE WITHOUT ADDITIONAL EXPENSE TO THE OWNER.
- ALL CONDUIT PENETRATIONS AT FIRE RATED WALLS MUST BE PROVIDED WITH SCHEDULE 40 GALVANIZED CONDUIT SLEEVE SECURED TO PARTITION WITH GROUT AND CAULK ANNULAR SPACE BETWEEN CONDUIT AND SLEEVE WITH FIRE RETARDANT SEALANT. WHERE CONDUIT IS EXPOSED AT FINISHED WALLS, PROVIDE FLUSH MOUNTED SLEEVE AND STAINLESS STEEL ESCUTCHEON PLATES. AT NON-FIRE RATED INTERIOR WALLS, CAULK ANNULAR SPACE BETWEEN CONDUIT AND SLEEVE WITH 1 LB. DENSITY FIBERGLASS AND SEAL ENDS WITH DOW CORNING 732 RTV OR EQUAL.
- ALL EXHAUST FANS (120V/1ø) ARE SPECIFIED WITH FACTORY INSTALLED DISCONNECT SAFETY
  SWITCH MOTOR STARTERS ARE PROVIDED AND INSTALLED BY FLECTRICAL CONTRACTOR SWITCH. MOTOR STÄRTERS ÄRE PROVIDED AND INSTALLED BY ELECTRICAL CONTRACTOR. THERMOSTATS, FAN INTERLOCKS AND HVAC CONTROLS ARE ALL PROVIDED AND INSTALLED UNDER DIVISION 15. CONFIRM WITH DIVISION 15 AND MECHANICAL SCHEDULES.
- COORDINATE AND CONFIRM HORSEPOWER RATING AND LOCATION OF ALL MECHANICAL AND PLUMBING FOLIPMENT WITH DIVISION 15 AND MECHANICAL SCHEDULES PRIOR TO AND PLUMBING EQUIPMENT WITH DIVISION 15 AND MECHANICAL SCHEDULES PRIOR TO ORDERING AND INSTALLATION OF DISCONNECT SAFETY SWITCHES, MOTOR STARTERS OR COMBINATION MOTOR STARTERS.
- ALL LIGHTING CIRCUITS SHALL HAVE SEPARATE NEUTRALS. NO SHARED NEUTRALS.





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1936

ARCHITECT HAS REVIEWED THE CONSULTANT'S WORK AND COORDINATED IT WITH

THE OVERALL PROJECT

CLINIC

ISSUED FOR SCHEMATIC DESIGN

DATE: 6/19/2019 DESIGN DEVELOPMENT X DATE: 8/1/2019

BIDS & CONSTRUCTION X DATE: 10/28/2019

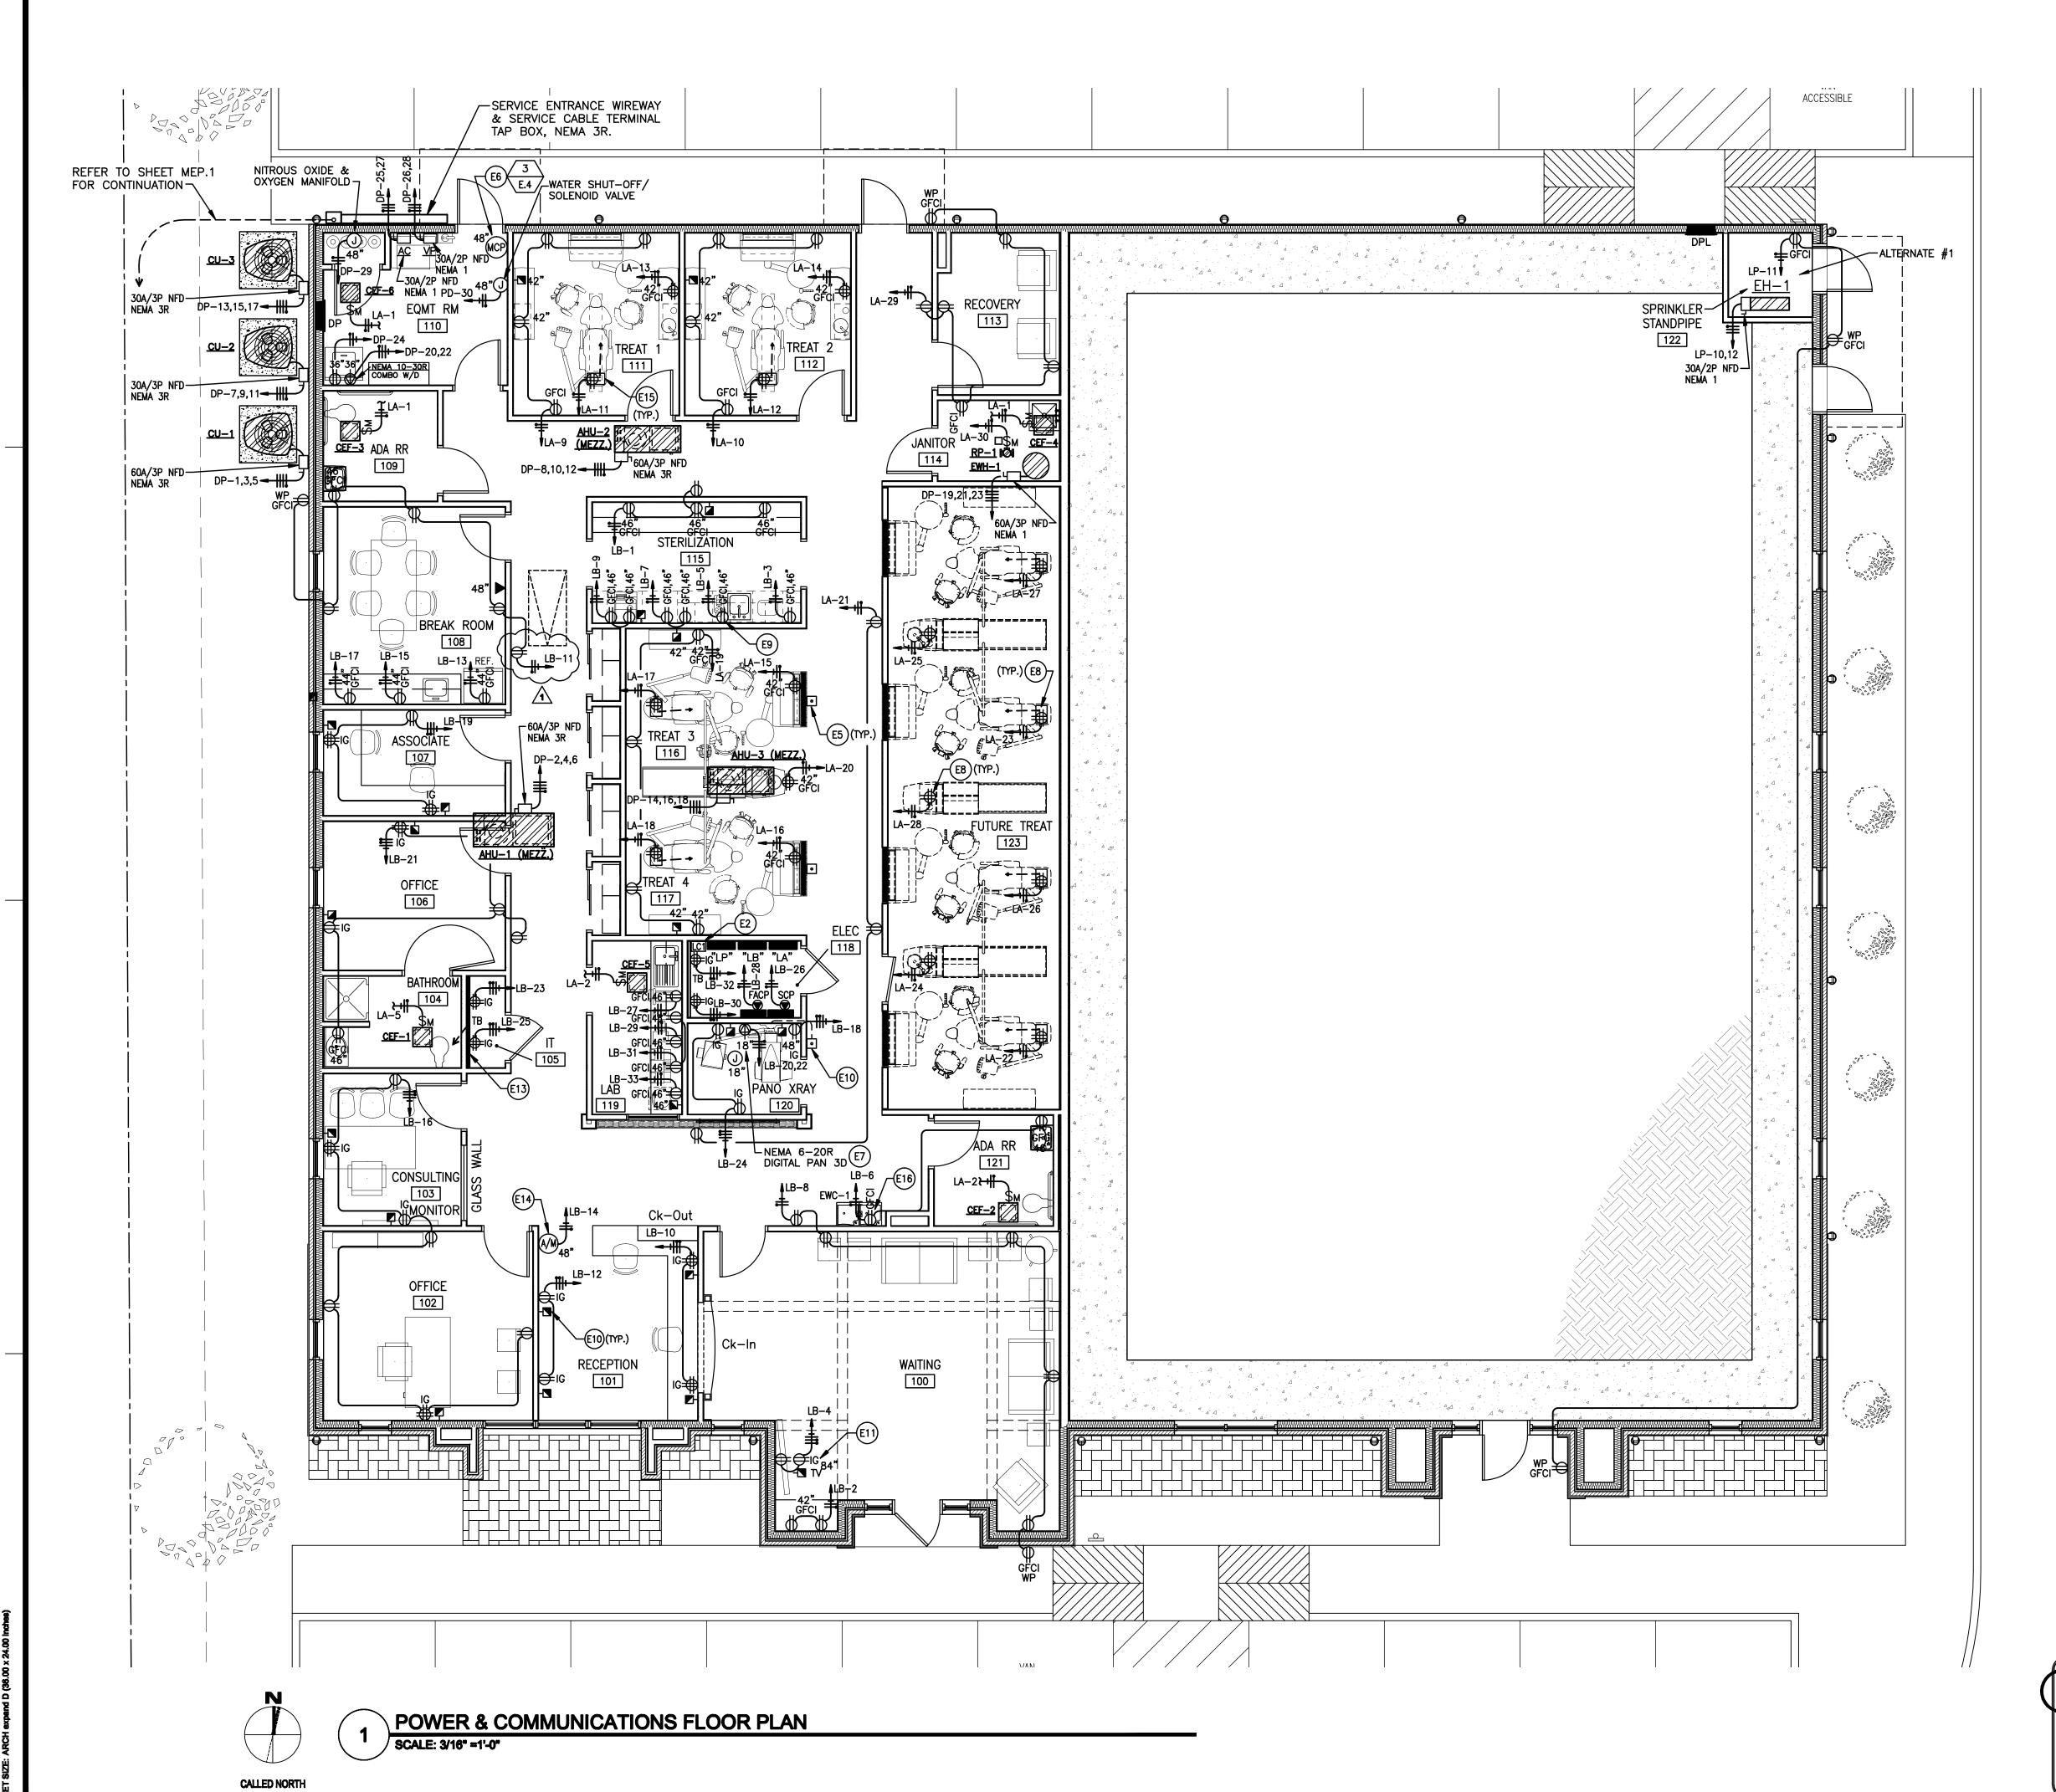
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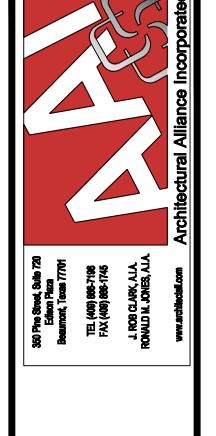
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DRAWINGS SHEET TITLE LIGHTING **FLOOR PLAN** 

SHEET NUMBER



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**REVISION:** 

DRAWINGS SHEET TITLE

POWER & COMMUNICATIONS FLOOR PLAN

SHEET NUMBER

1936 PROJECT NUMBER

MEPTech Engineering, Inc. TBPE FIRM # F-10227 5090 ADA AVENUE
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## **ELECTRICAL SPECIFICATIONS**

- GENERAL REQUIREMENTS AND CONTRACTOR QUALIFICATIONS
- A. The Contractor for this work shall be a specialist in this field, having the organization to provide trained, experienced and skilled personnel required to construct a practical and working system.

B. Study all matters and conditions of the Project and coordinate

- with the other Divisions of work to provide a complete and functioning system in accordance with the Contract Documents. C. Use only the specified materials, equipment and procedures in
- fabricating the systems. D. Notify the Engineer of any and all conflicts in ample time to avoid
- unwarranted changes in any work.
- E. Obtain all applicable permits and pay all fees charged by above authorities.
- F. Existing conditions
- 1. Prior to submitting a proposal, visit the job site to become familiar with existing conditions and equipment for the work to be accomplished.
- 2. Verify exact location of existing electrical system.
- G. Provide "AS BUILT" shop drawings at completion of project.
- H. The Electrical Systems in their entirety shall be installed in accordance with the NFPA 70, 2017 National Electrical Code, International Energy Code and all other governing Codes and Authorities. Modifications required by the above said outhorities shall be made without additional charge to the owner.
- With submission of bid, Contractor shall give written notice to the Architect or Engineer of any materials or apparatus believed inadequate or unsuitable, in violation of laws, ordinances, rules and any necessary items or work omitted. In the absence of such written notice, it is mutually agreed the Contractor has included the cost of all required items in his proposal, and that he will be responsible for the approved satisfactory functioning of the entire system without extra compensation.
- 2. LIGHTING AND POWER CIRCUITS AND SWITCHLEGS
  - A. Provide a luminaire for each luminaire symbol shown on the
- drawings and install all luminaires complete with lamps. B. Install luminaires complete with all materials, devices, parts, cables, hardware, hangers, supports, frames and equipment required for a

complete, safe and fully operational installation.

- C. Furnish and install all conduit and conductors necessary for complete circuiting of general power and lighting and for light switching.
- 3. SHOP DRAWINGS AND PRODUCT DATA
- A. Submit manufacturer's printed product literature for all compoments of the electrical systems prior to purchase and installation.
- 4. BRANCH CIRCUITS FOR POWER AND LIGHTING
- A. Conduit systems shall be U.L. labeled EMT with U.L. labeled compression or die cast type fittings.
- 1. Minimum 3/4" for homeruns. 1/2" for switchlegs. B. Branch circuit Conductors to be soft drawing annealed copper
- having a conductivity of not less than 99% of pure copper. 1. Type "THHN" (interior), or "THHW" (exterior) solid conductor.
- C. All feeders, service conductors & branch circuit wiring shall be copper only.
- D. Use flexible conduit for light fixture wiring where length is within limits as prescribed by NEC and Local Codes.
- E. Conduit interconnection of lighting fixtures shall be from joist level. Do not extend runs horizontally from fixture to fixture.
- F. Except where wiring and conduit is routed exposed in electrical/ mechanical rooms all wiring shall be concealed within floors, walls
- G. Color coding of wire larger than No. 6 AWG and other types of wire accomplished by means of self—adhesive, wrap around type markers of solid colors.
- 1. Mark each wire at panelboards, junction boxes, pull boxes, and outlets.
- 2. Color Code.
- red
- white green pink
- H. Motor circuit conductors shall be continuous throughout their entire length.
- Splices and joints in branch circuit wiring shall be made only in accessible junction boxes and shall be made with compression type solderless connectors. Connectors of the nonmetallic screw type are not approved.
- J. Minimum wire size shall be no less than #12 AWG unless otherwise

- Minimum wire size 20 amp branch circuit shall be AWG listed size per distance shown below. Distance shall be measured from the panelboard circuit breaker to the furthest outlet.
  - Less than 100 feet
  - A. #12 Between 100-150 feet B. #10 Between 150-250 feet
- 5. WIRING DEVICES
- A. Furnish and install all wiring devices for convenience outlets, telephone outlets, push buttons, conductor splices, and switches as shown on the drawings unless otherwise noted.
- B. Unless shown otherwise, convenience outlets shall be Hubbell #CR5362GR/WH.
- C. Unless shown otherwise, light switches shall be Hubbell #CS1221GR/WH/CS1222GR/WH/CS1223GR/WH/CS1224GR/WH. Dimmer - 120V LED Incandescent: Greengate WBSD-DEC-W (White)
- Dimmer 0-10V LED/Fluorescent: Greengate WBSD-010M-C1-W (White) D. Where shown on drawings, duplex receptacles designated with ground fault circuit interruption shall be HUBBELL #GFR53521 and weatherproof cover shall be HUBBELL CWP26H.
- E. The following are the ADA Accessibility Guidelines for switches, receptacles, telephones and outlets. Unless shown otherwise on the drawings, mounting heights to be as follows:
- 1. Wall switches 4'-0"
- 2. Wall switches at countertops 3'-8" to center of device or shown on drawings.
- 3. Wall receptacles, telephone and data outlets 1'-6" to center of device or shown on drawings.
- 4. Wall receptacles, telephone and date outlets at countertops
- 3'-8" to center of device or shown on drawings.
- Provide white wall/face plates for all interior areas. Confirm color with Architect or GC.
- G. Occupancy Sensors:

6. LIGHT FIXTURES AND LIGHTING CONTROLS.

- 1.) Wall mounted: Greengate-Cooper Model ONW-D-1001-DMV-N/ OSW-D-010 120V and white color. 2.) Ceiling mounted: Greengate-Cooper Model OAC-DT-2000-R/
- DT2000 120V and white color.
- Furnish and install all lighting fixtures in accordance with the fixture designation, light fixture schedule or indicated on drawings.
- 7. TELEPHONE, VIDEO AND DATA CONDUIT SYSTEM REQUIREMENT
- Where shown on drawings, at each telephone, video and data
- outlet location, furnish and install recessed wall or floor boxes with 3/4" empty conduit and pull string extending to 6" above ceiling. Provide white plastic cover plate over wall box if not in used. 8. CUTTING AND PATCHING
- A. The contract shall do all cutting and patching of the existing contruction work which may be required for the proper installation of the electrical work. All patching shall be of the same materials, workmanship and finish as, and shall accurately match all surrounding
- 9. FIRE ALARM, SMOKE DETECTION AND SECURITY SYSTEMS
- A. Installation of new fire alarm devices shall comply with the current applicable provisions of NFPA 70, NFPA 71, NFPA 72/72E, NFPA 101, local and state building codes, and all requirements of the local authority having jurisdiction.
- Furnish and install new security devices with all necessary equipment, wiring, conduits, boxes, etc. required to ensure a fully operational
- C. It shall be the responsibility of the Electrical Contractor to provide all conduit systems, standard electrical boxes, and operating power for the security system as outlined on the project drawings or as required by the Security System Contractor. Verify all requirements prior to installation of conduit and wall boxes.

Wiring and installation shall be in accordance with standard professional

- security system engineering practices and Texas State Board of Private Investigators. All installation and service personnel working on this project shall be "Registered" Alarm system Installers.
- 10. PANELBOARDS, CBs, DISCONNECT SAFETY SWITCHES & MOTOR STARTERS
- A. Furnish and install at locations as shown on the drawings and shall be of the type approved by owner, indicated or specified.
- 11. GROUNDING OF ELECTRICAL SYSTEMS
- Grounding of the electrical systems shall conform to the requirements of the latest National Electrical Code and other governing local codes.

<u> </u>	GROUND CONDUCTOR
<b>-                                    </b>	ISOLATED GROUND & GROUND CONDUCTOR
	SWITCH LEG AND/OR BRANCH CIRCUIT
	BRANCH CIRCUIT
<b></b>	HOME RUN TO PANELBOARD
\$	SWITCH, 48" AFF
\$3	THREE-WAY SWITCH, 48" AFF
\$3D	THREE-WAY DIMMER SWITCH, 48" AFF
\$м	MOTOR RATED SWITCH
\$ <sub>P</sub>	SWITCH WITH PILOT LIGHT, 48" AFF
\$os	OCCUPANCY SENSOR SWITCH, 48" AFF
\$osd	OCCUPANCY SENSOR DIMMER SWITCH, 48" AFF
<b>⊘</b> ∕	MOTOR
	DISCONNECT SAFETY SWITCH
$\boxtimes$	COMBINATION MOTOR STARTER AND DISCONNECT SAFETY SWITCH
	HARDWIRED CONNECTION
$\ominus$	DUPLEX RECEPTACLE, 12" AFF
<b>⊕</b> c	DUPLEX RECEPTACLE ABOVE CEILING
	FLOOR MOUNTED DUPLEX RECEPTACLE
⊖ıc	ISOLATED GROUND DUPLEX RECEPTACLE
<b>⊖</b> 00"	DUPLEX RECEPTACLE WITH MOUNTING HEIGHT
<b>⊕</b> wp	WEATHER PROOF DUPLEX RECEPTACLE
<b>⊖</b> GFCI	GROUND FAULT CIRCUIT INTERRUPTER DUPLEX RECEPTACLE
<b>⊕</b>	DOUBLE DUPLEX RECEPTACLE, 12" AFF
⊕  G	ISOLATED GROUND DOUBLE DUPLEX RECEPTACLE, 12" AFF
<b>⊕</b> 00"	DOUBLE DUPLEX RECEPTACLE WITH MOUNTING HEIGHT
$\odot$	JUNCTION BOX
	DATA AND/OR VOICE OUTLETS, 12" AFF (DOUBLE DUPLEX CAT 5)
- <b>⊿</b> s	DATA AND/OR VOICE OUTLETS, 12" AFF (DUPLEX CAT 5)
<b>∠</b> c	CEILING MOUNTED DATA AND/OR VOICE OUTLETS (DOUBLE DUPLEX CAT 5)
	FLOOR MOUNTED DATA AND/OR VOICE OUTLETS (DOUBLE DUPLEX CAT 5)
<b>-⊿</b> 00"	DATA AND/OR VOICE OUTLETS WITH MOUNTING HEIGHT (DOUBLE DUPLEX CAT 5)
- <b>∠</b> TV	TV DATA OUTLET
F	FIRE ALARM PULL STATION, 48" AFF
V	FIRE ALARM VISUAL/STROBE DEVICE, 80" AFF
$\boxed{\lor} \lor$	FIRE ALARM AUDIO/VISUAL DEVICE, 80" AFF
VO	FIRE ALARM WP EXTERIOR HORN, 108" AFF
R	FIRE ALARM SHUT DOWN RELAY
SD	DUCT MOUNTED SMOKE DETECTOR WITH INDICATOR LIGHT
abla	FIRE ALARM STROBE/VISUAL DEVICE, 80" AFF
<b>(</b>	CEILING MOUNTED HEAT DETECTOR
②	CEILING MOUNTED SMOKE DETECTOR
PC	PHOTO ELECTRIC CONTROL, 108" AFF
	LIGHTING CONTACTOR 54" AFF

LIGHTING CONTACTOR, 54" AFF

AMPS INTERRUPTING CURRENT

FUSED DISCONNECT SAFETY SWITCH

ABOVE FINISHED FLOOR

CIRCUIT BREAKER

GROUND CONDUCTOR

ISOLATED GROUND

KILOVOLT-AMPS

MAIN LUGS ONLY

UNDER COUNTER

WEATHERPROOF

VOLTS

MAIN CIRCUIT BREAKER

NATIONAL ELECTRICAL CODE

NON-FUSED DISCONNECT SAFETY SWITCH

**AMPERES** 

CONDUIT

COPPER

CU

KVA

MCB

NFD

**ABBREVIATIONS** 

**ELECTRICAL SYMBOLS** 

REFERENCE TO DETAIL

SURFACE MOUNTED PANEL

LED EMERGENCY LIGHT FIXTURE

CEILING MOUNTED DOWNLIGHT LIGHT FIXTURE

CEILING MOUNTED EXIT LIGHT FIXTURE

WALL MOUNTED EXIT LIGHT FIXTURE

FLUSH MOUNTED PANEL

NEUTRAL CONDUCTOR

PHASE CONDUCTOR

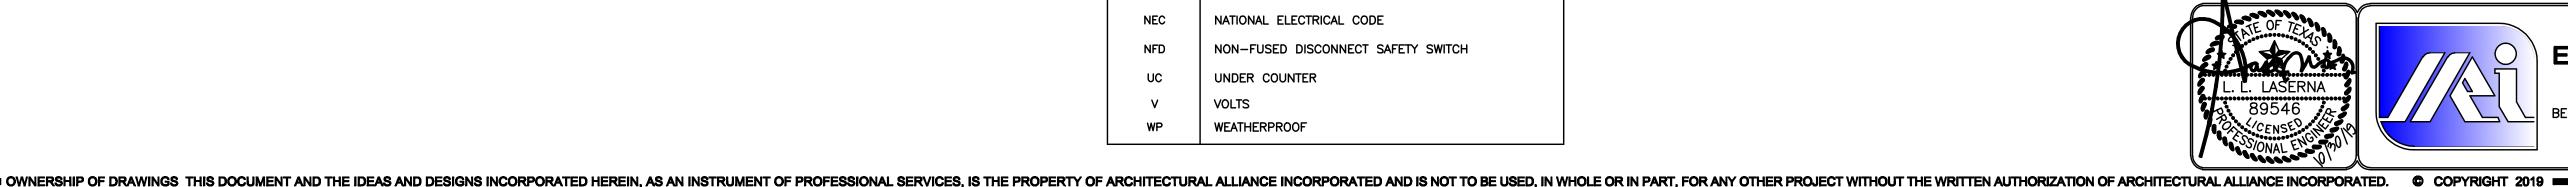
LED LIGHT FIXTURE

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E.1 /

		LIGH"	T FIXTURE SCHED	ULE	
MARK	MANUFACTURER	MODEL NO.	LAMPS	VOLTAGE	REMARKS
A	METALUX	24FP-64-UNV- L840-CD1	(1)-42W LED/840 (INCLUDED)	120	2' x 4' RECESSED FLANGED LED WITH DI FORMED COLD ROLLED STEEL, INTEGRAL DRIVE SMOOTH FROSTED ACRYLIC LENS AND DRYWAL FRAME KIT.
ΑE	METALUX	24FPX-64-UNV-EL14W L840-CD1	(1)-42W LED/840 (INCLUDED)	120	SAME AS FIXTURE TYPE "A" EXCEPT WIT EMERGENCY BATTERY PACK INSTALLED.
AEN	METALUX	24FPX-64-UNV-EL14W L840-CD1	(1)-42W LED/840 (INCLUDED)	120	SAME AS FIXTURE TYPE "AE" EXCEPT HARDWIRE FOR NIGHT LIGHT.
AN	METALUX	24FPX-64-UNV-EL14W L840-CD1	(1)-42LED/840 (INCLUDED)	120	SAME AS FIXTURE TYPE "A" EXCEPT HARDWIRE FOR NIGHT LIGHT.
В	METALUX	2BCLED-LD4-28SL-UNV- -L840-CD1	(1)-29W LED/840 (INCLUDED)	120	2' WALL BRACKET LED WITH DIE FORME COLD ROLLED STEEL, INTEGRAL DRIVER, SMOO OPAL WHITE ACRYLIC LENS.
BE	METALUX	2BCLED-LD4-28SL-UNV- EL7W-L840-CD1	(1)-29W LED/840 (INCLUDED)	120	SAME AS FIXTURE TYPE "B" EXCEPT WI EMERGENCY BATTERY PACK INSTALLED.
С	HALO	HC630D010- HM612840-61WDCWF RMB22	(1)-28 LED/840	120	6" OPEN DOWNLIGHT SELF FLANGED, WIE BEAM WITH SPECULAR CLEAR FINISH O C-CHANNEL BAR HANGER.
CE	HALO	HC620D010- HM634840-61WDCWF	(1)-28 LED/840	120	SAME AS FIXTURE TYPE "C" EXCEPT WI EMERGENCY BATTERY PACK INSTALLED.
C1	HALO	RMB22 1EM14 HC615D010- HM634840-61RWWHWF	(1)-28 LED/840	120	6" LED WALL WASHER.
D		——————————————————————————————————————	<u></u>	120	CHANDILIER FURNISHED BY OWNER AN INSTALLED BY ELECTRICAL CONTRACTOR.
E	SURE-LITES COOPER	LPX7SD20	(LED LAMPS INCLUDED)	120	BACK MOUNT SINGLE FACE EXIT SIG WITH HIGH IMPACT POLYCARBONATE HOUSIN STENCIL RED FACE, WHITE FACE/HOUSIN TEXTURED FINISH, LED LAMP AND NICKE CADMIUM BATTERY. MOUNT BOTTOM EX SIGN 12" CENTERED ABOVE DOOR.
E1	SURE-LITES COOPER	LPX7SD20	(LED LAMPS INCLUDED)	120	TOP MOUNT SINGLE FACE EXIT SIG WITH IM HI POLYCARBONATE HOUSING STENCIL RED FACE, WHITE HOUSING FINIS LED LAMP, NICKEL CADMIUM BATTERY AN CHEVRON DIRECTIONAL INDICATOR KNOCKOUTS AS INDICATED ON PLANS.
E2	SURE-LITES COOPER	LPX7SD20	(LED LAMPS INCLUDED)	120	SAME AS FIXTURE TYPE "E1" EXCEPT WIT DOUBLE FACE.
FE	METALUX	4BCLED-LD4-28SL-UNV- EL7W-L840-CD1	(1)-29W LED/840 (INCLUDED)	120	4' LED WALL BRACKET WITH DIE FORME COLD ROLLED STEEL, INTEGRAL DRIVER, SMOOT OPAL WHITE ACRYLIC LENS.
G	METALUX	4CWPLD4040C	(1)-45W LED/840 (INCLUDED)	120	4' LED WWRAPAROUND WITH COLD ROLLE STEEL, INTEGRAL DRIVER, HIGH-IMPACT POLYME PLASTIC & FROSTED WHITE LENS.
Н	ELK	87042/1	(1)-20W LED A19/840	120	WALL SCONCES WITH MATTE BLACK LANTER STYLE SHADE WITH MESH AND CLEAR GLASS.
J	LUMARK COOPER	PRV-C60-D-UNV-T5 -SA-BZ (2   180') ADAPTOR FOR 3 -1/2" TENON) SSS-5-M-20-S-F-3-1 EPA (120 MPH)	(2)-306 LED 4000K (INCLUDED)	120	20'-0" STEEL SQUARE POLE WITH DURAGR PLUS DOUBLE MOUNT FIXTURE WITH D FORMED HEAVY GAUGE ALUM. CONSTRUCTIO COMPLETELY GASKETED, HEAT RESISTAN FLAT CLEAR TEMPERED GLASS, TENON MOUI BRONZE FINISH, LED AND U.L. LISTED FO
J1	LUMARK COOPER	PRV-C60-D-UNV-T5 -SA-BZ (2 @ 90°)  ADAPTOR FOR 3 -1/2" TENON)  SSS-5-M-20-S-F-3-1 EPA (120 MPH)	(2)-306 LED 4000K (INCLUDED)	120	WET LOCATIONS.  SAME AS FIXTURE TYPE "J" EXCEPT AR MOUNT 2@90°.
K	ACCLAIM	FLEXOSE#4 -12 FT. CVD60L24DC	(1)-28W LED 4000K (INCLUDED)	120	12'-0" LED STRIP WITH DIMMABLE, MUL VOLTAGE DRIVER, COPPER STRIP AND WHIT FINISH.





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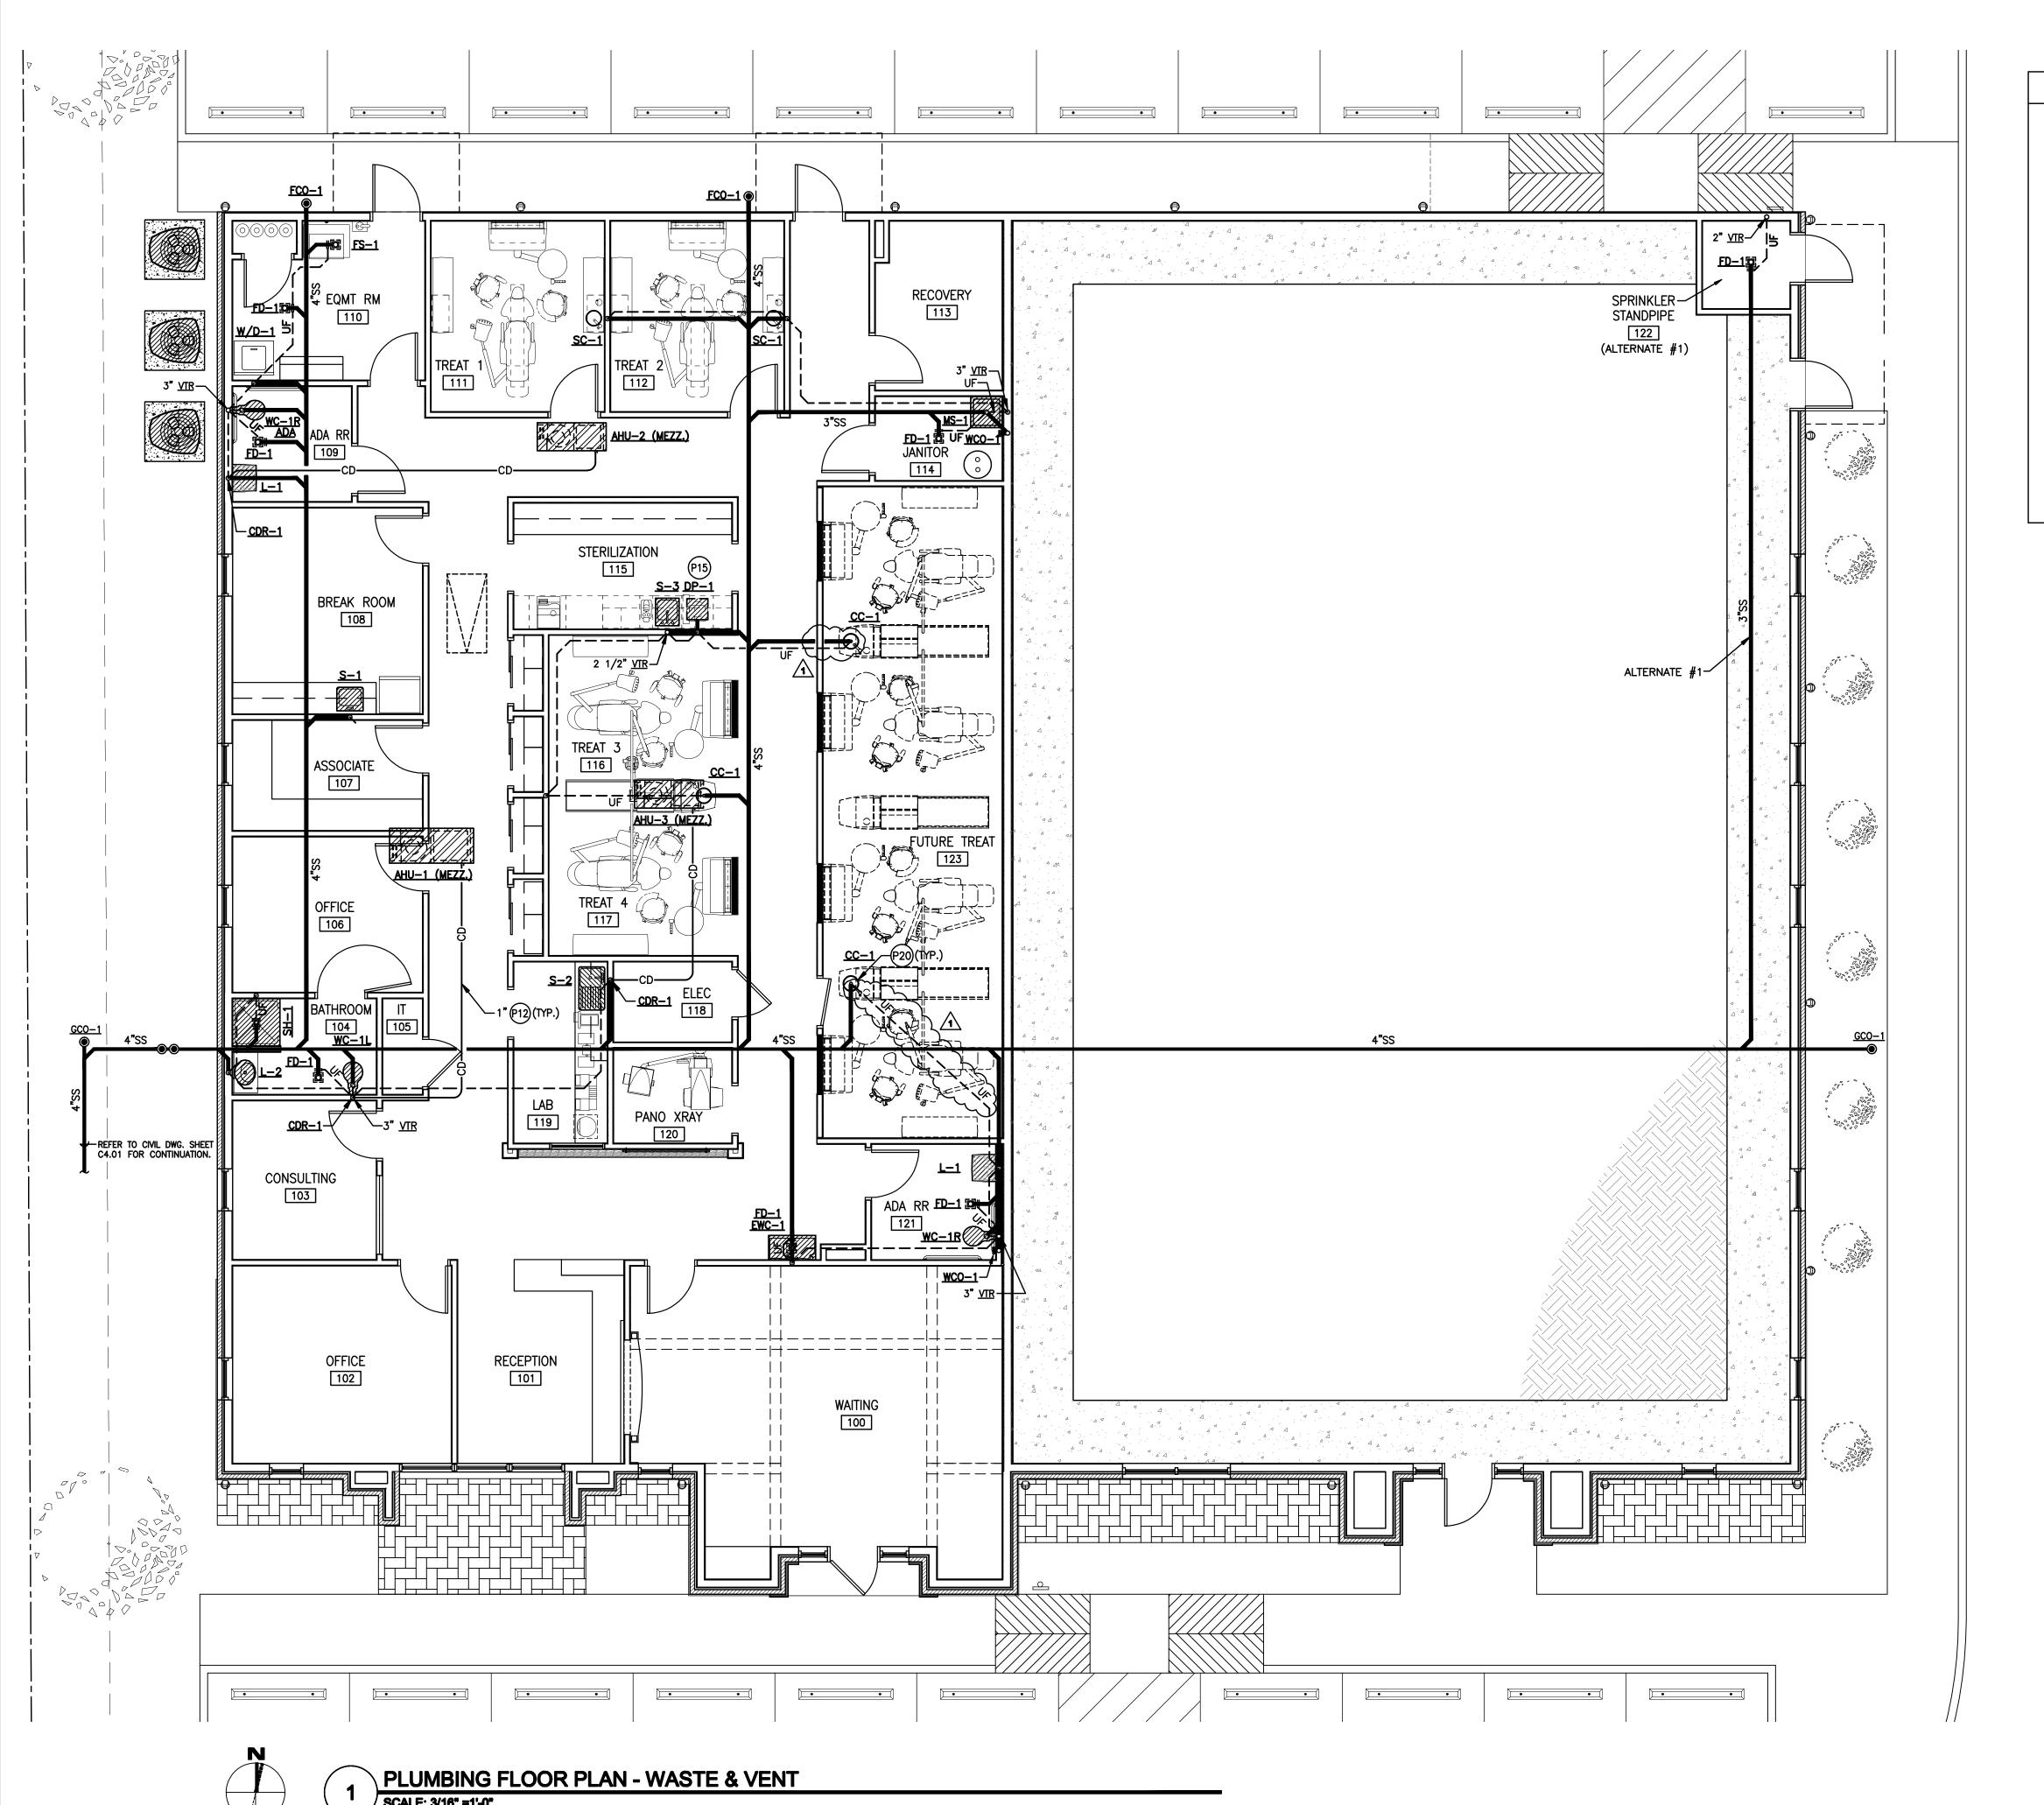
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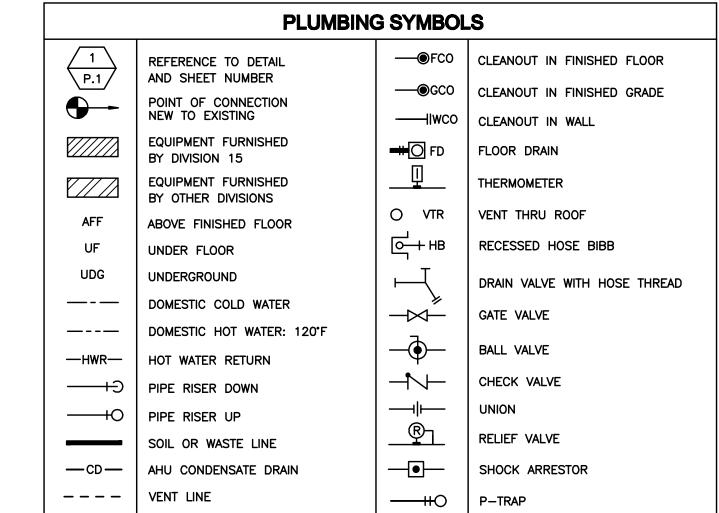
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DESIGN DEVELOPMENT

**DRAWINGS SHEET TITLE ELECTRICAL** SYMBOLS, LIGHT FIXTURE SCHED

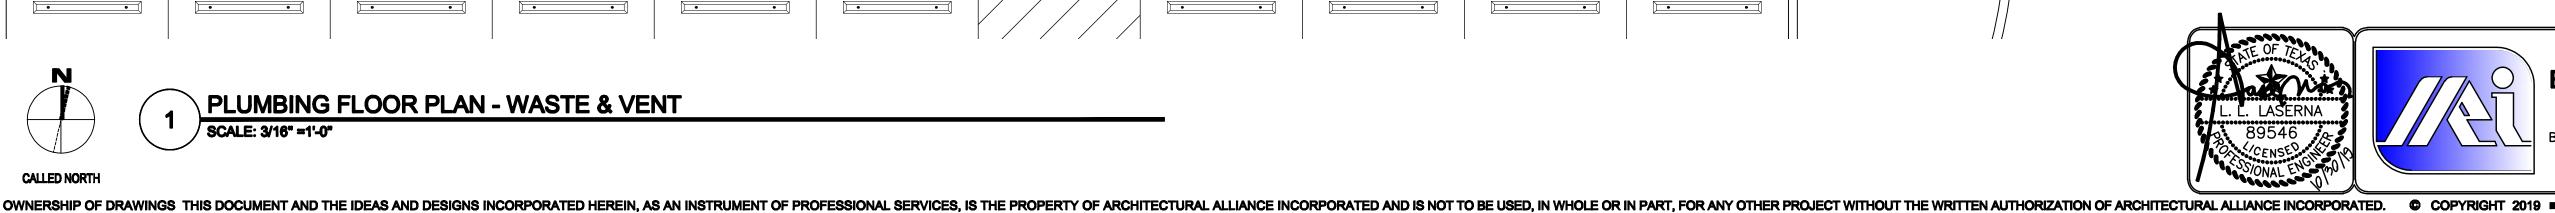
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## **PLUMBING NOTES**

- (P1) CONFIRM AND COORDINATE EXACT LOCATION OF ALL FLOOR DRAINS WITH ARCHITECTURAL, STRUCTURAL ELEMENTS, HVAC EQUIPMENT AND/OR ELECTRICAL SYSTEMS PRIOR TO MAKE FINAL INSTALLATION. SAW CUT AND PATCH TO MATCH EXISTING CONCRETE SLAB FOR ALL PIPING ROUTED UNDER EXISTING CONCRETE SLAB.
  - ALL EXTERIOR BRACKETS, CLAMPS AND HANGERS SHALL BE GALVANIZED. COAT ALL ENDS AND WELDS WITH "ZRC" COLD GALVANIZING COMPOUND. PROVIDE SHIELDING AT ALL DISSIMILAR METAL CONTACT. ALL MISCELLANEOUS INTERIOR BRACKETS SHALL BE SHOP PRIMED UNLESS GALVANIZED OR STAINLESS STEEL.
  - PROVIDE NEOPRENE ROPE SEAL WITH SILICONE CAULKING TO FORM A WATERTIGHT SEAL WHERE SERVICE MOP SINK ABUTS WALL.
  - LOCATE FULL PORT VALVES 12" MAXIMUM ABOVE CEILING AND ACCESSIBLE FOR SERVICE. FIELD COORDINATE EXACT LOCATION WITH MECHANICAL AND ELECTRICAL DRAWINGS PRIOR TO MAKE FINAL INSTALLATION.
  - REFER TO SHEET P.3 MINIMUM LINE SIZE SCHEDULE FOR LINE SIZES NOT SHOWN ON FLOOR PLANS.
  - INSTALL 12" AIR CHAMBER FOR DOMESTIC HOT AND COLD WATER PIPING AT SINGLE PLUMBING FIXTURE.
- PROVIDE TYPE "K" COPPER UNDER SLAB WITH CORROSION PROTECTION AS SPECIFIED OR SCHEDULED.
- ALL PLUMBING FIXTURES INDICATED ON FLOOR PLANS OR SCHEDULED FOR ADA MUST COMPLY WITH ADA HEIGHTS AND REQUIREMENTS. CONFIRM WITH ARCHITECTURAL DRAWINGS. INSULATE P-TRAP, TAILPIECE AND WATER SUPPLIES OF ALL ADA COMPLIANT PLUMBING FIXTURES WITH HANDI-LAV INSULATION OR EQUAL.
- PROVIDE NEW COLD WATER CUTOFF VALVE WITH CAST IRON TOP WITH MARKED "WATER" AND IN HEAVY DUTY BOX. REFER TO CIVIL DRAWINGS FOR REQUIREMENTS.
- LOCATE WATER BACKFLOW PREVENTOR CLOSE TO WATER METER TO COMPLY WITH CITY OF BEAUMONT LOCATION REQUIREMENTS. FIELD CONFIRM FINAL LOCATION PRIOR TO MAKE FINAL INSTALLATION WITH CITY OF BEAUMONT WATER UTILITIES. REFER TO CIVIL DRAWING SHEET C4.01 FOR LOCATION.
- PROVIDE HYDROTROL SHOCK ARRESTOR EQUAL TO MIFAB OR ZURN Z1700, MODEL #300 IN COLD WATER LINE, 33-60 PU. INSTALL STAINLESS STEEL 12" x 12" ACCESS FOR SERVICING.
- INSTALL AND CONNECT 1" CONDENSATE DRAIN OF AHUS TO SANITARY SEWER FLOOR DRAIN AS SHOWN ON PLAN. FIELD COORDINATE EXACT CONNECTION WITH MECHANICAL CONTRACTOR.
- PUT TOP OF EXTERIOR CLEANOUTS IN 12"  $\times$  12"  $\times$  6" THICK CONCRETE PAD FLUSH WITH FINISHED GRADE. FIELD CONFIRM EXACT LOCATION OF EXTERIOR CLEANOUTS PRIOR TO MAKE FINAL INSTALLATION.
- PLUMBING PIPING INSTALLATION MUST BE WITHIN 3 FEET OF ALL ELECTRICAL PANELS AND HVAC EQUIPMENT OR PER CODES.
- WATER FILTRATION/ULTRAPURE AND RELATED EQUIPMENT FURNISHED AND INSTALLED BY PATTERSON DENTAL. INSTALL AND PROVIDE MASTER WATER SHUT—OFF VALVES, SOLENOID VALVE, DRAIN AND 3/4" COPPER PIPING SYSTEM IN EQUIPMENT ROOM 110. EXTEND 3/4" COPPER PIPING WITH SHUT-OFF/SOLENOID VALVES TO ULTRAPURE TANK WATER SYSTEM LOCATED UNDER SINK IN STERILLIZATION 115. INSTALL FLEX PIPING FROM TANK UP TO COUNTERTOP UNTRASONIC STERILIZATION UNIT. CONFIRM EXACT REQUIREMENTS WITH PATTERSON DENTAL PRIOR TO SUBMIT BIDDING. COORDINATE TO ALL TRADES PRIOR TO MAKE FINAL INSTALLATION.
- MASTER CONTROL PANEL FOR COMPRESSED AIR AND VACUUM SYSTEM FURNISHED AND INSTALLED BY PATTERSON DENTAL. PLUMBING CONTRACTOR TO PROVIDE AND AND INSTALL (1) 1/4" POLYFLOW TUBING EACH TO COMPRESSED AIR LINE AND TO VACCUM LINE FROM MASTER CONTROL PANEL. FIELD CONFIRM EXACT REQUIREMENTS WITH PATTERSON DENTAL PRIOR TO MAKE FINAL INSTALLATION.
- INSTALL 2" PVC SCH. 40 PIPING EACH FOR EXHAUST LINE AND FRESH AIR FROM VACUUM PUMP AND AIR COMPRESSOR UP TO WALL CAP AS SHOWN. FIELD CONFIRM AND COORDINATE EXACT REQUIREMENTS WITH DENTAL EQUIPMENT INSTALLER PRIOR TO MAKE FINAL INSTALLATION OF 2" PIPING.
- INSTALL ASME THERMAL EXPANSION TANK EQUAL TO WATTS MODEL PET-12-M1 AT COLD WATER CONNECTION TO ELECTRIC WATER HEATER.
- MAKE CONNECTTIONS TO SIDE CABINET SINK FURNISHED AND INSTALLED BY PATTERSON DENTAL. FIELD COORDINATE EXACT REQUIREMENTS WITH PATTERSON DENTAL PRIOR
- STUB-UP AT 18" AFF AND CAP FOR FUTURE CENTRAL CABINET. PROVIDE SHUT-OFF VALVES FOR HOT AND COLD WATER LINES. FIELD COORDINATE EXACT REQUIREMENTS WITH PATTERSON DENTAL PRIOR TO SUBMIT BIDDING.
- INSTALL GALVANIZED IRON HANGER ROD AND HANGER EVERY 10'-0" AND CONNECT TO BAR JOISTS. PROVIDE A SECTION OF HIGH COMPRESSION STRENGTH INSULATION AT EACH HANGER POINT. INSULATION SHALL BE HALF ROUND AND EXTEND 2" BEYOND 16. GAUGE GALVANIZED SHEET SHIELD EACH WAY.





**MEPTech** Engineering, Inc. TBPE FIRM # F-10227 5090 ADA AVENUE BEAUMONT, TEXAS 77708-4411

> 1936 PROJECT NUMBER

PHONE: (409) 673-2013 FAX: (409) 767-9224

ARCHITECT HAS REVIEWED THE CONSULTANT'S WORK AND COORDINATED IT WITH THE OVERALL PROJECT

CLINIC

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ISSUED FOR

SCHEMATIC DESIGN DATE: 6/19/2019 DESIGN DEVELOPMENT [

DATE: 8/1/2019 BIDS & CONSTRUCTION X

DATE: 10/28/2019 REVISION: 1

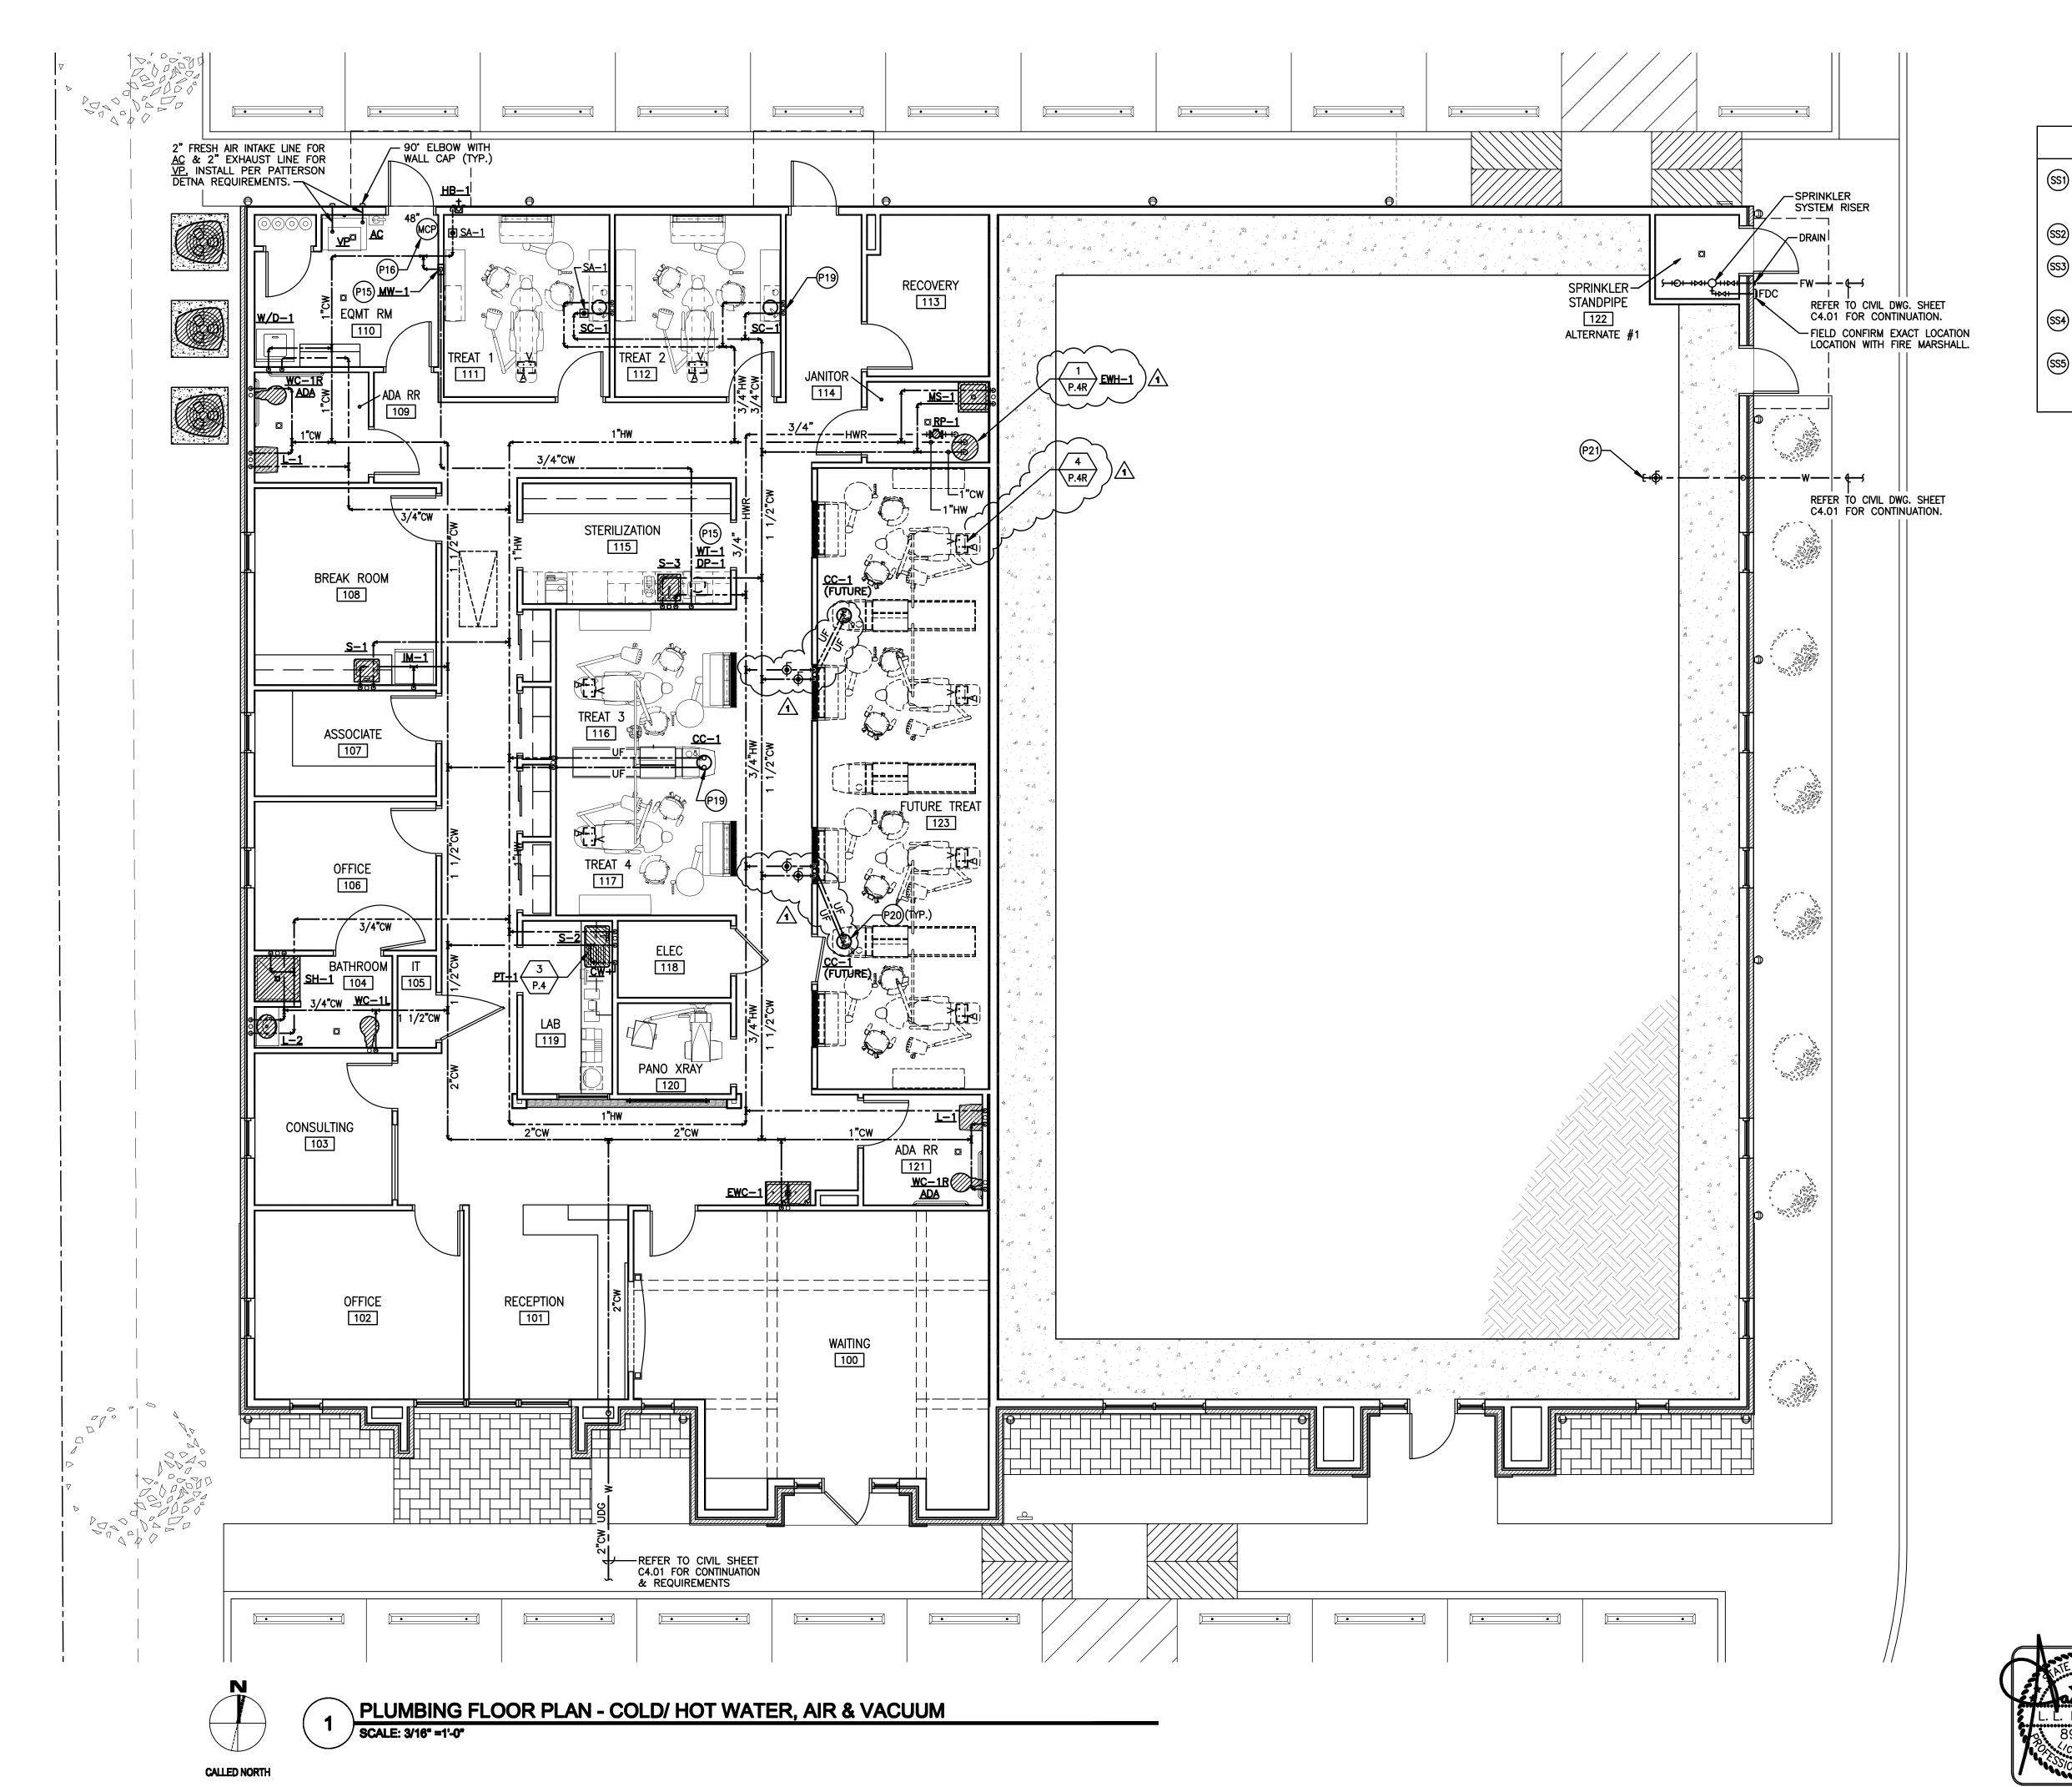
DATE: 11-04-2019 REVISION:

**REVISION:** 

**DRAWINGS SHEET TITLE** PLUMBING FLOOR PLAN **WASTE & VENT** 

SHEET NUMBER

NOTES & SYMBOLS





- (SS1) INSTALL NEW 4" WET PIPE SYSTEM WITH QUICK RESPONSE SPRINKLERS, CONTROL VALVE, TAMPER SWITCH, FLOW SWITCH, DRAIN AND FDC AND SHALL BE DESIGNED AND INSTALLED IN ACCORDANCE WITH NFPA 13 AND MEET LOCAL FIRE MARSHALL REQUIREMENTS.
- SS2) SPRINKLER SYSTEM SHALL BE HYDRAULICALLY CALCULATED PER NFPA 13 11.2.3.2.3.
- SS3) 1"-2" PIPE TO BE ALLIED BLT BLACK LIGHTWALL THREADABLE PIPE WITH STANDARD BLACK CAST FITTINGS. 2 1/2"-4" PIPE TO BE ALLIED DYNA-FLOW WITH WELDED THREAD-O-LETS, CLAMP TEES AND GROOVED FITTINGS
- SPRINKLER SYSTEM WORK BEGINS FROM FINISHED FLOOR 6" PIPE TO 4" SPRINKLER PIPE. LOCATION OF FDC MUST BE CONFIRMED WITH LOCAL FIRE MARSHALL PRIOR TO BIDDING AND INSTALLATION.
- SS5 SPRINKLER SYSTEM CONTRACTOR MUST SUBMIT DRAWINGS AND SUBMITTALS PRIOR TO INSTALLATION. COORDINATE LOCATION OF ALL SPRINKLER HEADS AND ROUTING OF PIPING WITH ARCHITECTURAL REFLECTED CEILING PLAN, ELEVATIONS, SECTIONS AND STRUCTURAL DRAWINGS.

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ISSUED FOR

DESIGN DEVELOPMENT DATE: 8/1/2019

SCHEMATIC DESIGN

**BIDS & CONSTRUCTION** DATE: 10/28/2019

REVISION: 1 DATE: 11-04-2019 REVISION:

REVISION:

PLUMBING FLOOR PLAN -COLD & HOT

SHEET NUMBER

**WATER** 

### 1. SCOPE OF THE WORK INCLUDED IN THIS SECTION:

- A. The complete installation of the domestic cold and hot water piping and the drain, waste and vent piping all from the point noted on the drawings to all fixtures, saw cutting/trenching and backfilling for piping in this section, and fixtures, incidentals, and equipment described in this section.
- B. The furnishing of all labor, materials, equipment, tools, cranes, hoists, scaffolding, support, etc. necessary or incidental to the accomplishment of the work described herein and/or shown on the accompanying drawings.
- C. Furnishing detailed information, including dimensional drawings and specifications on all equipment, fixtures piping etc. to be furnished and/or
- D. All work and installation of plumbing systems in their entirety shall comply with the 2015 International Plumbing Code, International Energy Conservation Code, Southern Standard Mechanical Code, most recent versions of all applicable laws, rules, regulations and ordinances of all governing national or local codes and authorities. However, give precedence to the plans and specifications whenever they require higher standards than those required by the rules and regulations above. The 2015 International Plumbing Code will govern in case of any direct conflict between this code and the plans and specifications. Any changes necessary in the work indicated on the plans or in the specifications that must be made in order for the work to conform to this plumbing code shall be made at no additional cost to the Owner.
- E. Includes extensive cooperation with mechanical contractor, electrical contractor, and others where plumbing work serves units furnished under separate trades and contract.
- F. Contractor shall obtain required permits and pay all fees.
- G. Demolition damage to existing materials/equipment will be repaired at no additional cost to owner. Re-support any remaining piping or devices that were supported by walls or structures being removed.

The approximate locations of all equipment, piping etc. are indicated on the plumbing drawings. These drawings do not intend to give the complete and accurate and precise details in regard to locations, etc. Exact locations are to be determined by reference to the general building plans and by actual measurements at the building, and will in all cases, be subject to approval of the Engineer.

## 3. COMPLETE FUNCTIONING OF THE WORK:

All labor, materials, apparatus and appliances that may be fairly implied as essential to the complete functioning of the plumbing systems described herein and shown on the drawings shall be furnished and installed whether specifically mentioned in these specifications, or shown in the drawings or not. In case of doubt as to the work intended by the drawings or specifications, or in event of need for amplification or clarification thereof, the contractor shall call upon the Engineer for supplementary instructions or drawings.

### 4. EXAMINATION OF THE SITE:

Examine the actual site and compare with the drawings and specifications. Ascertain and check locations of any existing obstructions that may affect the work. Failure to determine conditions will not be considered cause for granting additional compensation.

## 5. SUBMITTAL DATA AND SHOP DRAWINGS:

- A. Within twenty (20) days after a contract is awarded for this work, the contractor shall submit to the Architect for approval, detailed shop drawings, control wiring diagrams, equipment drawings, engineering information, detailed specifications and description, and other pertinent data on all items of equipment and material the contractor intends to install.
- B. Three (3) complete sets of drawings and/or data noted in A. above shall be submitted to the Engineer for approval and if corrections are required, re-submit showing connections, and continue to re—submit until approval by the Architect is obtained. After satisfactory review by the Architect, one approved copy will be returned to the Contractor.
- 6. COLD/HOT WATER, SANITARY DRAIN, WASTE AND VENT PIPING:
  - A. Furnish and install all cold/hot, sanitary drain, waste, vent piping, supports, hangers, sleeves and insulations noted or required to tie—in new pipings to existing.

- A. Location: On all exposed lines in finished areas where passing through walls, floors, or ceilings.
- B. Material: Chrome plated <u>Brass</u> or as noted on plans.
- C. Sized to fit snugly around pipe and tight against wall, floor or ceiling where installed. Verify with Architect if you have any questions.

## 8. CLEANING AND TESTING:

- A. After completing this installation, the Contractor shall thoroughly clean all components or his work that are sight exposed elsewhere within inside or out—side the building. This cleaning shall be done in preparation of final painting. Any equipment having factory painted finish shall be touched up using paint of the same type and color.
- B. All items of equipment and fixtures shall be tested and proven free of all mechanical defects.
- C. The Contractor shall also make such other tests as may be required to demonstrate that all equipment/pipings performance comply with the specification requirements and in accordance with codes.

## 9. PLUMBING FIXTURES:

- A. The work in this section shall include the furnishing and installing of all plumbing fixtures, unless noted otherwise, and/or the connection to or roughing in of plumbing services for fixtures furnished under other sections herein or furnished by the Owner, all as noted in fixture schedule in this section.
- B. Note that each and every fixture requiring water service shall be furnished with individual stop valves.
- C. Locate all fixtures accurately for spacing and height. Engineer to check and verify center to center location of all fixtures after roughing—in and before placing on concrete slab. Refer to plans or elsewhere herein for wall-mounted fixture rim height above floor. If the rim mounting height is not noted for any wall—mounted fixture, obtain the desired height before roughing in for fixture.

MARK  WC-1R  ADA  WC-1L	MANUFACTURER  AMERICAN STANDARD  AMERICAN STANDARD	MODEL NO. 3461.660 3461.001.020	REMARKS  VITREOUS WHITE CHINA FLOOR MOUNT MADERA 17"H ELONGATED FLUSHOMETER/SELECTRONI
	AMERICAN STANDARD	] 5401.001.020	FLUSH VALVE TOILET, 1.6 GPF LOW CONSUMPTION, TOP SPUD, FLOOR OUTLET AND EVERCLEAR
WC-1L		6065.161 5905.100	ADA COMPLIANT. RIGHT HANDED FLUSH LEVER OR WIDE SIDE OF STALL.  SELECTRONIC FLUSH VALVE WITH FACTORY—INSTALLED CR—P2 LITHIUM BATTER'S SENSOR "HANDS FREE" OPERATION AND MANUAL OVERRIDE BUTTON. EVERCLEAN
	AMERICAN STANDARD	3451.660 3451.001.020	SEAT EXTRA HEAVY DUTY OPEN FRONT LESS COVER.  VITREOUS WHITE CHINA FLOOR MOUNT MADERA 15"H ELONGATED FLUSHOMETER/SELECTRONI FLUSH VALVE TOILET, 1.6 GPF LOW CONSUMPTION, TOP SPUD, FLOOR OUTLET AND EVERCLEAR
I	AMERICAN STANDARD	6065.161	STANDARD HEIGHT, LEFT HANDED FLUSH LEVER OR WIDE SIDE OF STALL.  SELECTRONIC FLUSH VALVE WITH FACTORY—INSTALLED CR—P2 LITHIUM BATTERY
<u>L-1</u>	AMERICAN STANDARD	5905.100 0356.421.020	SENSOR "HANDS FREE" OPERATION AND MANUAL OVERRIDE BUTTON. EVERCLEAN SEAT EXTRA HEAVY DUTY OPEN FRONT LESS COVER.  LUCERNE WHITE VITREOUS WALL—HUNG LAVATORY WITH SINGLE CENTER FAUCET
	AMERICAN STANDARD	6053.102	HOLE. ADA COMPLIANT. WALL HANGER INCLUDED/CONCEALED ARMS SUPPORT.  ELECTRONIC PROXIMITY LAVATORY FAUCET, 1.5 GPM PRESSURE COMPENSATING VANDAL—RESISTANT AERATOR AND SENSOR "HANDS FREE" OPERATION AND PWR.
	AMERICAN STANDARD	605XTMV1070	LONG-LIFE BATTERY POWERED.  POINT OF USE THERMOSTATIC MIXING VALVE.
	McGUIRE McGUIRE	155WCEC0 2165CC	ADA COMPLIANT OFFSET CHROME PLATED CAST BRASS TAILPIECE WITH OPEN GRII STRAINER.  1/2"x3/8" ANGLE HOT AND COLD WATER SUPPLY STOPS.
	McGUIRE	8872CBECO	1 1/4" 17 GA. CHROME PLATED CAST BRASS P-TRAP WITH CLEANOUT AND OUTLE TO WALL WITH ESCUTCHEON.
	TRUEBRO TRUEBRO	102EZ 105EZ	ONE P-TRAP COVER TWO ANGLE VALVE AND SUPPLY COVER.  ONE OFFSET TAILPIECE WHELLCHAIR STRAINER COVER ONLY.
<u>L-2</u>	AMERICAN STANDARD	0491.156.020	RONDALYN COUNTERTOP WHITE VITREOUS CHINA LAVATORY WITH 4" ON CENTER:
	AMERICAN STANDARD	6053.102	FAUCET HOLES. ADA COMPLIANT.  ELECTRONIC PROXIMITY LAVATORY FAUCET, 1.5 GPM PRESSURE COMPENSATING VANDAL—RESISTANT AERATOR AND SENSOR "HANDS FREE" OPERATION AND PWR. LONG—LIFE BATTERY POWERED.
	AMERICAN STANDARD	605XTMV1070	POINT OF USE THERMOSTATIC MIXING VALVE.
<u>S-1</u>	ELKAY	LRAD1918603	LUSTERTONE 19"x18"x6 1/2" DEEP 18 GA. STAINLESS STEEL AND SELF-RIMMING
	AMERICAN STANDARD	6530.170.002	WITH 3 HOLES 4" ON CENTERS SINGLE BOWL SINK. ADA COMPLIANT.  MONTERREY TWO—HANDLE 8" WIDESPREAD LAVATORY FAUCET WITH GOOSENECK SPOU
	McGUIRE	151A	AND WRIST BLADE HANDLES.  STAINLESS STEEL BASKET STRAINER WITH 1 1/2"x4" SEAMLESS BRASS TAILPIECE, LOCI AND COUPLING NUTS.
	McGUIRE	2165CCLK	1/2"x3/8" ANGLE HOT AND COLD WATER SUPPLY STOPS.
	McGUIRE	8912CBECO	1 1/2" 17 GA. CHROME PLATED P-TRAP WITH CLEANOUT AND OUTLET TO WALIWITH ESCUTCHEON.
<u>S-2</u>	ELKAY	ILR3322L3	LUSTERTONE 33"x22"x7 5/8" DEEP 18 GA. STAINLESS STEEL AND SELF-RIMMING WITH 3 HOLES 4" ON CENTERS, SINGLE DRAINBOARD ON RIGHT SIDE AND SINGLE BOWL SINK. ADA COMPLIANT.
	AMERICAN STANDARD	6530.170.002	MONTERREY TWO-HANDLE 8" WIDESPREAD LAVATORY FAUCET WITH GOOSENECK SPOU
	McGUIRE	151A	AND WRIST BLADE HANDLES.  STAINLESS STEEL BASKET STRAINER WITH 1 1/2"x4" SEAMLESS BRASS TAILPIECE, LOCI
	McGUIRE	2165CCLK	AND COUPLING NUTS.  1/2"x3/8" ANGLE HOT AND COLD WATER SUPPLY STOPS.
	McGUIRE	8912CBECO	1 1/2" 17 GA. CHROME PLATED P-TRAP WITH CLEANOUT AND OUTLET TO WALI
<u>S-3</u>			WITH ESCUTCHEON.  STERILIZATION CABINET COUNTERTOP SINK FURNISHED AND INSTALLED BY PATTERSO
			DENTAL. FIELD COORDINATE WITH PATTERSON DENTAL REGARDING COLD/HOT WATER AND SANITARY LINES CONNECTIONS.
<u>SC-1</u>			TREATMENT SIDE CABINET COUNTERTOP SINK FURNISHED AND INSTALLED BY PATTERSO DENTAL. FIELD COORDINATE WITH PATTERSON DENTAL REGARDING COLD/HOT WATER AND SANITARY LINES CONNECTIONS.
<u>CC-1</u>			TREATMENT CENTRAL CABINET COUNTERTOP SINK FURNISHED AND INSTALLED BY PATTERSOI DENTAL. FIELD COORDINATE WITH PATTERSON DENTAL REGARDING COLD/HOT WATER AND SANITARY LINES CONNECTIONS.
<u>WT-1</u>			WATER TREATMENT UNDERCOUNTER FURNISHED AND INSTALLED BY PATTERSON DENTAL FIELD COORDINATE WITH PATTERSON DENTAL REGARDING COLD WATER LINE AND DRAIL
<u>MW-1</u>			LINE CONNECTIONS.  WATER FILTRATION AND MASTER WATER SHUT-OFF/SOLENOID VALVE PROVIDED B BY PATTERSON DENTAL AND INSTALLED BY PLUMBING CONTRACTOR.
<u>PT-1</u>			PLASTER TRAP UNDER SINK FURNISHED BY PATTERSON DENTAL AND INSTALLED B PLUMBING CONTRACTOR. REFER TO SHEET 3/P.4 FOR DETAILS.
<u>DP-1</u>			16"Wx16"Lx3"H GALVANIZED DRAIN PAN FOR ULTRAPURE TANK WATER SYSTELLOCATED UNDER SINK.
<u>IM-1</u>	OATEY	38681	ICE MAKER/REF. 6"x6"x3 1/2" OUTLET BOX 1/4 TURN BRASS BALL VALVE COPPER SWEAT.
<u>W/D−1</u>	OATEY	38934	CENTER DRAIN WASHING MACHINE 11 3/4x10 1/8" OUTLET BOX 1/4 TURN BRASS BALL VALVVE COPPER SWEAT.
<u>MS-1</u>	E L MUSTEE & SONS	63M	24"x24"x10" MOP SERVICE BASIN ONE—PIECE MOLDED FIBERGLASS WITH INTEGRAL MOLDED DRAIN, COMPLETE WITH DRAIN SEAL 3" ABS, PVC SCH. 80 AND IRON PIPE AND REMOVABLE STAINLESS STEEL STRAINER.
	E L MUSTEE & SONS	63.600A	CHROME PLATED BRASS SERVICE MOP FAUCET, VACUUM BREAKER INTEGRAL STOPS, CHROME PLATED HOT AND COLD HANDLES, THREADED 3/4" HOSE—END SPOUT AND PAIL HOOK. TOP REINFORCING BAR AND MOUNTING BRACKET.
	E L MUSTEE & SONS	65.700, 65.600, 63.403, 67.24C, 65.309	31" SERVICE HOSE AND SS HOSE HOLDER, SERVICE MOP HANGER, SS BUMPER GUARDS, DURAGUARD WALL GUARD AND MOP SERVICE BASIN SEAL 3" ABS PVC SCH. 80 AND IRON PIPE.
<u>SA-1</u>	ZURN	Z1700-100/200	ZURN TYPE "B" PDI 3/4" MIPS SHOCKSTOP 12-32 FIXTURE UNITS. PROVIDE SS 12"x12" ACCESS FOR SERVICING.
FD-1	SIOUX CHIEF	842LNR-V/842PT TG-33IP	PVC BODY AND CAST IRON FLASHING COLLAR WITH ROUND NICKEL BRONZ ADJUSTABLE STRAINER HEAD, GASKET SEAL OUTLET AND PRO-SET/ROLL/TRA SILL WATERLESS TRAP PRIMER.
<u>FS-1</u>	ZURN	Z-1901	12"x12" FLOOR SINK WITH HALF GRATE, DOME STRAINER AND NICKEL BRONZE TOP. PRO-SET/ROLL/TRAP SILL WATERLESS TRAP PRIMER. TOP, PVC CLOSURE PLUG
FCO-1	SIOUX CHIEF	852-4-LB-R	HARD FINISHED FLOOR. PVC BODY, ROUND ADJUSTABLE NICKEL BRONZE CORIATED
<u>GCO-1</u>	SIOUX CHIEF	852-4Li	TOP, PVC CLOSURE PLUG.  ADJUSTABLE ON-GRADE CLEANOUT. PVC BODY AND CLOSURE PLUG WITH ROUND
WCO-1	SIOUX CHIEF	873	HEAVY DUTY CAST IRON RING AND COVER 4" MIPS TRACTOR TYPE TOP.  FINISHED WALLS. CAST BRASS PLUG, STAINLESS STEEL BOLT, 5 1/2" ROUND STAINLES STEEL ACCESS/CLEANOUT COVER WITH COUNTERSUNK SQUARE HEAD.
<u>HB-1</u>	WOODFORD	B65P4	3/4" FPT CLOSE COUPLED AUTOMATIC DRAINING, FREEZELESS RECESSED BRASS WALL HYDRANT WITH CHROME FINISH, VACUUM BREAKER, LOCKING ACCESS DOOF AND LOOSE TEE KEY.
<u>RP-1</u>	GRUNDFOS	UP26-64F	BUILT-IN MOTOR PROTECTION, SS CONSTRUCTION, WHISPER-QUIET OPERATION, 3 SPEED MOTOR, ED UNIT, REMOVABLE, INTEGRATED CHECK VALVE AND 3/4" SUPPLY PIPE SUPPLY PIPE.
<u>CW</u>			COLD WATER VALVE WITH 3/8" COMPRESSION ANGLE STOP ABOVE COUNTERTOP

		PLUMBII	NG FIXTURE SCHEDULE
MARK	MANUFACTURER	MODEL NO.	REMARKS
EWC-1	ELKAY	LZSTL8SC ADA	VERSATILE COOLER WALL MOUNT BI—LEVEL ADA FILTERED, 8 GPH STAINLESS, FLEXI—GUARD SAFETY BUBBLER, ELECTRONIC FRONT AND SIDE BUBBLER PUSHBAR ACTIVATION. HERMETICALLY—SEALED COMPRESSOR AND FAN COOLED CONDENSER.
	ELKAY	MLP200	BI-LEVEL PLATE TYPE SYSTEM WALL CARRIER.
	McGUIRE	8912CBECO	1 1/2"x1 1/4" CHROME PLATED 17 GA. BRASS P-TRAP WITH CLEANOUT AND WALL ESCUTCHEON.
	McGUIRE	2165CC	1/2"x3/8" ANGLE HOT COLD WATER SUPPLY WITH STOPS.
<u>SH-1</u>	AMERICAN STANDARD	1662.211.002	1.5 GPF FLOWWISE COMMERCIAL SHOWER SYSTEMS KIT WITH SS SHOWER VALVE, COLONY, COLONY SOFT VALVE ONLY TRIM, 1.5 GPM 3-F HAND SHOWER, IN-LINE VACUUM BREAKER, METAL HOSE, WALL SUPPLY AND 36" SLIDE BAR.
			PROVIDE CHROME CURTAIN ROD AND WHITE WEIGHTED ANTIMICROBIAL CURTAIN. 36" x 36" SHOWER ENCLOSURE SELECTED BY ARCHITECT. CONFIRM EXACT REQUIREMENTS WITH ARCHITECT PRIOR TO SUBMIT BIDDING.
	ZURN (SHOWER DRAIN)	Z415P3NL ZN4006B	3" NL CI DRAIN BODY WITH GSK TR-PR TAP, CLAMPING COLLAR. PRO-SET ROLL TRAP SILL WATERLESS TRAP PRIMER. 6" RD NICKEL BRONZE TYPE B STRAINER DRAINS.

NO1	TES:	

H.) WITH "WATTS" THERMAL EXPANSION TANK (PET-12-M1).

1.) PIPE SIZES SHOWN ARE MINIMUM.

MR. SKIP FORTUNE AT (832)-8588.

1.) PROVIDE OTHER NECESSARY ACCESSORIES THAT ARE NOT MENTION IN THIS SCHEDULE AS REQUIRED. 2.) CONFIRM AND COORDINATE EXACT LOCATION AND MOUNTING HEIGHT WITH ARCHITECTURAL DRAWINGS.

TANK GPH @ 100' KW AMPS /PHASE CW HW MODEL NO.							ELECT	RIC WAT	ER HEAT	ΓER				
TANK GALLONS RISE   KW   AMPS   /PHASE   MODEL NO.   CW   HW   MODEL NO.   CW   HW   MODEL NO.   CW   HW   MODEL NO.   CW   HW   MODEL NO.   MODEL NO.   CW   HW   CW   MODEL NO.   CW   HW   MODEL NO.   CW   CW   MODEL NO.   CW   CW   MODEL NO.   CW   CW   MODEL NO.   CW   CW   MODEL NO.   CW	MADK	REC	OVERY	INPUT	FLC	MOCE	VOLTAGE	DIMENSIONS	THEDMOSTAT	CONNE	CTIONS	MANUFACTURER	LOCATION	REMARKS
NOTES:  x53-3/4"H  E40A-12-G  1) ELECTRIC WATER HEATER WITH:  A.) 150 PSIG ASME T & P RELIEF VALVE.  B.) 98% MAXIMUM RECOVERY EFFICIENCY.	IMMILI			KW	AMPS	WOOI	/PHASE	DIMILINGIONS	IHERMOSIAI		<del>`                                    </del>	MODEL NO.	LOCATION	IVEIMAININ
1) ELECTRIC WATER HEATER WITH:  A.) 150 PSIG ASME T & P RELIEF VALVE.  B.) 98% MAXIMUM RECOVERY EFFICIENCY.	<u>EWH-1</u> NOTES:		50	12	34	45	208/3/60		IMMERSION	1"	1"		MECH. 122	W/ (1)
B.) 98% MAXIMUM RECOVERY EFFICIENCY.	<u> </u>		R HEATER WITH	<b>-</b> 1:										
ullet	A.)	150 PSIG	ASME T &	P RELIE	F VAL	/E.								
C.) LIFEGUARD HEATING ELEMENTS. SYSTEM SENTINEL LED DIAGNOSTIC SYSTEM AND AUTOMATIC TEMP. CONTROL.	•													
	•							DIAGNOSTIC	SYSTEM AND	AUTOMA	TIC TEMP	. CONTROL.		
D.) FULL PORT, FULL FLOW BRASS DRAIN VALVE. E.) LONG LIFE ASME TANK, MINIMAL HEAT LOSS DESIGN AND 2 1/2" RIGID POLYRETHANE FOAM INSULATION.	•													
		ANODE RO												

•	PLUMBING FIX	IUKE BK	ANCH CO	NNECTION	N SCHEL	JULE		
FIXTURE	MARK	HOT WATER	COLD WATER	WASTE/DRAIN	VENT	FRESH AIR	AIR	VACUUM
WATER CLOSET - FLUSH VALVE	WC-1R. WC-1L	_	1"	4"	2"	_	_	_
LAVATORY	<u>L-1, L-2</u>	1/2"	1/2"	1 1/2"	1 1/2"	_	-	_
SINK	S-1. S-2. S-3	1/2"	1/2"	1 1/2"	1 1/2"	_	_	_
SHOWER	<u>SH-1</u>	1/2"	1/2"	3"	2"	_	_	_
ELECTRIC WATER HEATER	<u>EWH-1</u>	1"	1"	1 1/4"	_	_	_	_
ELECTRIC WATER COOLER	EWC-1	_	1/2"	1 1/2"	1 1/2"	_	_	_
WASHER/DRYER	<u>W/D-1</u>	1/2"	1/2"	2"	1 1/2"	_	_	_
ICE MAKER	<u>IM-1</u>	_	1/2"	_	_	_	_	_
FLOOR DRAIN	<u>FD-1</u>	_	_	3"	1 1/2"	_	_	_
FLOOR SINK	<u>FS-1</u>	_	_	3"	1 1/2"	_	_	_
HOSE BIBB	<u>HB-1</u>	_	3/4"	_	_	_	_	_
MOP SINK	<u>MS-1</u>	1/2"	1/2"	<b>3</b> "	2"	_	_	_
	 GCO-1, FCO-1, WCO-	·		3"	2"	_	_	_
AHU CONDENSATE DRAIN RECEIVR	<u>CDR-1</u>	_	_	1 1/2"	1 /12"	_	_	_
HOT WATER RECIRCULATING PUMP	<u>RP-1</u>	3/4	_	- · ·/ -	_	_	_	_
TREATMENT SIDE CABINET	SC-1	1/2"	1/2"	2"	1 1/2"	_	1/2"	_
TREATMENT CENTRAL CABINET	<u>CC-1</u>	1/2"	1/2"	2" 2"	1 1/2"	_	1/2"	_
	<u>DCH-1</u>	_	_	_	, _	_	1/2"	3/4"
DENTAL CHAIR	<del></del>	_	_	_	_		·	3/4
COMPRESSED AIR	<u>AC</u>	_	_			2"	1/2"	_
VACUUM PUMP	<u>VP</u>	_	-	1 1/2"	1 1/2"	_	_	2"
MASTER WATER SHUT-OFF/ FILTRATION SYSTEM	<u>MW-1</u>	-	3/4"	_	- <del>/1</del>	7 –	_	_
COLD WATER OUTLET	<u>CW</u>	_	1/2"	_	_	_	_	_
AIR OUTLET	A	-	-	-	-	-	1/2	_
VACUUM OUTLET	<u>V</u>	_	_	_	_	-	_	3/4
DRAIN PAN	<u>DP-1</u>	-	_	1 1/2"	-	_	_	_

2.) REFER TO PATTERSON DENTAL DRAWINGS ALL EXACT REQUIREMENTS AND INSTALLATIONS PRIOR TO SUBMIT BIDDING. CONTACT



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SHEET NUMBER P.3R

FAX: (409) 767-9224 1936 PROJECT NUMBER

ARCHITECT HAS REVIEWED

THE CONSULTANT'S WORK AND COORDINATED IT WITH THE OVERALL PROJECT

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ISSUED FOR

DESIGN DEVELOPMENT X

BIDS & CONSTRUCTION X

**DRAWINGS SHEET TITLE** 

**PLUMBING** 

**SCHEDULES &** 

**SPECIFICATIONS** 

SCHEMATIC DESIGN

DATE: 6/19/2019

DATE: <u>8/1/2019</u>

DATE: 10/28/2019

DATE: 11-04-2019

REVISION: 1

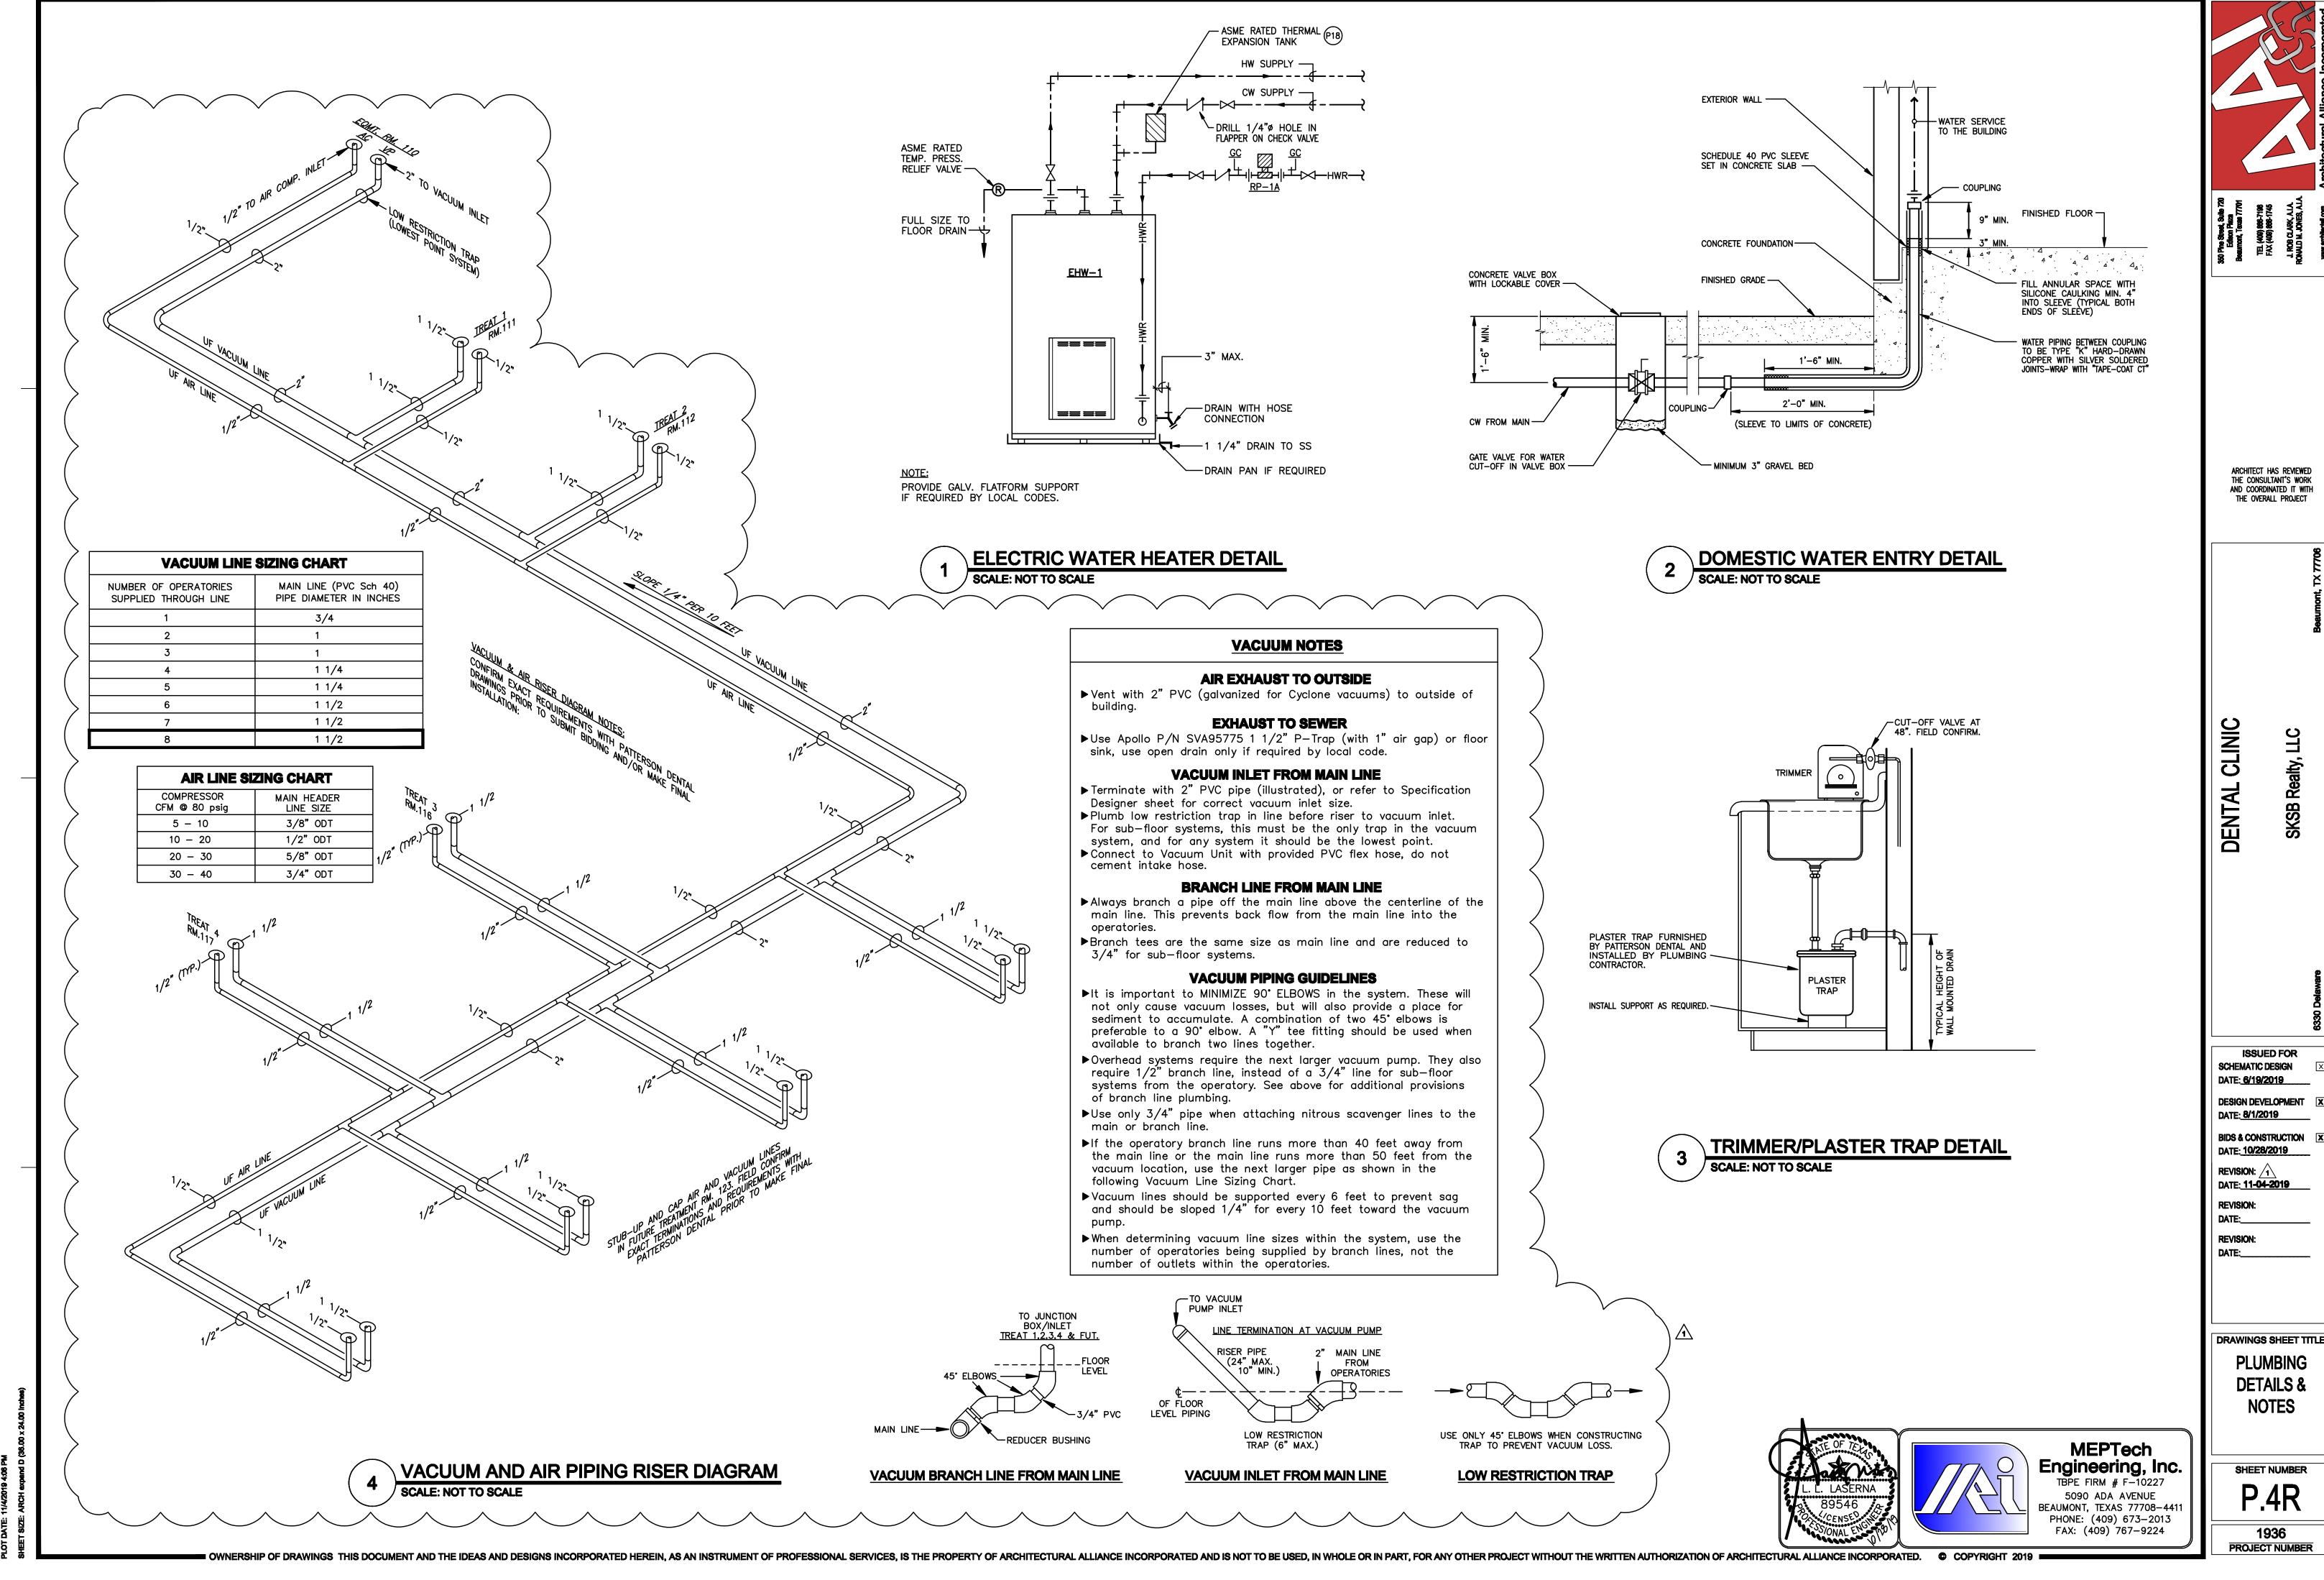
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